
1591 Tionontati St.

South Lake Tahoe, CA 96150 EL DORADO COUNTY APN: 081-074-001

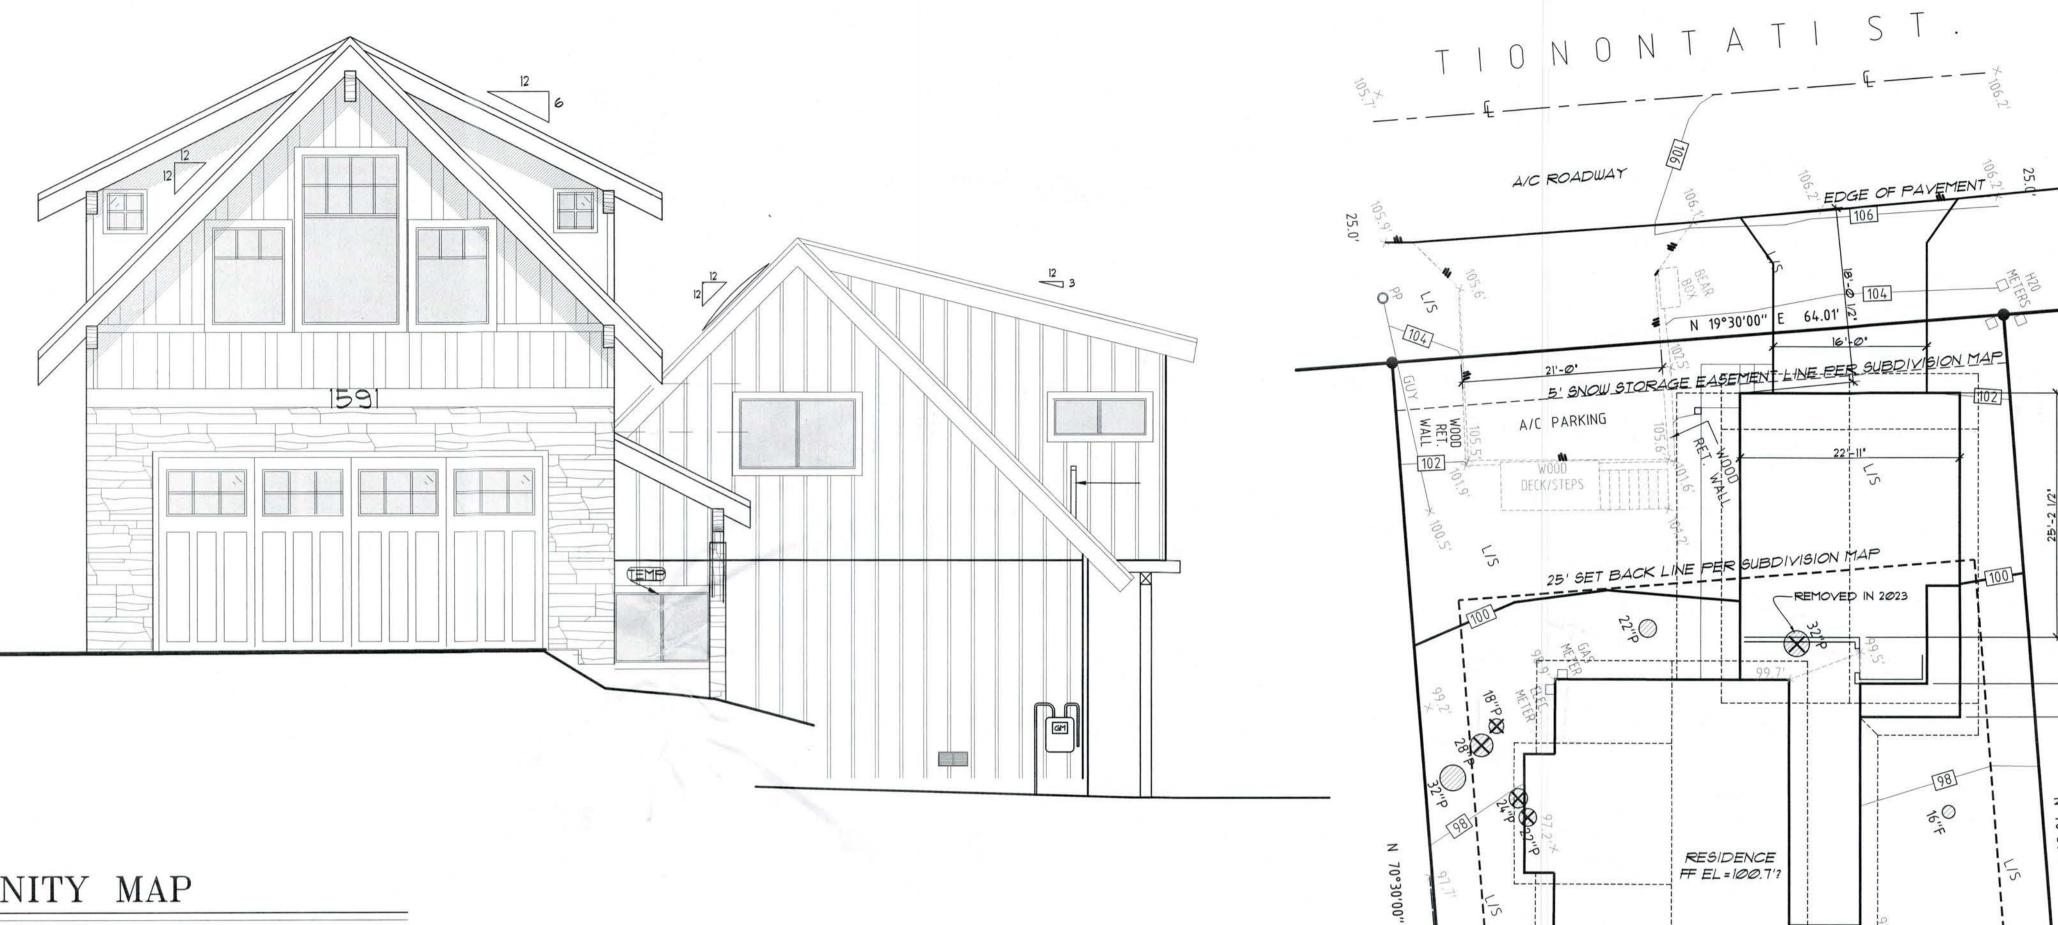

VICINITY MAP



- CALL 811 TWO DAYS BEFORE STARTING ANY DIGGING **PROJECT**
- WAIT FOR THE SITE TO BE MARKED RESPECT THE MARKS

DIG WITH CARE

- D CONSTRUCTION NOTES CONTRACTOR TO VERIFY ALL DIMENSIONS AND SITE CONDITIONS SHOWN AND TO NOTIFY ERIC SUDHAUSEN, NY. RESIDENTIAL DESIGNER OF ANY DISCREPANCIES PRIOR TO COMMENCEMENT OF WORK.
- 2) CODES
- THIS PROJECT SHALL COMPLY WITH ALL APPLICABLE BUILDING CODES AS SHOWN BELOW:
- 2019 CALIFORNIA BUILDING CODE (CBC) INCLUDING ASCE 7-05 (FOR STRUCTURAL)
- @ 2019 CALIFORNIA RESIDENTIAL CODE (CRC) (FOR NON-STRUCTURAL) ○ 2019 CALIFORNIA PLUMBING CODE (CPC)
- © 2019 CALIFORNIA MECHANICAL CODE (CMC) ■ 2019 CALIFORNIA ELECTRICAL CODE (CEC)
- 2019 CALIFORNIA FIRE CODE
- 2019 CALIFORNIA ENERGY CODE
- 2019 CALIFORNIA BUILDING STANDARDS ADMINISTRATION CODE ■ 2019 CALIFORNIA GREEN BUILDING
- STANDARDS CODE WHERE APPLICABLE AND ANY OTHER
- PERTINENT LOCAL CODES & ORDINANCES
- BUILDING CODE DATA
- OCCUPANCY GROUP = R-3, U TYPE OF CONSTRUCTION = Y-B
- SPRINKLERS = NO STORIES = 2

RESIDENTIAL UNITS = 1

CLIENT

Chelsea Kasai and Joshua Hanewinkel 1591 Tionontati Street, South Lake Tahoe, CA96150 Phone: (Chelsea) 952-210-5212 (Josh) 917-723-6664 Email: (Chelsea) chelsea.kasai@gmail.com (Josh) joshua.hanewinkel@gmail.com

ENGINEER

Daniel Grant 2259 Rimrock Trail South Lake Tahoe, CA 96150 Phone: 619-865-8099 Email: daniel@grantstructural.com

CONTRACTOR

(TBD) **Business Name** Phone: Email:

SURVEYOR

Turner & Associates, Inc. Land Surveying Phone: 775-588-5658

SCOPE OF WORK

- ADD SECOND FLOOR DORMER ADDITION FOR NEW BATHROOM
- ADD CLOSET IN MASTER BEDROOM ADD RIDGE BEAM

NEW SQUARE FOOT: DWELLING S.F. -

GARAGE S.F. - Ø DECK S.F. - Ø

> APPROVED EL DORADO COUNTY ZONING ADMINISTRATOR DATE March 20, 2024

ZONING ADMINISTRATOR V23-0003

SHEET INDEX

- COVER SHEET EXISTING SITE PLAN
- DEFENSIBLE SPACE PLAN 4 C3 BMP PLAN & DETAILS
- EXISTING FLOOR PLANS 6 A2 EXISTING NORTH&WEST ELEVATIONS
- EXISTING SOUTH&EAST ELEVATIONS PROPOSED FLOOR PLANS
- PROPOSED NORTH&WEST ELEVATIONS
- 10 A6 PROPOSED SOUTH&EAST ELEVATIONS 11 S1 PROPOSED SECTIONS
- PROPOSED ELECTRICAL PLANS 12 E1

2020 CALGREEN NOTES

V23-0003

DRAWN BY: CHECKED BY: DATE PREPARED: SCALE: as noted

REVISION: 11/10/2022

11/17/2022

CO

0 WOOD DECK EL = 100.5'? 14-----15' SET BACK LINE PER SUBDIVISION MAP ---- 2.5' PUBLIC UTILITY EASEMENT PER SUBDIVISION MAP N 19°30'00" E 64.01" PIONEER TR.

PROPOSED SITE PLAN

Scale: 1"=10'-0"

1' CONTOUR INTERVAL

JOB No:
DRAWN BY:
CHECKED BY:
DATE PREPARED:
SCALE: QS NOTED

C₁

DRAWING No:

EDGE OF PAVEMENT N 19°30'00" E 64.01' _ 5' SNOW STORAGE EASEMENT LINE PER SUBDIVISION MAP A/C PARKING 25' SET BACK LINE PER SUBDIVISION MAP 50 RESIDENCE FF EL = 100.717 WOOD DECK EL = 100.5'? 6 ---- 2.5' PUBLIC UTILITY EASEMENT PER SUBDIVISION MAP 3 N 19°30'00" E 64.01' PIONEER TR. SITEPLAN Scale: 1"=10'-0" I' CONTOUR INTERVAL

TIONONTATI ST.

A/C ROADWAY

COVERAGE

RESIDENCE 934

WOOD DECK/STEPS A/C PARKING

TOTAL ESTIMATED OFFSITE COVERAGE

> A/C DRIVEWAY 278 TOTAL 278

COVERAGE TABLE:

ONSITE COVERAGE	EXISTING	PROPOSED	W/ 3:1 HEIGHT REDUCTION	TOTAL
RESIDENCE	934	973	973	973
WOOD DECK	614	0	0	0
TOTAL	1,548			
	1			

OFFSITE COVERAGE COMPACTED DIRT ASPHALT DRIVEWAY:

LOT INFORMATION
LOT AREA:
LAND CAPABILITY (CLASS IB):
ALLOWABLE COVERAGE:
GRAND-FATHERED COVERAGE:
REMOVED COVERAGE:
ALLOWED COVERAGE W/ 15:1 RELOCATION:
TOTAL PROPOSED COVERAGE:

114 SF 6,200 SF 62 SF 2,276 SF 799 SF 2,010 SF 1,918 SF

298 SF

APPROVED
EL DORADO COUNTY
ZONING ADMINISTRATOR DATE March 20, 2024 BY BCH Sampson I due ZONING ADMINISTRATOR

V23-0003

By Bret Samoson U ZONING ADMINISTRATOR

V23-0003

ALL RESIDUAL TREES WILL BE LIMBED TO A HEIGHT OF 10'-0" FEET FROM GROUND, NOT TO EXCEED 1/3 OF THE TOTAL TREE HEIGHT.

TRIM ALL LOW HANGING LIMBS SO THAT NONE ARE LOWER THAN 10'0"

64.01 N 19°30'00"

25' SET BACK LINE PER GUBDIVISION MAP

RESIDENCE

WOOD DECK EL = 100.5'?

FF EL = 100.7'

5' SNOW STORAGE EASEMENT LINE PER SUBDIVISION MAI

EDGE OF PAVEMENT

A/C DRIVEWAY

Y-----

TIONONTATI ST.

A/C ROADWAY

ZONE 1: 0-5' NONCOMBUSTABLE AREA

CREATE A NONCOMBUSTABLE AREA AT LEAST 5 FEET WIDE AROUND THE BASE OF THE STRUCTURE (INCLUDING ALL DECKS). THIS AREA NEEDS TO HAVE A VERY LOW POTENTIAL FOR IGNITION FROM FLYING EMBERS. USE IRRIGATED HERBACEOUS PLANTS SUCH AS LAWN, GROUND COVER, AND FLOWERS THAT ARE RECOMMENDED FOR THE LAKE TAHOE BASIN; ROCK MULCHES; OR HARD SURFACES, SUCH AS BRICK AND PAVERS, IN THIS AREA.

- 1. THE AREA WITHIN 0-5' OF THE FOUNDATION OR SUPPORT POSTS SHOULD CONTAIN NO COMBUSTABLE MATERIALS, INCLUDING COMBUSTABLE PLANT MATERIAL A 3" GRAVEL MOAT IS THE PREFERRED MATERIAL OF USE, DRIP LINES MAY BE INCORPORATED INTO THIS
- 2. REMOVE ALL PINE NEEDLES AND FOREST DUFF WITHIN THIS AREA.

ZONE 2: 5-30' LEAN, CLEAN AND GREEN AREA

FOR A DISTANCE OF 5 FEET TP 30 FEET FROM THE STRUCTURE THERE SHOULD BE A LEAN, CLEAN, AND GREEN AREA. "LEAN" INDICATES THAT ONLY A SMALL AMOUNT OF FLAMMABLE VEGETATION, IF ANY, IS PRESENT WITHIN 30 FEET OF THE STRUCTURE. "CLEAN" MEANS THERE IS LITTLE OR NO ACCUMULATION OF DEAD VEGETATION OR FLAMMABLE DEBRIS WITHIN THE AREA DURING FIRE SEASON, "GREEN" IMPLIES THAT PLANTS LOCATED WITHIN THIS AREA ARE KEPT HEALTHY, GREEN AND IRRIGATED DURING FIRE SEASON.

- 1. TRIM ALL TREES OVER 20 FEET A MINIMUM OF 10 FEET ABOVE ADJACENT GRADE.
- 2. REMOVE ANY TREE 14 INCHES DIAMETER OR LESS (AS INDICATED ON DRAWINGS) TO CREATE A 10 FOOT SPACE BETWEEN ANY ADJACENT TREE CANOPY, REFER TO DETAIL 2.
- 3. REMOVE ACUMULATION OF DEAD VEGETAION FROM TREES (FLAMMABLE DEBRIS, DEAD BRANCHES AND LIMBS) 10 FEET ABOVE ADJACENT GRADE.
- 4. WITHIN 5-30' OF THE STRUCTURE ONLY SINGLE SPECIMENS OF WELL MAINTAINED AND WELL IRRIGATED SHRUBS OR TREES SHOULD BE PRESENT. SUCH MATERIALS SHOULD NOT BE CAPABLE OF READILY TRANSMITTING FIRE TO THE STRUCTURE. COMBUSTABLE MULCHES OR PINE NEEDLES SHOULD NOT BE USED AS GROUND COVER WITHIN THIS ZONE.
- 5. ALL BRUSH, TREES OR FLAMMABLE MATERIAL WILL BE REMOVED FROM UNDER THE DRIP LINE OF RESIDENTAIL TREES OF THE TREE GROUP.
- 6. REMOVE ALL PINE NEEDLES AND FOREST DUFF WITHIN THIS AREA.

ZONE 3: 30-100' WILDLAND FUEL REDUCTION AREA

THE WILDLAND FUEL REDUCTION AREA LIES BEYOND THE LEAN, GREEN AREA AND OFTEN CONSISTS OF NATURALLY OCCURING PLANTS (PINE TREES, MANZANITA, SAGEBRUSH. ETC.) WITHIN THIS AREA. REMOVE DEAD VEGETATION, INCLUDING DEAD SHRUBS, DRIED GRASS, FALLEN BRANCHES, THICK ACCUMULATION OF NEEDLES AND LEAVES ETC. THIN, DENSE STANDS OF SHRUBS AND TREES TO CREATE A SEPARATION BETWEEN THEM. REMOVING TREES MORE THAN 14" IN DIAMETER REQUIRES A PERMIT FROM THE TAHOE REGIONAL PLANNING AGENCY (TRPA) OR YOUR LOCAL FIRE PROFESSIONAL.

- TREE CANOPIES WILL BE SPACED AT LEAST 10 FEET APART, IF TREES ARE GROUPED CLOSE ENOUGH TOGETHER AS TO ACT AS ONE UNIT, THEN ALL OTHER REQUIREMENTS MUST BE MET. REFER TO DETAIL 2.
- 2. BEYOND 30 FEET FROM THE STRUCTURE, BRUSH FIELDS MUST BE SPACED TO A DISTANCE EQUAL OR GREATER THAN TWO (2) TIMES THE HEIGHT OF THE BRUSH. INDIVIDUAL BRUSH PLANTS WILL NOT EXCEED 100 SQUARE FEET. REFER TO DETAIL 1.
- 3. PINE NEEDLES ARE ACCEPTABLE WITHIN ZONE 3 AS LONG AS THEY ARE NO THICKER THAN 2 OR 3 INCHES.

FOR SLOPED PROPERTIES, USE THE FOLLOWING STANDARDS FOR THE ABOVE REQUIREMENTS:

10 FEET BETWEEN EDGES OF CROWNS 20-40% 20 FEET BETWEEN EDGES OF CROWNS

0-20% 2 X HEIGHT OF RESIDUAL BRUSH 20-40% 4 X HEIGHT OF RESIDUAL BRUSH 40%-UP 6 X HEIGHT OF RESIDUAL BRUSH

40%-UP 30 FEET BETWEEN EDGES OF CROWNS

LEGEND TREE WITH IA' TRUNK DIAMETER AT BREAST HEIGHT LODGE POLE ASPHALT CONCRETE SPOT ELEVATION FOUND 3/4" GAPPED IRON PIPE LS 2725, OR AS NOTED OR SET AS NOTED DEMO-ED TREE

SET BAS' REBAR WCAP FLS 7949

OF BUILDING 5-30 FEET FROM STRUCTURE OF BUILDING

Ø-5 FEET FROM STRUCTURE


ZONE 3 30-100 FEET FROM STRUCTURE OF BUILDING

15' SET BACK LINE PER SUBDIVISION MAP ---- 2.5" PUBLIC UTILITY EASEMENT PER SUBDIVISION MAP --

N 19°30'00" E 64.01' PIONEER TR.

DEFENSIBLE SPACE PLAN

Scale: 1"=10'-0"

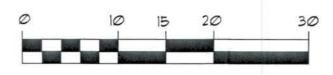


I' CONTOUR INTERVAL

SEPARATION BETWEEN TREES & SHRUBS


SAGEBRUSH, MANZANITA, HUCKLEBERRY OAK, AND OTHER SHRUBS: ON FLAT TO GENTLY SLOPING TERRAIN, INDIVIDUAL SHRUBS OR SMALL CLUMPS OF SHRUBS WITHIN THE DEFENSIBLE SPACE ZONE SHOULD BE SEPARATED FROM ONE ANOTHER BY AT LEAST TWICE THE HEGIHT OF THE AVERAGE SHRUB. FOR HOMES LOCATED ON STEEPER SLOPES, THE SEPARATION DISTANCE SHOULD BE GREATER.

FOR EXAMPLE, IF THE TYPICAL SHRUB HEIGHT IS 2 FEET, THEN THERE SHOULD BE A SEPARATION BETWEEN SHRUB BRANCHES OF AT LEAST 4 FEET. REMOVE SHRUBS OR PRUNE TO REDUCE THEIR HEIGHT AND/OR

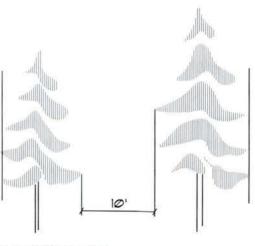


2 FOREST TREES

ON FLAT OR GENTLY SLOPING TERRAIN, TREES SHOULD BE THINNED TO PROVIDE AN AVERAGE SEPARATION BETWEEN THE CANOPIES OF AT LEAST 10 FEET (TRPA). FOR HOMES LOCATED ON STEEPER SLOPES, THE SEPARATION DISTANCE SHOULD BE GREATER. STUMPS SHOULD BE CUT SLUSH TO THE GROUND FOR THEES LESS THAN 6 INCHES IN DIAMETER AT BREAST HEIGHT, AND TO WITHIN 6 INCHES OF THE GROUND FOR LARGER TREES. THE STUMPS CUT SURFACE SHOULD BE COATED WITH POWDERED BORAX TO RETARD THE SPREAD OF ROOT DISEASES, WHEN SELECTING TREES FOR REMOVAL, CONSIDER CUTTING UNHEALTHY. DAMAGED, OR WEAK TREES. RETAIN LESS COMMON SPECIES OF TREES, SUCH AS INCENSE CEDAR, SUGAR PINE, AND WESTERN JUNIPER IF POSSIBLE.

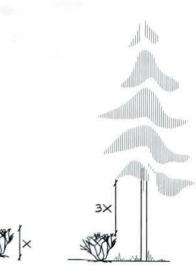

SEPARATION BETWEEN TREE BRANCHES 3 LOWER GROWING PLANTS

IF TREES ARE PRESENT WITHIN THE DEFENSIBLE SPACE ZONE, THERE SHOULD BE A REPARATION BETWEEN THE LOWER GROWING VEGETATION AND THE LOWEST TREE BRANCHES. VEGETATION THAT CAN CARRY FIRE BURNING IN LOW GROWING PLANTS TO TALLER PLANTS IS CALLED "LADDER FUEL." FOR LARGE TREES, THE RECOMMENDED SEPARATION FOR LADDER FUELS IS THREE TIMES THE HEIGHT OF THE LOWER VEGETATION LAYER, PRUNE BRANCHES FROM LOWER THIRD OF THE TREE HEIGHT, SHORTEN THE HEIGHT OF THE SHRUBS, OR REMOVE PLANTS. DO NOT REMOVE MORE THAN ONE-THIRD OF THE TOTAL TREE BRANCHES. WHEN THERE IS NO UNDERSTORY VEGETATION PRESENT, REMOVE LOWER TREE BRANCHES TO A HEIGHT OF AT LEAST FIVE FEET ABOVE GROUND. DURING FIRE, THIS WILL HELP PREVENT BURNING NEEDLES AND TWIGS THAT ARE LYING ON THE GROUND FROM IGNITING THE TREE. FOR SHORTER TREES, WHERE THREE TIMES THE HEIGHT OF THE LOWER VEGETATION LAYER EXTENDS BEYOND THE LOWER THIRD OF THE TREE HEIGHT, SHORTEN THE HEIGHT OF THE SHRUBS OR REMOVE PLANTS BELOW THE TREE.

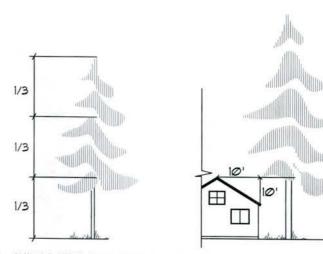

APPROVED EL DORADO COUNTY

4 GUIDELINES FOR TRIMMING TREES

ALL RESIDUAL TREES WILL BE LIMBED TO ACHIEVE (10) FEET OF CLEARANCE FROM ANY PART OF THE HOUSE TO THE BRANCHES OF THE TREE. IF THIS WOULD REQUIRE REMOVAL OF THE CROWN EXCEEDING THE LOWER 1/3 OF THE TREE, THEN THE ENTIRE SHEET SHOULD BE REMOVED.

OF THE GROUND.

V23-0003

JOB No:

FILE:

DRAWN BY:

CHECKED BY:

DRAWING No:

DATE PREPARED: scale: as noted

DRAWN BY: CHECKED BY: DATE PREPARED: SCALE: as noted

DRAWING No:

V23-0003

BMP DETAILS

Thank you for your interest in participating in the BMP Retrofit Program! We value your partnership and willingness to work with us to protect Lake Tahoe.

At this time, we have found that your property includes site characteristics such as high groundwater, slow permeability soils, rocky soils, or other conditions that make installation of infiltration BMPs difficult and/or infeasible. This property is considered "site constrained," therefore, source control BMPs should be installed, which are designed to stabilize sediment on-site; examples are mulching, gravel armoring and terracing.

Once you have completed source control BMPs for your property, please contact us at 775/589-5202 for a final inspection. Once approved, the property will be issued a "Source Control Certificate," which demonstrates substantial compliance with TRPA requirements for the BMP Retrofit Program (Chapter 60.4, TRPA Code of Ordinances). However, if an area-wide or regional water quality treatment program becomes available, the Source Control Certificate no longer demonstrates substantial compliance. TRPA will then outline the process to bring your property into full compliance; once implemented, the property will receive a BMP Certificate of Completion.

TRPA will not pursue enforcement action for noncompliance with the BMP Retrofit Program for properties with a valid Source Control Certificate. This Source Control Certificate is transferable to all successors and assigns, and remains valid provided the source control BMPs are maintained and an areawide or regional water quality treatment program is not available.

We appreciate your patience regarding this matter and thank you for doing your part to protect Lake

Sincerely,

Shay Navarro Stormwater Program Manager Stormwater Management Program

Dear Tahoe Basin Property Owner:

Site Constraint Tracking Form

Property Address:	Jurisdiction:	APN:	
1591 Tionontati St, South Lake Tahoe	ELDO	081-074-001	
Site Evaluator:	Agency:	Date:	
Angela Turrietta	TRPA	08/03/2022	


The following site constraint(s) has/have been identified on your property:


- Property located in an area with a Seasonal High Water Table/Stream Environment Zone
- Property located on slow soils (Ksat ≤1"/hr)
- Property located on rocky soils or in an area with bedrock at or near grade
- Infiltration area restricted due to utility placement Infiltration area restricted due to retaining structures
- Steep slopes / Cut and fill slopes Infiltration area restricted due to property boundaries
- Conveyance structure cannot be installed due to underground heating unit Structure located with no/minimal setback to public right-of-way
- Subsurface contamination
- Seasonal Use Driveway only
- Tahoe Keys property, unless utilizing pervious coverage exemption pursuant to TRPA Code §30.4.6.D.1

Evaluator Notes:

This parcel is considered site constrained due to the reason(s) stated above making the installation of full infiltration BMPs difficult and/or infeasible at this time in terms of stormwater capture and infiltration. However, source control BMPs are still required for the property. Source Control BMPs are designed to stabilize sediment on-site; examples include mulching, gravel armoring and terracing. Fire-defensible space BMPs are also required. No combustible materials, including woody vegetation or wooden borders for infiltration systems, are permitted within 5 feet of any structure. Remove tree limbs that are within 5' of chimneys, decks and roofs of structures. Property must meet FDS requirements in all zones.

Where applicable, Source Control BMPs also include parking barriers to restrict vehicle access to all unpaved areas without impeding snow removal practices. Vehicle traffic compacts soil and disturbs vegetated areas. Please keep this in mind when installing the parcel BMPs on this property.

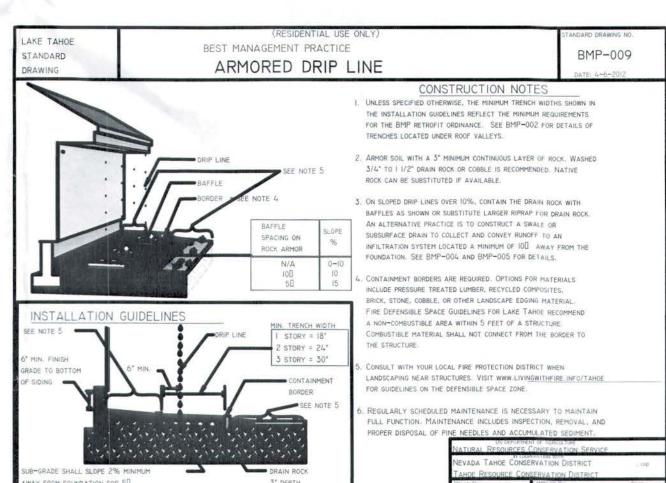

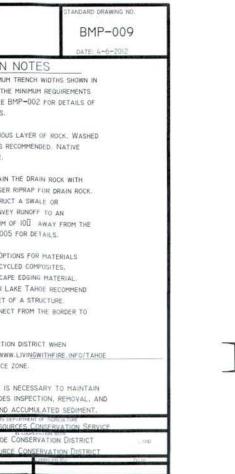

TRPA-SOIL PROTECTION DETAILS

BMP PLAN

Scale: 1"=10'-0" I' CONTOUR INTERVAL

TIONONTATI ST.

EDGE OF PAVEMENT

A/C DRIVEWAY

96

64.01

N 19°30'00"

_____ 5' SNOW STORAGE EASEMENT LINE PER SUBDIVISION ".

25' SET BACK LINE PER SUBDIVISION MAP

RESIDENCE

WOOD DECK EL = 100.5'?

---- 2.5' PUBLIC UTILITY EASEMENT PER SUBDIVISION MAP ---

N 19°30'00" E 64.01'

PIONEER TR.

15' SET BACK LINE PER SUBDIVISION MAP

FF EL=100.7

AIC ROADWAY

APPROVED EL DORADO COUNTY ZONING ADMINISTRATOR DATE March 20, 2024 BY BOX SAMPSON Are ZONING ADMINISTRATOR V23-0003

1. ALL BARREN AREAS AND AREAS DISTURBED BY CONSTRUCTION SHALL BE REVEGETATED IN ACCORDANCE WITH THE TRPA HANDBOOK OF BEST MANAGEMENT PRACTICES AND LIVING WITH FIRE, LAKE TAHOE BASIN, SECOND EDITION. APPLICATION OF A MULCH MAY ENHANCE VEGETATIVE ESTABLISHMENT.

2. EXCAVATION EQUIPMENT SHALL BE LIMITED TO THE FOUNDATION FOOT PRINT TO MINIMIZE SITE DISTURBANCE. NO GRADING OR EXCAVATION SHALL BE PERMITTED OUTSIDE OF THE BUILDING FOOTPRINT.

3. CONSTRUCTION PLANS SHALL BE CONFIRMED AT THE TIME OF THE TRPA PRE-GRADING INSPECTION. ANY REQUIRED MODIFICATIONS, AS DETERMINED BY TRPA, SHALL BE INCORPORATED INTO THE PROJECT PERMIT AT THAT

4. PROVIDE A THREE INCH (3") LAYER OF CRUSHED 3/4" DRAINROCK BENEATH ALL RAISED DECKS.

REVEGETATION NOTES:

FOR ALL AREAS DISTURBED BY CONSTRUCTION, INSTALL TEMPORARY STABILIZATION MEASURES SUCH AS EROSION CONTROL BLANKETS OR HYDROMULCHW/ TACKIFIERS. COVER STOCKPILES THAT WILL REMAIN OVER WINTER W/ A DURABLE MATERIAL OR PLASTIC SHEETING. THESE MEASURES SHALL BE MAINTAINED FROM COMPLETION OF THE INITIAL GRADING THROUGH COMPLETION OF THE PROJECT

THIS SITE SHALL BE WINTERIZED IN ACCORDANCE W/ THE PROVISIONS OF ATTACHMENT R BY OCT. 15TH OF EACH CONSTRUCTION SEASON. THE PERMITTEE IS RESPONSIBLE FOR INSURING THAT THE PROJECT, AS BUILT, DOES NOT EXCEED THE APPROVED LAND COVERAGE FIGURES SHOWN ON THIS SIT PLAN. THE APPROVED LAND COVERAGE FIGURES SHALL SUPERSEDE SCALED DRAWINGS WHEN DISCREPANCIES OCCUR.

ALL BMP DETAILS AND SPECIFICATIONS SHALL BE CONSISTENT WITH THE TRPA HANDBOOK OF BEST MANAGEMENT PRACTICES. ALL OF THE BMP HANDBOOK DETAILS AND INFORMATION SHEETS CAN BE VIEWED AND DOWNLOADED AT HTTP://WWW.TAHOEBMP.ORG/BMPHANDBOOKCH4.ASPX. IF SUB-SURFACE INFILTRATION FACILITIES ARE PROPOSED, IT WILL BE NECESSARY TO SUBMIT PHOTO DOCUMENTATION OF SUB-SURFACE INFILTRATION SYSTEMS PRIOR TO ISSUANCE OF A BMP CERTIFICATE OF COMPLETION. THE PHOTOGRAPHS SHALL CLEARLY SHOW THAT THE INFILTRATION SYSTEMS HAVE BEEN INSTALLED AS SPECIFIED ON TRPA APPROVED

CONSTRUCTION STAGING AREA SHALL BE LIMITED TO WITHIN THE PERIMETER VEGETATION PROTECTION FENCING ALL EXTERIOR LIGHTING SHALL BE CONSISTENT WITH TRPA CODE OF ORDINANCES, CHAPTER 30, SECTION 30.8, EXTERIOR LIGHTING STANDARDS.

DISTURBED BY CONSTRUCTION SHALL BE REVEGETATED IN ACCORDANCE THE TRPA HANDBOOK OF BEST MANAGEMENT PRACTICES AND LIVING WITH FIRE, LAKE TAHOE BASIN, SECOND EDITION. APPLICATION OF A MULCH MAY ENHANCE VEGETATIVE ESTABLISHMENT.


ALL AREAS DISTURBED BY CONSTRUCTION SHALL BE MULCHED WITH A 2 TO 3 INCH LAYER OF PINE NEEDLES OR WOOD CHIPS AS A DUST CONTROL MEASURE. THIS MULCH SHALL BE MAINTAINED FROM COMPLETION OF THE INITIAL GRADING THROUGH COMPLETION OF THE PROJECT.

DRAINAGE

THE GROUND IMMEDIATELY ADJACENT TO THE FOUNDATION SHALL BE SLOPED AWAY FORM THE BUILDING AT A SLOP OF NOT LESS THAN ONE UNIT VERTICAL IN 20 UNITS HORIZONTAL (5-PERCENT SLOPE) FOR A MINIMUM DISTANCE OF 10 FEET MEASURED PERPENDICULAR TO THE FACE OF THE WALL. IF PHYSICAL OBSTRUCTION OR LOT LINES PROHIBIT 10 FEET OF HORIZONTAL DISTANCE, A 5-PERPENTS SLOPE SHALL BE PROVIDED TO AN APPROVED ALTERNATIVE METHOD OF DIVERTING WATER AWAY FROM THE FOUNDATION. SWALES USED FOR THIS PUPOSE SHALL BE SLOPED NOT LESS THAN 2 PERCENT WHERE LOCATED WITHIN 10 FEET OF THE BUILDING FOUNDATION. IMPERVIOUS SURFACES WITHIN 10 FEET OF THE BUILDING FOUNDATION SHALL BE SLOPED NOT LESS THAN 2 PERCENT AWAY FROM THE BUILDING.


OWNER IS RESPONSIBLE TO PERPETUATE EXSISTING DRAINAGE.


BMP'S TEMPORARY

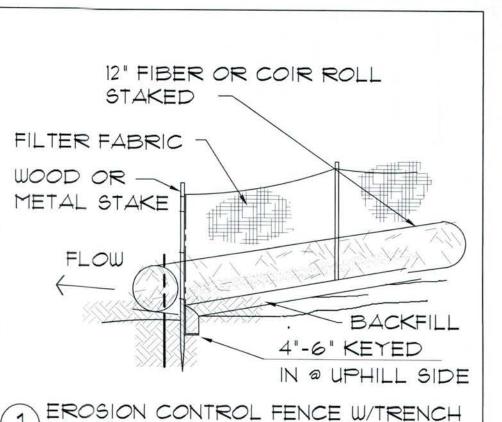


ORANGE PLASTIC FENCING OR WIRE MESH 48" HI, @ DRIPLINE METAL FENCE POSTS 48" HI TREE PROTECTION

V23-0003

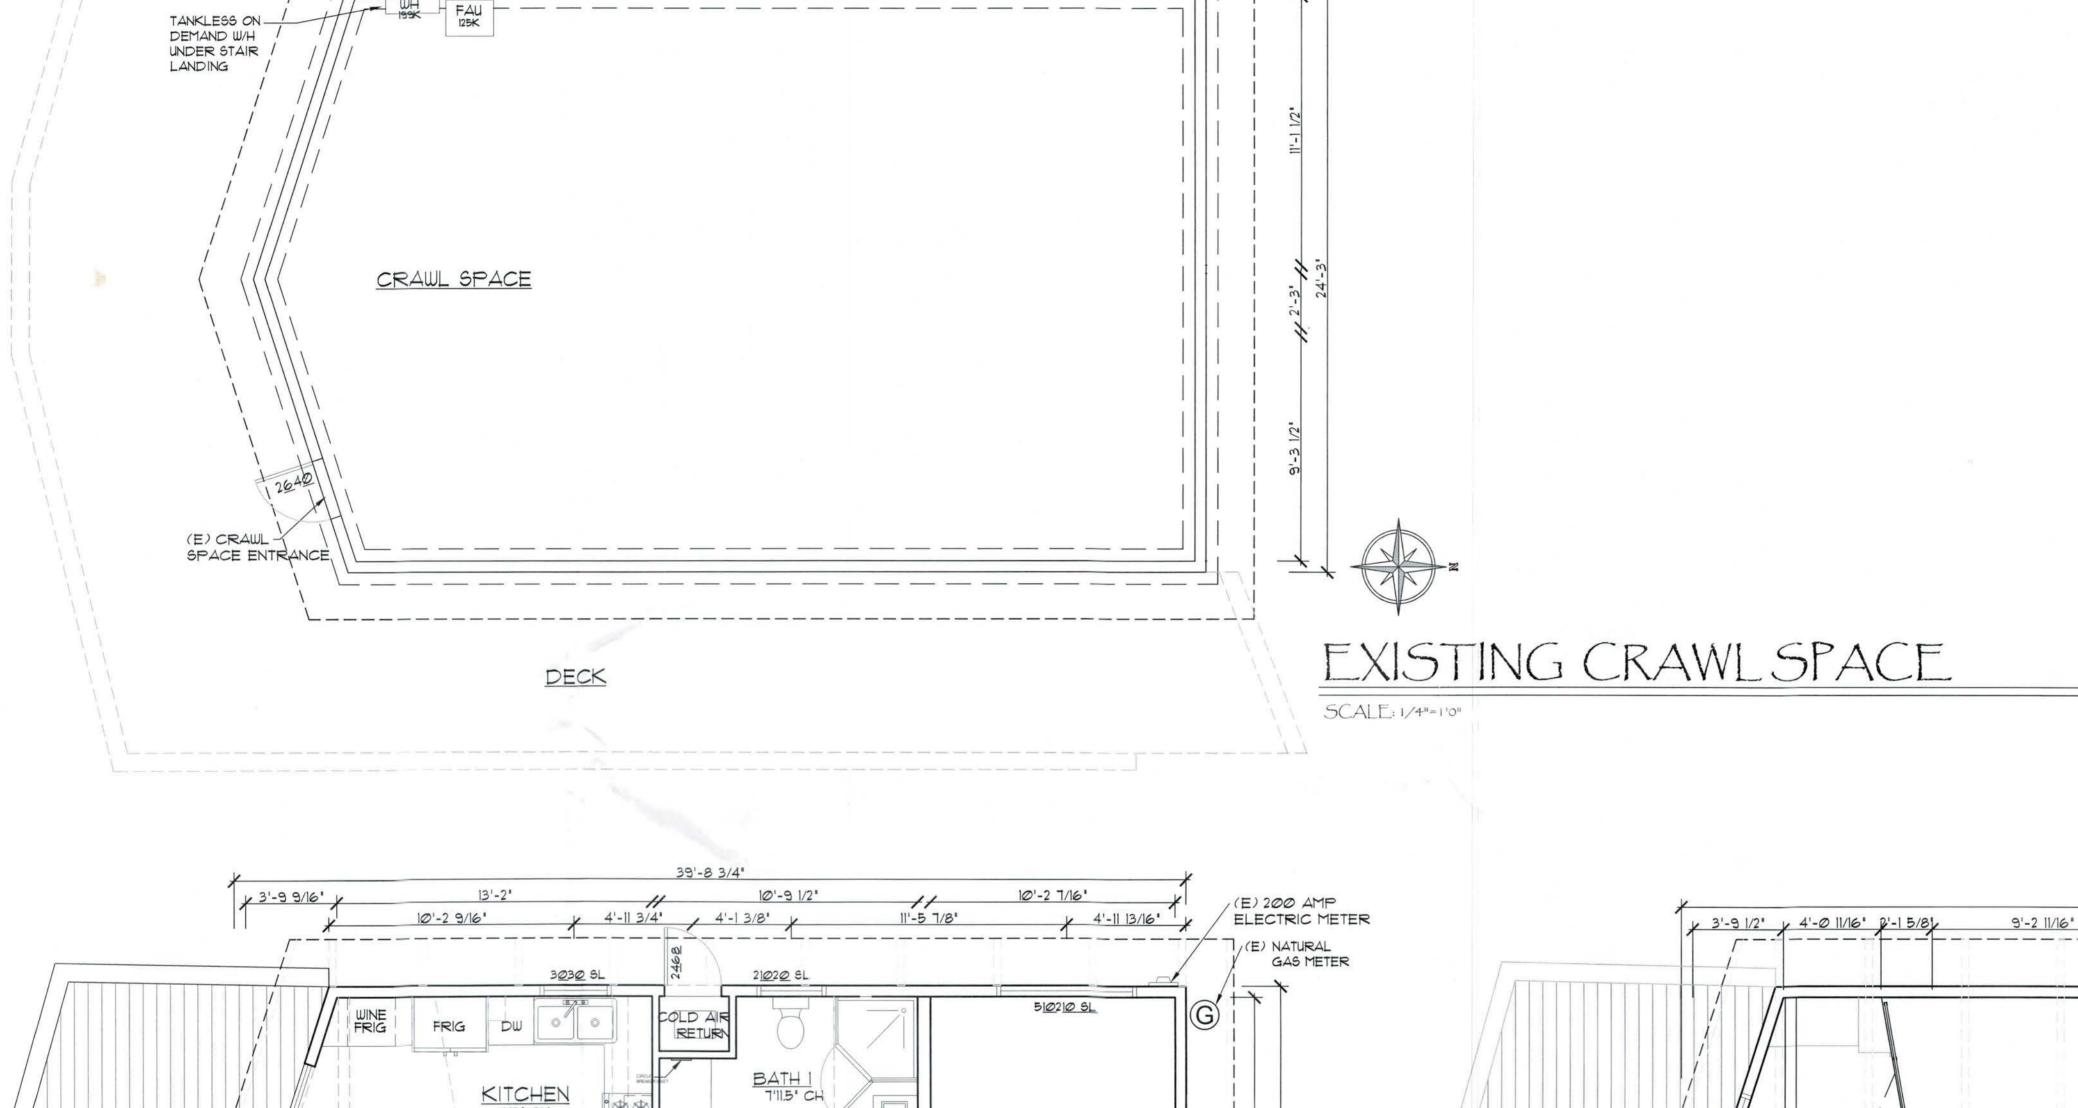

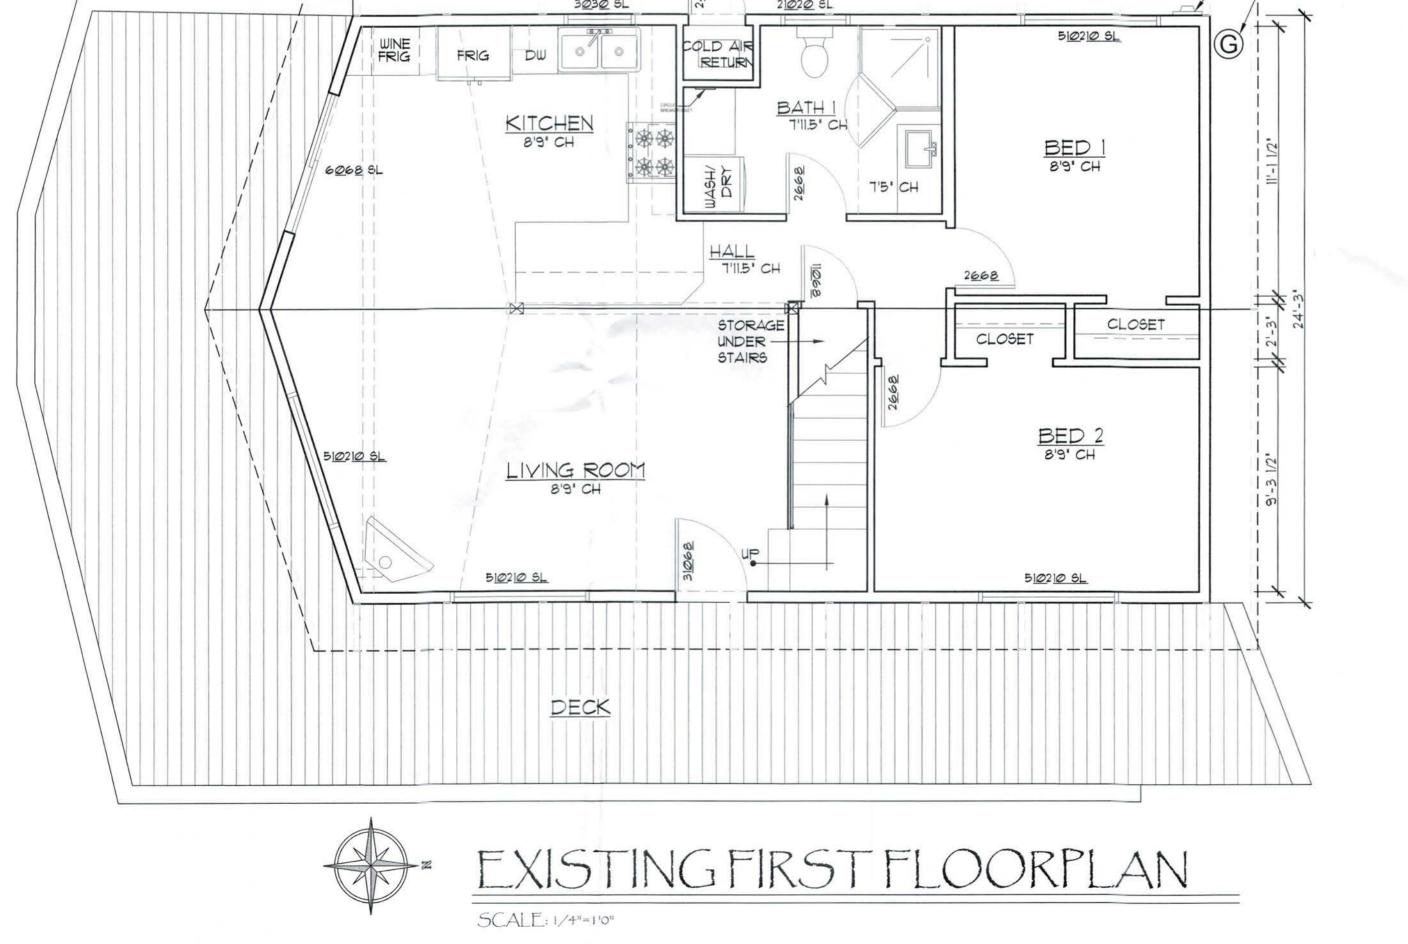

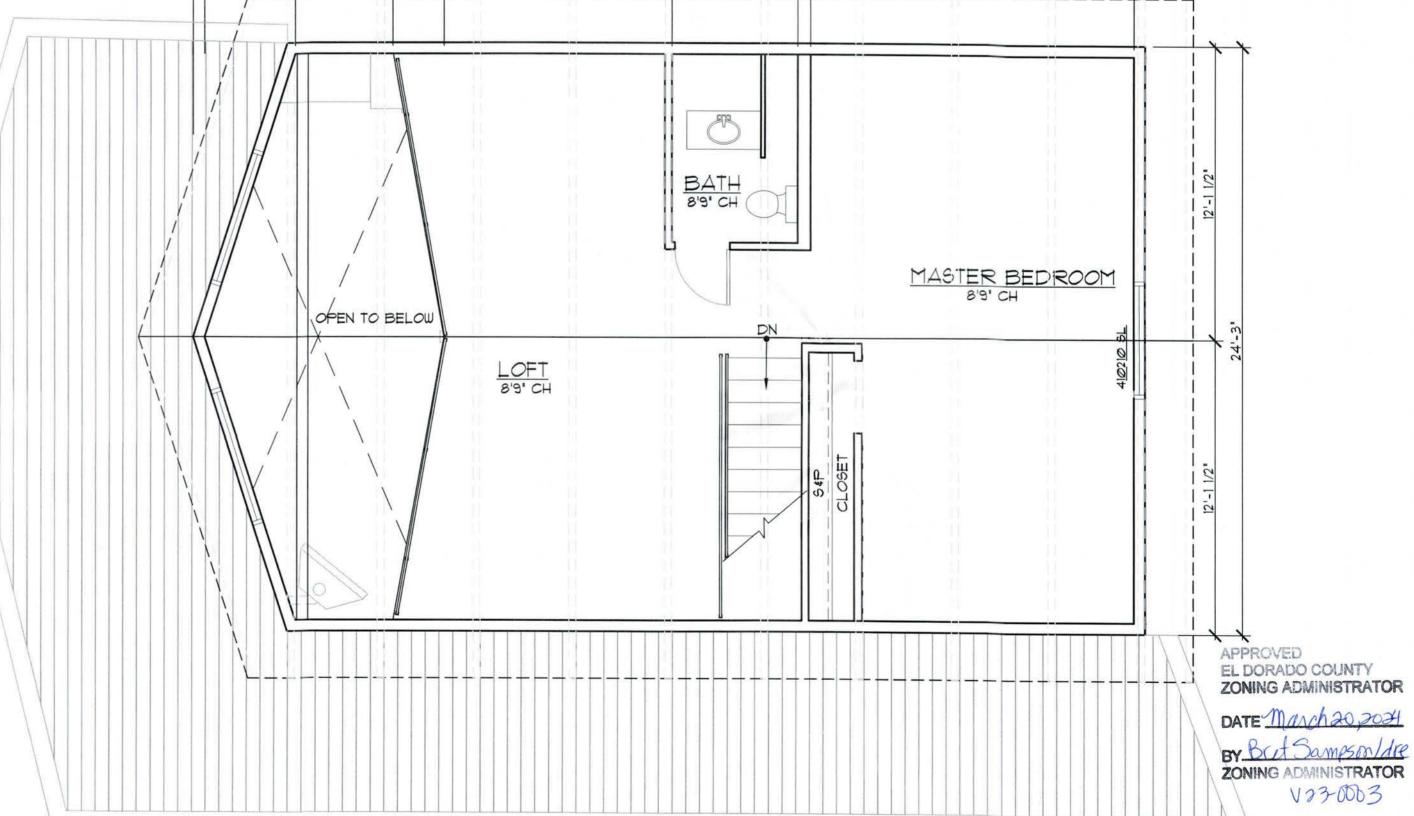

EXISTINGSECONDFLOORPLAN

SCALE: 1/4"=1"0"

39'-8 3/4"

A

V23-0003


EXISTING NSOUTH ELEVATION

SCALE 1/4**-10**

JOB No:
DRAWN BY:
CHECKED BY:
DATE PREPARED:
SCALE: QS NOTED

DRAWING I

03 A3

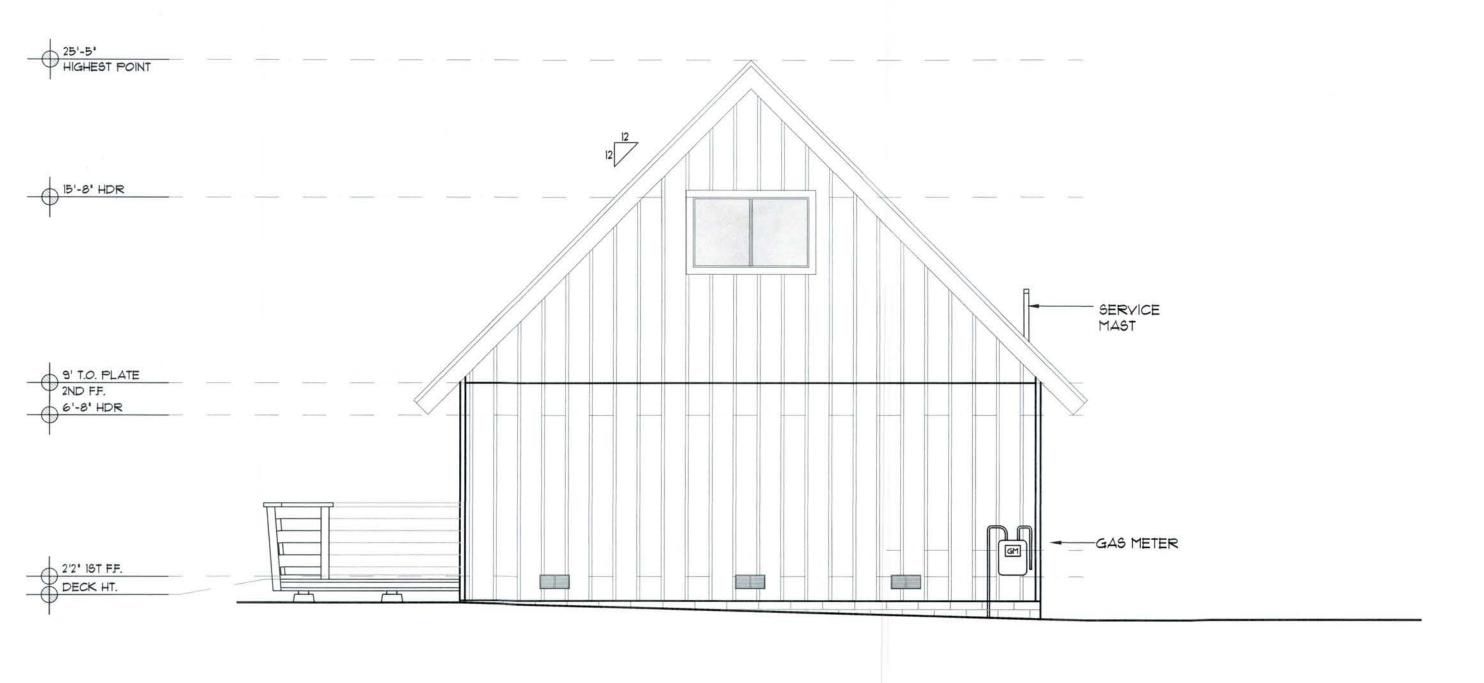

EXISTING SNORTH ELEVATION

SCALE: 1/4"=1'0"



EXISTING WEST ELEVATION

SCALE: 1/4"=1"0"

V23-0003

APPROVED
EL DORADO COUNTY
ZONING ADMINISTRATOR

BY Bret Sampson / dre ZONING ADMINISTRATOR NO3-0003

JOB No:
DRAWN BY:
CHECKED BY:
DATE PREPARED:
SCALE: QS NOTED
FILE:


A4a

V23-0003

APPROVED
EL DORADO COUNTY
ZONING ADMINISTRATOR

DATE MUNCH 20, 2024

BY BLET Sampson I dre
ZONING ADMINISTRATOR

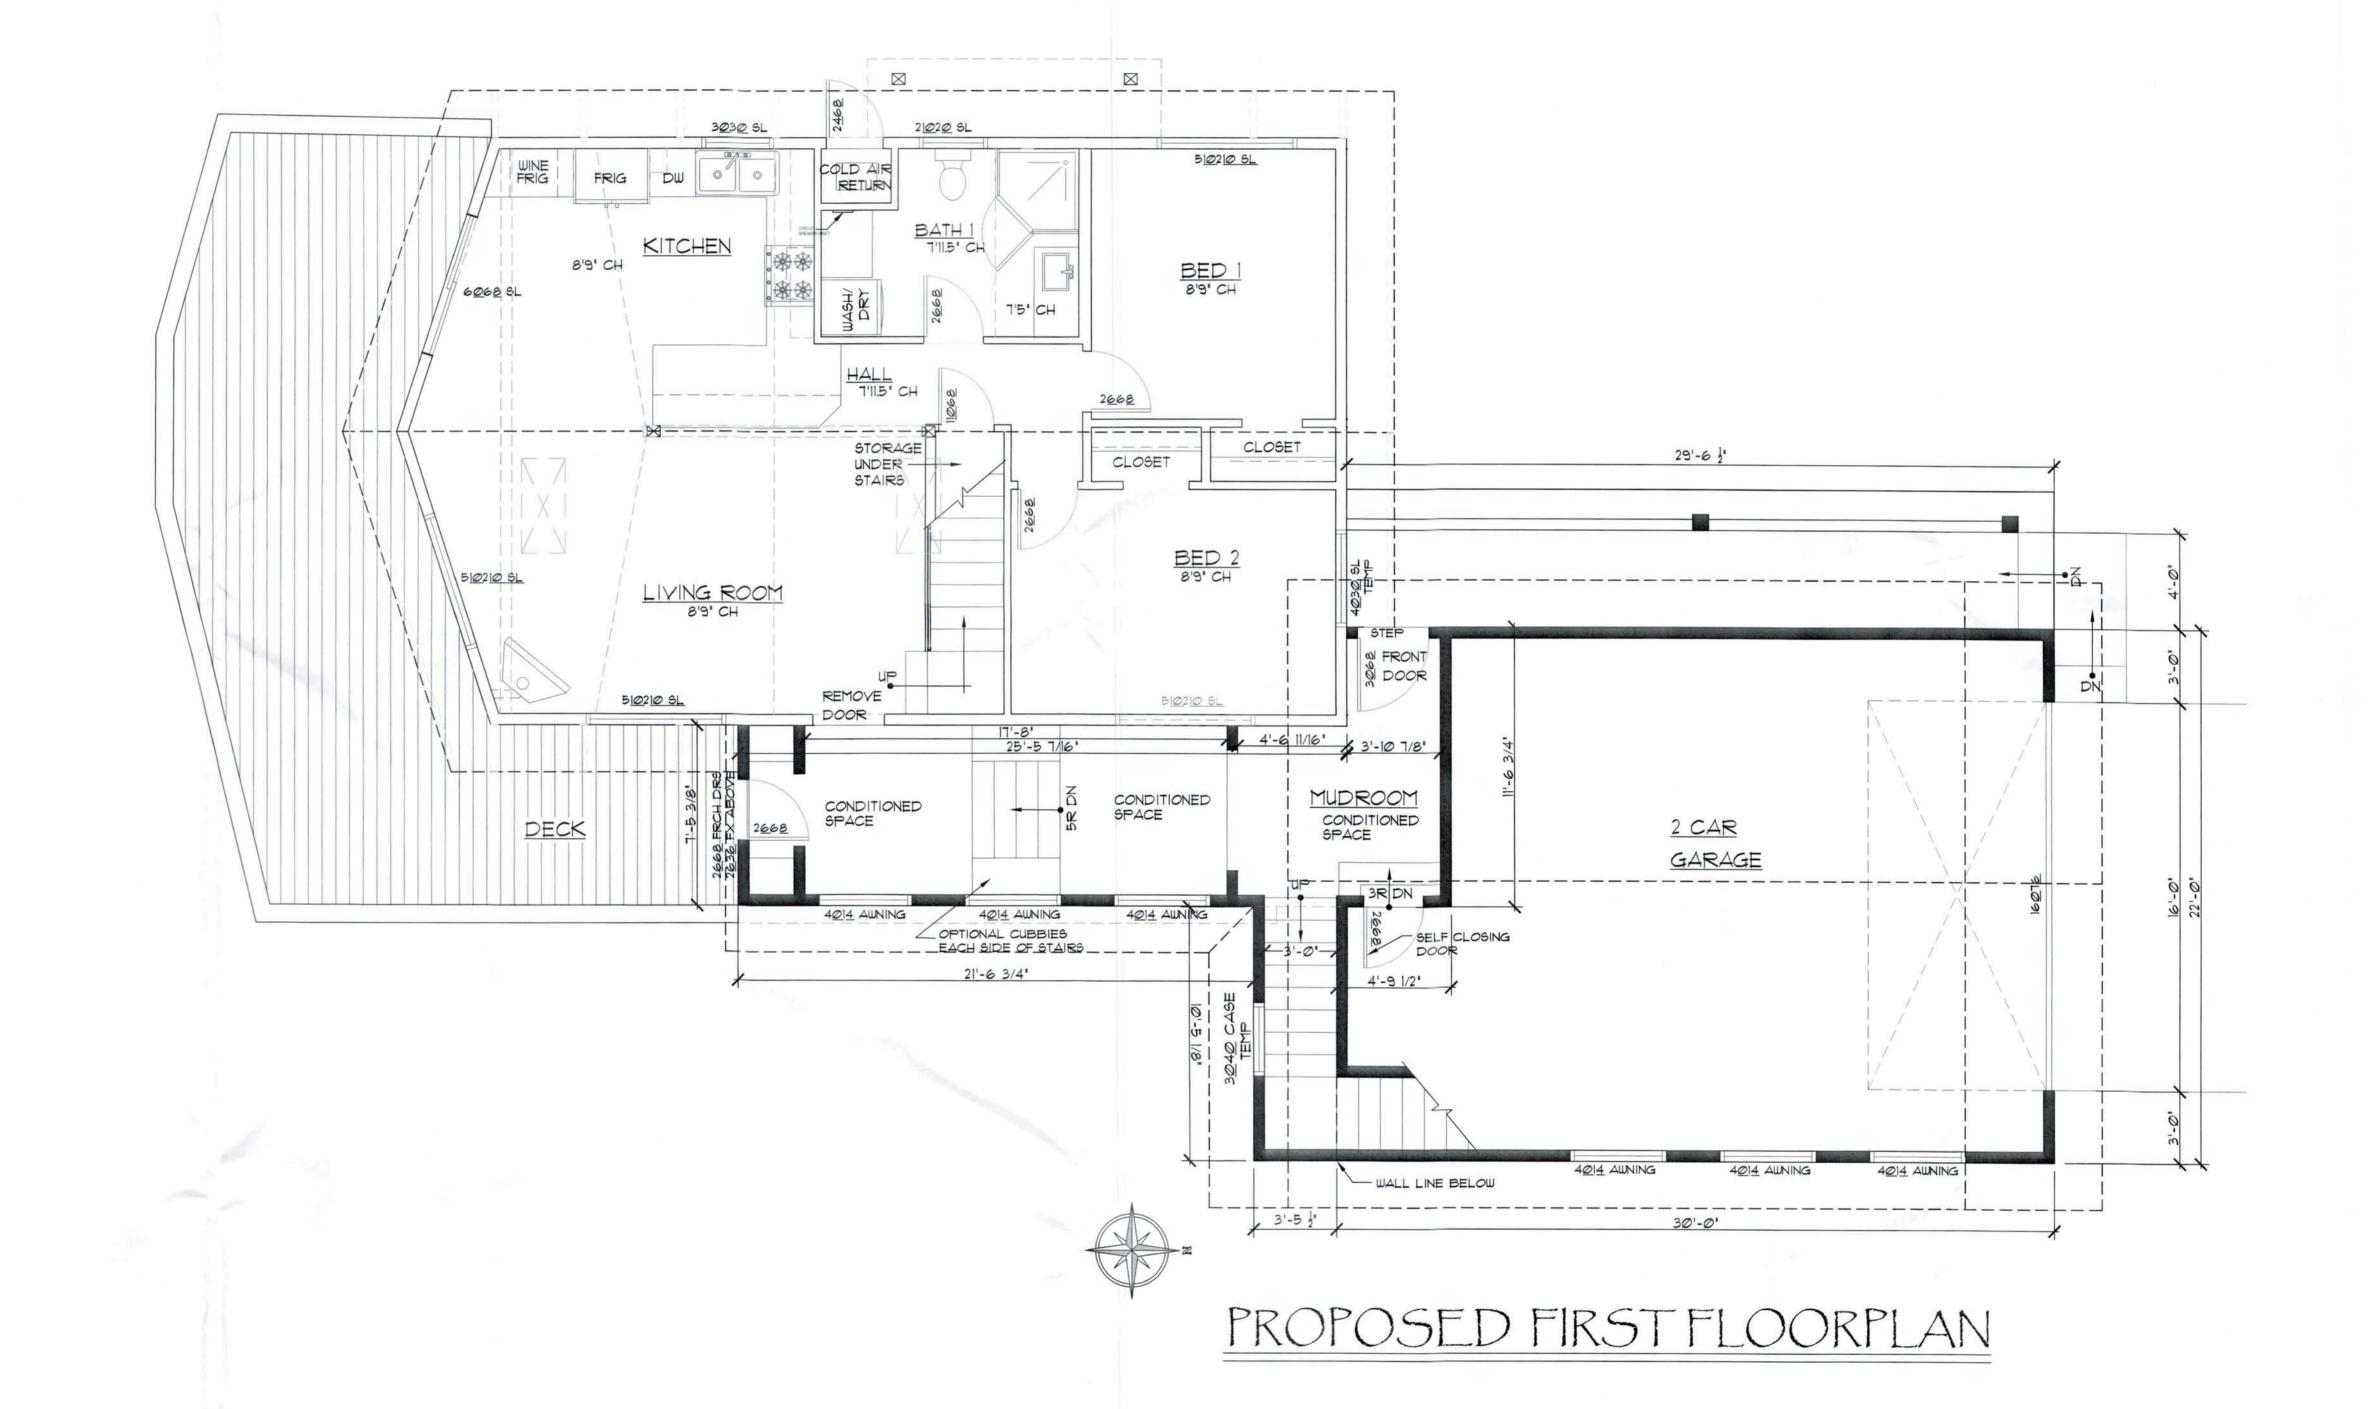

JOB No:
DRAWN BY:
CHECKED BY:
DATE PREPARED:
SCALE: as noted
FILE:


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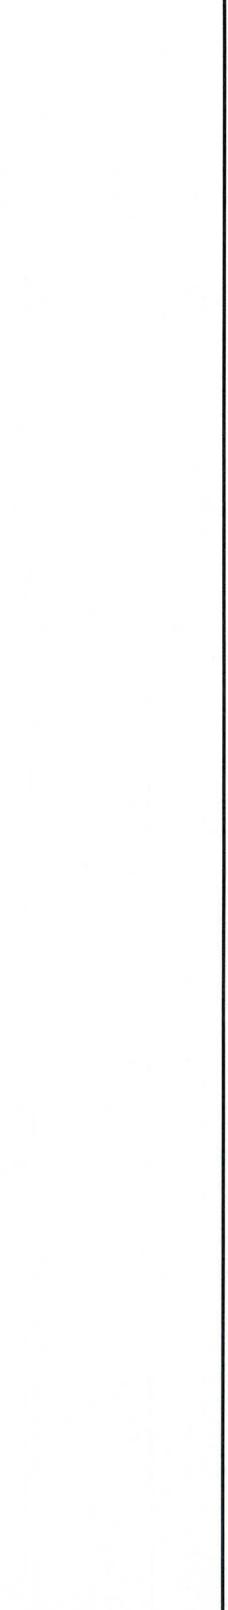
A4b

V23-0003

APPROVED
EL DORADO COUNTY
ZONING ADMINISTRATOR

BY BAD Sampson/dre ZONING ADMINISTRATOR



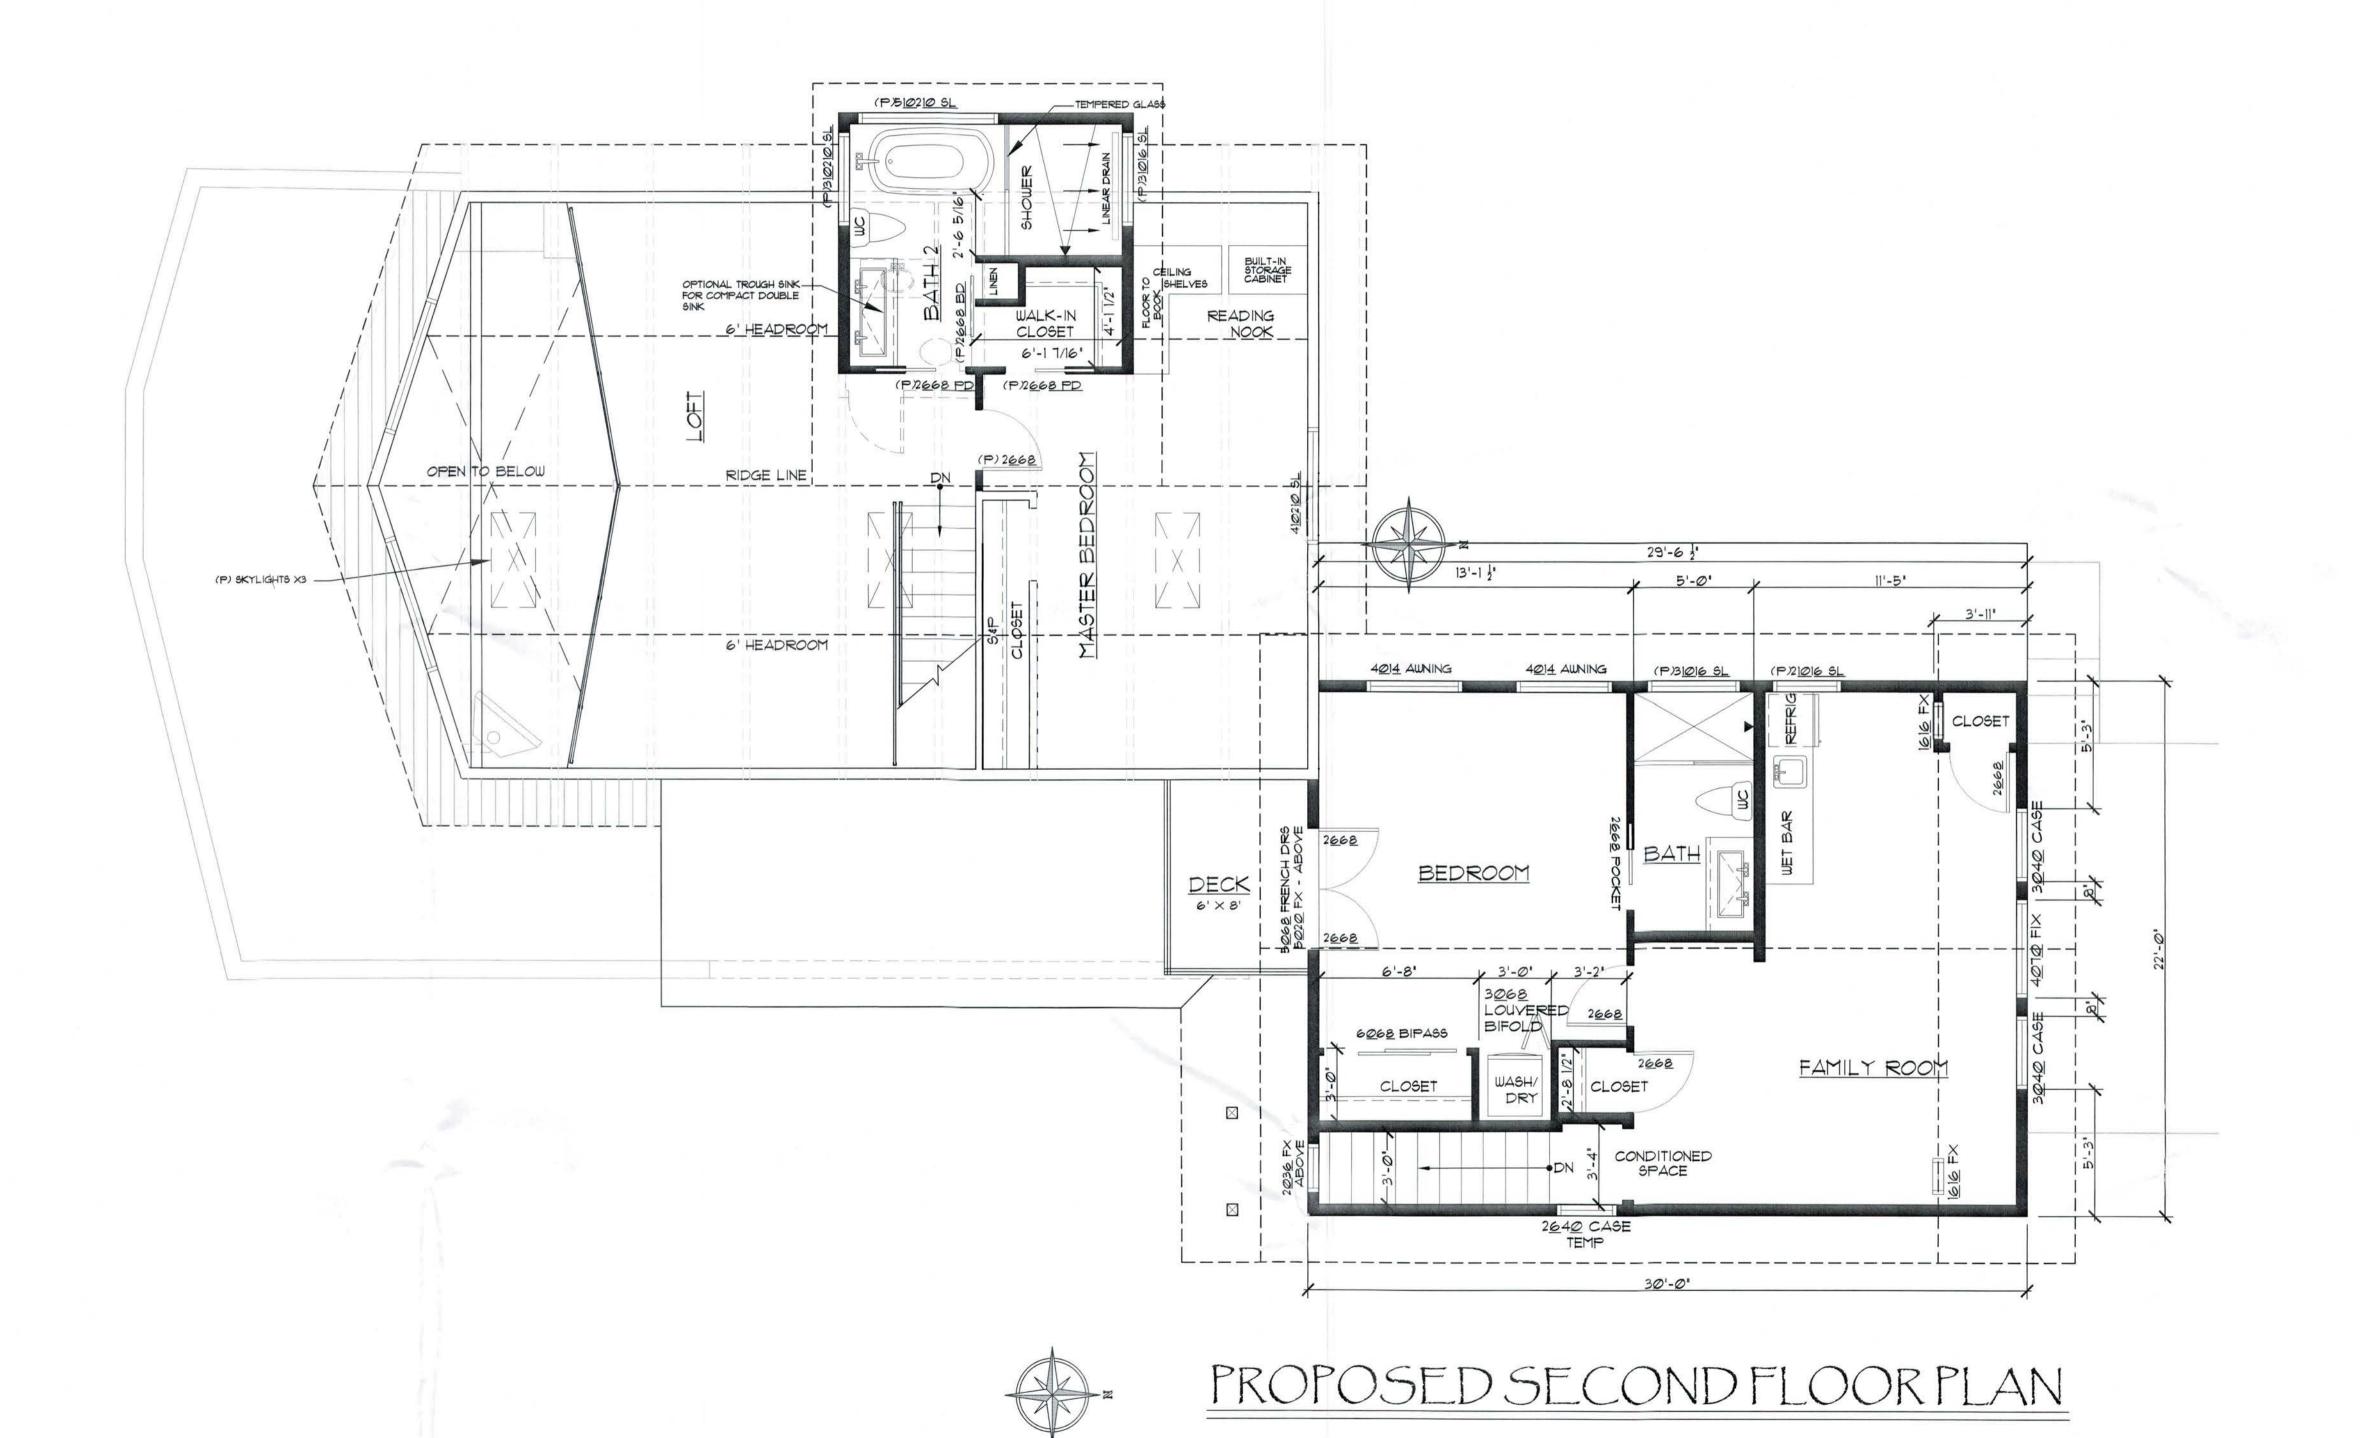

CHELSEA KASAI
1591 TIONONTATI ST
SOUTH LAKE TAHOE, CA 9618
APN: 081-074-001

REVISION: 11/10/2022

JOB No:

DRAWN BY:

CHECKED BY:

DATE PREPARED:

SCALE: OS NOTED


FILE:

DRAWING No:

V23-0003

DATE March 20, 2024



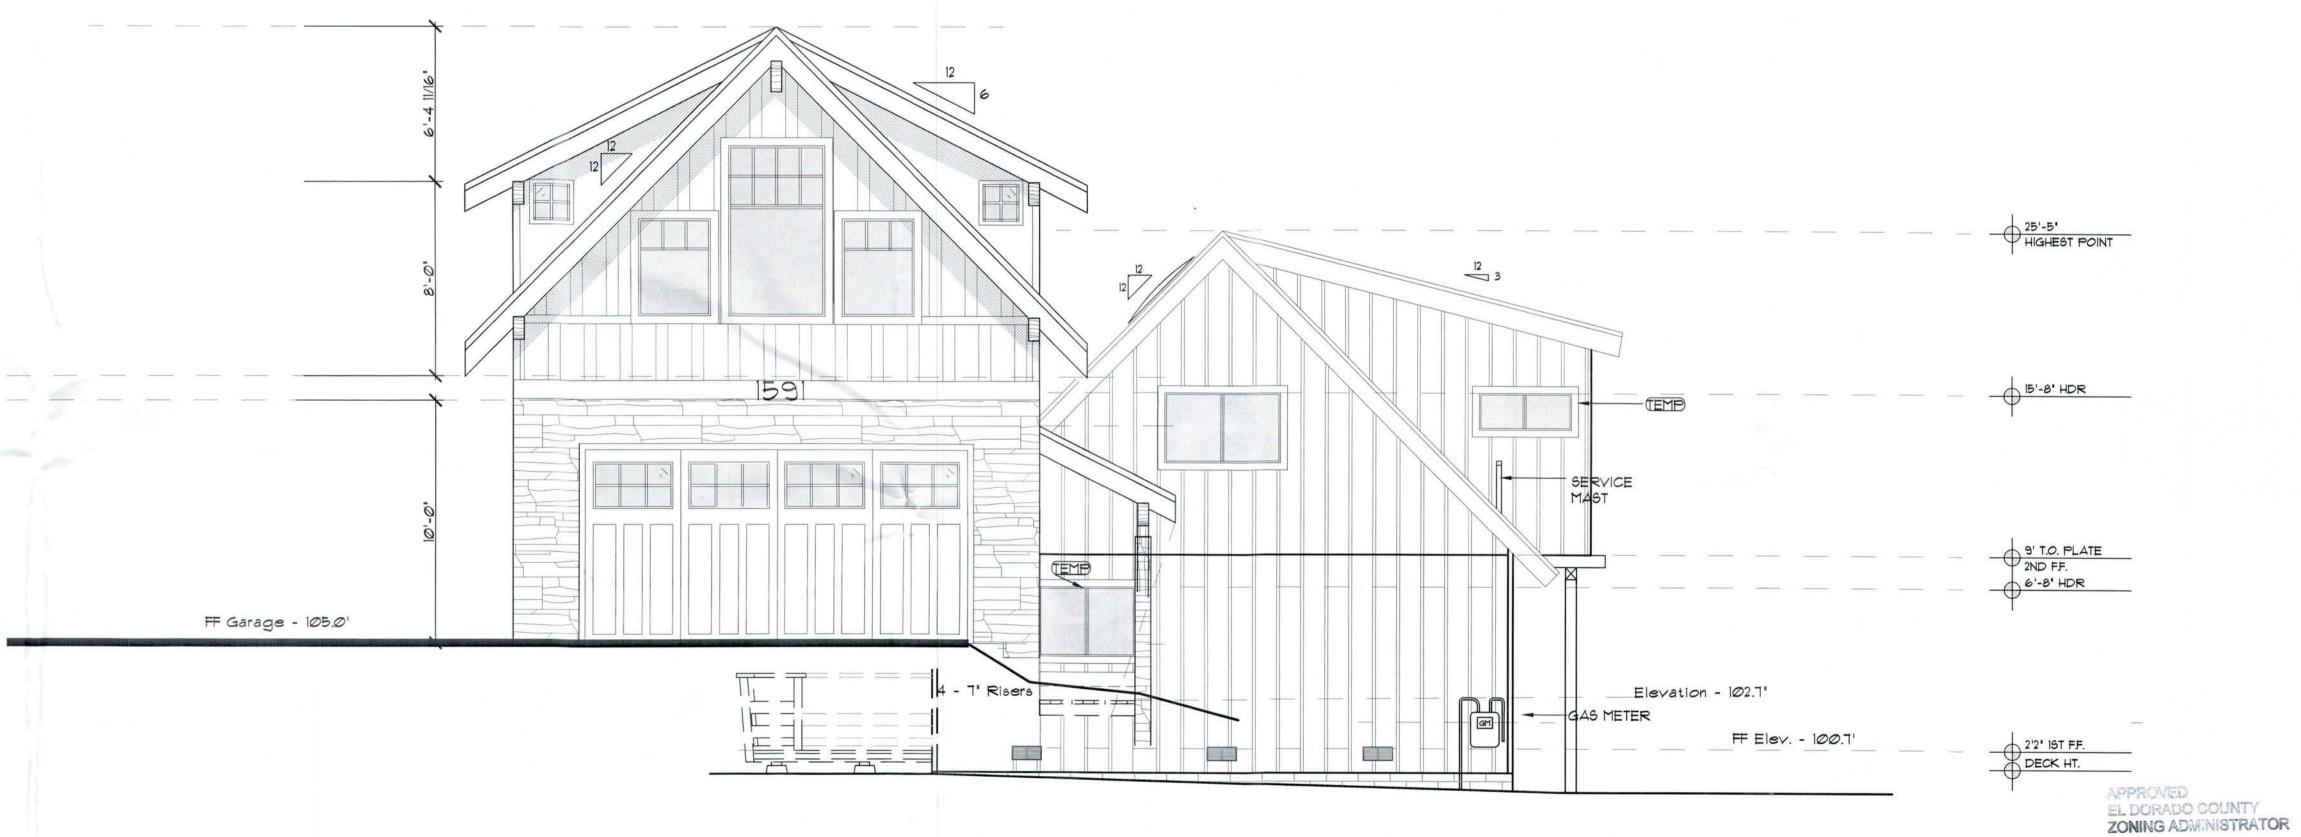

SCALE: 1/4"=1'0"

PROPOSED NORTH ELEVATION

GARAGE NORTH ELEVATION

Scale: 1/4"=11-0"


DRAWING No:

V23-0003

APPROVED
EL DORADO COUNTY
ZONING ADMINISTRATOR

DATE March 20, 2024


BY BOLF Sampson/Are ZONING ADMINISTRATOR

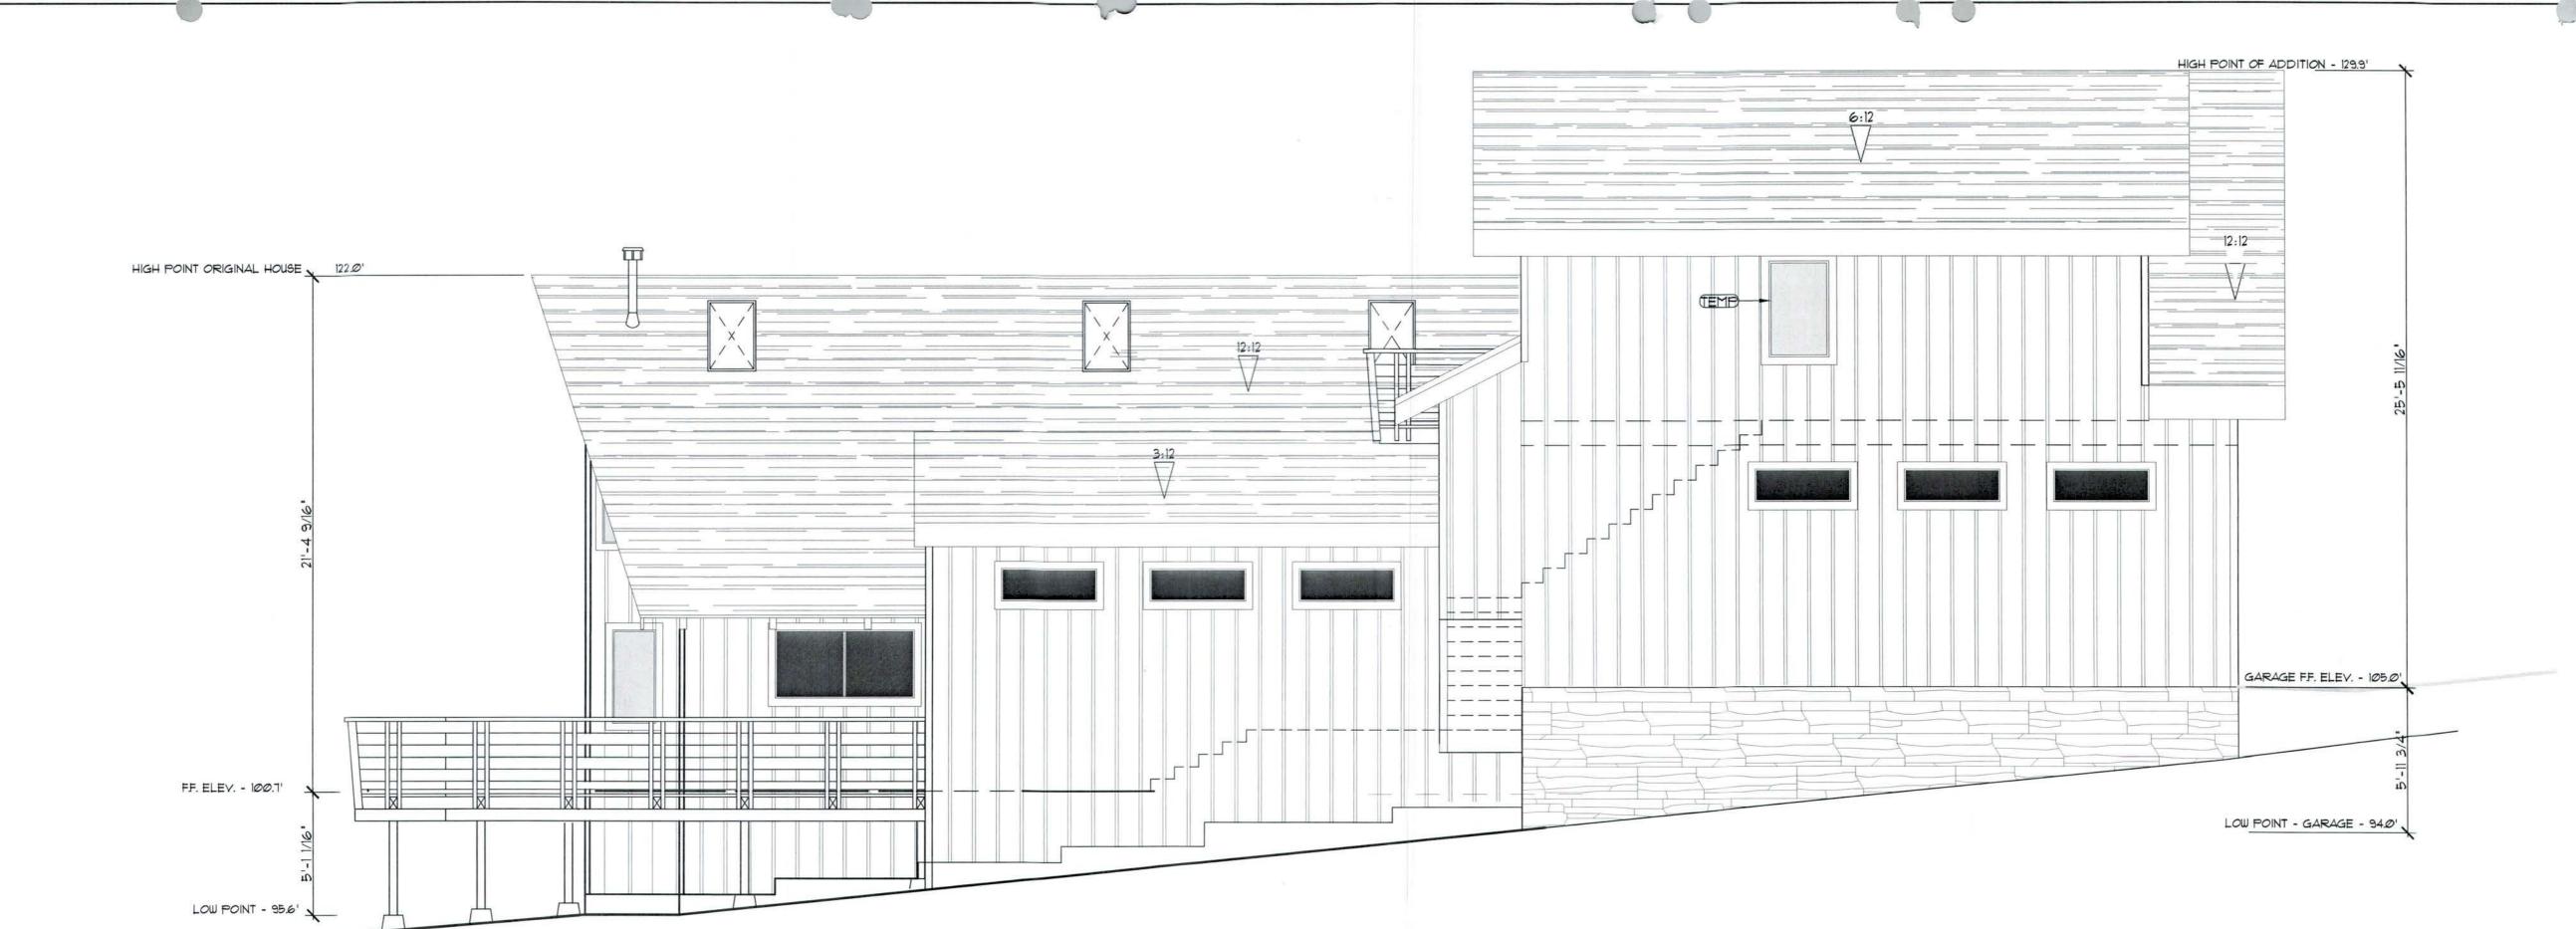

PROPOSED EAST ELEVATION

SCALE: 1/4"=1"0"

TEMP = TEMPERED GLASS FOR SAFETY GLAZING.

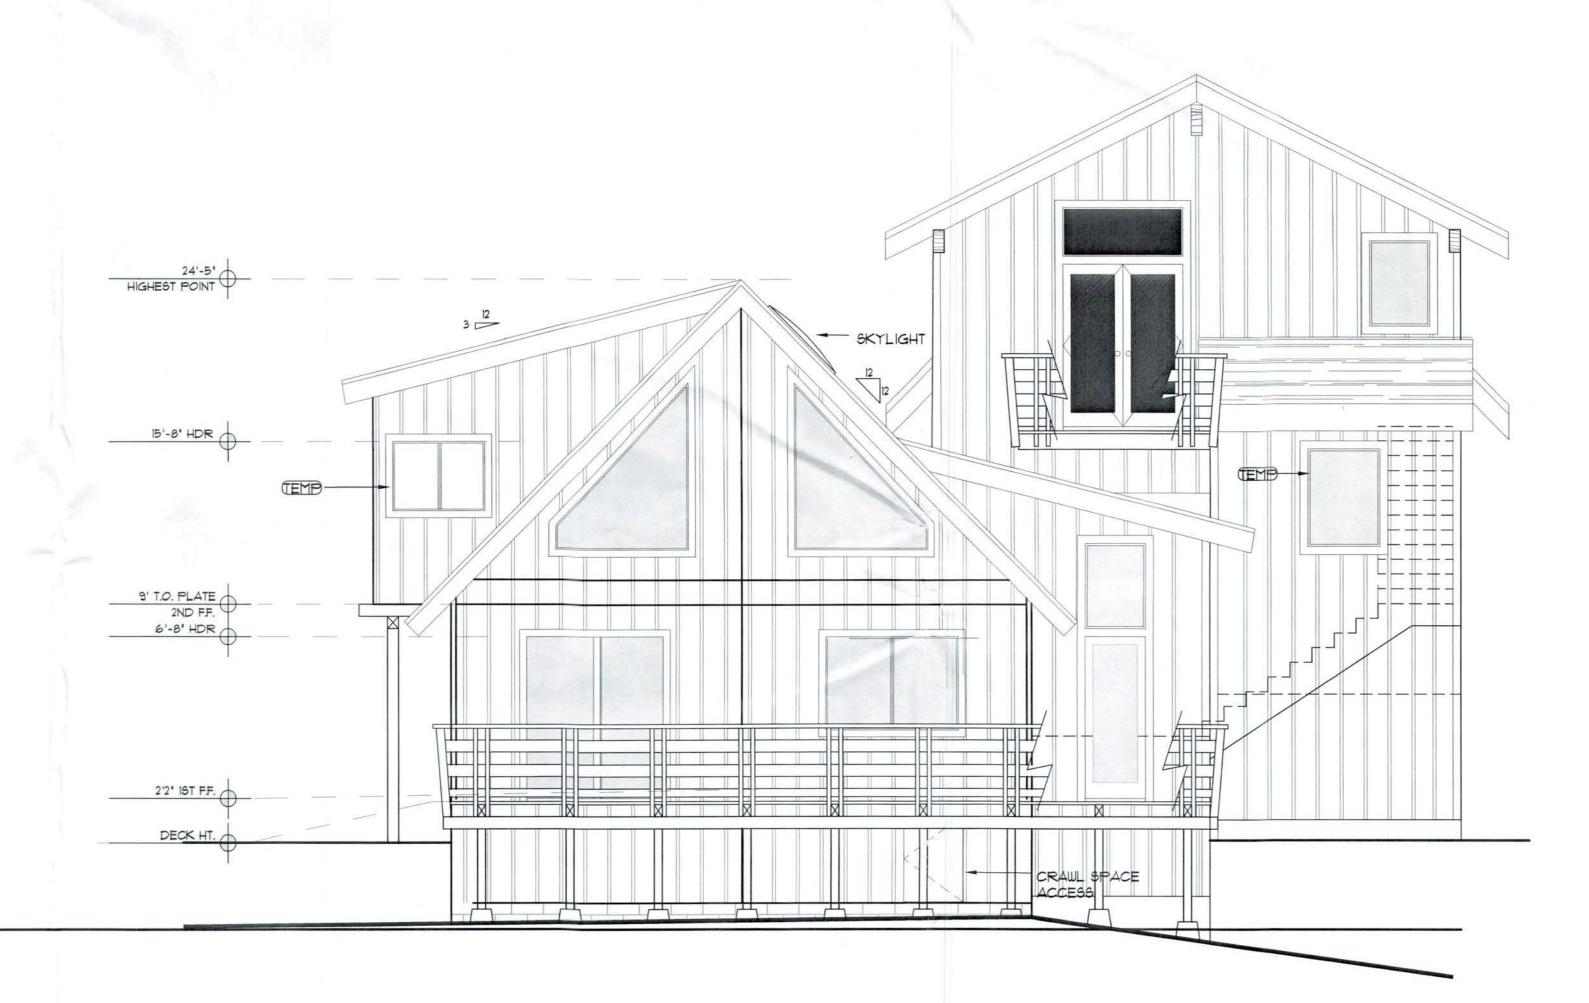

PROPOSED SOUTH ELEVATION

SCALE: 1/4"=110"

(TEMP) = TEMPERED GLASS FOR SAFETY GLAZING.