

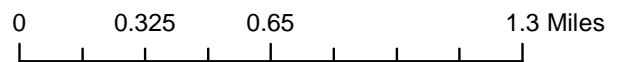


S17-0016/AT&T CAF4  
Site 4 Soapweed  
Location Map  
Exhibit A

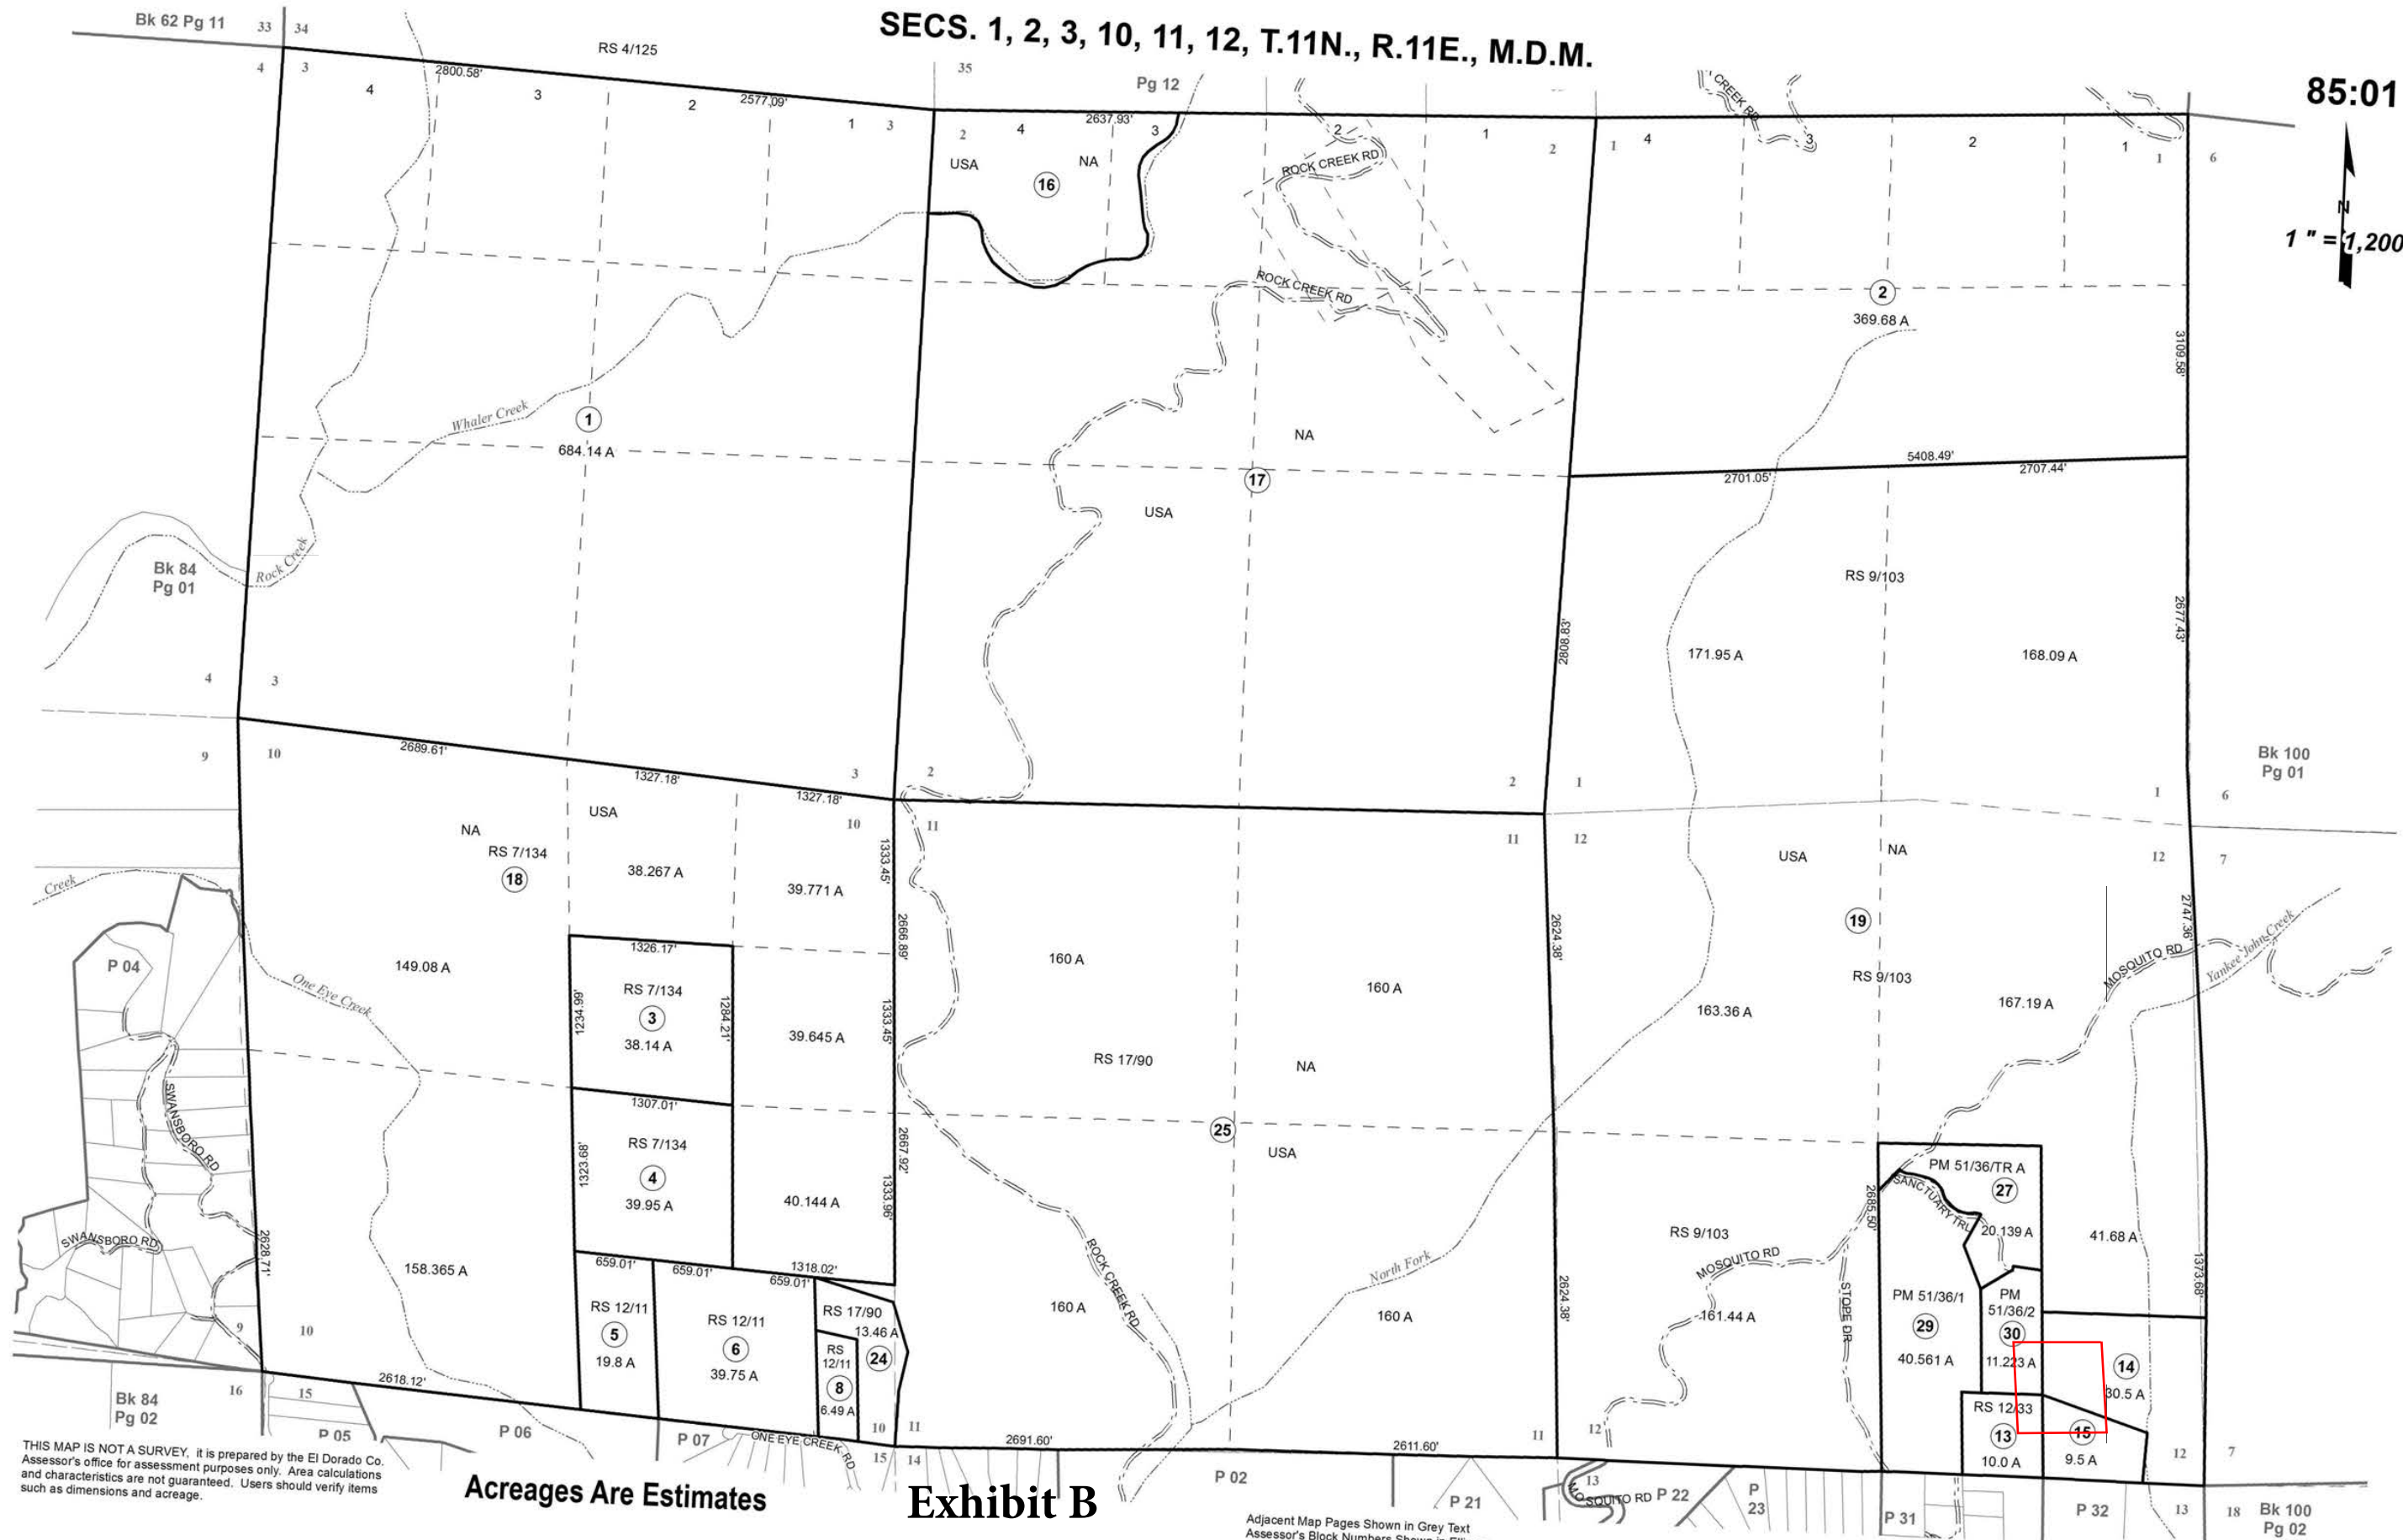

SECS. 1, 2, 3, 10, 11, 12, T.11N., R.11E., M.D.M.

85:01

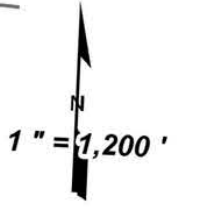

THIS MAP IS NOT A SURVEY, it is prepared by the El Dorado Co. Assessor's office for assessment purposes only. Area calculations and characteristics are not guaranteed. Users should verify items such as dimensions and acreage.


Acreages Are Estimates

**Exhibit B**  
**Site 4 Soapweed**

Adjacent Map Pages Shown in Grey Text  
Assessor's Block Numbers Shown in Ellipses  
Assessor's Parcel Numbers Shown in Circles


Rev. Feb 7, 2014


Assessor's Map Bk. 085, Pg. 01  
County of El Dorado, CA

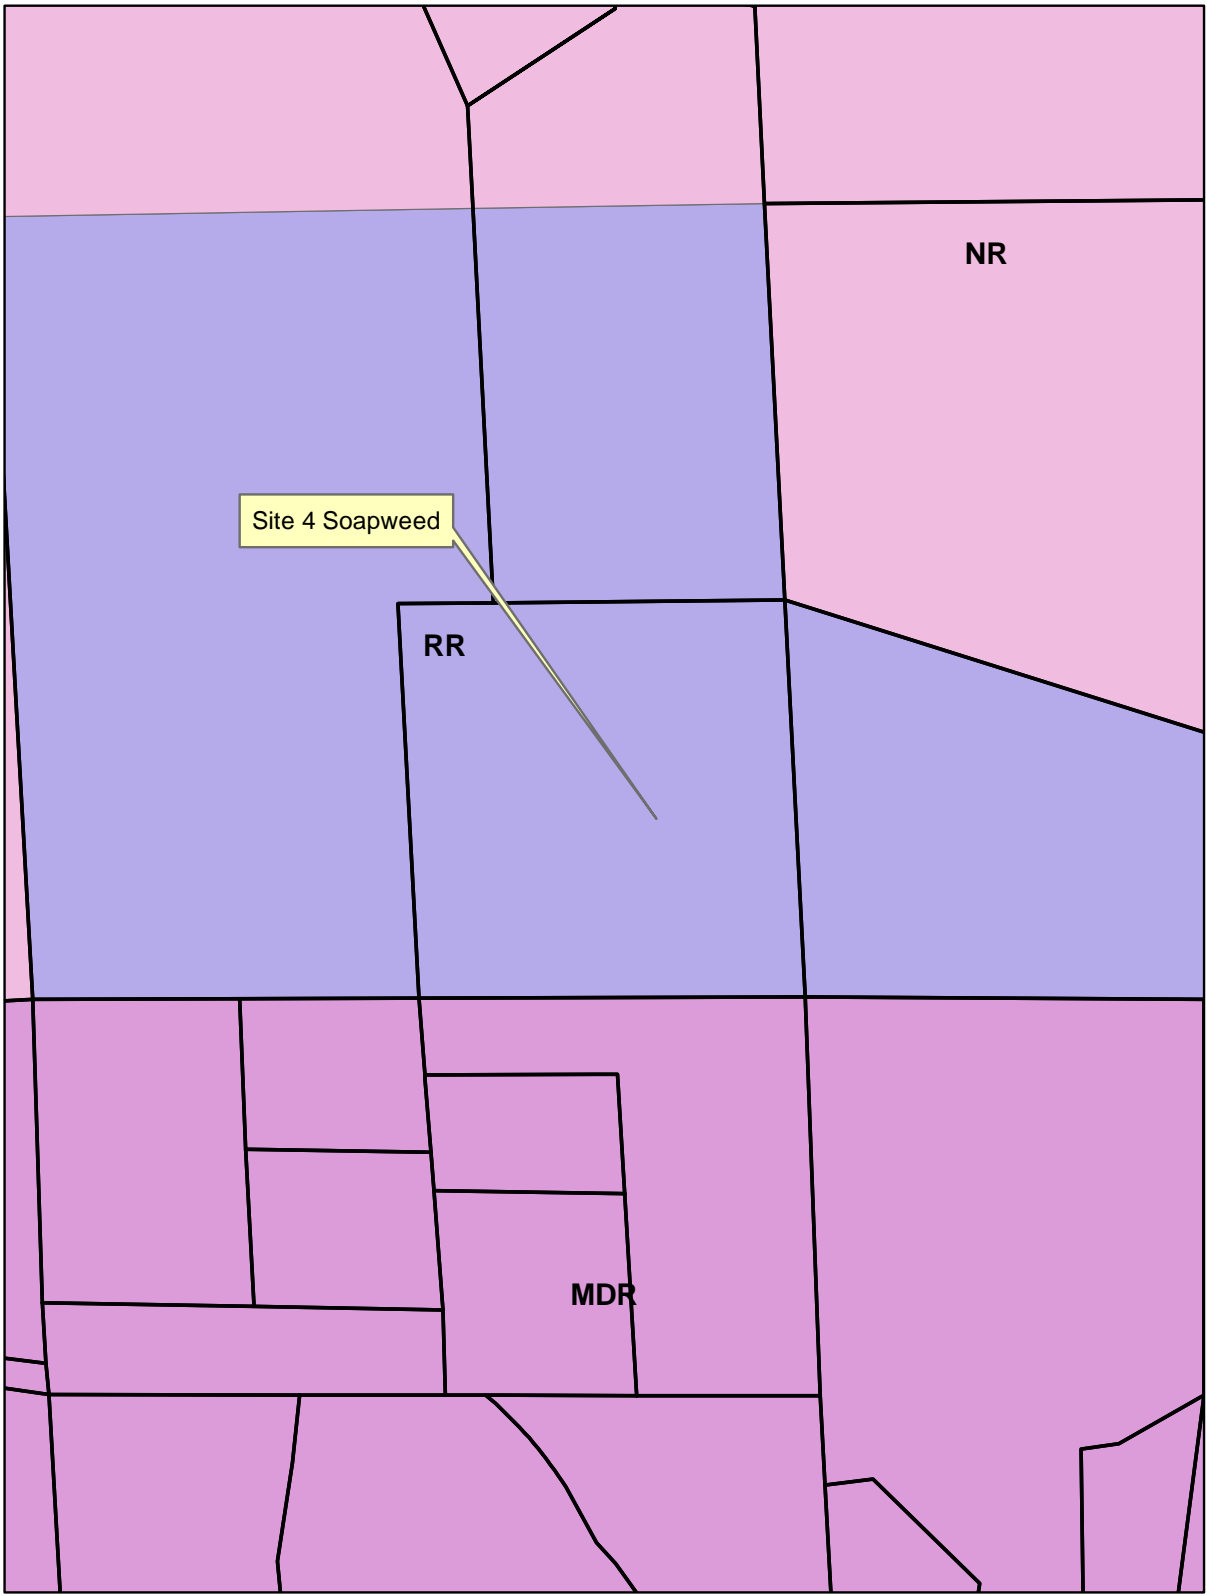




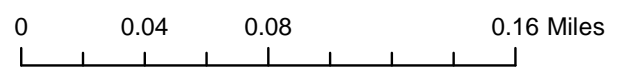

S17-0016/AT&T CAF4  
Site 4 Soapweed  
General Plan Map  
Exhibit C

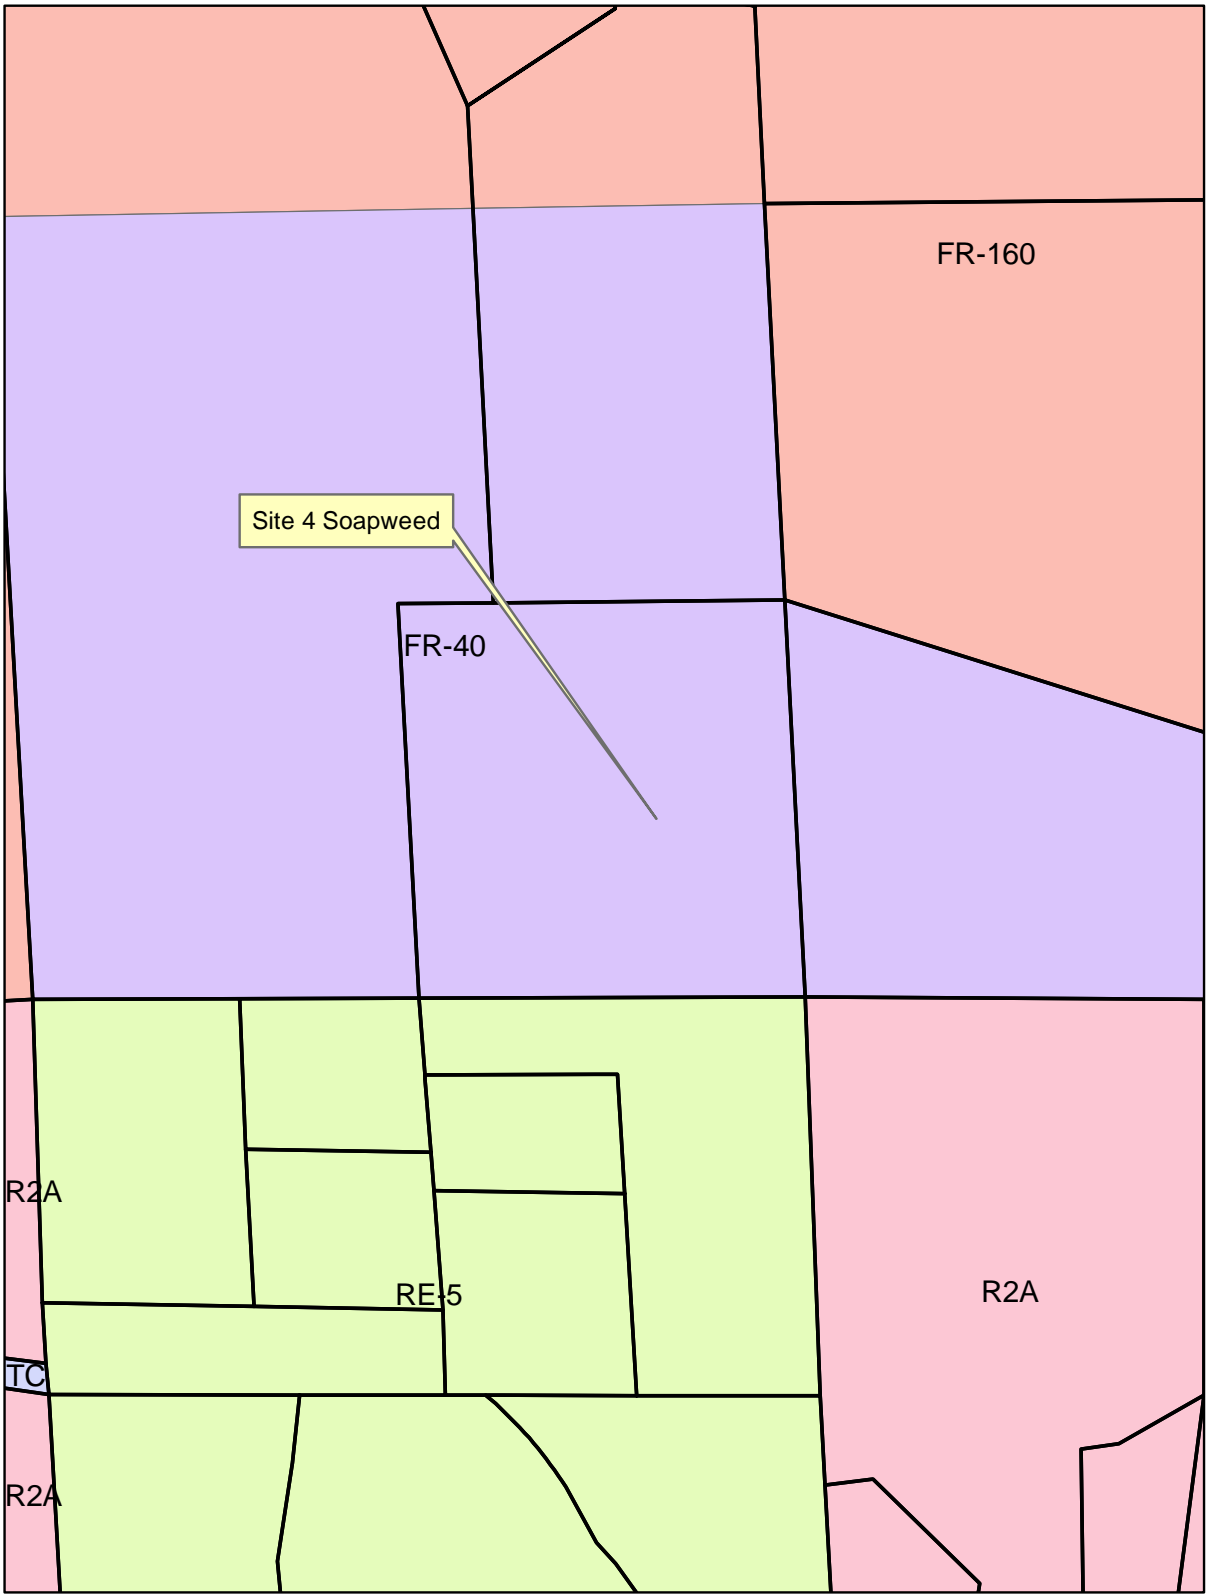
- MDR
- NR
- RR



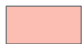

S17-0016/AT&T CAF4  
 Site 4 Soapweed  
 Zoning Map  
 Exhibit D


-  FR-160
-  FR-40
-  R2A
-  RE-5
-  TC

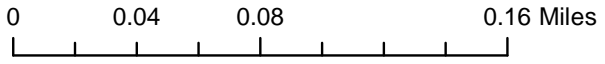





S17-0016/AT&T CAF4  
Site 4 Soapweed  
Aerial Map  
Exhibit E

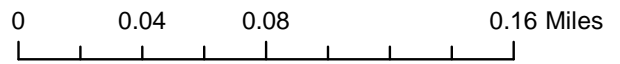





# at&t

SITE NUMBER: CVL03411  
 SITE NAME: SOAPWEED

4070 STOPE DR  
 PLACERVILLE, CA 95667

PROPRIETARY INFORMATION  
 THE INFORMATION CONTAINED IN THIS SET OF DRAWINGS IS PROPRIETARY BY NATURE. ANY USE OR DISCLOSURE OTHER THAN THAT WHICH RELATES TO PEEK SITE-COM IS STRICTLY PROHIBITED

CLIENT:

2600 CAMINO RAMON  
 SAN RAMON, CA 94583

PROJECT INFORMATION	PROJECT TEAM	SHEET INDEX	
<p><b>APPLICANT:</b>            AT&amp;T MOBILITY            2600 CAMINO RAMON            SAN RAMON, CA 94583</p> <p><b>CONSTRUCTION MANAGER:</b>            PETE MANAS            EPIC WIRELESS            8700 AUBURN FOLSOM ROAD, SUITE 400            GRANITE BAY, CA 95746            (530) 383-5957</p> <p><b>SITE SURVEY:</b>            GEIL ENGINEERING            1226 HIGH STREET            AUBURN, CA 95603            (530) 885-0426</p> <p><b>RF ENGINEER:</b>            MUHAMMAD AHMED            MA912P@ATT.COM</p> <p><b>RFDS VERSION/DATE:</b>            1.00.01 / 05-01-17</p>	<p><b>ENGINEERING FIRM:</b>            PEEK SITE-COM            12852 EARHART AVE SUITE 101            AUBURN, CA 95602            (530) 885-6160</p> <p><b>SITE ACQUISITION &amp; PLANNING:</b>            JARED KEARSLEY            EPIC WIRELESS            8700 AUBURN FOLSOM ROAD, SUITE 400            GRANITE BAY, CA 95746            (916) 755-1326</p> <p><b>CIVIL VENDOR:</b>            VINCOLUMS CONSTRUCTION MANAGER            KEN ABEL            KABEL@VINCOLUMS.COM            (916) 844-4602</p>	<p><b>SITE NAME:</b> SOAPWEED  <b>SITE NUMBER:</b> CVL03411  <b>FA LOCATION#:</b> 13787568</p> <p><b>SITE ADDRESS:</b>            4070 STOPE DR            PLACERVILLE, CA 95667</p> <p><b>ASSESSORS PARCEL NUMBER:</b> 085-010-13-100  <b>LATITUDE:</b> 38.808183°  <b>LONGITUDE:</b> -120.697967°  <b>GROUND ELEVATION:</b> 3,151' AMSL</p> <p><b>ZONING:</b> FR-40  <b>JURISDICTION:</b> EL DORADO COUNTY  <b>COUNTY:</b> EL DORADO</p> <p><b>PROPERTY OWNER:</b> DAVID JOSEPH RONZONE TR  <b>OWNER ADDRESS:</b> P.O. BOX 889            EL DORADO, CA 95623</p>	<p>T-1 TITLE SHEET            GN-1 GENERAL NOTES            GN-2 SITE SIGNAGE            C-1 SITE SURVEY            C-2 SITE SURVEY            C-3 EROSION CONTROL PLAN &amp; DETAILS            C-4 GRADING NOTES &amp; DETAILS            C-5 PRELIMINARY GROUNDING PLAN            A-1 OVERALL SITE PLAN            A-2 EQUIPMENT PLAN            A-3 ANTENNA PLAN &amp; DETAILS            A-4 ELEVATIONS</p>

PROJECT INFORMATION:

**SOAPWEED**  
 4070 STOPE DR  
 PLACERVILLE, CA 95667

REV#	DATE	DESCRIPTION	BY
1	6-14-17	90% ZONING DOC'S	RB
2	8-3-17	REV 90% ZONING DOC'S	RB
3	8-21-17	100% ZONING DOC'S	RB

CODE COMPLIANCE	VICINITY MAP	DIRECTIONS FROM AT&T	PROJECT DESCRIPTION
<p>ALL WORK AND MATERIALS SHALL BE PERFORMED AND INSTALLED IN ACCORDANCE WITH THE CURRENT EDITIONS OF THE FOLLOWING CODES AS ADOPTED BY THE LOCAL GOVERNING AUTHORITIES. NOTHING IN THESE PLANS IS TO BE CONSTRUED TO PERMIT WORK NOT CONFORMING TO THESE CODES.</p> <ol style="list-style-type: none"> <li>2016 CALIFORNIA BUILDING CODE</li> <li>2016 CALIFORNIA FIRE CODE</li> <li>2016 CALIFORNIA ELECTRICAL CODE</li> <li>2016 CALIFORNIA PLUMBING CODE</li> <li>2016 CALIFORNIA MECHANICAL CODE</li> <li>2016 CALIFORNIA HEALTH AND SAFETY CODE</li> </ol>	<p>SITE LOCATION</p>	<p>DIRECTIONS FROM AT&amp;T'S OFFICE AT 2600 CAMINO RAMON, SAN RAMON, CA</p> <ol style="list-style-type: none"> <li>TURN RIGHT ONTO CAMINO RAMON</li> <li>CONTINUE STRAIGHT TO STAY ON CAMINO RAMON</li> <li>TURN RIGHT ONTO BOLLINGER CANYON RD</li> <li>MERGE ONTO I-680 N</li> <li>TAKE EXIT 71A TOWARD I-80 E/SACRAMENTO</li> <li>MERGE ONTO I-80 E</li> <li>KEEP LEFT AT THE FORK TO CONTINUE ON I-80BL E/US-50 E/CAPITAL CITY FREEWAY, FOLLOW SIGNS FOR INTERSTATE 80 BUSINESS/SACRAMENTO/SOUTH LAKE TAHOE</li> <li>CONTINUE ONTO US-50 E/EL DORADO FWY</li> <li>TURN LEFT ONTO SPRING ST</li> <li>TURN LEFT ONTO COLOMA ST</li> <li>TURN RIGHT ONTO CA-193 W</li> <li>TURN RIGHT ONTO ROCK CREEK RD</li> <li>TURN LEFT ONTO SLUICE CREEK</li> <li>TURN RIGHT ONTO SWANSBORO RD</li> <li>TURN LEFT ONTO MOSQUITO RD</li> <li>TURN RIGHT ONTO LUPINE LN</li> <li>TURN LEFT ONTO STOPE DR</li> </ol>	<p>AT&amp;T PROPOSES TO CONSTRUCT A NEW UNMANNED TELECOMMUNICATIONS FACILITY. AT&amp;T WILL INSTALL:</p> <ul style="list-style-type: none"> <li>(1) NEW 15' WIDE GRAVEL ACCESS ROAD</li> <li>(1) NEW 40'X45' FENCED LEASE AREA</li> <li>(1) NEW 6' CHAIN LINK FENCE</li> <li>(1) NEW 12' WIDE DOUBLE ACCESS GATE</li> <li>(1) NEW 133' MONOPINE (TOP OF BRANCHES AT 140')</li> <li>(1) NEW PRE-FAB "MIC" LIGHT WEIGHT EQUIPMENT SHELTER WITH ANCILLARY INTERIOR EQUIPMENT</li> <li>(1) NEW GPS ANTENNA</li> <li>(1) NEW 15kw PROPANE GENERATOR</li> <li>(1) LP PROPANE TANK (500 GALLON)</li> <li>(12) NEW ANTENNAS</li> <li>(6) NEW RRUS-11, (3) NEW RRUS-12, (12) NEW RRUS-32</li> <li>(4) NEW SURGE SUPPRESSORS</li> <li>(2) FUTURE 4' M/W DISH</li> </ul>

COORDINATING ENGINEER:

**Peek Site-Com**  
 12852 Earhart Ave. Suite 101  
 Auburn, California 95602  
 Phone (530) 885-6160  
 E-Mail info@peeksitcom.com

OCCUPANCY & CONST. TYPE	SPECIAL INSPECTIONS	APPROVALS	GENERAL CONTRACTOR NOTES																											
<p>OCCUPANCY: U (UNMANNED)            CONSTRUCTION TYPE: V-B</p> <p><b>ACCESSIBILITY REQUIREMENTS:</b>            THIS FACILITY IS UNMANNED AND NOT FOR HUMAN HABITATION, HANDICAPPED ACCESS REQUIREMENTS ARE NOT REQUIRED IN ACCORDANCE WITH THE 2016 CALIFORNIA BUILDING CODE, CHAPTER 11B, EXCEPTION SECTION 11B-203.5</p>	<p>*SEE SPECIAL INSPECTION FORM</p> <ol style="list-style-type: none"> <li>POST-INSTALLED ANCHORS</li> <li>HIGH STRENGTH BOLTING</li> </ol>	<table border="1"> <thead> <tr> <th>APPROVED BY:</th> <th>INITIALS:</th> <th>DATE:</th> </tr> </thead> <tbody> <tr> <td>AT&amp;T:</td> <td></td> <td></td> </tr> <tr> <td>VENDOR:</td> <td></td> <td></td> </tr> <tr> <td>R.F.:</td> <td></td> <td></td> </tr> <tr> <td>LEASING/LANDLORD:</td> <td></td> <td></td> </tr> <tr> <td>ZONING:</td> <td></td> <td></td> </tr> <tr> <td>CONSTRUCTION:</td> <td></td> <td></td> </tr> <tr> <td>POWER/TELCO:</td> <td></td> <td></td> </tr> <tr> <td>PG&amp;E:</td> <td></td> <td></td> </tr> </tbody> </table>	APPROVED BY:	INITIALS:	DATE:	AT&T:			VENDOR:			R.F.:			LEASING/LANDLORD:			ZONING:			CONSTRUCTION:			POWER/TELCO:			PG&E:			<p><b>Exhibit F</b>  <b>Site 4 Soapweed</b></p> <p>DO NOT SCALE DRAWINGS</p> <p>THESE DRAWINGS ARE FORMATTED TO BE FULL SIZE 24"X36". CONTRACTOR SHALL VERIFY ALL PLANS AND EXISTING DIMENSIONS AND CONDITIONS ON THE JOBSITE AND SHALL IMMEDIATELY NOTIFY THE ARCHITECT/ENGINEER IN WRITING OF ANY DISCREPANCIES BEFORE PROCEEDING WITH THE WORK OR MATERIAL ORDERS OR BE RESPONSIBLE FOR THE SAME.</p>
APPROVED BY:	INITIALS:	DATE:																												
AT&T:																														
VENDOR:																														
R.F.:																														
LEASING/LANDLORD:																														
ZONING:																														
CONSTRUCTION:																														
POWER/TELCO:																														
PG&E:																														

SEAL:

SITE #	CHK.	DRAWN BY
CVL03411	...	RB

SHEET TITLE:

**TITLE SHEET**

SHEET NUMBER: **T-1** REVISION: **0**







This Site Operated by:  
**AT&T MOBILITY**  
2600 CAMINO RAMON, 4W850 N  
SAN RAMON, CA 94583  
IN CASE OF FIRE AND THE NEED FOR SHUTDOWN  
TO DEACTIVATE ANTENNAS CALL  
THE FOLLOWING NUMBER:  
For 24 Hour Emergency Contact and Access Please Call:  
(800) 832-6662  
Reference Site#: CVL03158  
Site Address: 4070 STOPE DR. PLACERVILLE, CA 95667

**FENCED COMPOUND SIGNAGE**

NO  
TRESPASSING

**FENCED COMPOUND SIGNAGE**

**AUTHORIZED  
PERSONNEL  
ONLY**

**DOOR/EQUIPMENT SIGN**

Property of AT&T  
**Authorized  
Personnel Only**  
In case of emergency, or prior to performing  
maintenance on this site, call \_\_\_\_\_  
and reference cell site number \_\_\_\_\_

**SHELTER/CABINET DOORS SIGNAGE**

**INFORMATION**  
AT&T MOBILITY OPERATES TELECOMMUNICATION ANTENNAS AT THIS LOCATION, FROM AT LEAST 3 FEET AWAY FROM ANY ANTENNA AND MEET ALL POSTED SIGNS.  
CONTACT THE OWNER(S) OF THE ANTENNAS BEFORE WORKING CLOSER THAN 3 FEET FROM THE ANTENNAS(S).  
CONTACT AT&T MOBILITY AT 800-388-2822 PRIOR TO PERFORMING ANY MAINTENANCE OR REPAIRS NEAR AT&T MOBILITY ANTENNAS.  
THIS IS SITE # CVL03158.  
CONTACT THE MANAGEMENT OFFICE IF THIS DOOR/ANTENNA/DATE IS FOUND UNLOCKED.  
**INFORMACION**  
EN ESTA PROPIEDAD SE UBICAN ANTENNAS DE TELECOMUNICACIONES OPERADAS POR AT&T. FAVOR MANTENER UNA DISTANCIA DE NO MENOS DE 3 PIES Y OBEDECER TODOS LOS AVISOS.  
COMUNIQUESE CON EL PROPIETARIO O LOS PROPIETARIOS DE LAS ANTENNAS ANTES DE TRABAJAR O CAMINAR DE MENOS DE 3 PIES DE LA ANTENA.  
COMUNIQUESE CON AT&T MOBILITY 800-388-2822 ANTES DE REALIZAR CUALQUIER MANTENIMIENTO O REPARACION DE LAS ANTENNAS DE AT&T MOBILITY.  
ESTA ES LA ESTACION BASE NUMERO CVL03158.  
FAVOR COMUNICARSE CON LA OFICINA DE LA ADMINISTRACION DEL EDIFICIO SI ESTA PUERTA O COMPUERTA SE ENCUENTRA SIN CERRADA.

INFORMATION SIGN 1-1

**INFORMATION**  
**ACTIVE ANTENNAS ARE MOUNTED**  
 ON THE OUTSIDE FACE OF THIS BUILDING  
 INFORMATION SIGN 1-2  
 ON THIS STRUCTURE  
**STAY BACK A MINIMUM OF 3 FEET FROM THESE ANTENNAS**  
CONTACT AT&T MOBILITY AT 800-388-2822 & FOLLOW THEIR INSTRUCTIONS PRIOR TO PERFORMING ANY MAINTENANCE OR REPAIRS CLOSER THAN 3 FEET FROM THE ANTENNAS.  
THIS IS AT&T MOBILITY SITE # CVL03158

INFORMATION SIGN 1-2

**at&t**  
**INFORMATION SIGN 1-3**  
1-1/2"  
2"  
STAY BACK 3 FEET FROM ANTENNA  
2"  
**INFORMATION SIGN 1-4**

INFORMATION SIGN 1-4

- CONTRACTOR SHALL INSTALL ALL INFORMATION SIGNAGE IN ACCORDANCE W/ AT&T WIRELESS DOCUMENT #03-0074, RF EXPOSURE POLICY AND RF SAFETY COMPLIANCE PROGRAM, LATEST EDITION.
- FABRICATION:  
\*SIGN 1-1: ENTRANCE DOOR, SEE DETAIL 1A, THIS SHEET.  
SIGN 1 IS TO BE MADE ON THE 50 MIL ALUMINUM SHEETING (SIZE 8 INCHES BY 12 INCHES) W/ (4) 1/4 INCH MOUNTING HOLES, ONE EACH CORNER OF THE SIGN FOR MOUNTING W/ HARDWARE W/ TIE WRAPS. THE MAIN BACKGROUND COLOR IS THE BE WHITE FRONT & BACK W/ BLACK LETTERING.  
THE INFORMATION BAND SHALL BE 1.2 INCH SOLID GREEN BAND W/ 0.5 INCH HIGH BLACK LETTERING. THE BODY OF THE TEXT SHALL BE IN BLACK LETTERING W/ 0.2 INCH HIGH LETTERS. THE REF LINE SHALL NE IN 1/8 INCH LETTERS.  
THE PLACEMENT OF TEXT SHALL BE DONE IN A MANNER THAT WILL PERMIT EASY READING FROM A DISTANCE OF APPROXIMATELY 6 FEET IN FRONT OF THE SIGN.  
ALL PAINT WILL BE BAKER W/ ENAMEL W/ UV PROTECTIVE COATING OVER THE FACE OF THE SIGN.

- \*SIGN 1-2 POLE, SEE DETAIL 1B, THIS SHEET.  
SIGN 2 MUST BE A NON METALLIC LABEL W/ AN ADHESIVE BACKING, THE LABEL SHALL BE MADE USING VINYL OR SIMILAR WEATHERPROOF MATERIAL. THE LABEL SHALL BE APPROXIMATELY SIX INCHES W/ A WHITE BACKGROUND AND BLACK LETTERING. THE GREEN BAND SHALL BE 1.375 INCH IN HEIGHT & THE LETTERING SHALL BE BLACK W/ 0.75 INCH HIGH LETTERS. THE TEXT LETTERING SHALL BE BLACK W/ 1/8 INCH HIGH LETTERS. UV PROTECTION SHALL BE PLACED OVER THE FRONT OF THE LABEL.  
\*SIGN 1-3: BACK OF ANTENNAS, SEE DETAIL 1C & 3, THIS SHEET  
\*SIGN 3 IS A 1 INCH X 2 INCH PANEL THAT CAN BE APPLIED TO THE BACK OR SIDE OF AN ANTENNA TO IDENTIFY IT AS AN AT&T ANTENNA.  
\*SIGN 1-4: SIDE OF ANTENNAS, SEE DETAIL 1D & 3, THIS SHEET  
SIGN 4 IS MADE FROM TRANSPARENT MATERIAL 1-1/2 INCHES WIDE & 24 INCHES LONG. THE LETTERING IS TO BE BLACK W/ 1/2 INCH LETTERING IN A VERTICAL COLUMN. THE SPACING BETWEEN WORDS MUST BE SUCH THAT IT IS EASILY READ & FILLS THE LENGTH OF THE SIGN.

**INFORMATION SIGNAGE**

**INFORMATION**  
Federal Communications Commission  
Tower Registration Number  
**1 2 3 4 5 6 7**  
Posted in accordance with federal Communications Commission rules and antenna tower registration 47CFR 17.4(g).

**FCC ASR SIGNAGE**

Property of AT&T  
**Authorized  
Personnel Only**  
No Trespassing  
Violators will be Prosecuted  
In case of emergency, or prior to performing  
maintenance on this site, call \_\_\_\_\_  
and reference cell site number \_\_\_\_\_

**GATE SIGNAGE**

- NOTE:**
- CONTRACTOR SHALL INSTALL ALL INFORMATION SIGNAGE IN ACCORDANCE W/ AT&T WIRELESS DOCUMENT #03-0074, RF EXPOSURE POLICY AND RF SAFETY COMPLIANCE PROGRAM, LATEST EDITION.
  - CONTRACTOR SHALL CONTACT AT&T R-RFSC FOR INFORMATION ON MPE LEVELS AND INSTRUCTIONS ON LEVEL AND LOCATION OF SIGNAGE.

**WARNING**  
**Beyond This Point you are entering a controlled area where RF Emissions exceed the FCC Controlled Exposure limits**  
Failure to obey all posted signs and site guidelines could result in serious injury  
Ref: FCC 47CFR 1.1307(b)

**CAUTION AND WARNING SIGN**

**CAUTION**  
**Beyond This Point you are entering a controlled area where RF Emissions may exceed the FCC Controlled Exposure limits**  
Obey all posted signs and site guidelines for working in an RF environment  
Ref: FCC 47CFR 1.1307(b) at&t

**NOTICE**  
**Beyond This Point you are entering an area where RF Emissions may exceed the FCC General Population Exposure Limits**  
Follow all posted signs and site guidelines for working in an RF environment  
Ref: FCC 47CFR 1.1307(b) at&t

**GENERAL NOTES**

**SIGNAGE AND STRIPING INFORMATION**

- THE FOLLOWING INFORMATION IS A GUIDELINE W/ RESPECT TO PREVAILING STANDARDS LIMITING HUMAN EXPOSURE TO RADIO FREQUENCY ENERGY AND SHOULD BE USED AS SUCH. IF THE SITE'S EMF REPORT OR ANY LOCAL, STATE OR FEDERAL GUIDELINES OR REGULATIONS SHOULD BE IN CONFLICT W/ ANY PART OF THESE NOTES OR PLANS, THE MORE RESTRICTIVE GUIDELINE OR REGULATION SHALL BE FOLLOWED AND OVERRIDE THE LESSER.
- THE PUBLIC LIMIT OF RF EXPOSURE ALLOWED BY AT&T IS 1MWCM<sup>2</sup> AND THE OCCUPATIONAL LIMIT OF RF EXPOSURE ALLOWED BY AT&T IS 5MWCM<sup>2</sup>.
- IF THE BOTTOM OF THE ANTENNA IS MOUNTED (8) EIGHT FEET ABOVE THE GROUND OR WORKING PLATFORM LINE OF THE PERSONAL COMMUNICATION SYSTEM (PCS) AND DOES NOT EXCEED THE PUBLIC LIMIT OF RF EXPOSURE LIMIT THEN NO STRIPING OR BARRICADES SHOULD BE NEEDED.
- IF THE PUBLIC LIMIT OF RF EXPOSURE ON THE SITE IS EXCEEDED AND THE AREA IS PUBLICLY ACCESSIBLE (E.G. ROOF ACCESS DOOR THAT CANNOT BE LOCKED, OR FIRE EGRESS) THEN BOTH BARRICADES AND STRIPING SHALL BE PLACED AROUND THE ANTENNAS. THE EXACT EXTENT OF THE BARRICADES AND STRIPING SHALL BE DETERMINED BY THE EMF REPORT FOR THE SITE DONE BEFORE OR SHORTLY AFTER COMPLETION OF SITE CONSTRUCTION. USE THE PLANS AS A GUIDELINE FOR PLACEMENT OF SUCH BARRICADES AND STRIPING.
- IF THE PUBLIC LIMIT OF RF EXPOSURE ON THE SITE IS EXCEEDED AND THE AREA IS PUBLICLY ACCESSIBLE (E.G. ROOF ACCESS DOOR THAT CANNOT BE LOCKED, OR FIRE EGRESS) THEN BOTH BARRICADES AND STRIPING SHALL BE PLACED AROUND THE ANTENNAS. THE EXACT EXTENT OF THE BARRICADES & STRIPING SHALL BE DETERMINED BY THE EMF REPORT FOR THE SITE DONE BEFORE OR SHORTLY AFTER COMPLETION OF SITE CONSTRUCTION. USE THE PLANS AS A GUIDELINE FOR PLACEMENT OF SUCH BARRICADES AND STRIPING.
- ALL TRANSMIT ANTENNAS REQUIRE A THREE LANGUAGE WARNING SIGN WRITTEN IN ENGLISH, SPANISH, AND CHINESE. THIS SIGN SHALL BE PROVIDED TO THE CONTRACTOR BY THE AT&T CONSTRUCTION PROJECT MANAGER AT THE TIME OF CONSTRUCTION. THE LARGER SIGN SHALL BE PLACED IN PLAIN SIGHT AT ALL ROOF ACCESS LOCATIONS AND ON ALL BARRICADES. THE SMALLER SIGN SHALL BE PLACED ON THE ANTENNA ENCLOSURES IN A MANNER THAT IS EASILY SEEN BY ANY PERSON ON THE ROOF. WARNING SIGNS SHALL COMPLY W/ ANSI Z39.52 COLOR, SYMBOL, AND CONTENT CONVENTIONS. ALL SIGNS SHALL HAVE AT&T'S NAME AND THE COMPANY CONTACT INFORMATION (E.G. TELEPHONE NUMBER) TO ARRANGE FOR ACCESS TO THE RESTRICTED AREAS. THIS TELEPHONE NUMBER SHALL BE PROVIDED TO THE CONTRACTOR BY THE AT&T CONSTRUCTION PROJECT MANAGER AT THE TIME OF CONSTRUCTION.
- PHOTOS OF ALL STRIPING, BARRICADES & SIGNAGE SHALL BE PART OF THE CONTRACTORS CLOSE OUT PACKAGE & SHALL BE TURNED INTO THE AT&T CONSTRUCTION PACKAGE & SHALL BE TURNED INTO THE AT&T CONSTRUCTION PROJECT MANAGER AT THE END OF CONSTRUCTION. STRIPING SHALL BE DONE W/ FADE RESISTANT YELLOW SAFETY PAINT IN A CROSS-HATCH PATTERN AS DETAILED BY THE CONSTRUCTION DRAWINGS. ALL BARRICADES SHALL BE MADE OF AN RF FRIENDLY MATERIAL SO AS NOT TO BLOCK OR INTERFERE W/ THE OPERATION OF THE ANTENNAS. BARRICADES SHALL BE PAINTED W/ FADE RESTRAINT YELLOW SAFETY PAINT. THE CONTRACTOR SHALL PROVIDE ALL RF FRIENDLY BARRICADES NEEDED, & SHALL PROVIDE THE AT&T CONSTRUCTION PROJECT MANAGER W/ A DETAILED
- SHOP DRAWING OF EACH BARRICADE. UPON CONSTRUCTION COMPLETION.

PROPRIETARY INFORMATION  
THE INFORMATION CONTAINED IN THIS SET OF DRAWINGS IS PROPRIETARY BY NATURE. ANY USE OR DISCLOSURE OTHER THAN THAT WHICH RELATES TO PECK SITE-COM IS STRICTLY PROHIBITED.

CLIENT:  
  
2600 CAMINO RAMON  
SAN RAMON, CA 94583

PROJECT INFORMATION:  
**SOAPWEED**  
4070 STOPE DR  
PLACERVILLE, CA 95667

REV: \_\_\_\_\_ DATE: \_\_\_\_\_ DESCRIPTION: \_\_\_\_\_ BY: \_\_\_\_\_

REV	DATE	DESCRIPTION	BY
1	6-14-17	90% ZONING DOC'S	RB
2	8-3-17	REV 90% ZONING DOC'S	RB
3	8-21-17	100% ZONING DOC'S	RB

COORDINATING ENGINEER:  
  
**Peek Site-Com**  
12852 Earhart Ave, Suite 101  
Auburn, California 95602  
Phone (530) 885-6160  
E-Mail info@peeksitocom.com

SEAL:  
  
SITE #: \_\_\_\_\_ CHK.: \_\_\_\_\_ DRAWN BY: \_\_\_\_\_  
CVL03411 ... RB


**SITE SIGNAGE**  
SHEET NUMBER: \_\_\_\_\_ REVISION: \_\_\_\_\_  
**GN-2 0**



DATE OF SURVEY: 04-26-17  
 SURVEYED BY OR UNDER DIRECTION OF: KENNETH D. GEIL, R.C.E. 14803  
 LOCATED IN THE COUNTY OF EL DORADO, STATE OF CALIFORNIA  
 BEARINGS SHOWN ARE BASED UPON MONUMENTS FOUND AND RECORD INFORMATION. THIS IS NOT A BOUNDARY SURVEY.  
 ELEVATIONS SHOWN ON THIS PLAN ARE BASED UPON U.S.G.S. N.A.V.D. 88 DATUM. ABOVE MEAN SEA LEVEL.  
 N.G.V.D. 1929 CORRECTION: SUBTRACT 2.84' FROM ELEVATIONS SHOWN.  
 CONTOUR INTERVAL: 1 FT.  
 CONTRACTOR IS RESPONSIBLE TO VERIFY LEASE AREA PRIOR TO CONSTRUCTION.  
 ASSESSOR'S PARCEL NUMBER: 085-010-13-100  
 OWNER(S): DAVID JOSEPH RONZONE TR  
 P.O. BOX 889  
 EL DORADO, CA 95623

**A.T. & T. Mobility**  
 Project No./Name: CVL03411 / Soapweed  
 Project Site Location: 4070 Stope Drive  
 Placerville, CA 95667  
 El Dorado County  
 Date of Observation: 04-28-17  
 Equipment/Procedure Used to Obtain Coordinates: Trimble Geo XT post processed with Pathfinder Office software.  
 Type of Antenna Mount: Proposed Monopine Tower  
 Coordinates (Center Lease Area)  
 Latitude: N 38°48'29.46" (NAD83) N 38°48'29.81" (NAD27)  
 Longitude: W 120°41'52.68" (NAD83) W 120°41'48.94" (NAD27)  
 ELEVATION of Ground at Structure (NAVD88) 3151' AMSL

**Lease Area Description**  
 All that certain lease area being a portion of the Southeast 1/4 of the Southwest 1/4 of the Southeast 1/4 of Section 12, Township 11 N., Range 11 E., M.D.B. & M., as shown on the plat filed in Book 12 of Surveys, page 33 El Dorado County California Records being more particularly described as follows:  
 Commencing at the Southwest corner of the aforementioned Parcel of land; thence along the Westerly boundary thereof North 1°57'24" West, 381.06 feet; thence leaving said West boundary North 88°02'36" East, 70.65 feet to the True Point of Beginning; thence from said point of beginning South 87°45'14" East, 45.00 feet; thence South 21°44'46" West, 40.00 feet; thence North 87°45'14" West, 45.00 feet; thence North 21°44'46" East, 40.00 feet to the point of beginning.  
 Together with a non-exclusive easement for access and utility purposes, purposes fifteen feet in width, the centerline of which is more particularly described as follows: Beginning at a point which bears South 87°45'14" East, 10.14 feet from the Southwest corner of the above described lease area thence from said point of beginning along a non-tangent curve, concave to the west, having a radius of 7226.78 feet a central angle of 2°21'40", and a chord of 297.77 feet bearing North 3°29'09" West; thence South along said curve, a distance of 297.80 feet to a point hereafter referred to as Point A; thence South 57°36'11" West, a distance of 85.58 feet more or less to the existing traveled way commonly known as Awesome View.  
 Also together with a non-exclusive easement for utility purposes, purposes six feet in width, the centerline of which is more particularly described as follows: Beginning at the above described Point A; thence South 02°17'04" East, a distance of 5.20 feet; thence North 57°36'11" East, a distance of 98.0 feet more or less to an existing utility service connection location.

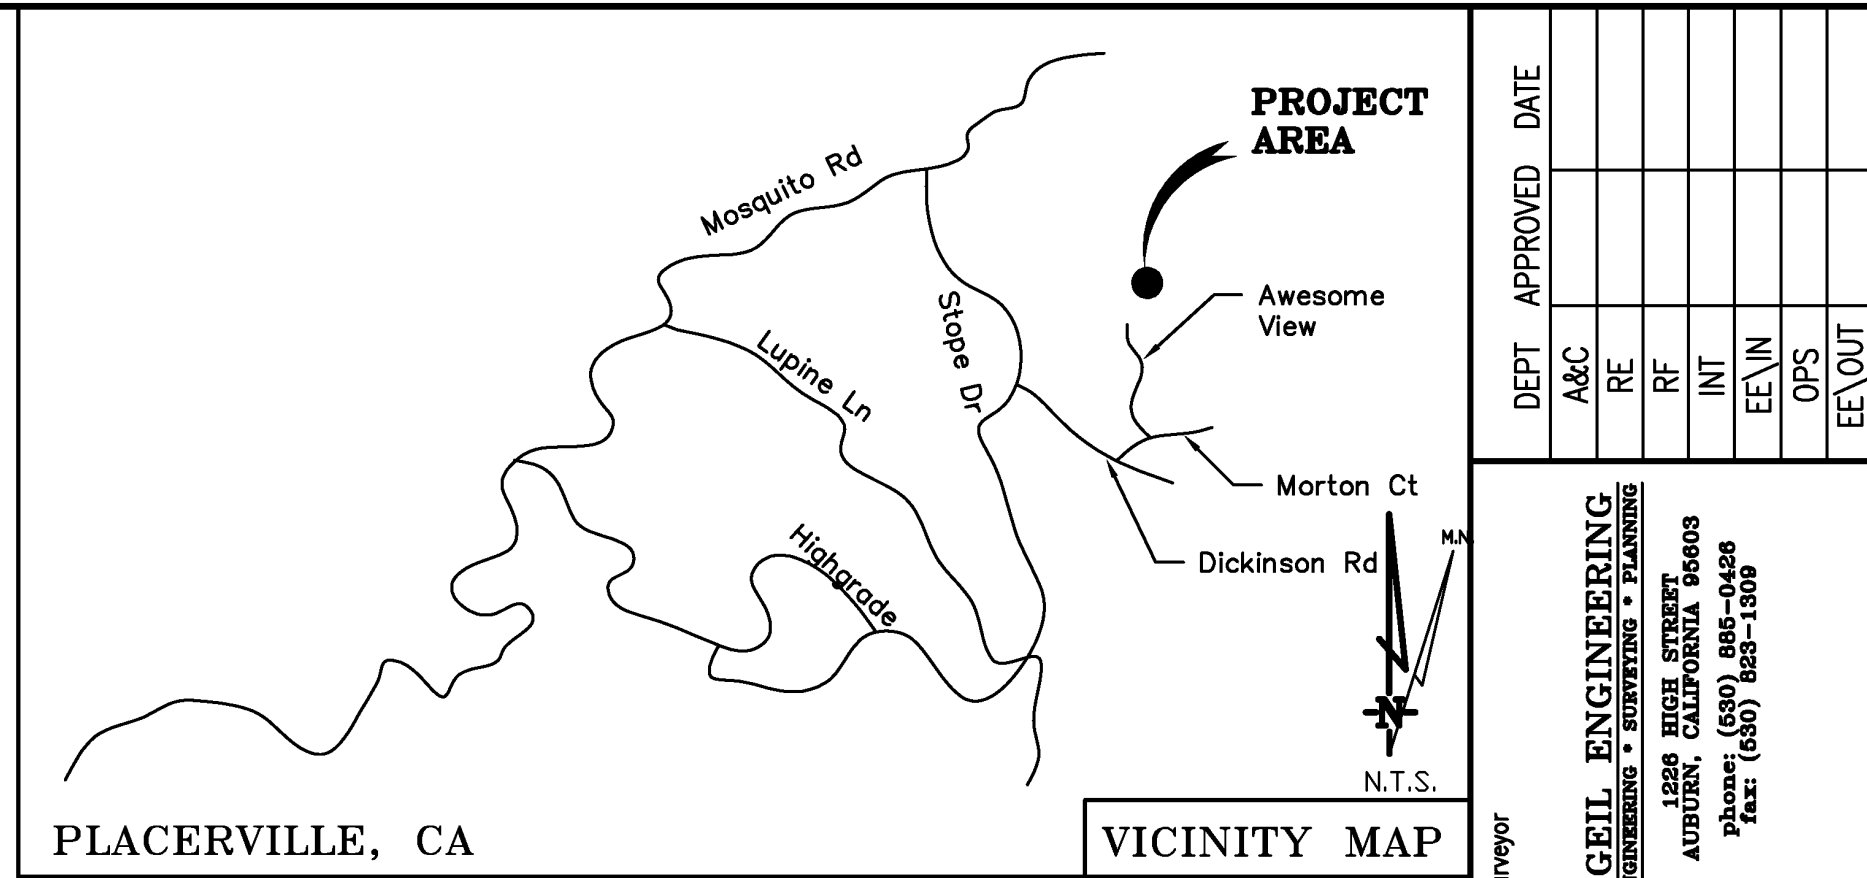


PLACERVILLE, CA

THESE DRAWINGS AND/OR THE ACCOMPANYING SPECIFICATION AS INSTRUMENTS OF SERVICE, ARE THE EXCLUSIVE PROPERTY OF GEIL ENGINEERING AND THEIR USE AND PUBLICATION SHALL BE RESTRICTED TO THE ORIGINAL SITE AND CARRIER FOR WHICH THEY ARE PREPARED. REUSE, REPRODUCTION OR PUBLICATION BY ANY METHOD, IN WHOLE OR IN PART, IS PROHIBITED EXCEPT BY WRITTEN PERMISSION FROM GEIL ENGINEERING. TITLE TO THESE PLANS AND/OR SPECIFICATIONS SHALL REMAIN WITH GEIL ENGINEERING WITHOUT PREJUDICE AND VISUAL CONTACT WITH THEM SHALL CONSTITUTE PRIMA FACIE EVIDENCE OF ACCEPTANCE OF THESE RESTRICTIONS.


BOUNDARY SHOWN IS BASED ON MONUMENTATION FOUND AND RECORD INFORMATION. THIS IS NOT A BOUNDARY SURVEY. THIS IS A SPECIALIZED TOPOGRAPHIC MAP WITH PROPERTY LINES AND EASEMENTS BEING A GRAPHIC DEPICTION BASED ON INFORMATION GATHERED FROM VARIOUS SOURCES OF RECORD AND AVAILABLE MONUMENTATION FOUND DURING THE FIELD SURVEY. NO EASEMENTS WERE RESEARCHED OR PLOTTED. PROPERTY LINES AND LINES OF TITLE WERE NOT INVESTIGATED NOR SURVEYED. NO PROPERTY MONUMENTS WERE SET.

DEPT	APPROVED	DATE
A&C		
RE		
RF		
INT		
EE/IN		
OPS		
EE/OUT		


Surveyor  
**GEIL ENGINEERING**  
 4700 Stope Drive  
 Auburn, California 96803  
 Phone: (830) 885-0428  
 Fax: (830) 885-1309

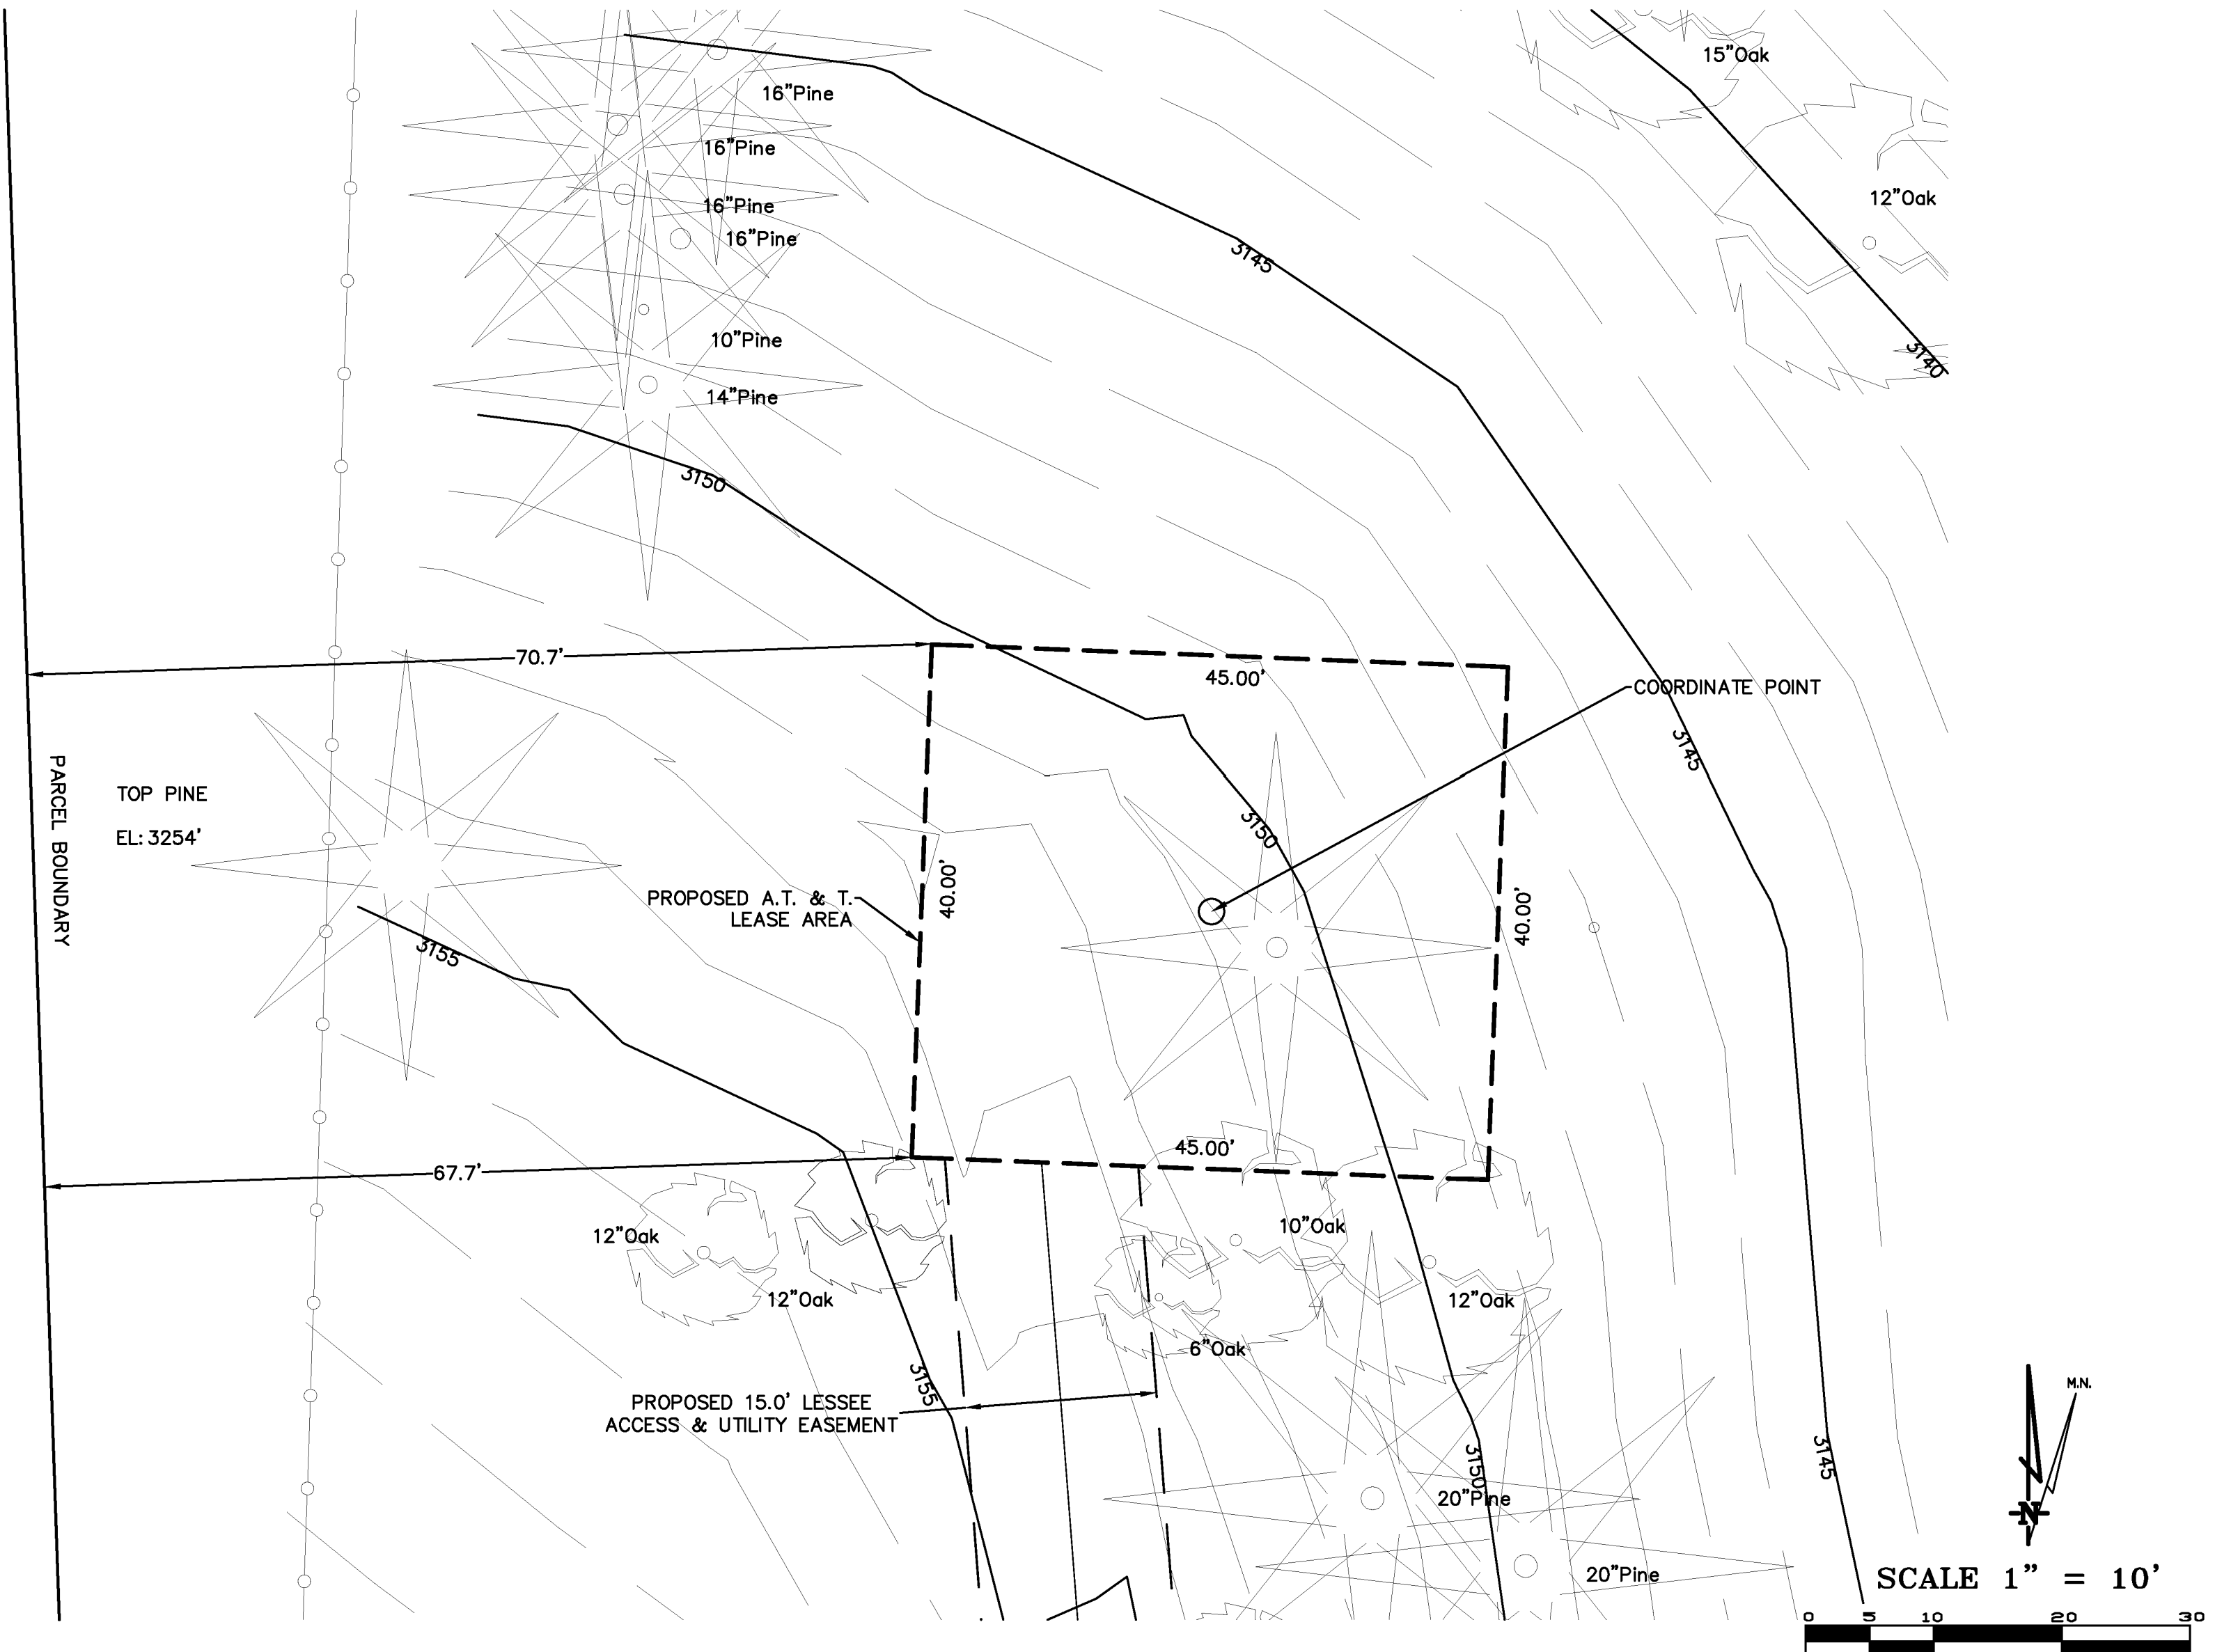

**LEASE AREA DETAIL**

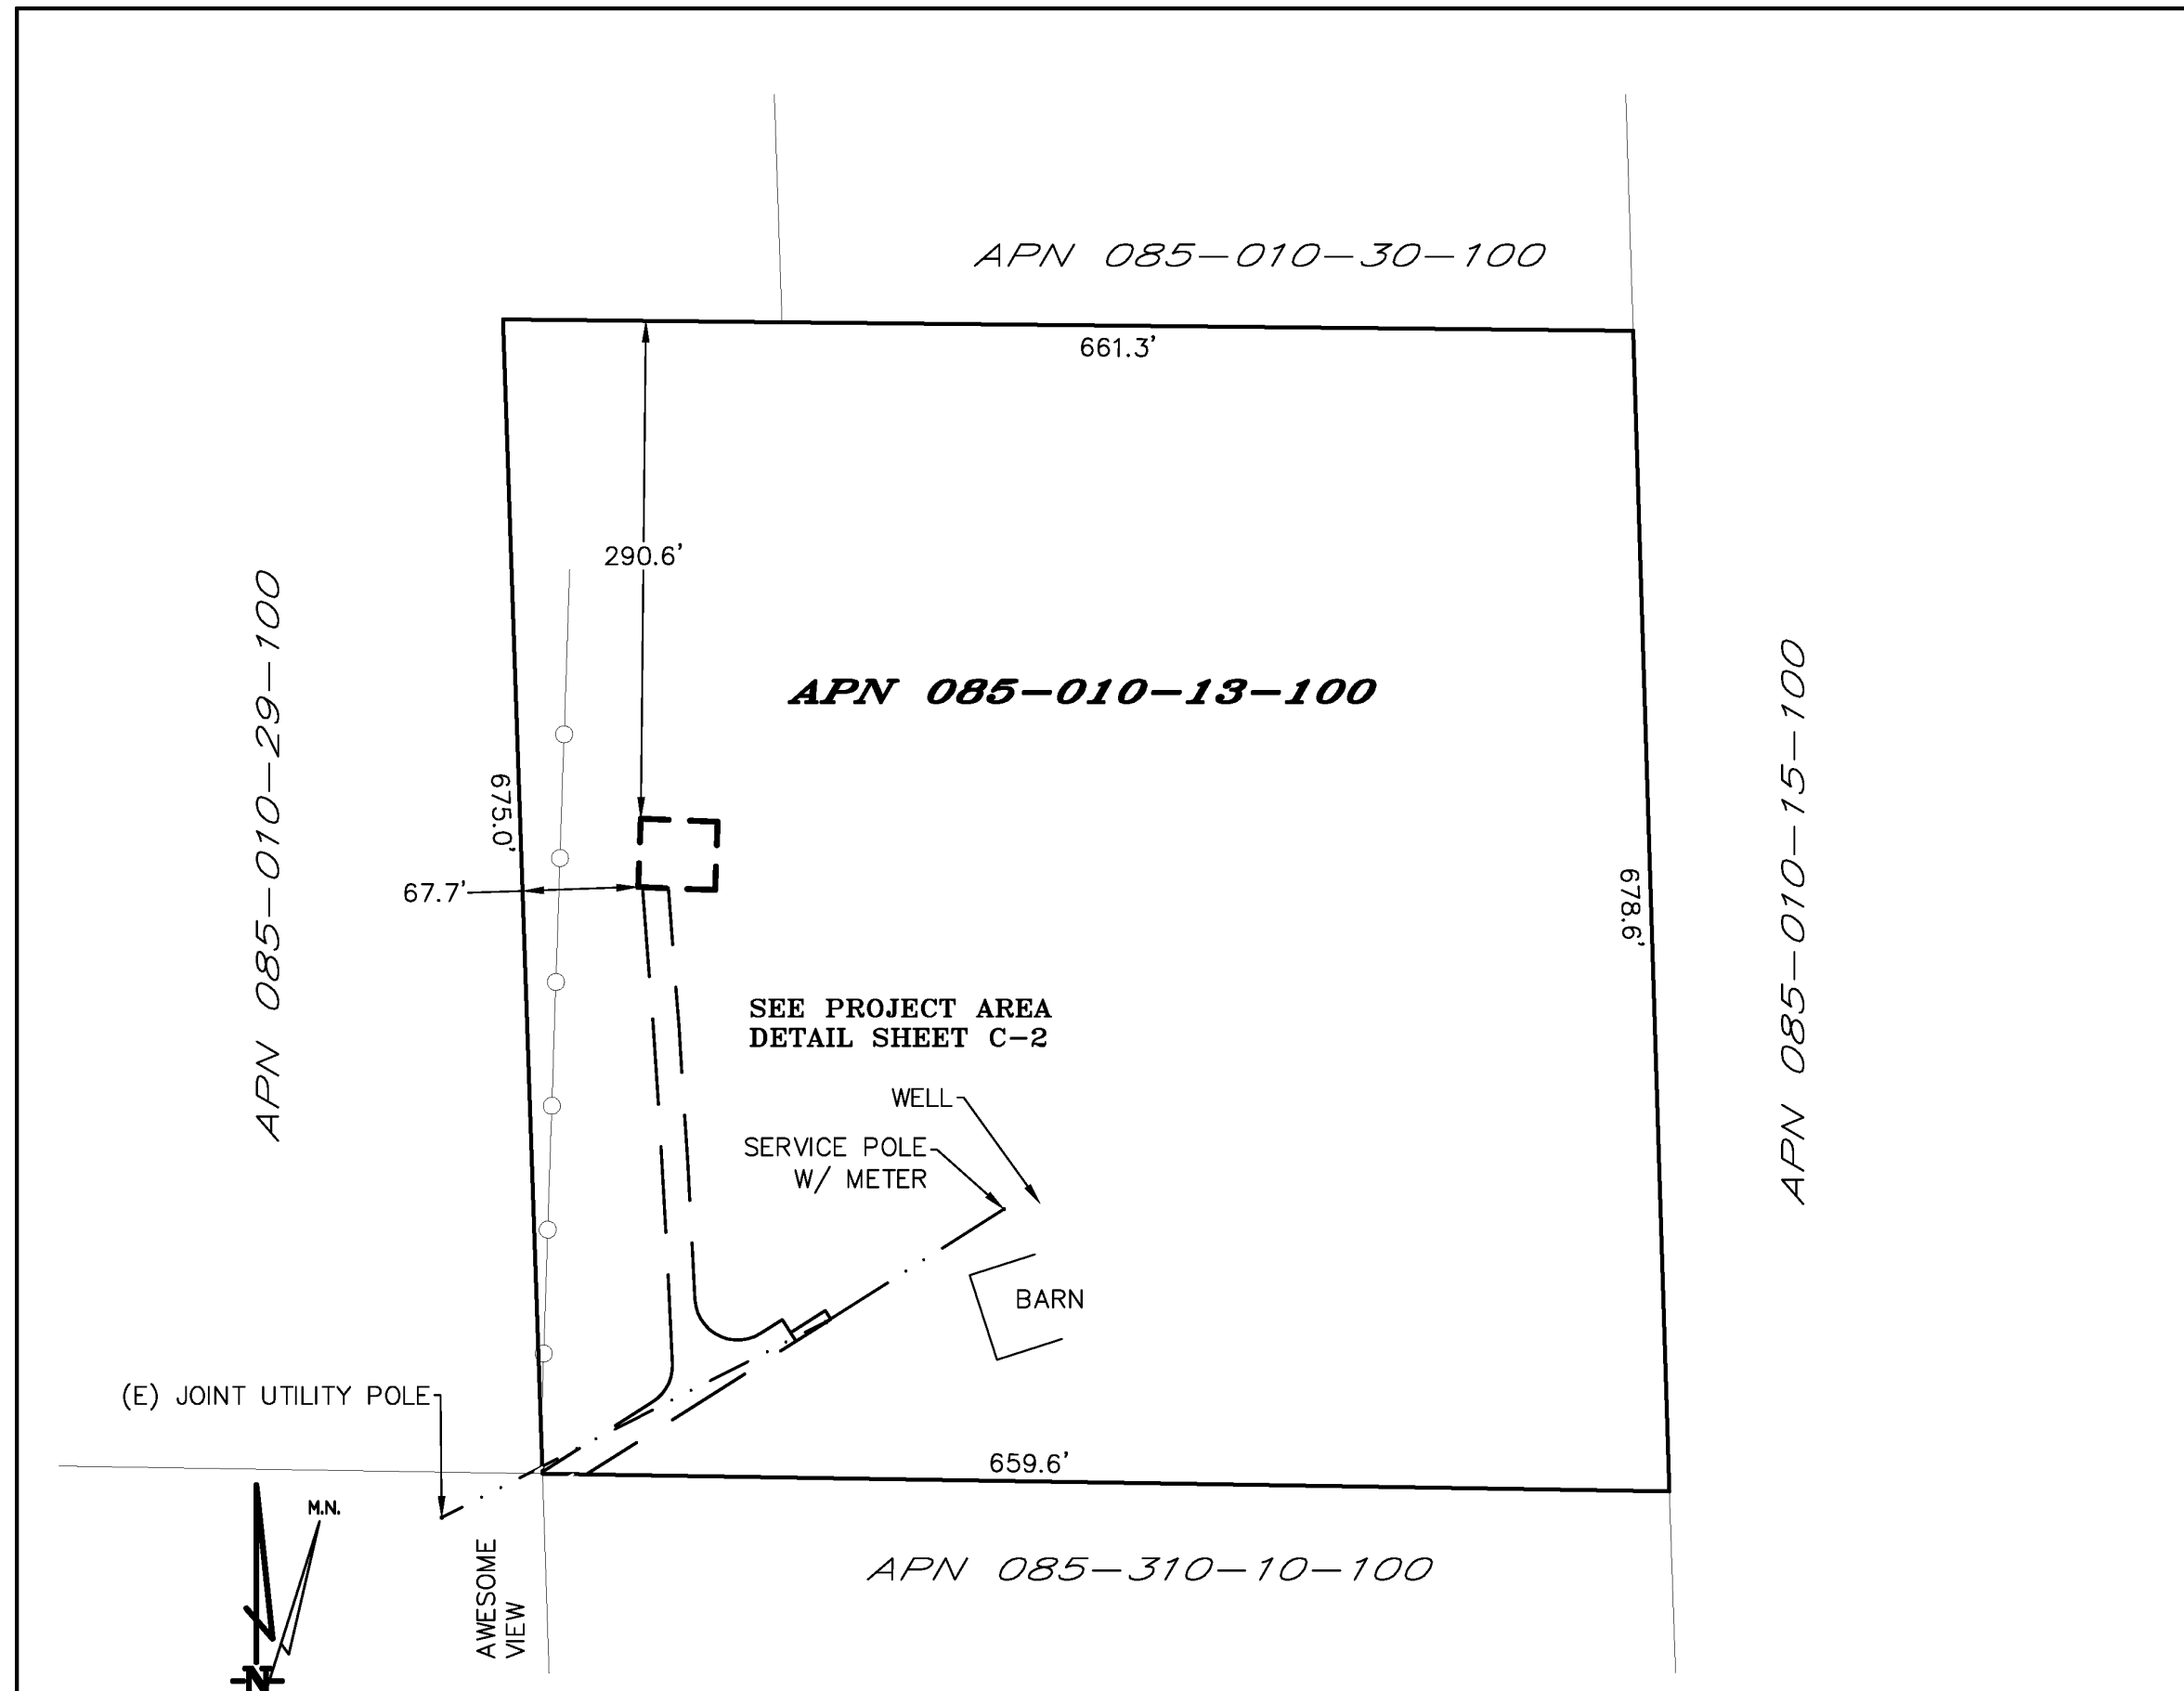

**OVERALL PROJECT AREA**

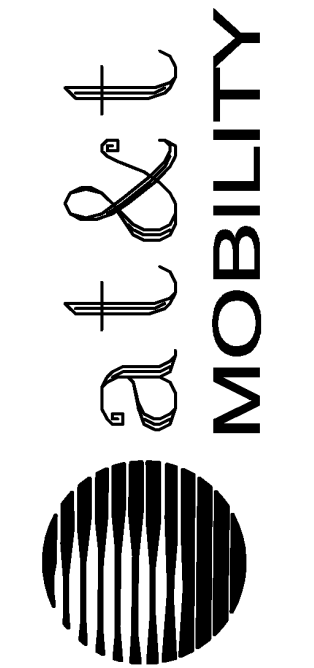


**CVL03411 Soapweed**  
 4700 Stope Drive  
 Placerville, CA 95667  
**PLOT PLAN AND SITE TOPOGRAPHY**

REVISIONS	DATE	DESCRIPTION
04-30-17	04-30-17	Preliminary Drawing
05-25-17	05-25-17	redline
08-08-17	08-08-17	redline

Sheet  
**C-1**

SCALE 1" = 20'

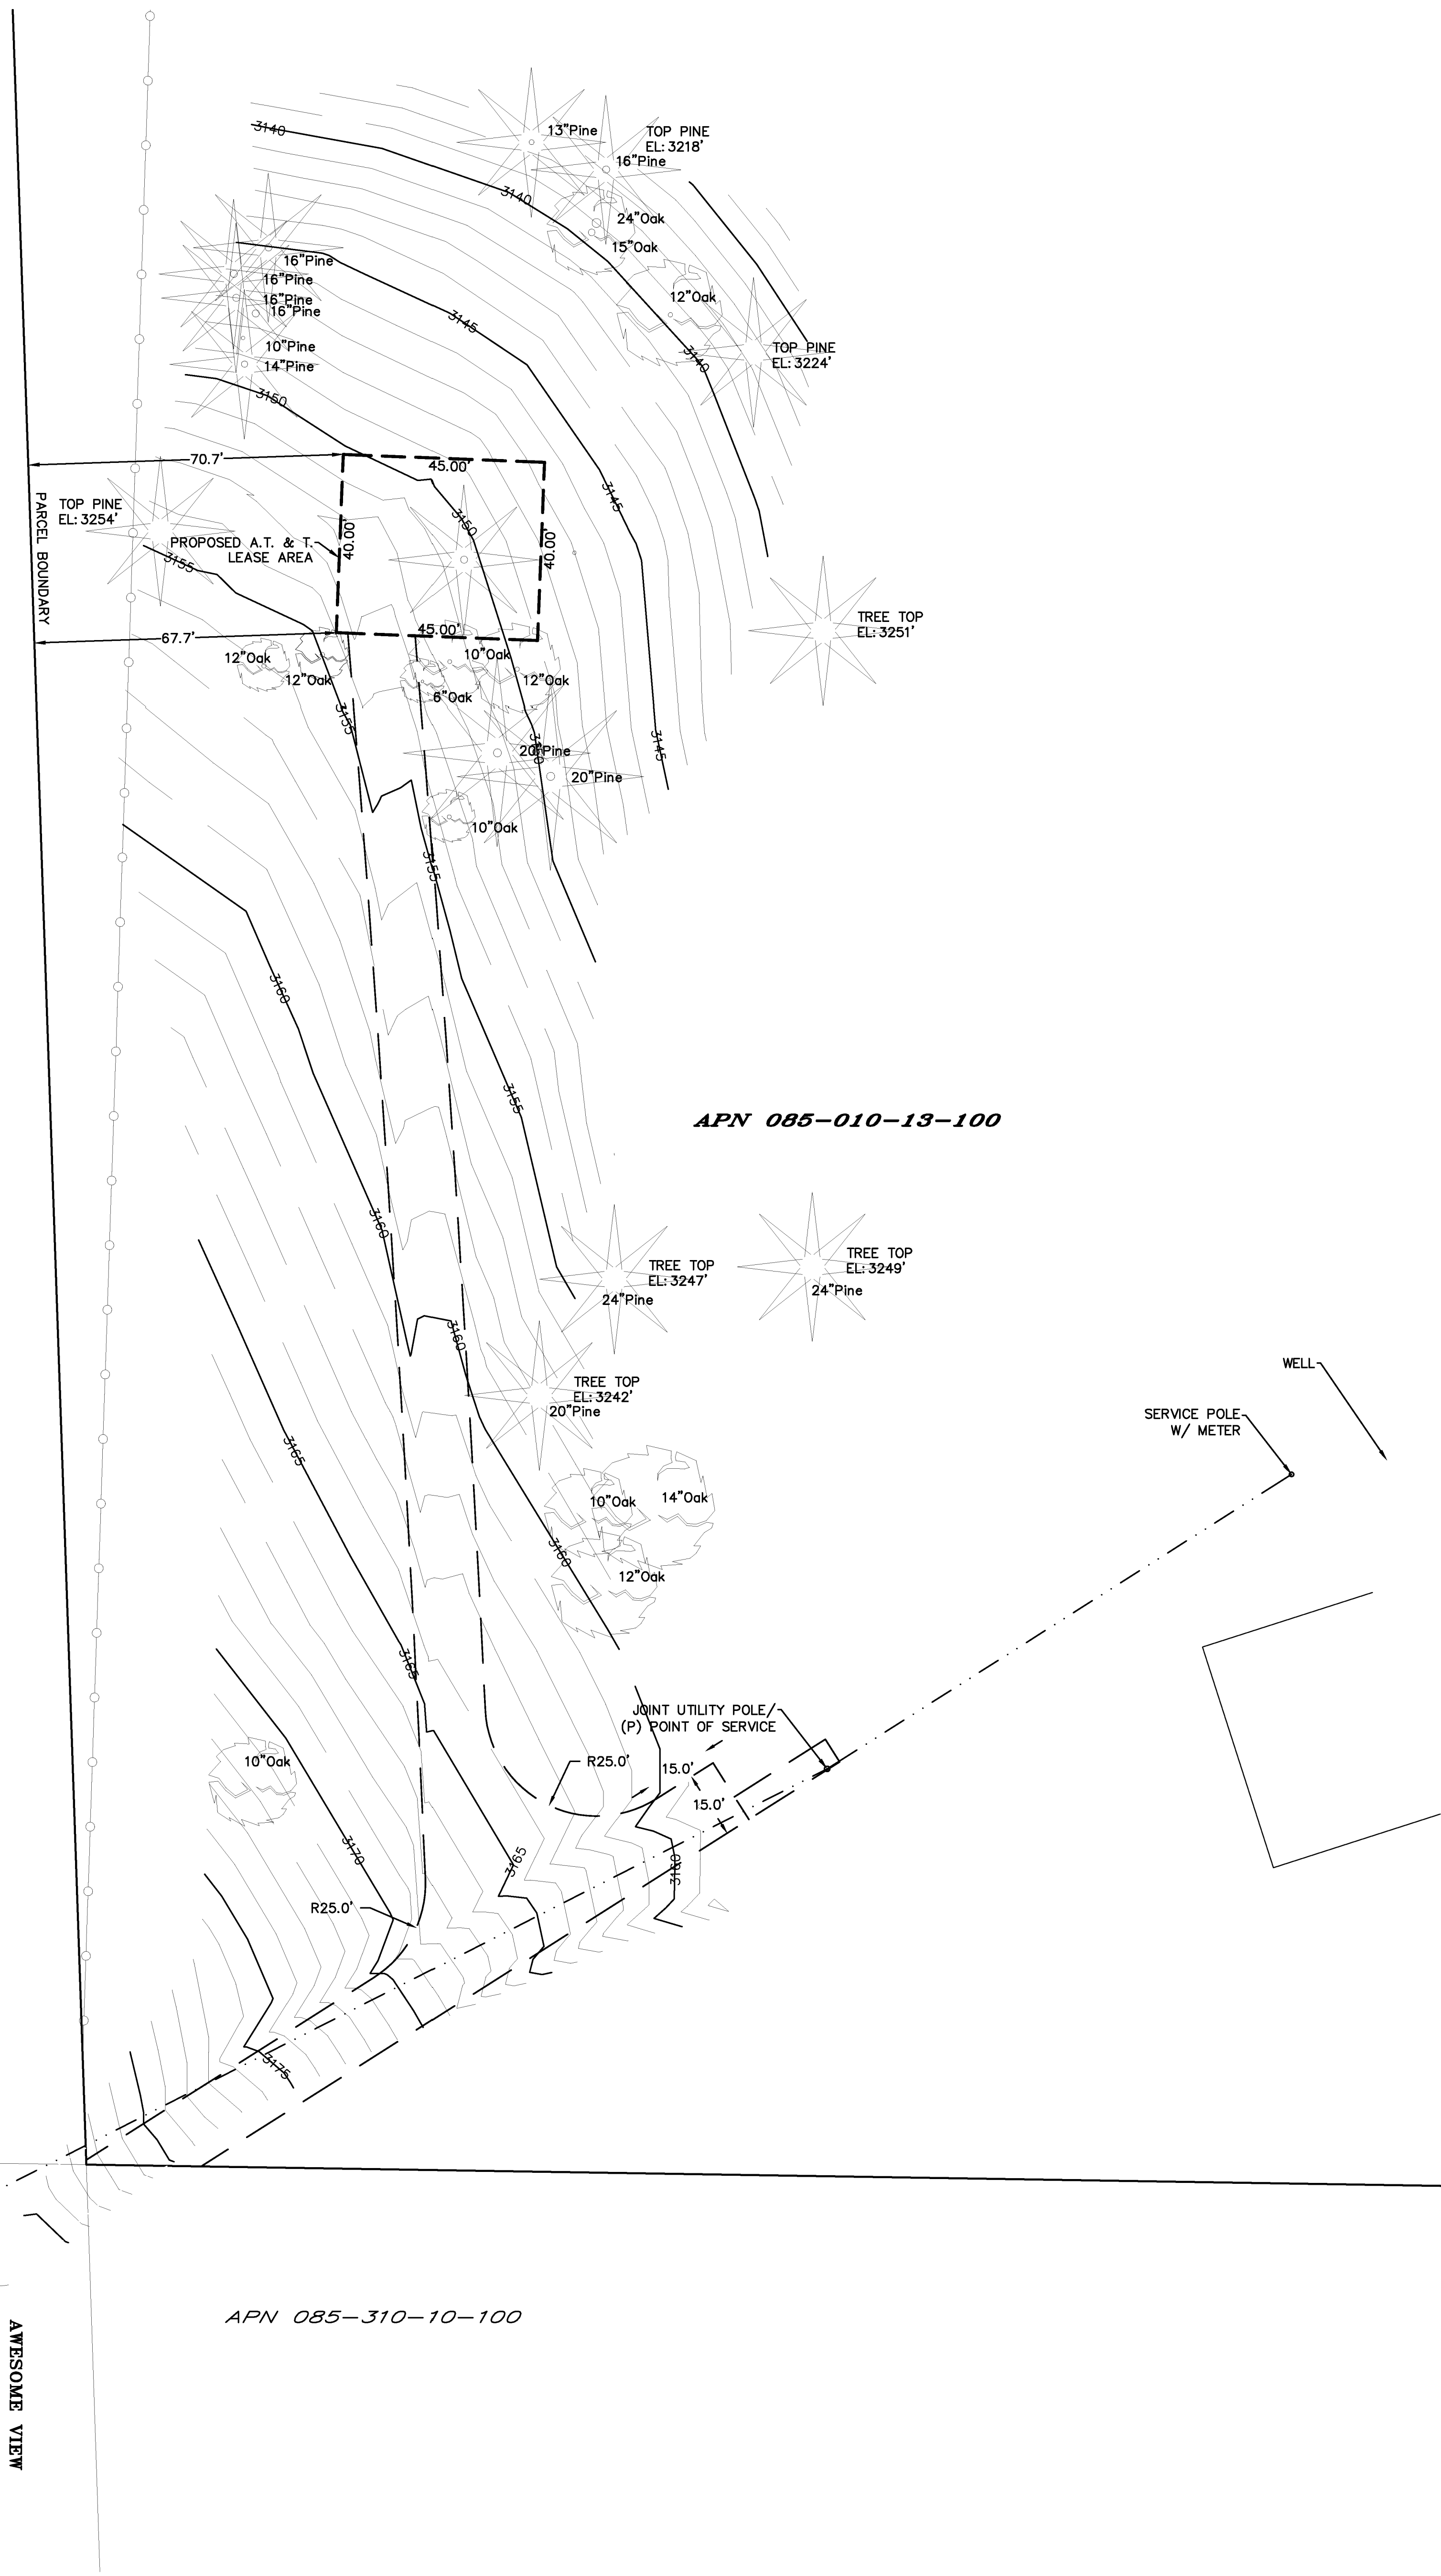

PROJECT AREA DETAIL

AWESOME VIEW  
 APN 085-310-09-100  
 JOINT UTILITY POLE

REV	DATE	DESCRIPTION	BY
REV	04-30-17	Preliminary Drawing	da
REV	05-25-17	redline	da
REV	08-08-17	redline	da
REV			
REV			
REV			

**CVL03411 Soapweed**  
 4700 Stope Drive  
 Placerville, CA 95667

**PLOT PLAN AND  
 SITE TOPOGRAPHY**



Surveyor

**GEIL ENGINEERING**  
 ENGINEERING • SURVEYING • PLANNING

1228 HIGH STREET  
 AUBURN, CALIFORNIA 95603  
 Phone: (530) 885-0428  
 Fax: (530) 823-1309

DEPT	APPROVED	DATE
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C-2



## GENERAL NOTES

1. THE CONTRACTOR SHALL HAVE A RESPONSIBLE PARTY, WHO SHALL HAVE THE AUTHORITY TO REPRESENT AND ACT FOR THE CONTRACTOR, ON THE JOB SITE DURING ALL WORKING HOURS.
2. ALL WORK SHALL BE ACCOMPLISHED TO THE SATISFACTION OF THE WASHOE COUNTY AUTHORIZED REPRESENTATIVE.

### DEFINITIONS:

- (ESC) - EROSION AND SEDIMENT CONTROL
- (NPDES) - NATIONAL POLLUTANT DISCHARGE ELIMINATION SYSTEM
- (CWA) - CLEAN WATER ACT
- (SWPPP) - STORM WATER POLLUTION PREVENTION PLAN
- (BMP'S) - BEST MANAGEMENT PRACTICES

### THE CONTRACTOR SHALL:

MAKE HIM/HERSELF AWARE OF THE REQUIREMENTS OF SAID GENERAL PERMIT AND THE PROVISIONS OF THE GRADING & EROSION CONTROL PLANS.

IMPLEMENT THE ESC FEATURES AND BEST MANAGEMENT PRACTICES (BMP'S) CONTAINED IN THE IMPROVEMENT PLANS, AND OTHERWISE DILIGENTLY PURSUE COMPLIANCE WITH THE LOCAL REQUIREMENTS.

ASSIST THE OWNER, ENGINEER, AND PUBLIC WORKS DEPARTMENT STAFF IN THE ASSESSMENT OF THE FUNCTIONALITY OF AND MODIFICATIONS TO THE FEATURES AND PRACTICES IMPLEMENTED AND PROPOSED.

MEET WITH THE OWNER AND THE PUBLIC WORKS DEPARTMENT STAFF TO DETERMINE AND DISCUSS THE STATUS OF THE PROJECT, CONSTRUCTION SCHEDULE, AND ANY MODIFICATIONS AND/OR ADDITIONS TO THE ESC FEATURES IN ORDER TO DILIGENTLY PURSUE COMPLIANCE.

DOCUMENT ANY MAINTENANCE, REPLACEMENT, INSPECTION, MODIFICATIONS OR ADDITIONS TO THE PROJECT ESC FEATURES, AND NOTIFY THE ENGINEER, OWNER AND PUBLIC WORKS DEPARTMENT STAFF OF ANY SUBSTANTIAL MODIFICATIONS OR ADDITIONS TO THE ESC PRACTICES AND FEATURES. ALL DISTURBED AREAS SHALL BE PROTECTED WITH APPROVED MATERIALS WITHIN 15 DAYS OF COMPLETION OF THE FINISHED GRADES.

MAINTAIN AN INVENTORY OF ESC MATERIALS (STRAW BALES, 1.5" - 3" CLEAN CRUSHED ROCK, FIBER ROLLS, SILT FENCE, ROCK BAGS, ETC.) ON SITE FOR EMERGENCY USE AS DIRECTED BY THE ENGINEER, OWNER, OR THE PUBLIC WORKS DEPARTMENT STAFF.

### OTHER RESPONSIBILITIES OF APPLICANT:

- A. PROTECTION OF UTILITIES. THE APPLICANT SHALL BE RESPONSIBLE FOR THE PREVENTION OF DAMAGE TO ANY PUBLIC UTILITIES OR SERVICES.
- B. PROTECTION OF ADJACENT PROPERTY. THE APPLICANT SHALL BE RESPONSIBLE
- C. FOR THE PREVENTION OF DAMAGE TO ADJACENT PROPERTY. NO PERSON(S) SHALL EXCAVATE ON LAND THAT IS SO CLOSE TO THE PROPERTY LINE AS TO ENDANGER ANY ADJOINING PUBLIC STREET, SIDEWALK, ALLEY, STRUCTURE OR OTHER PUBLIC OR PRIVATE PROPERTY OR EASEMENT WITHOUT SUPPORTING AND PROTECTING SUCH PROPERTY FROM ANY DAMAGE WHICH MIGHT OTHERWISE RESULT.
- D. ADVANCE NOTICE. THE APPLICANT SHALL NOTIFY THE COUNTY AT LEAST FORTY-EIGHT HOURS PRIOR TO THE START OF WORK.
- E. EROSION AND SEDIMENT CONTROL. IT SHALL BE THE SOLE RESPONSIBILITY OF THE APPLICANT TO PREVENT DISCHARGE OF SEDIMENT FROM THE SITE, IN QUANTITIES GREATER THAN BEFORE THE GRADING OCCURRED, TO ANY WATERCOURSE, DRAINAGE SYSTEM, OR ADJACENT PROPERTY.
- F. COMPLIANCE WITH STORMWATER RUNOFF POLLUTION CONTROL CODE. AT ALL TIMES DURING THE PRECONSTRUCTION AND CONSTRUCTION OF ANY PROJECT FOR WHICH GRADING APPROVAL IS ISSUED UNTIL ALL FINAL IMPROVEMENTS AND PERMANENT STRUCTURES ARE COMPLETE, THE APPLICANT SHALL FULLY COMPLY WITH ALL APPLICABLE REQUIREMENTS OF THE STORMWATER RUNOFF POLLUTION CONTROL CODE.

## EROSION CONTROL NOTES

1. ALL EROSION AND SEDIMENT CONTROL MEASURES SHALL BE CONSTRUCTED AND MAINTAINED IN ACCORDANCE WITH THE COUNTY IMPROVEMENT STANDARDS, CURRENT EDITION, AND THE COUNTY EROSION AND SEDIMENT CONTROL GUIDELINES.
2. EROSION CONTROL BEST MANAGEMENT PRACTICES (BMP'S) SHALL BE INSTALLED AND MAINTAINED DURING THE WET SEASON (OCTOBER THROUGH APRIL 30). SEDIMENT CONTROL BMP'S SHALL BE INSTALLED AND MAINTAINED ALL YEAR.
3. ALL DRAINAGE INLETS IMMEDIATELY DOWNSTREAM OF THE WORK AREAS AND WITHIN THE WORK AREAS SHALL BE PROTECTED WITH SEDIMENT CONTROL AND INLET FILTER BAGS, YEAR ROUND. INLET FILTER BAGS SHALL BE REMOVED FROM THE DRAINAGE INLETS UPON ACCEPTANCE OF THE PUBLIC IMPROVEMENTS BY THE COUNTY.
4. ALL AREAS DISTURBED DURING CONSTRUCTION, BY GRADING, TRENCHING, OR OTHER ACTIVITIES, SHALL BE PROTECTED FROM EROSION DURING THE WET SEASON (OCTOBER 1 THROUGH APRIL 30). HYDROSEED, IF UTILIZED, MUST BE PLACED BY SEPTEMBER 15. HYDROSEED PLACED DURING THE WET SEASON SHALL USE A SECONDARY EROSION PROTECTION METHOD.
5. SENSITIVE AREAS AND AREAS WHERE EXISTING VEGETATION IS BEING PRESERVED SHALL BE PROTECTED WITH CONSTRUCTION FENCING. SEDIMENT CONTROL BMP'S SHALL BE INSTALLED WHERE ACTIVE CONSTRUCTION AREAS DRAIN INTO SENSITIVE OR PRESERVED VEGETATION AREAS.
6. SEDIMENT CONTROL BMP'S SHALL BE PLACED ALONG THE PROJECT PERIMETER WHERE DRAINAGE LEAVES THE PROJECT. SEDIMENT CONTROL BMP'S SHALL BE MAINTAINED YEAR ROUND UNTIL THE CONSTRUCTION IS COMPLETE OR THE DRAINAGE PATTERN HAS BEEN CHANGED AND NO LONGER LEAVES THE SITE.
7. THE FOLLOWING AREAS ARE TO RECEIVE HYDROSEEDING OR OTHER EROSION CONTROL: ALL SLOPES GREATER THAN 10:1.
8. FOR DEWATERING OPERATIONS, SEDIMENT-LADEN STORM WATER SHALL BE EITHER PUMPED (NOTE 10) OR ROUTED (TEMPORARY DIVERSION SWALE) TO SEDIMENT TRAP(S) TO ALLOW SEDIMENT TO SETTLE OUT BEFORE DISCHARGE OFF-SITE. ONCE SEDIMENT HAS SETTLED OUT, WATER WILL BE DISCHARGED THROUGH SWALE LINED WITH IMPERVIOUS PLASTIC LINER.
9. USE OF FIBER ROLLS SHALL BE AUGMENTED DURING WET SEASON WITH DEWATERING BMP'S IN THE EVENT THAT FIBER ROLLS DO NOT EFFECTIVELY RETAIN STORM WATER ON SITE. DEWATERING MAY INCLUDE PUMPS OR BERMS TO ROUTE WATER TO THE SEDIMENT TRAP. IF PUMPS ARE USED, THEN FILTER BAGS SHALL BE USED AT DISCHARGE HOSE ENDS. DEWATERING MATERIAL SHALL NOT BE DISCHARGED DIRECTLY TO THE STORM DRAIN SYSTEM.

## BMP INSTALLATION SCHEDULE

BEST MANAGEMENT PRACTICE	LOCATION	IMPLEMENTATION SCHEDULE	MAINTENANCE SCHEDULE
A. PRESERVING EXISTING VEGETATION	AROUND PERIMETER OF PROJECT SITE	CONTINUOUS, UNTIL CONSTRUCTION IS COMPLETED	EDUCATE EMPLOYEES AND SUBCONTRACTORS REGARDING IMPORTANCE AT MAINTAINING EXISTING VEGETATION TO PREVENT EROSION AND FILER AND SEDIMENT IN RUNOFF FROM DISTURBED AREAS ON THE CONSTRUCTION SITE. INSPECT SITE PERIMETER MONTHLY TO VERIFY THE OUTSIDE VEGETATION IS NOT DISTURBED.
B. PROTECT GRADED AREAS AND SLOPES FROM WASHOUT & EROSION	THROUGHOUT PROJECT SITE	DURING WET SEASON	INSPECT GRADED AREAS AND SLOPES ON AT LEAST A MONTHLY BASIS TO CHECK FOR EROSION. REGRADE TRIBUTARY AREAS OR INSTALL FILTER BARRIER OR SAND BAG DIKES AS NECESSARY TO PREVENT EROSION.
C. GRAVEL FILTER	ALONG FLOW LINES OF UNPAVED ROADWAYS WITHIN SITE	IN PLACE DURING WET SEASON UNTIL ROADWAYS ARE PAVED	INSPECT DAILY AND AFTER EACH STORM. REMOVE ON-SITE SEDIMENT DEPOSITED BEHIND BERM OR BARRIER TO MAINTAIN EFFECTIVENESS.
D. INLET FILTER BAG	INLETS TO THE STORM DRAINAGE SYSTEM	CONTINUOUS UNTIL LANDSCAPING IS IN PLACE	INSPECT WEEKLY AND AFTER EACH STORM. REMOVE SEDIMENT AND DEBRIS BEFORE ACCUMULATIONS HAVE REACHED ONE THIRD THE DEPTH OF THE BAG. REPAIR OR REPLACE INLET FILTER BAG AS SOON AS DAMAGE OCCURS.
E. FIBER ROLL	SEE PLAN SHEET C-4	CONTINUOUS	INSPECT WEEKLY AND AFTER EACH STORM. REMOVE SEDIMENT DEPOSITED BEHIND FIBER ROLL WHENEVER NECESSARY TO MAINTAIN EFFECTIVENESS.
F. HYDROSEEDING	3:1 SLOPES	IN PLACE DURING BY SEPT. 15	INSPECT SLOPES ON AT LEAST A MONTHLY BASIS TO CHECK FOR EROSION. IF EROSION IS NOTED, SPREAD STRAW MULCH OVER AFFECTED AREAS.
G. STABILIZED CONSTRUCTION ENTRANCE	ENTRANCES TO SITE FROM PUBLIC ROADWAYS	CONTINUOUS, UNTIL CONSTRUCTION IS COMPLETED	INSPECT ON A MONTHLY BASIS AND AFTER EACH RAINFALL. ADD AGGREGATE BASE MATERIAL WHENEVER NECESSARY TO PREVENT SEDIMENT FROM BEING TRACKED INTO PUBLIC STREET.
H. WIND EROSION CONTROL PRACTICES	WHEREVER NECESSARY THROUGHOUT PROJECT SITE	CONTINUOUS UNTIL GRADING IS COMPLETED AND SOILS HAVE STABILIZED	INSPECT SITE DURING WINDY CONDITIONS TO IDENTIFY AREAS WHERE WIND EROSION IS OCCURRING AND ABATE EROSION AS NECESSARY
I. GOOD HOUSEKEEPING MEASURES	THROUGHOUT PROJECT SITE	CONTINUOUS UNTIL CONSTRUCTION IS COMPLETED	INSPECT SITE ON AT LEAST A MONTHLY BASIS TO VERIFY THAT GOOD HOUSEKEEPING PRACTICES ARE BEING IMPLEMENTED.
J. PROPER CONSTRUCTION MATERIAL STORAGE	DESIGNATED AREA	CONTINUOUS UNTIL CONSTRUCTION IS COMPLETED	INSPECT SITE ON AT LEAST A WEEKLY BASIS TO VERIFY THAT CONSTRUCTION MATERIALS ARE STORED IN A MANNER, WHICH COULD NOT CAUSE STORM WATER POLLUTION.
K. PROPER CONSTRUCTION WASTE STORAGE AND DISPOSAL, INCLUDING 1) CONCRETE SPILL CLEANUP INCLUDING 1) PAINT & PAINTING SUPPLIES 2) VEHICLE FUELING MAINTENANCE & CLEANING	DESIGNATED AREA AND CONTAINERS MATERIAL HANDLING AREA DESIGNATED AREA WITH SECONDARY CONTAINMENT	CONTINUOUS UNTIL CONSTRUCTION IS COMPLETED IMMEDIATELY AT TIME OF SPILL CONTINUOUS	INSPECT SITE ON AT LEAST A WEEKLY BASIS TO ASSURE WASTE IS STORED PROPERLY AND DISPOSED OF AT LEGAL DISPOSAL SITE, DAILY. INSPECT MATERIAL HANDLING AREAS ON AT LEAST A MONTHLY BASIS TO VERIFY PROPER SPILL CLEANUP. KEEP AMPLIE SUPPLIES OF SPILL CLEANUP MATERIALS ON SITE & INSPECT ON REGULAR SCHEDULE.
L. STREET AND STORM DRAINAGE FACILITY MAINTENANCE DEFINITIONS	STREETS AND STORM DRAINAGE FACILITIES	CONTINUOUS UNTIL CONSTRUCTION IS COMPLETED	MAINTAIN STORM DRAINAGE FACILITIES AND PAVED STREETS CLEAR OF SEDIMENT AND DEBRIS.

1. WET SEASON: ENTIRE PERIOD BETWEEN OCTOBER 1 THROUGH APRIL 30. CONTRACTOR SHALL ALSO IMPLEMENT WET SEASON MEASURES IF WET WEATHER IS EXPECTED DURING THE DRY SEASON.
2. PHASES OF GRADING
  - INITIAL (STAGE 1): WHEN CLEARING AND GRUBBING ACTIVITIES OCCUR
  - ROUGH (STAGE 2): WHEN CUT AND FILL ACTIVITIES OCCUR AND THE SITE IMPROVEMENTS ARE CONSTRUCTED, INCLUDING UNDERGROUND PIPING, STREETS, SIDEWALKS, AND OTHER IMPROVEMENTS.
  - FINAL (STAGE 3): WHEN FINAL ELEVATIONS ARE SET, AND SITE IMPROVEMENTS ARE COMPLETED AND READY FOR COUNTY ACCEPTANCE.


## REQUIRED BMP'S

THE FOLLOWING BMP'S SHALL BE REQUIRED ON ALL PROJECTS:

- A. ACCESS POINTS TO THE CONSTRUCTION SITE SHALL HAVE A STABILIZED CONSTRUCTION ACCESS.
- B. THE PRESERVATION OF EXISTING VEGETATION SHALL BE DONE IN ACCORDANCE WITH PRESERVATION OF EXISTING VEGETATION, AND SILT FENCE.
- C. PERIMETER PROTECTION ALONG PROPERTY LINES SHALL HAVE PRESERVATION OF EXISTING VEGETATION, OR SILT FENCE.
- D. SLOPES GREATER THAN 3 PERCENT SHALL BE TEMPORARILY SEEDED AND SLOPES GREATER 3:1 (H:V) SHALL HAVE HYDROSEEDING AND/OR GEOTEXTILES, PLASTIC COVERS, AND/OR EROSION CONTROL BLANKETS INSTALLED.
- E. THE TOE OF ALL SLOPES SHALL HAVE SILT FENCE AND/OR FIBER ROLL.
- F. DISTURBED SOIL AREAS BEHIND THE CURB OR BACK OF WALK (OR CURB) SHALL HAVE STRAW MULCH, SOIL BINDERS OR GEOTEXTILES, PLASTIC COVERS, AND EROSION CONTROL BLANKETS/MATS IN CONJUNCTION WITH HYDROSEEDING. SURFACE TREATMENTS SHALL EXTEND TO THE GREATER OF 6 METERS (20 FEET) OR TO THE TOP OF SLOPE.
- G. ROADWAY SUBGRADES SHALL HAVE FIBER ROLL, SILT FENCE, OR SEDIMENT TRAP.
- H. DEAD END STREETS, TO BE EXTENDED IN THE FUTURE, SHALL HAVE PRESERVATION OF EXISTING VEGETATION, HYDROSEEDING, SEDIMENT TRAP OR OTHER APPLICABLE BMP TO MINIMIZE THE TRANSPORT OF SEDIMENT ONTO OR FROM THE IMPROVED SURFACE.
- I. PROJECTS THAT INCLUDE DETENTION BASINS SHALL HAVE A SEDIMENT BASIN.
- J. PLACE DRAINAGE INLET SEDIMENT BMP'S AT ALL STORM DRAIN INLETS. BMP'S SHALL INCLUDE INLET SEDIMENT CONTROL BARRIER, INLET FILTER BAG AND CONCRETE STAMPS OR EXPONDED PLAQUARDS.
- K. EACH CONSTRUCTION SITE SHALL PROVIDE DESIGNATED, PAINT AND WASTE DISPOSAL LOCATIONS AS NECESSARY.
- L. A BMP INSTALLATION SCHEDULE SHALL BE INCLUDED ON THE IMPROVEMENT PLANS. THE SCHEDULE SHALL INCLUDE THE BMP'S FOR BOTH THE WET SEASON AND THE DRY SEASON.



ER-1 PORTABLE CONCRETE WASHOUT CONTAINER  
NO SCALE

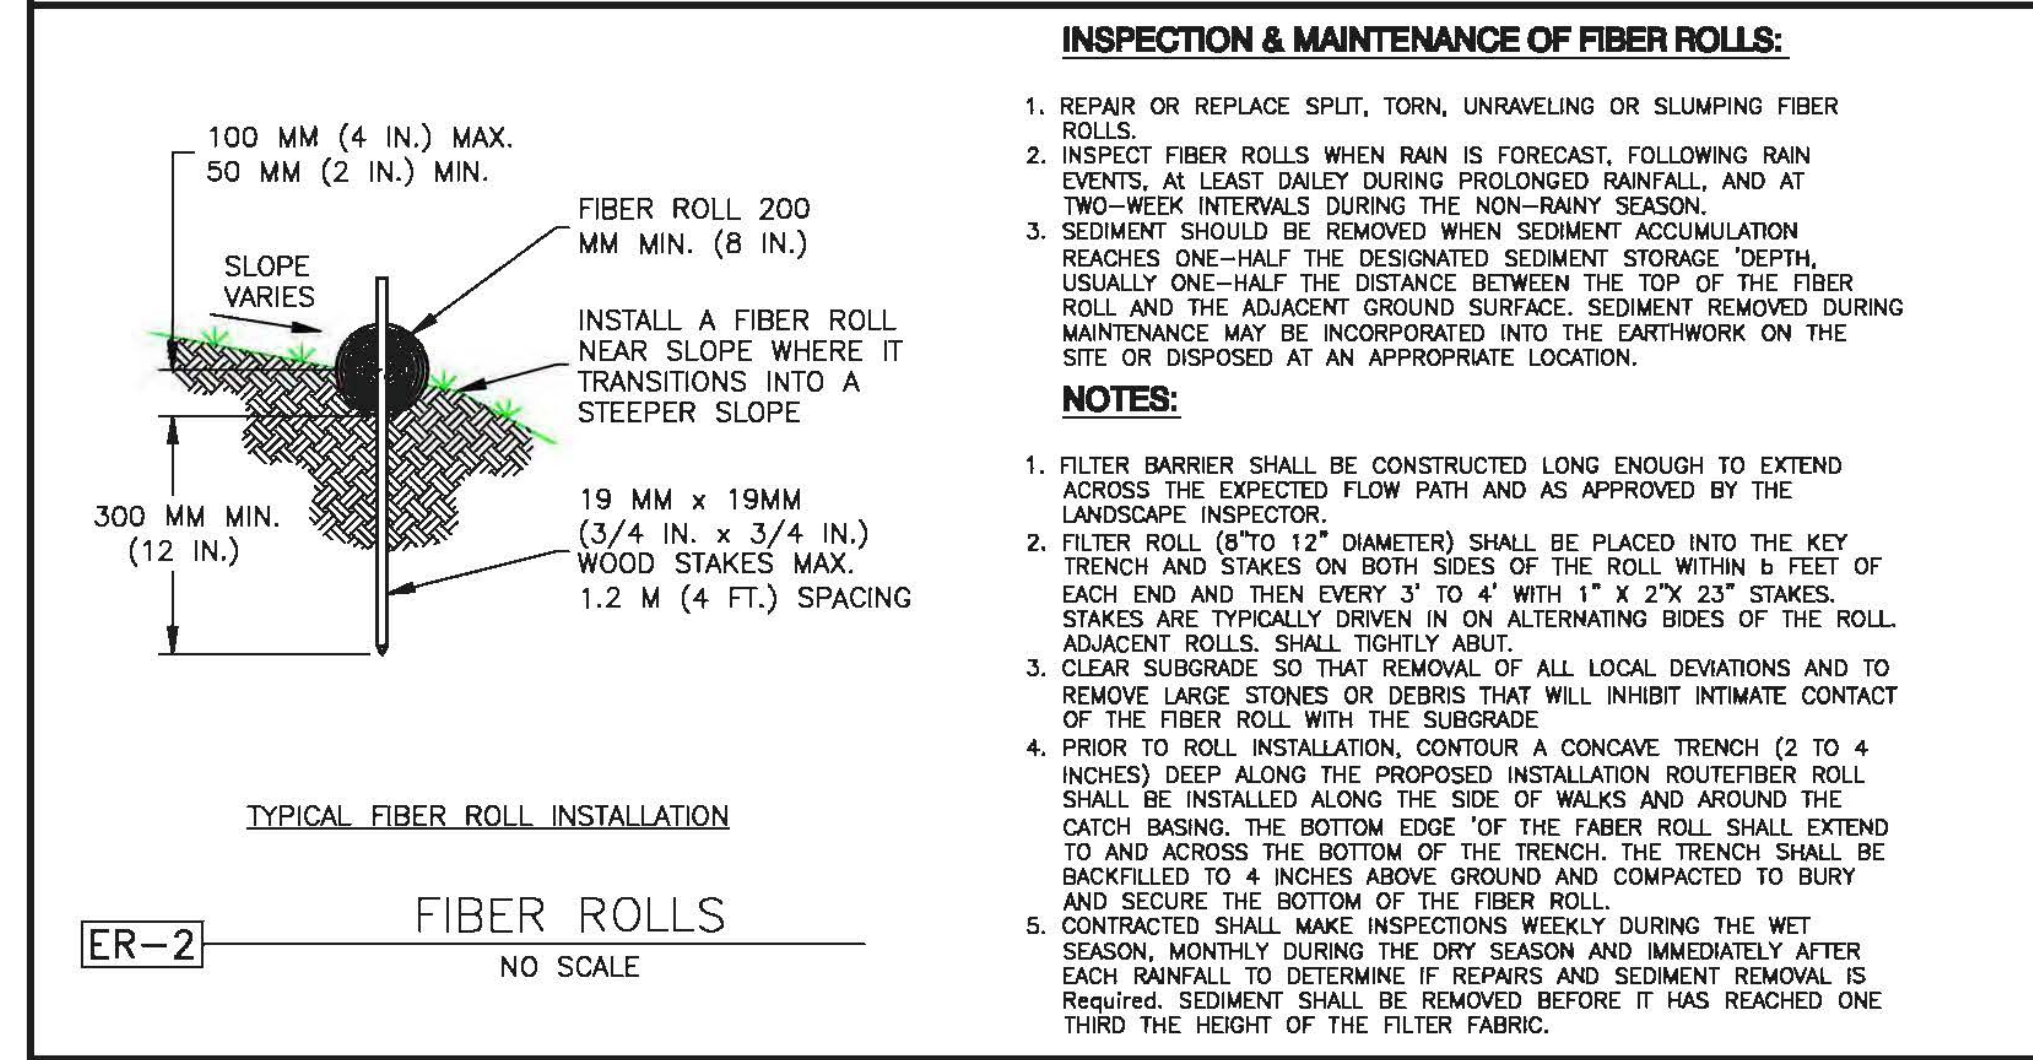

ER-2 FIBER ROLLS  
NO SCALE

### INSPECTION & MAINTENANCE OF FIBER ROLLS:

1. REPAIR OR REPLACE SPLIT, TORN, UNRAVELING OR SLUMPING FIBER ROLLS.
2. INSPECT FIBER ROLLS WHEN RAIN IS FORECAST, FOLLOWING RAIN EVENTS, AT LEAST DAILY DURING PROLONGED RAINFALL, AND AT TWO-WEEK INTERVALS DURING THE NON-RAINY SEASON.
3. SEDIMENT SHOULD BE REMOVED WHEN SEDIMENT ACCUMULATION REACHES ONE-HALF THE DESIGNATED SEDIMENT STORAGE DEPTH, USUALLY ONE-HALF THE DISTANCE BETWEEN THE TOP OF THE FIBER ROLL AND THE ADJACENT GROUND SURFACE. SEDIMENT REMOVED DURING MAINTENANCE MAY BE INCORPORATED INTO THE EARTHWORK ON THE SITE OR DISPOSED AT AN APPROPRIATE LOCATION.

### NOTES:

1. FILTER BARRIER SHALL BE CONSTRUCTED LONG ENOUGH TO EXTEND ACROSS THE EXPECTED FLOW PATH AND AS APPROVED BY THE LANDSCAPE INSPECTOR.
2. FILTER ROLL (8" TO 12" DIAMETER) SHALL BE PLACED INTO THE KEY TRENCH AND STAKES ON BOTH SIDES OF THE ROLL WITHIN 6 FEET OF EACH END AND THEN EVERY 3' TO 4' WITH 1" X 2" X 23" STAKES. STAKES ARE TYPICALLY DRIVEN IN ON ALTERNATING SIDES OF THE ROLL ADJACENT ROLLS. SHALL TIGHTLY ABUT.
3. CLEAR SUBGRADE SO THAT REMOVAL OF ALL LOCAL DEVIATIONS AND TO REMOVE LARGE STONES OR DEBRIS THAT WILL INHIBIT INTIMATE CONTACT OF THE FIBER ROLL WITH THE SUBGRADE.
4. PRIOR TO ROLL INSTALLATION, CONTOUR A CONCAVE TRENCH (2 TO 4 INCHES) DEEP ALONG THE PROPOSED INSTALLATION ROUTE. FIBER ROLL SHALL BE INSTALLED ALONG THE SIDE OF WALKS AND AROUND THE CATCH BASIN. THE BOTTOM EDGE OF THE FIBER ROLL SHALL EXTEND TO AND ACROSS THE BOTTOM OF THE TRENCH. THE TRENCH SHALL BE BACKFILLED TO 4 INCHES ABOVE GROUND AND COMPACTED TO BURY AND SECURE THE BOTTOM OF THE FIBER ROLL.
5. CONTRACTOR SHALL MAKE INSPECTIONS WEEKLY DURING THE WET SEASON, MONTHLY DURING THE DRY SEASON AND IMMEDIATELY AFTER EACH RAINFALL TO DETERMINE IF REPAIRS AND SEDIMENT REMOVAL IS REQUIRED. SEDIMENT SHALL BE REMOVED BEFORE IT HAS REACHED ONE THIRD THE HEIGHT OF THE FIBER FABRIC.

## REVEGETATION STANDARDS

1. PERMANENT REVEGETATION OR LANDSCAPING, IF REQUIRED, IS TO BE COMMENCED ON THE CONSTRUCTION SITE AS SOON AS PRACTICAL AND IN NO CASE EXCEEDING TWELVE MONTHS AFTER ACHIEVING FINAL GRADES AND UTILITY PLACEMENTS. WHENEVER PRACTICAL, LAND IS TO BE DEVELOPED IN INCREMENTS OF WORKABLE SIZE WHICH CAN BE COMPLETED DURING A SINGLE CONSTRUCTION SEASON. EROSION CONTROL MEASURES ARE TO BE COORDINATED WITH THE SEQUENCE OF GRADING OR IMPROVEMENTS.
2. ALL SURFACES DISTURBED BY VEGETATION REMOVAL, GRADING, HAUL ROADS, OR OTHER ACTIVITY OF CONSTRUCTION WHICH ALTERS THE NATURAL VEGETATIVE COVER ARE TO BE PREPARED FOR EXPEDITED REVEGETATION OR OTHERWISE MAINTAINED TO CONTROL EROSION UNLESS COVERED WITH IMPERVIOUS OR OTHER IMPROVED SURFACES PURSUANT TO APPROVED PLANS WITHIN FOURTEEN DAYS FOLLOWING THE COMPLETION OF GRADING, OR REMOVAL OF VEGETATION IF NO GRADING WAS INVOLVED.
3. TOPSOIL REMOVED FROM THE SURFACE IN PREPARATION FOR GRADING SHALL BE RESTORED TO EXPOSE CUT AND FILL EMBANKMENTS OR BUILDING PADS SO AS TO PROVIDE A SUITABLE BASE FOR SEEDING AND PLANTING.
4. ACCEPTABLE METHODS OF REVEGETATION INCLUDE STRAW-MULCHING, HYDRO-MULCHING OR PLANTING OF MIXTURE SPECIFIED IN THE IMPROVEMENT STANDARDS. OTHER METHODS OF REVEGETATION MAY BE APPROVED BY THE COUNTY ENGINEER WHERE EQUIVALENT PROTECTION IS PROVIDED.
5. ALL REVEGETATION AND LANDSCAPING ARE TO BE CONDUCTED WITHIN SUITABLE GROWING PERIODS. NATIVE PLANT MATERIALS ARE SPECIFICALLY ENCOURAGED IN ORDER TO REDUCE IRRIGATION DEMANDS.
6. TEMPORARY SEDIMENTATION CONTROL FACILITIES ARE TO BE INSTALLED IN CONJUNCTION WITH INITIAL GRADING OPERATIONS AND MAINTAINED THROUGHOUT THE CONSTRUCTION PERIOD TO REMOVE SEDIMENTS FROM RUNOFF WATERS DURING DEVELOPMENT.
7. PERMANENT SEDIMENT CATCHMENT BASINS OR OTHER TYPES OF SEDIMENT RETENTION FACILITIES ARE REQUIRED WHEREVER NECESSARY TO PREVENT DISCHARGE OF SEDIMENT INTO WATERS OF THE STATE. SEDIMENT RETENTION FACILITIES SHALL BE INSPECTED AND CLEANED ACCORDING TO A REGULAR MAINTENANCE SCHEDULE.
8. THE PLANTING OR SEEDING OF VEGETATIVE PROTECTION MUST BE EFFECTIVE. IF THE VEGETATION DOES NOT GROW AND OFFER PROPER PROTECTION, IT MUST BE REPLANTED OR RESEEDED.
9. THE MAINTENANCE OF VEGETATIVE PROTECTION ON GRADED SLOPES SHALL BE THE RESPONSIBILITY OF THE PERMITEE AND SHALL BE GUARANTEED UNTIL THE VEGETATION IS WELL ESTABLISHED OR IS OFFICIALLY ASSUMED BY ANOTHER PARTY.

## DUST MITIGATION PLAN

### SECTION 1: FUGITIVE DUST PREVENTION AND CONTROL

LAND CLEARING/EARTH MOVING:  
WATER SHALL BE APPLIED BY MEANS OF TRUCK(S), HOSES AND/OR SPRINKLERS PRIOR TO ANY LAND CLEARING OR EARTH MOVEMENT TO MINIMIZE DUST EMISSIONS. HAUL VEHICLES TRANSPORTING SOIL INTO OR OUT OF THE PROPERTY SHALL BE COVERED.

VISIBLY DRY DISTURBED SOIL SURFACE AREAS:  
ALL VISIBLY DRY DISTURBED SOIL SURFACE AREAS OF OPERATION SHALL BE WATERED TO MINIMIZE DUST EMISSIONS.

PAVED ROAD TRACK-OUT:  
PAVED ROADS SHALL BE CLEANED IF THE AMOUNT OF DIRT TRACKED-OUT OF THE OPERATION AREA HAS THE POTENTIAL TO CAUSE DUST EMISSIONS.

VISIBLY DRY DISTURBED UNPAVED DRIVEWAYS:  
ALL VISIBLY DRY DISTURBED UNPAVED DRIVEWAY SURFACE AREAS OF OPERATION SHALL BE WATERED TO MINIMIZE DUST EMISSIONS. UNPAVED DRIVEWAYS MAY BE GRAVELED TO REDUCE DUST EMISSIONS.

VEHICLES ENTERING / EXITING CONSTRUCTION AREA:  
VEHICLES ENTERING OR EXITING CONSTRUCTION AREA SHALL TRAVEL AT A SPEED WHICH MINIMIZES DUST EMISSIONS.

EMPLOYEE VEHICLES:  
CONSTRUCTION WORKERS PARK IN DESIGNATED PARKING AREA(S) TO HELP REDUCE DUST EMISSIONS.

SOIL PILES:  
SOIL PILE SURFACES SHALL BE MOISTENED IF DUST IS BEING EMITTED FROM THE PILE(S). ADEQUATELY SECURED TARPS, PLASTIC OR OTHER MATERIAL MAY BE REQUIRED TO FURTHER REDUCE DUST EMISSIONS.

### PROPRIETARY INFORMATION

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CLIENT:



2600 CAMINO RAMON  
SAN RAMON, CA 94583

PROJECT INFORMATION:

### SOAPWEED

4070 STOPE DR  
PLACERVILLE, CA 95667

REV: DATE: DESCRIPTION: BY:

REV	DATE	DESCRIPTION	BY
1	6-14-17	90% ZONING DOC'S	RB
2	8-3-17	REV 90% ZONING DOC'S	RB
3	8-21-17	100% ZONING DOC'S	RB

COORDINATING ENGINEER:

### Peek Site-Com

12852 Earhart Ave. Suite 101  
Auburn, California 95602  
Phone (530) 885-6160

E-Mail info@peeksitecom.com

SEAL:



SITE #: CHK.: DRAWN BY:

CVL03411 ... RB

SHEET TITLE:

## EROSION CONTROL NOTES

SHEET NUMBER: REVISION:

C-3 0

## GRADING-EROSION SEDIMENT CONTROL NOTES 1







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 SAN RAMON, CA 94583

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 E-Mail info@peeksitocom.com


SEAL:



SITE #	CHK.	DRAWN BY:
CVL03411	...	RB


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**PRELIMINARY  
 GROUNDING PLAN**


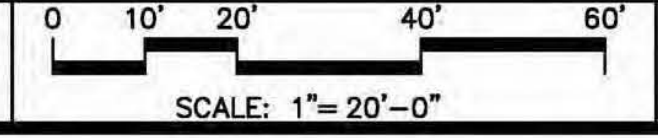
SHEET NUMBER:	REVISION:
<b>C-5</b>	<b>0</b>

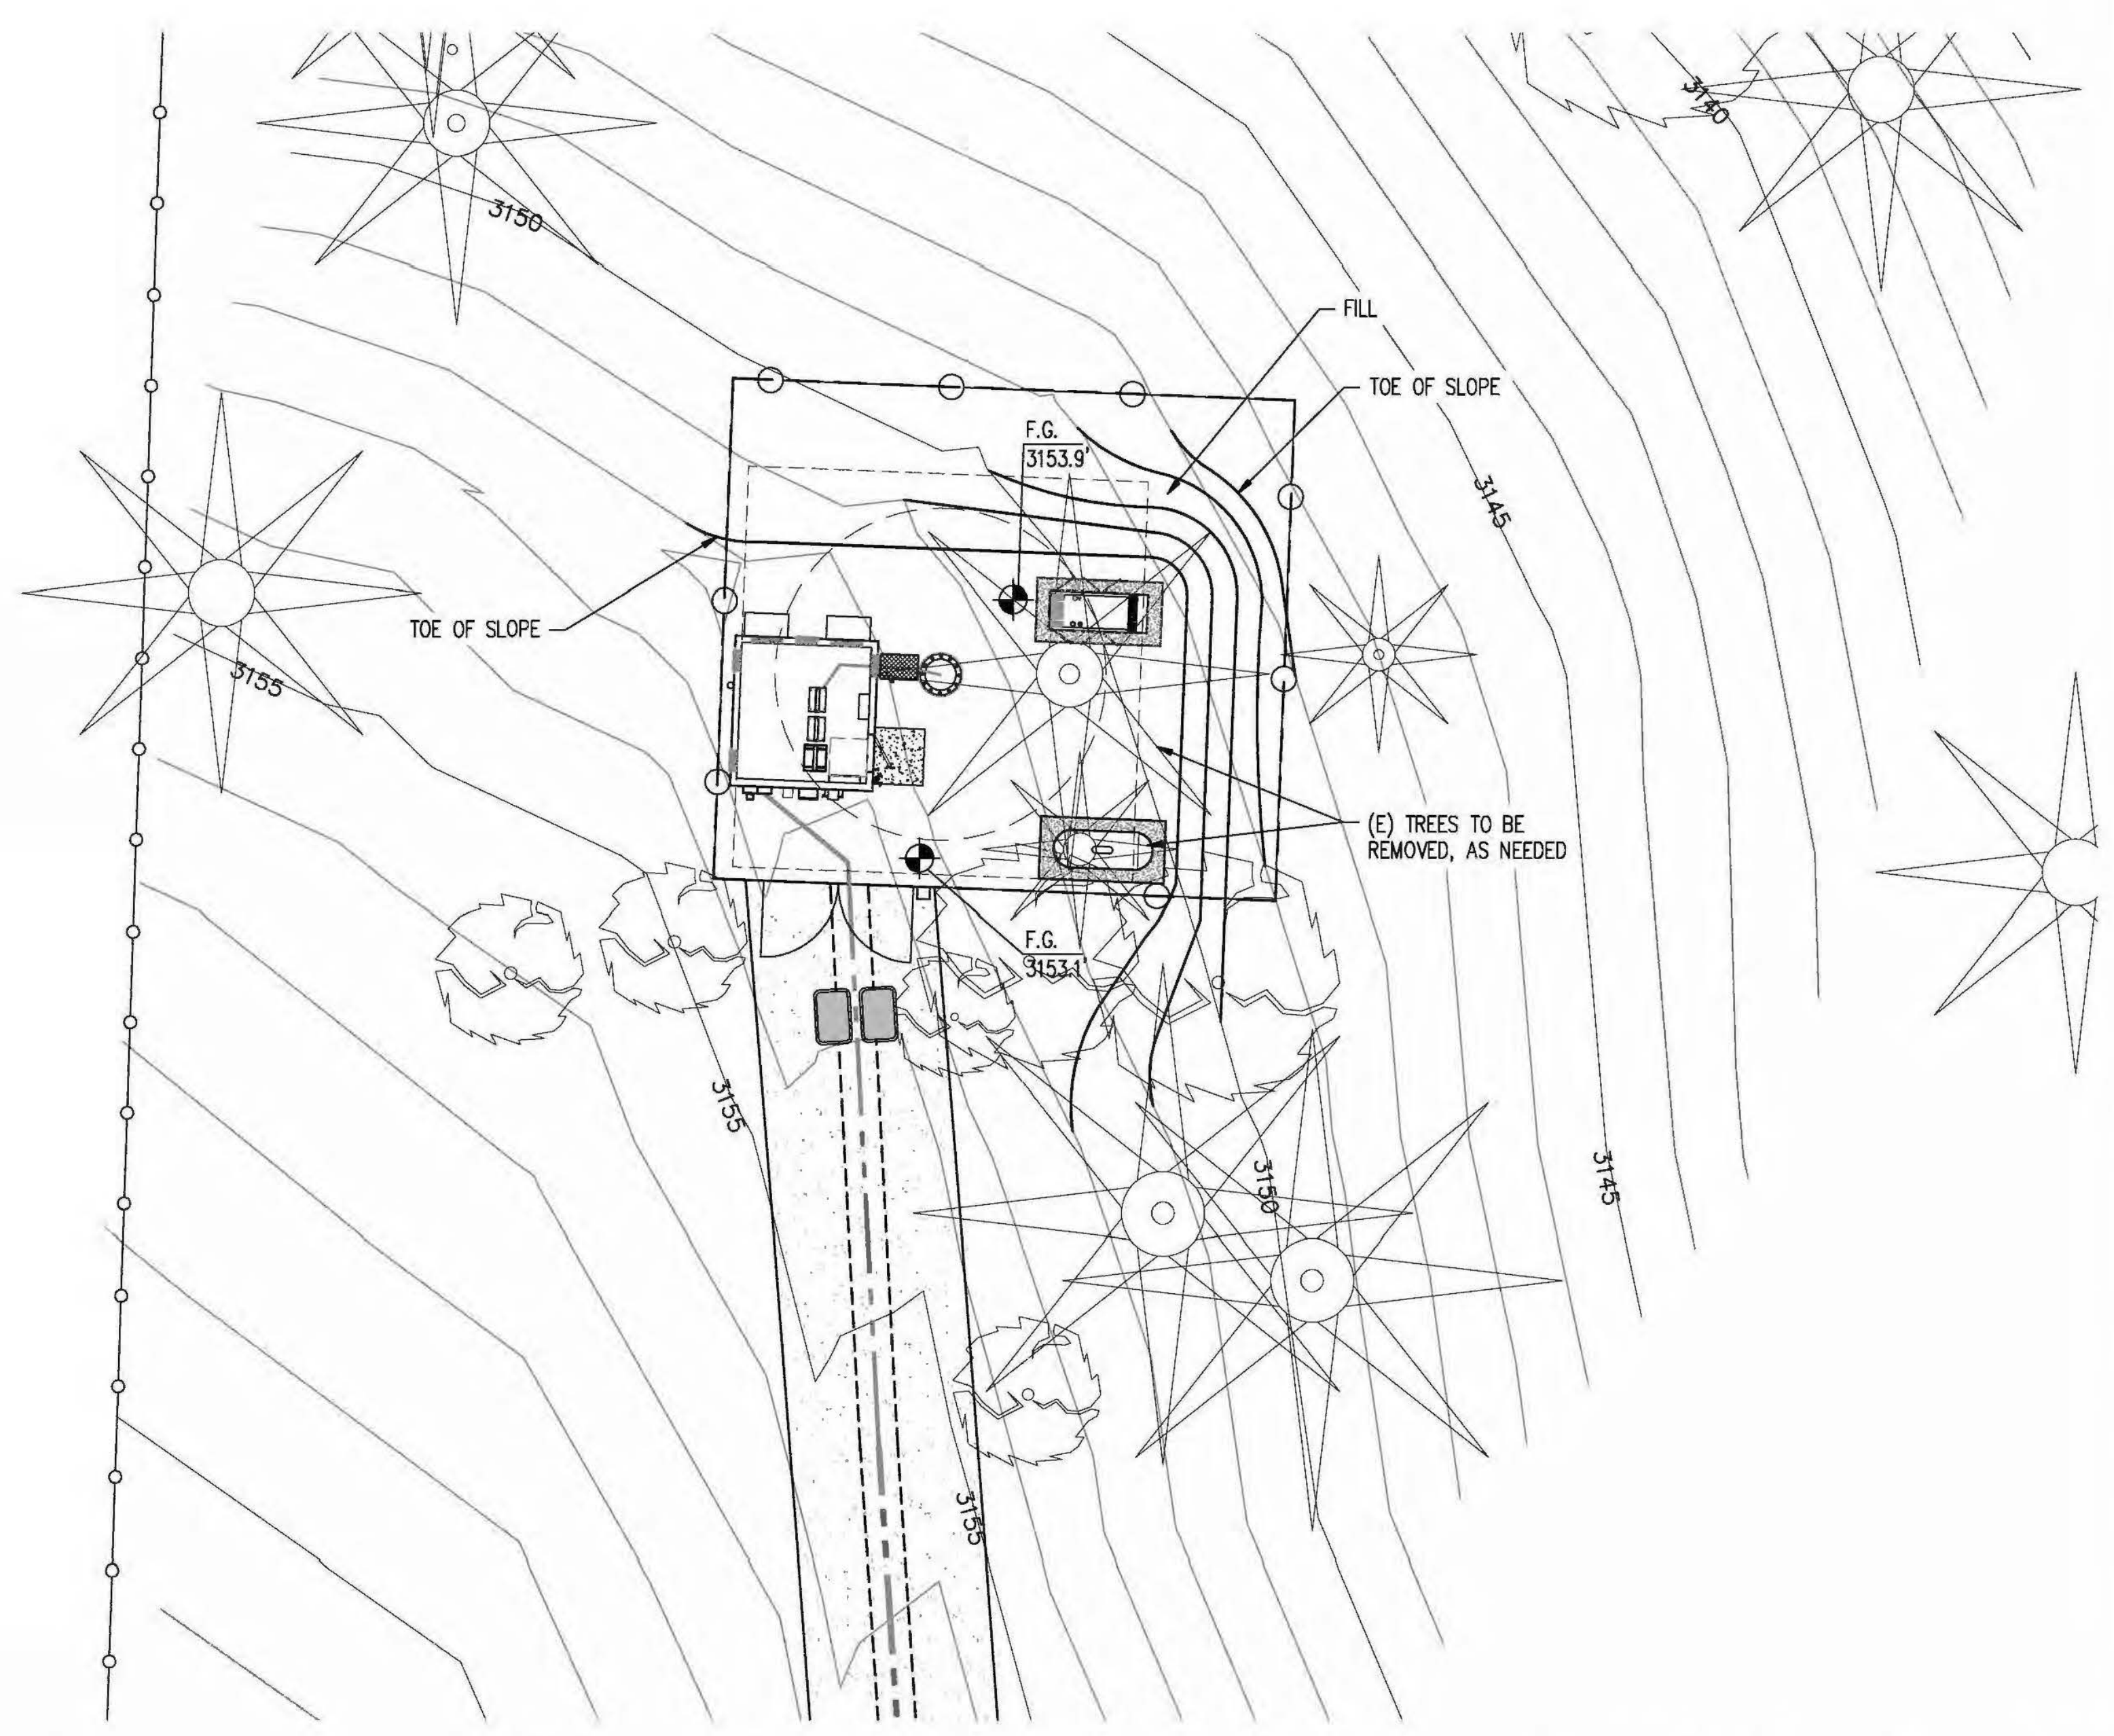

**PRELIMINARY GROUNDING PLAN** SCALE: 1"=10'-0"



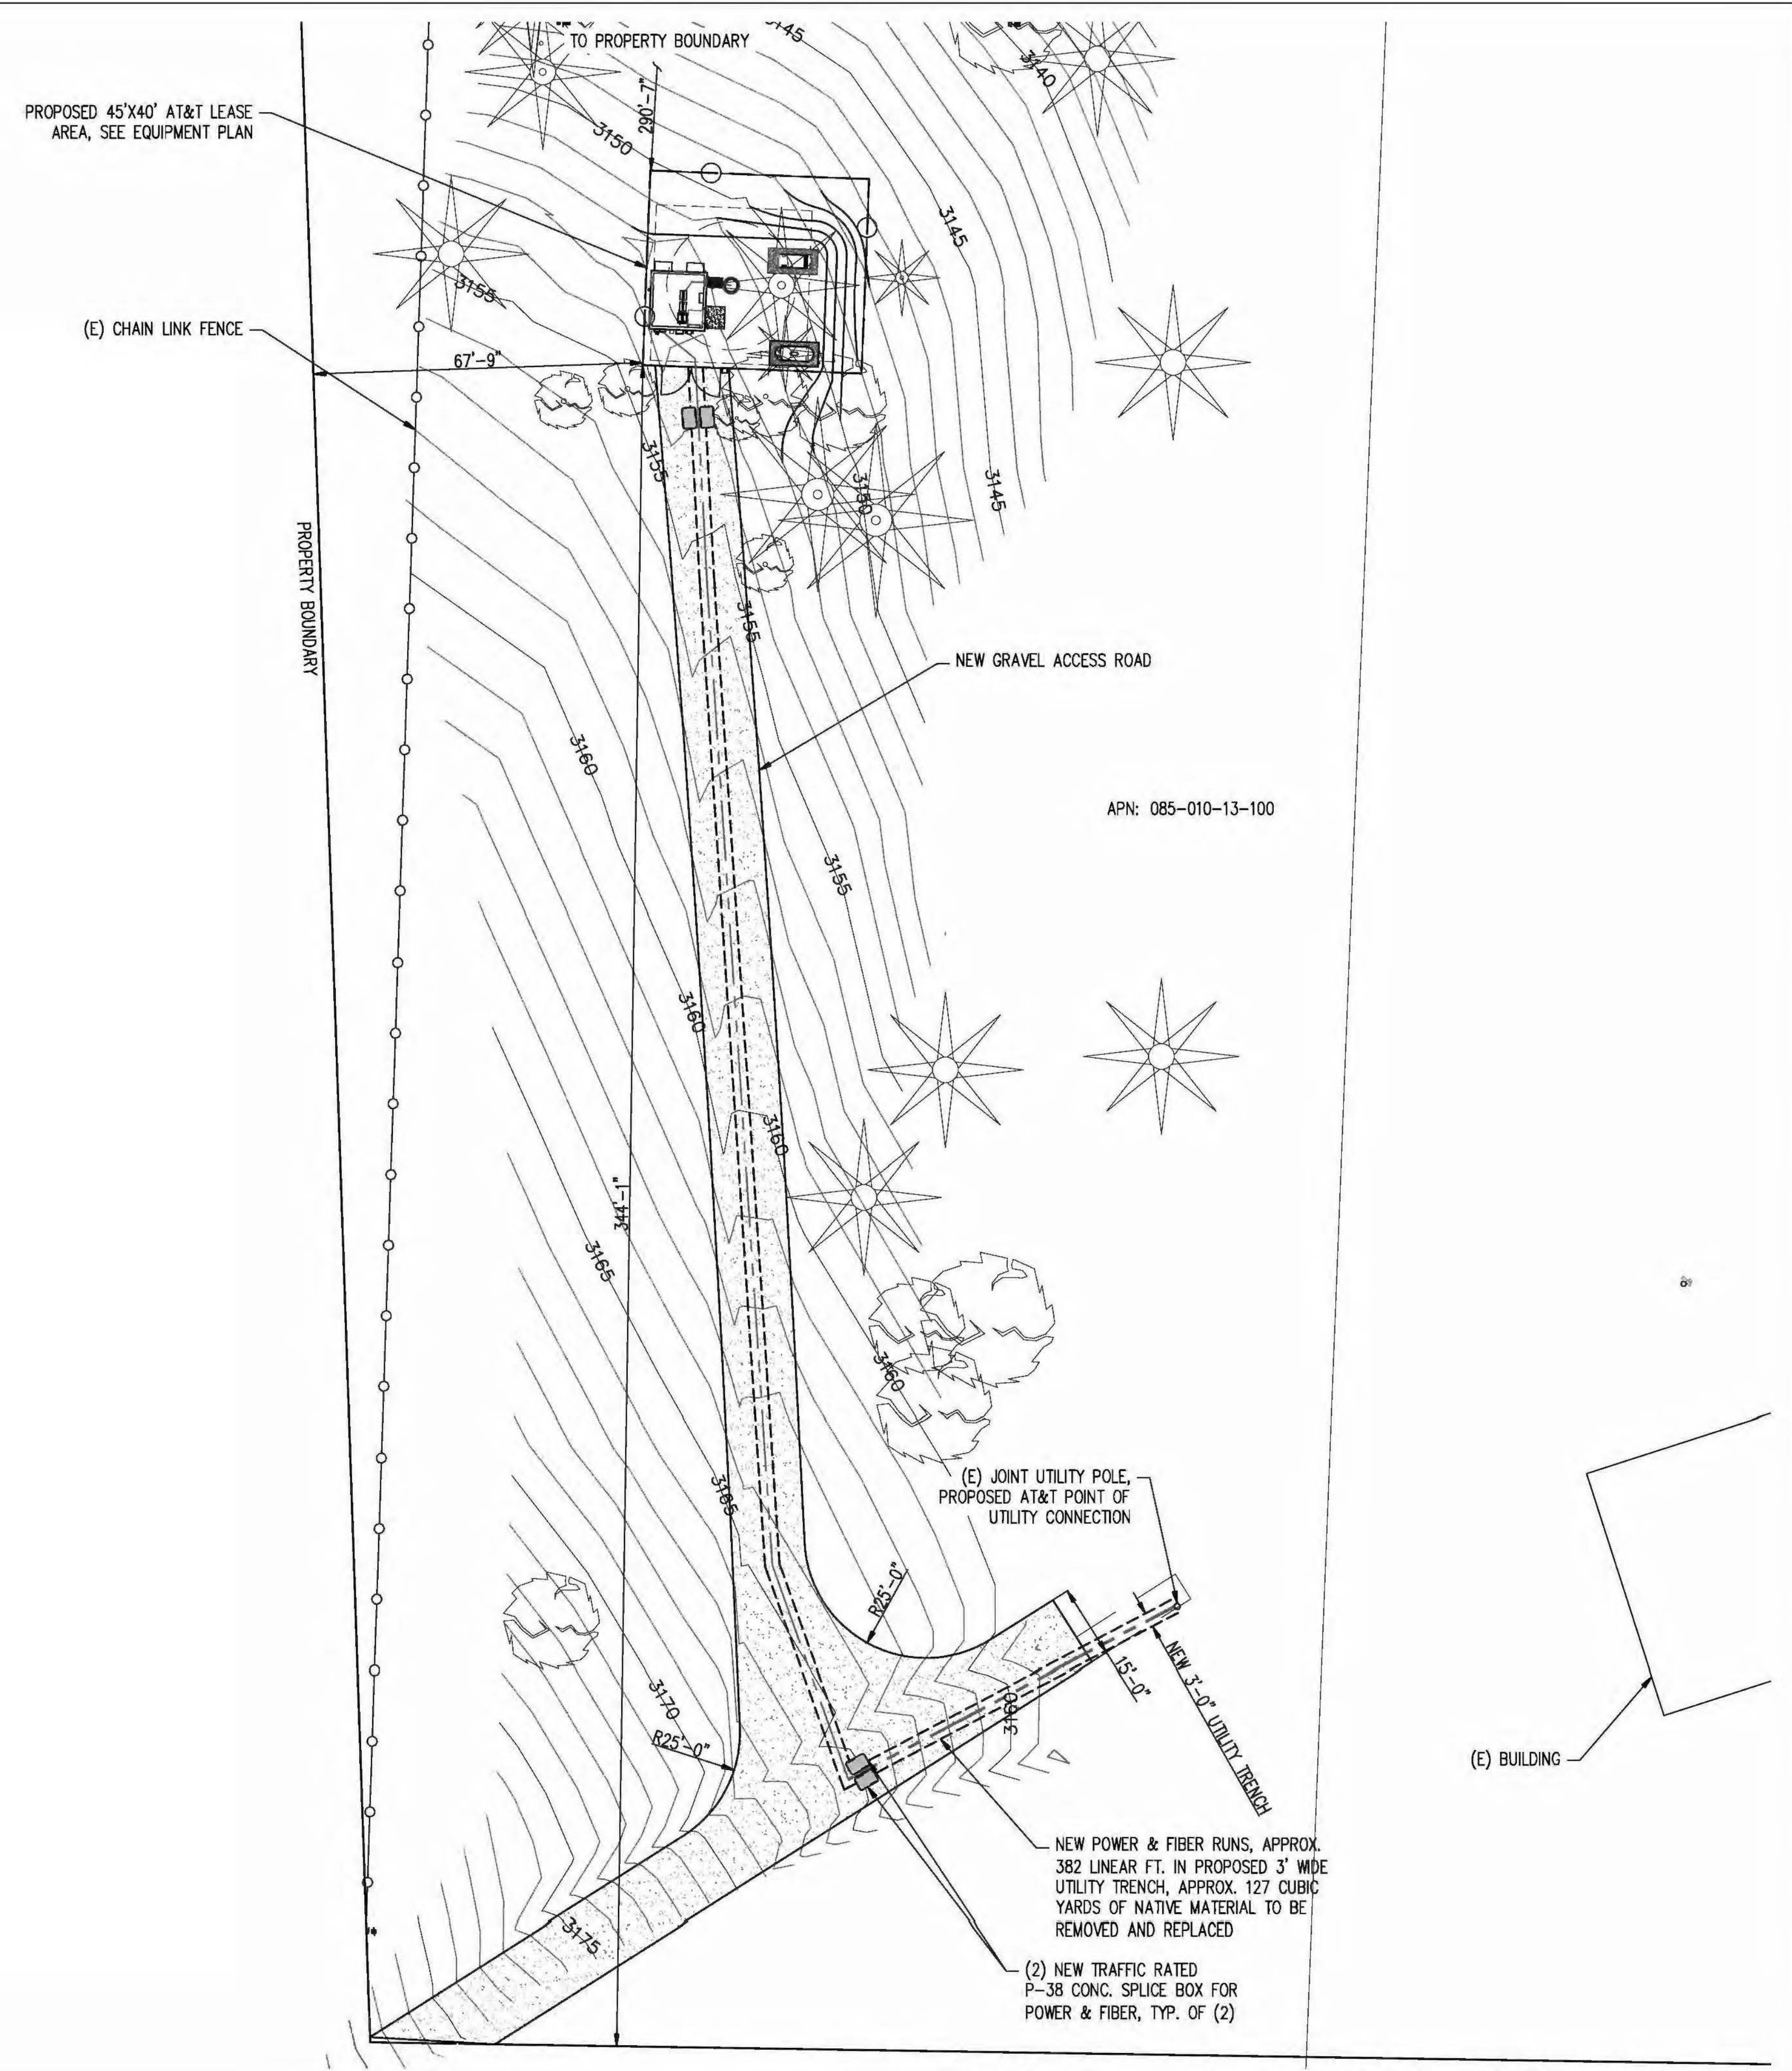


**SITE PLAN**   **1**

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CLIENT:



2600 CAMINO RAMON  
 SAN RAMON, CA 94583

PROJECT INFORMATION:

**SOAPWEED**  
 4070 STOPE DR  
 PLACERVILLE, CA 95667

APN: 085-010-13-100

REV:	DATE:	DESCRIPTION:	BY:
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3	8-21-17	100% ZONING DOC'S	RB

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 12852 Earhart Ave. Suite 101  
 Auburn, California 95602  
 Phone (530) 885-6160  
 E-Mail info@peeksitocom.com

SEAL:



SITE #: CVL03411    CHK.: ...    DRAWN BY: RB

SHEET TITLE: **SITE PLAN**

SHEET NUMBER: **A-1**    REVISION: **0**













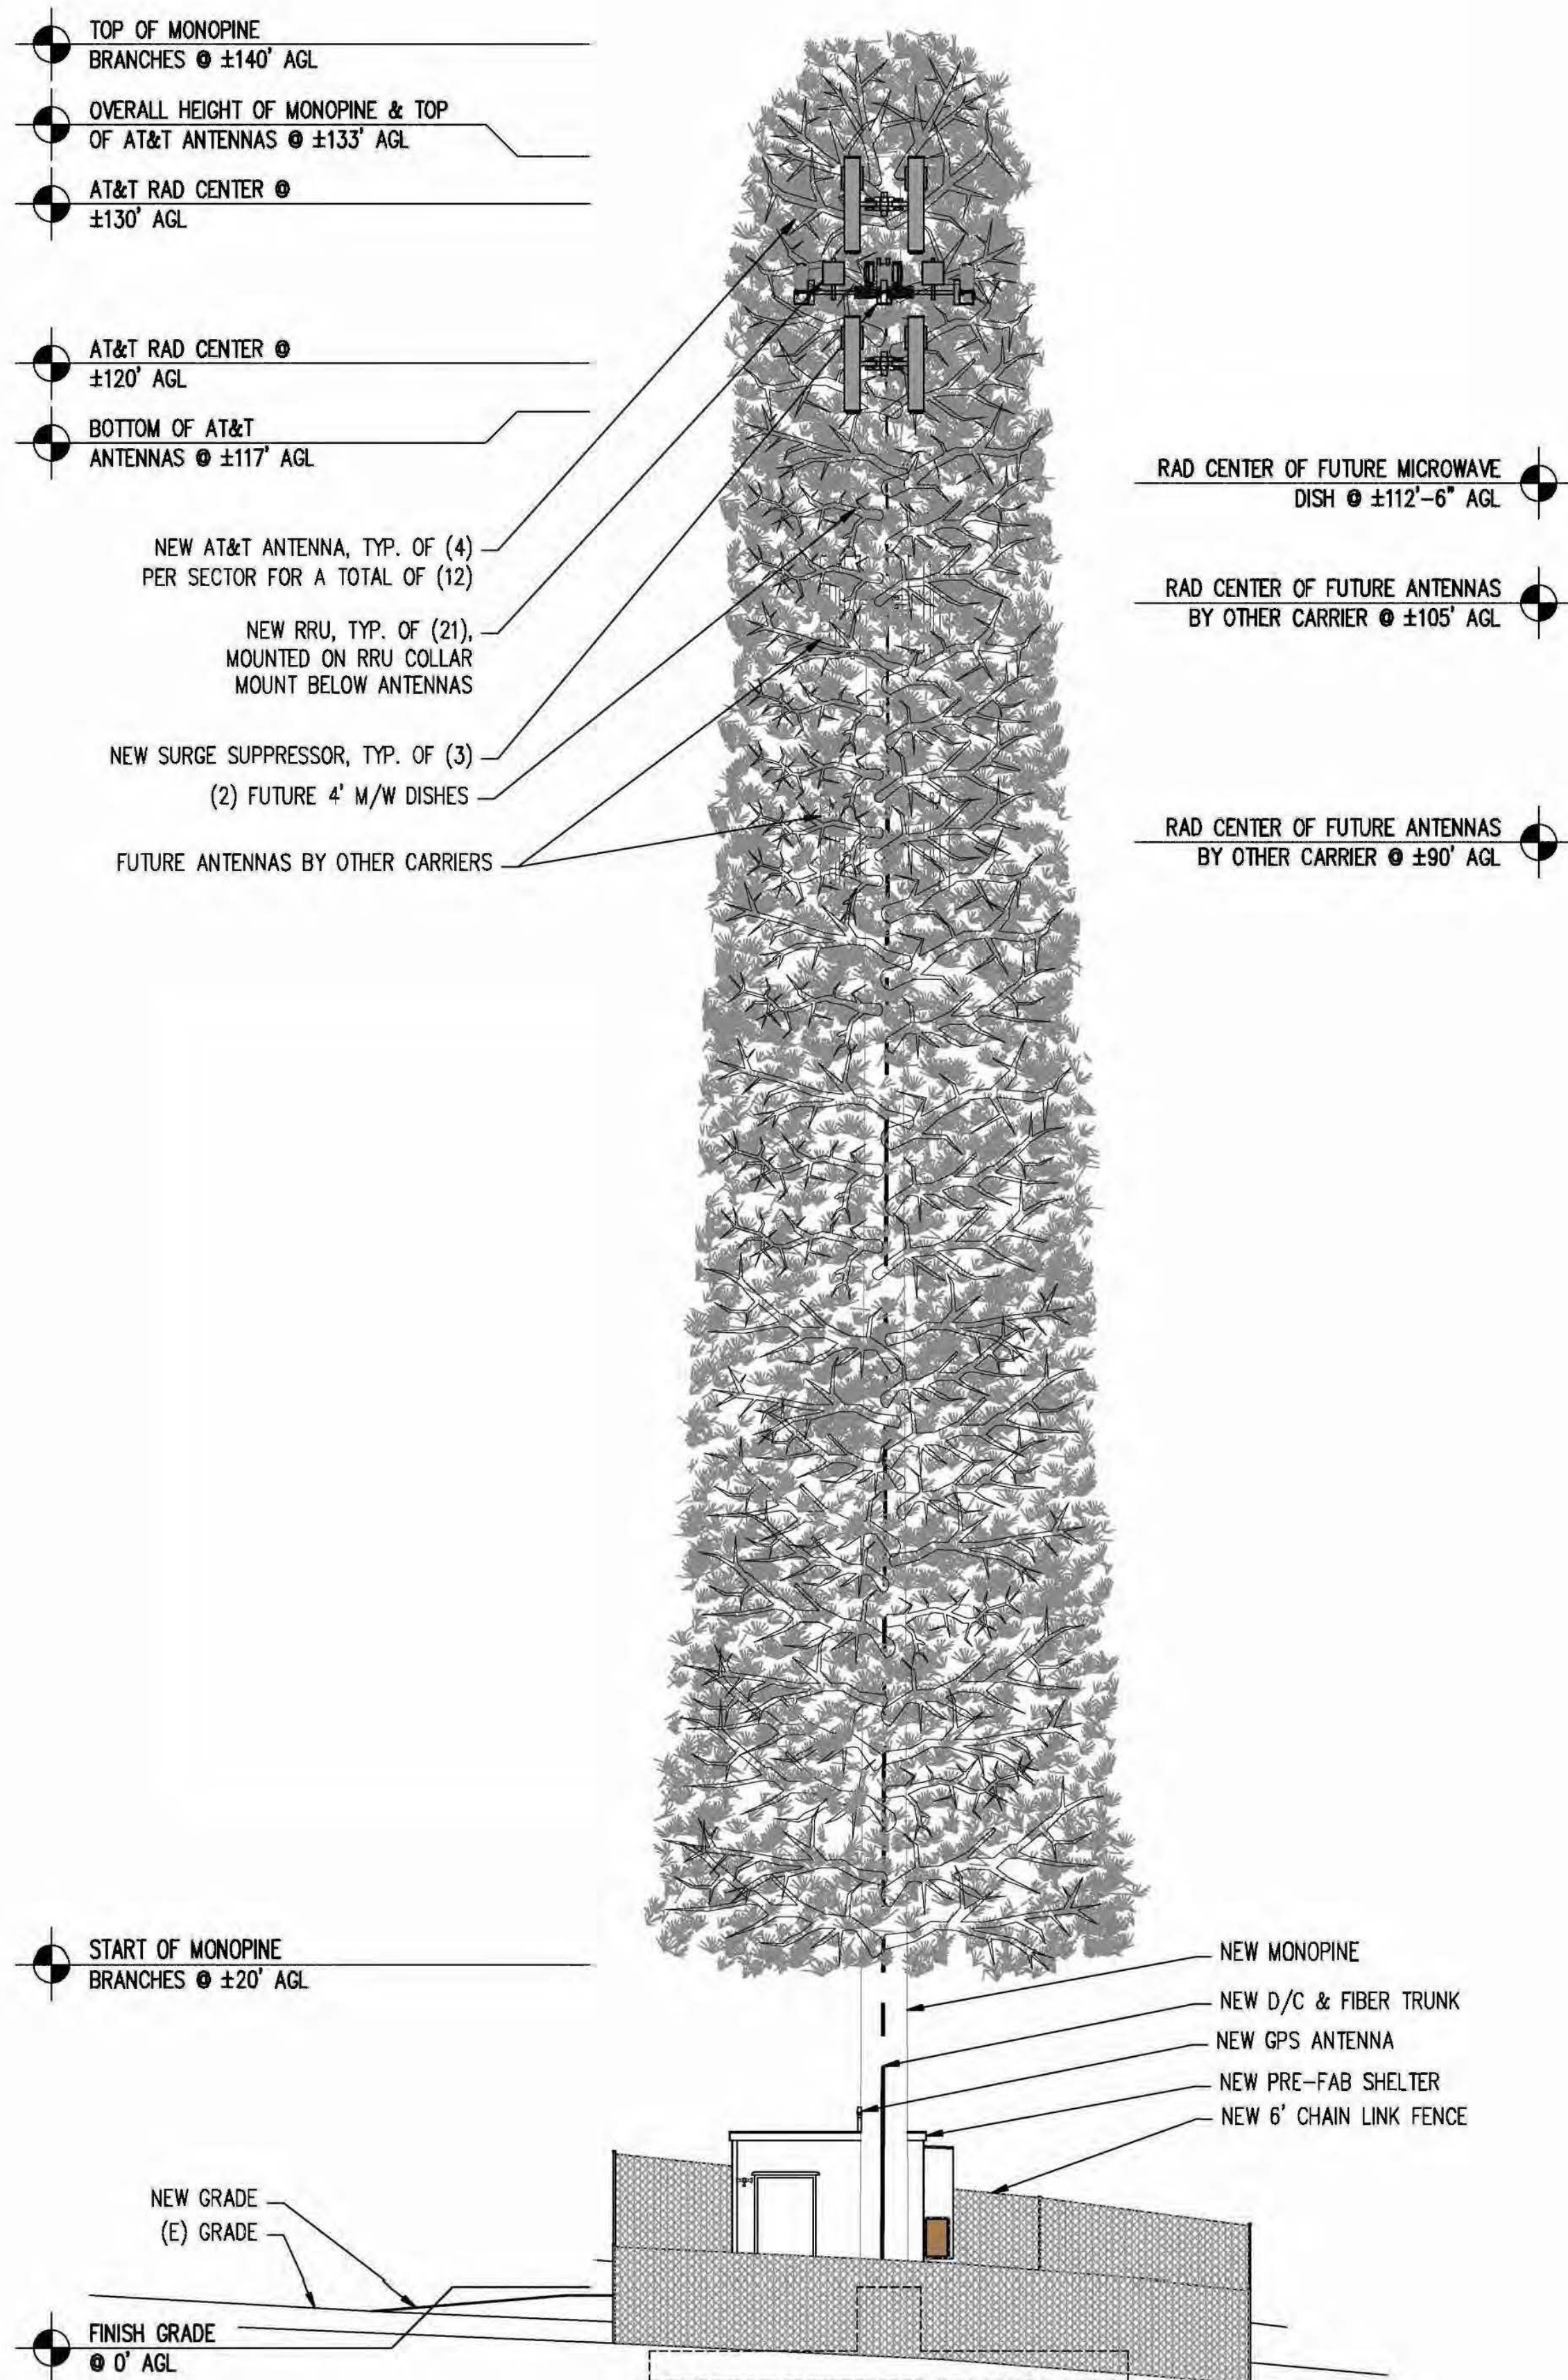

EAST ELEVATION

SCALE: 1/8"=1'-0"

2

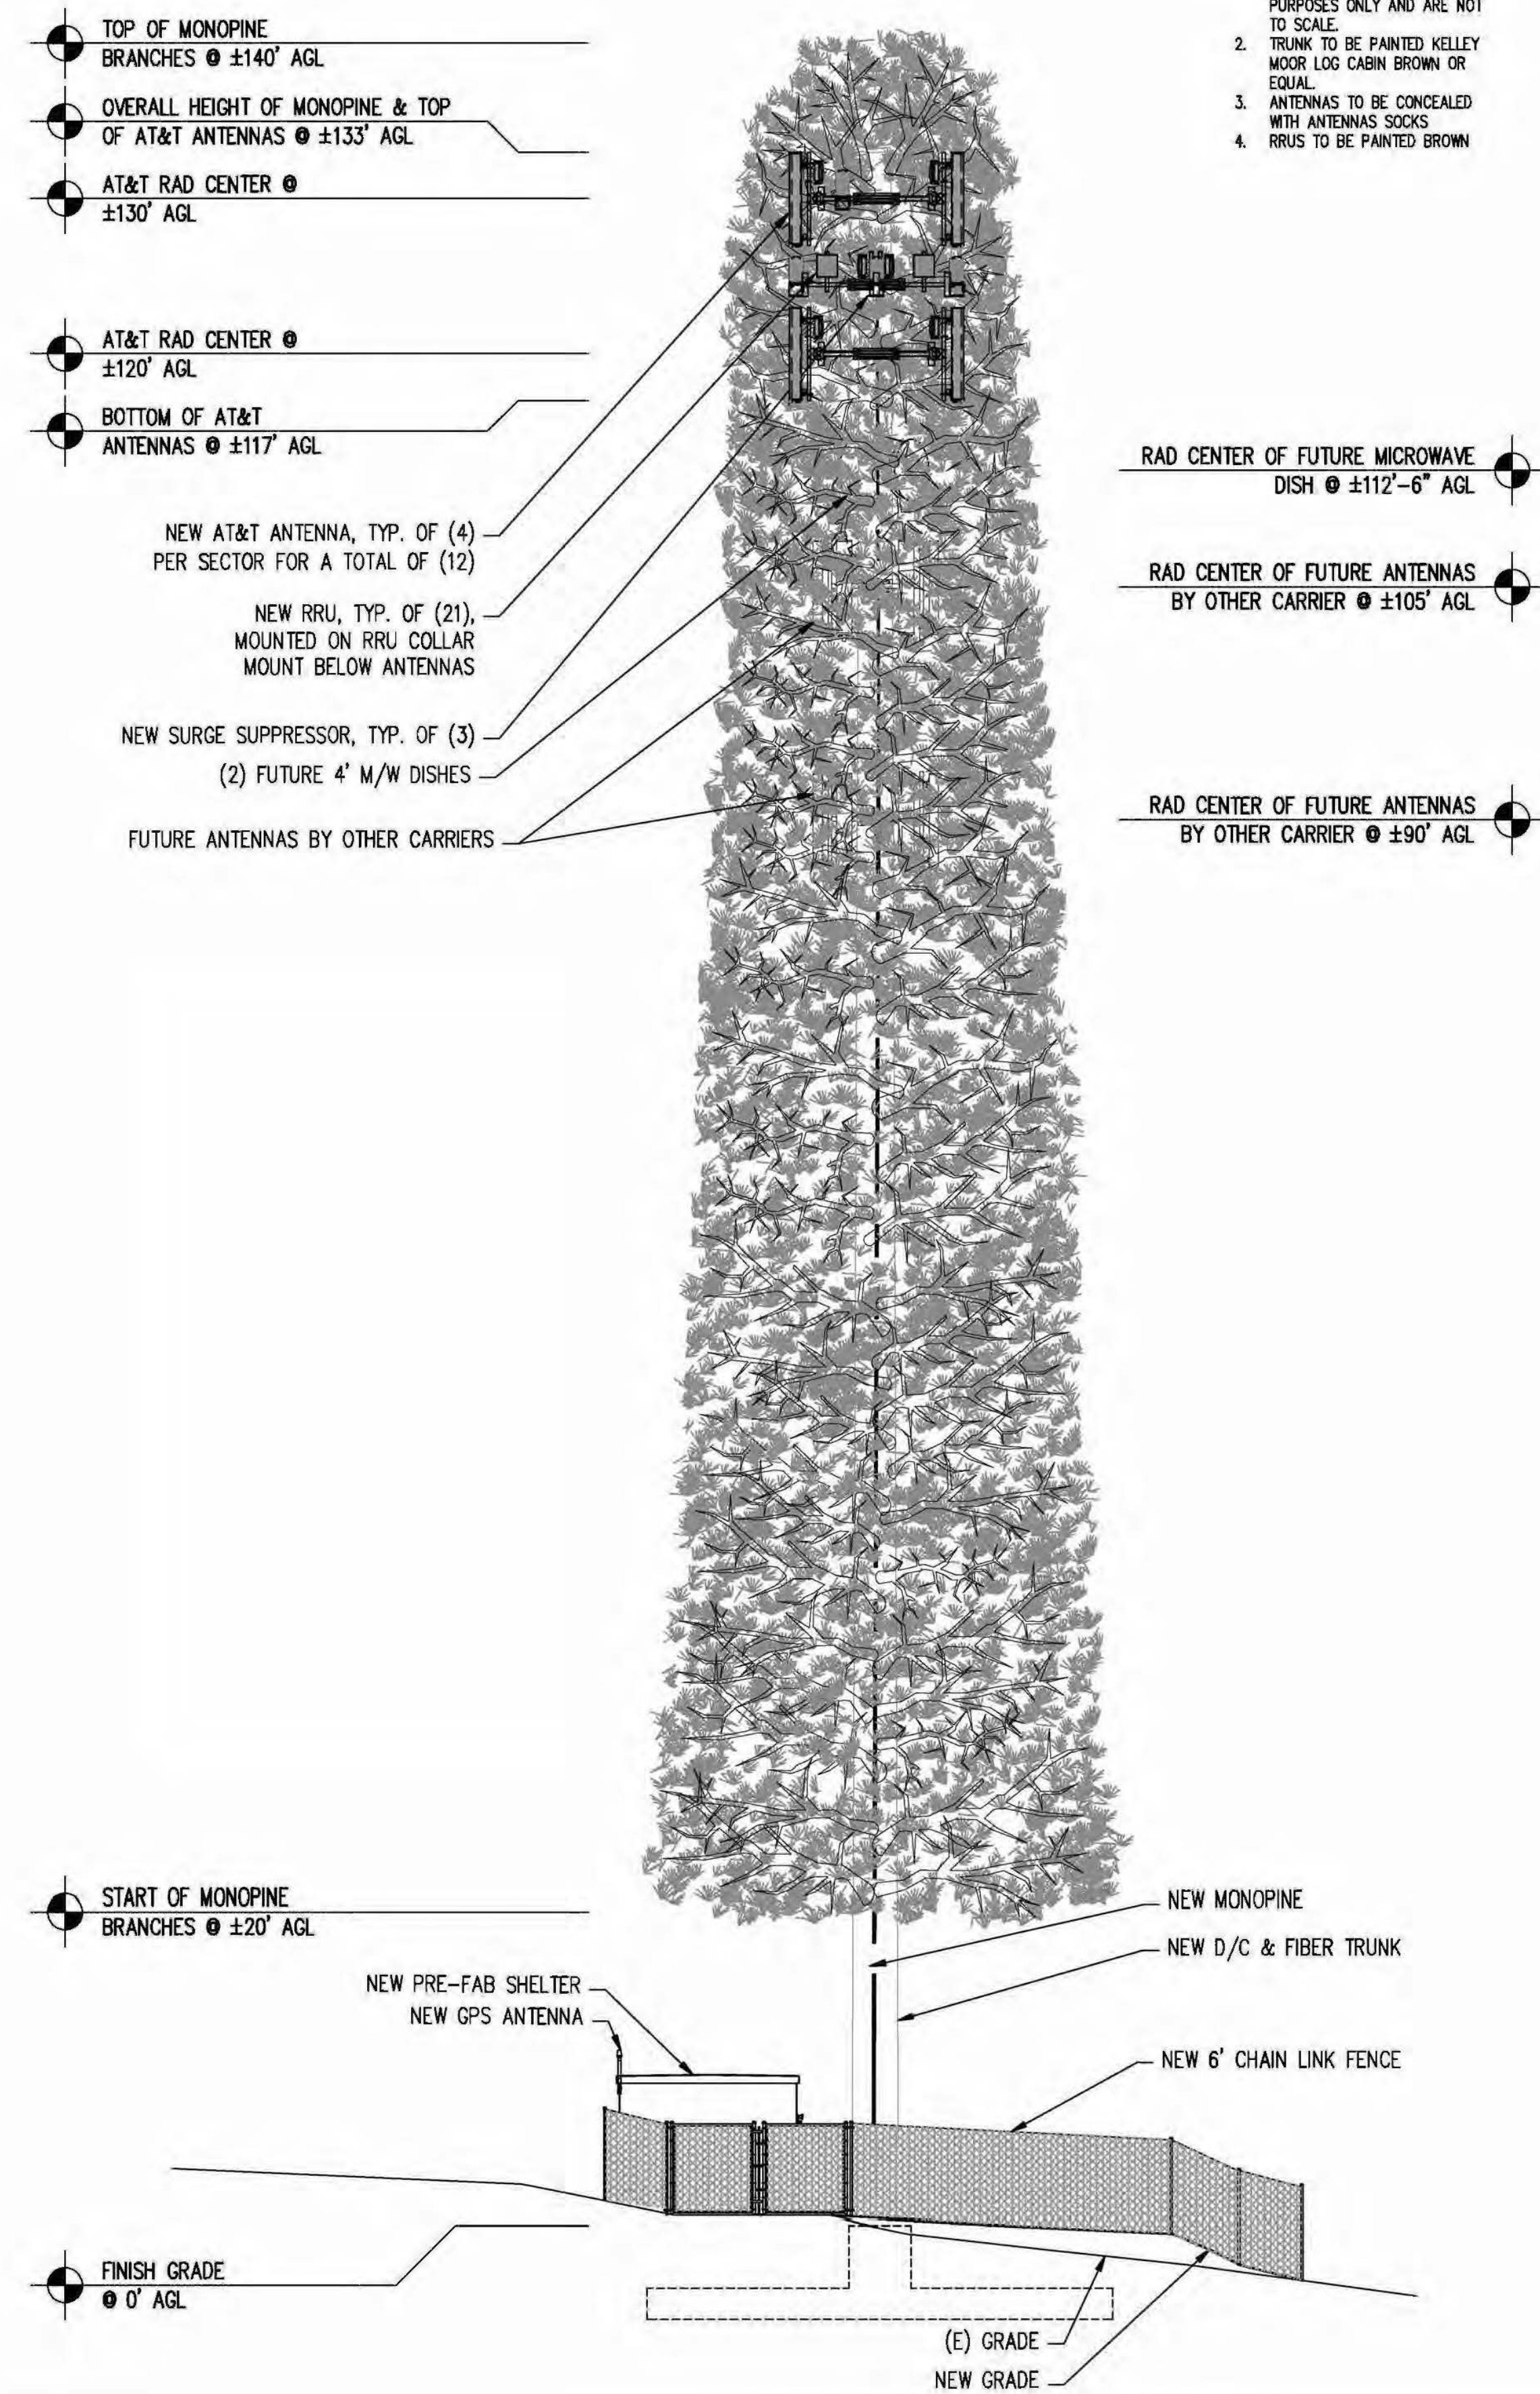

SOUTH ELEVATION

SCALE: 1/8"=1'-0"

1

NOTE:  
 1. MONOPINE BRANCHES SHOWN ARE FOR ILLUSTRATIVE PURPOSES ONLY AND ARE NOT TO SCALE.  
 2. TRUNK TO BE PAINTED KELLEY MOOR LOG CABIN BROWN OR EQUAL.  
 3. ANTENNAS TO BE CONCEALED WITH ANTENNAS SOCKS  
 4. RRU'S TO BE PAINTED BROWN

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CLIENT:

2600 CAMINO RAMON  
SAN RAMON, CA 94583

PROJECT INFORMATION:

**SOAPWEED**  
4070 STOPE DR  
PLACERVILLE, CA 95667

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12852 Earhart Ave. Suite 101  
Auburn, California 95602  
Phone (530) 885-6160  
E-Mail info@peeksitocom.com

SITE #: CVL03411    CHK.: ...    DRAWN BY: RB

SHEET TITLE: **ELEVATIONS**

SHEET NUMBER: **A-4**    REVISION: **0**



- TOP OF MONOPINE BRANCHES @ ±140' AGL
- OVERALL HEIGHT OF MONOPINE & TOP OF AT&T ANTENNAS @ ±133' AGL
- AT&T RAD CENTER @ ±130' AGL


- AT&T RAD CENTER @ ±120' AGL
- BOTTOM OF AT&T ANTENNAS @ ±117' AGL

- NEW AT&T ANTENNA, TYP. OF (4) PER SECTOR FOR A TOTAL OF (12)
- NEW RRU, TYP. OF (21), MOUNTED ON RRU COLLAR MOUNT BELOW ANTENNAS
- NEW SURGE SUPPRESSOR, TYP. OF (3)
- (2) FUTURE 4' M/W DISHES
- FUTURE ANTENNAS BY OTHER CARRIERS

- RAD CENTER OF FUTURE MICROWAVE DISH @ ±112'-6" AGL
- RAD CENTER OF FUTURE ANTENNAS BY OTHER CARRIER @ ±105' AGL
- RAD CENTER OF FUTURE ANTENNAS BY OTHER CARRIER @ ±90' AGL

- START OF MONOPINE BRANCHES @ ±20' AGL

- FINISH GRADE @ 0' AGL

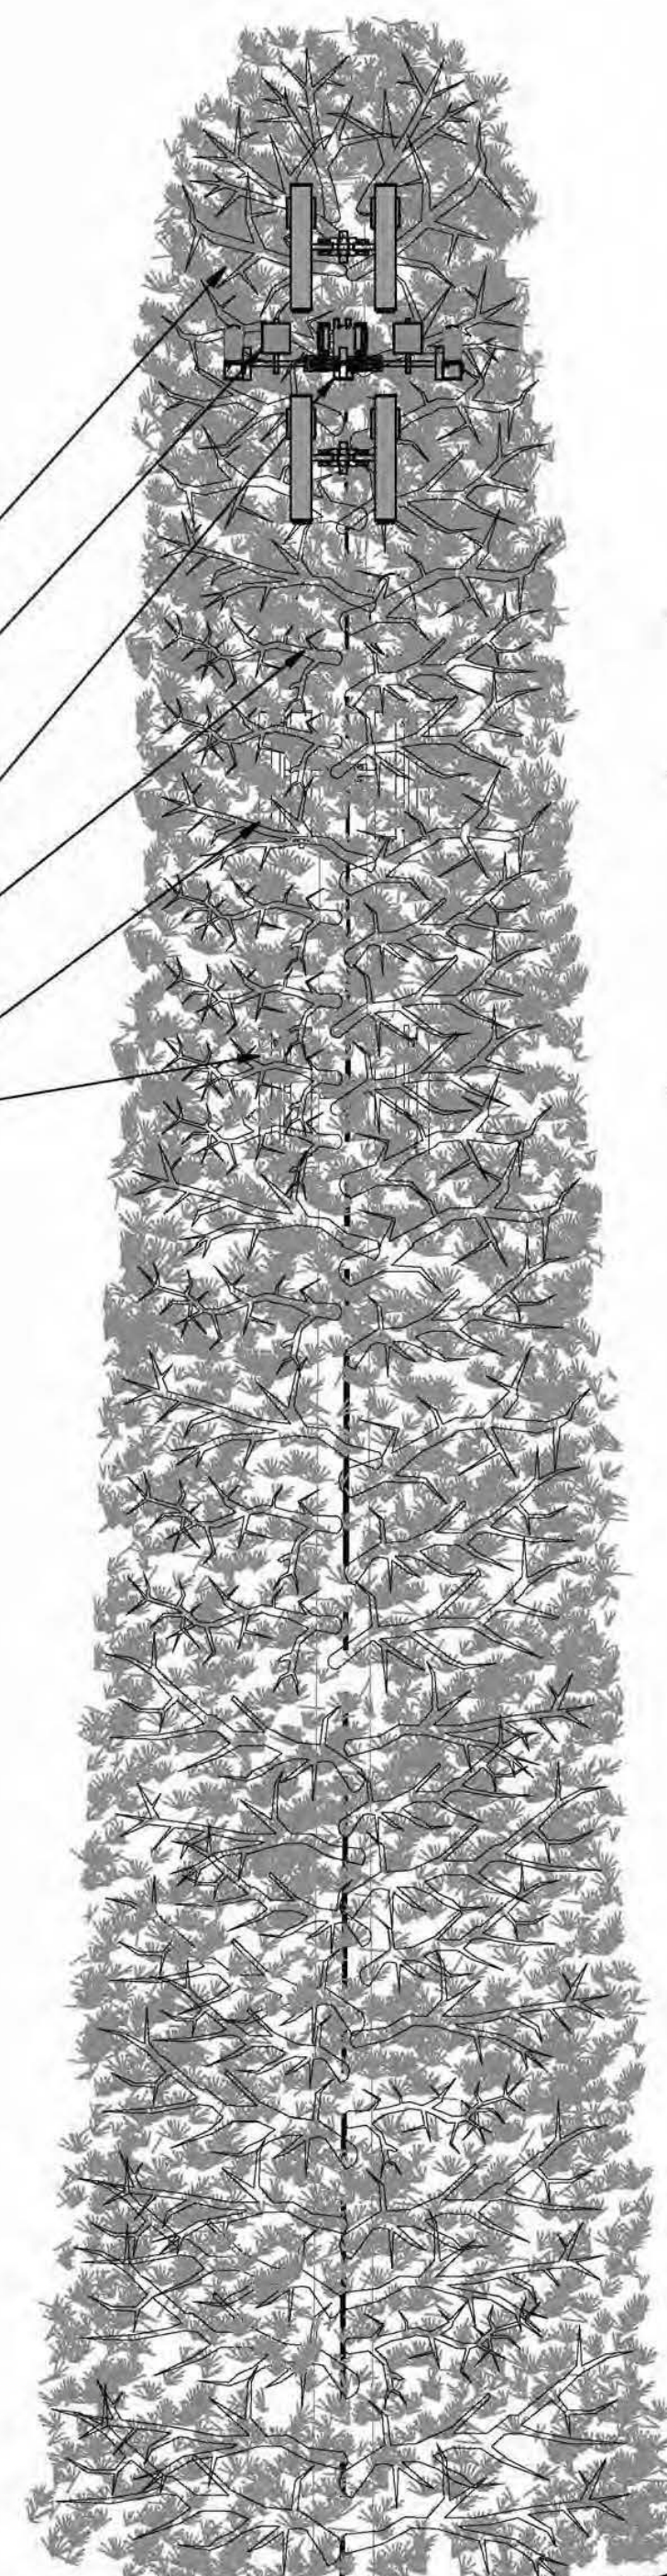

- NEW MONOPINE
- NEW D/C & FIBER TRUNK
- NEW GPS ANTENNA
- NEW PRE-FAB SHELTER
- NEW 6' CHAIN LINK FENCE

WEST ELEVATION

SCALE: 1/8"=1'-0"

2

- TOP OF MONOPINE BRANCHES @ ±140' AGL
- OVERALL HEIGHT OF MONOPINE & TOP OF AT&T ANTENNAS @ ±133' AGL
- AT&T RAD CENTER @ ±130' AGL


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- RAD CENTER OF FUTURE ANTENNAS BY OTHER CARRIER @ ±90' AGL

- START OF MONOPINE BRANCHES @ ±20' AGL

- FINISH GRADE @ 0' AGL



- NEW MONOPINE
- NEW D/C & FIBER TRUNK
- NEW PRE-FAB SHELTER
- NEW GPS ANTENNA
- NEW 6' CHAIN LINK FENCE

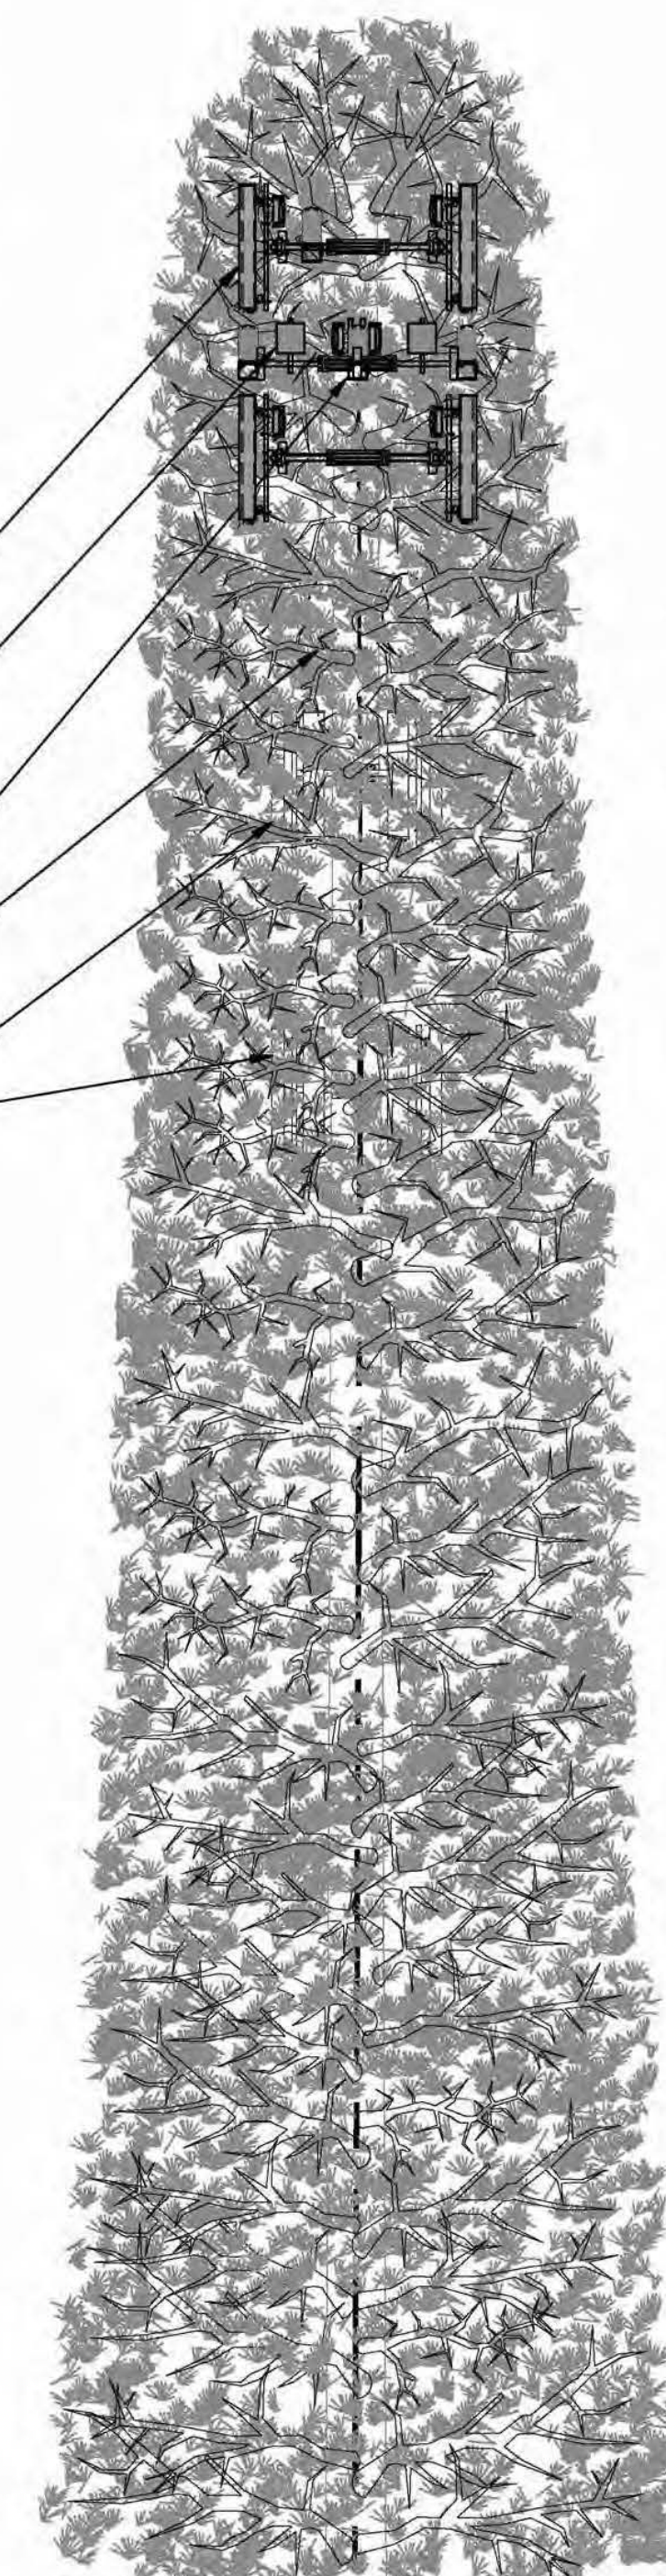NORTH ELEVATION

SCALE: 1/8"=1'-0"

1

NOTE:  
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CLIENT:

2600 CAMINO RAMON  
 SAN RAMON, CA 94583

PROJECT INFORMATION:

**SOAPWEED**  
 4070 STOPE DR  
 PLACERVILLE, CA 95667

REV.	DATE	DESCRIPTION	BY
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2	8-3-17	REV 90% ZONING DOC'S	RB
3	8-21-17	100% ZONING DOC'S	RB


COORDINATING ENGINEER:

*Peek Site-Com*  
 12852 Earhart Ave. Suite 101  
 Auburn, California 95602  
 Phone (530) 885-6160  
 E-Mail info@peeksitcom.com

SEAL:

SITE #:	CHK.:	DRAWN BY:
CVL03411	...	RB

SHEET TITLE: **ELEVATIONS**


SHEET NUMBER:	REVISION:
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**A-4.1 0**





CVL03411 Soapweed  
4070 Stope Drive, Placerville, CA  
Photosims Produced on 7-21-2017

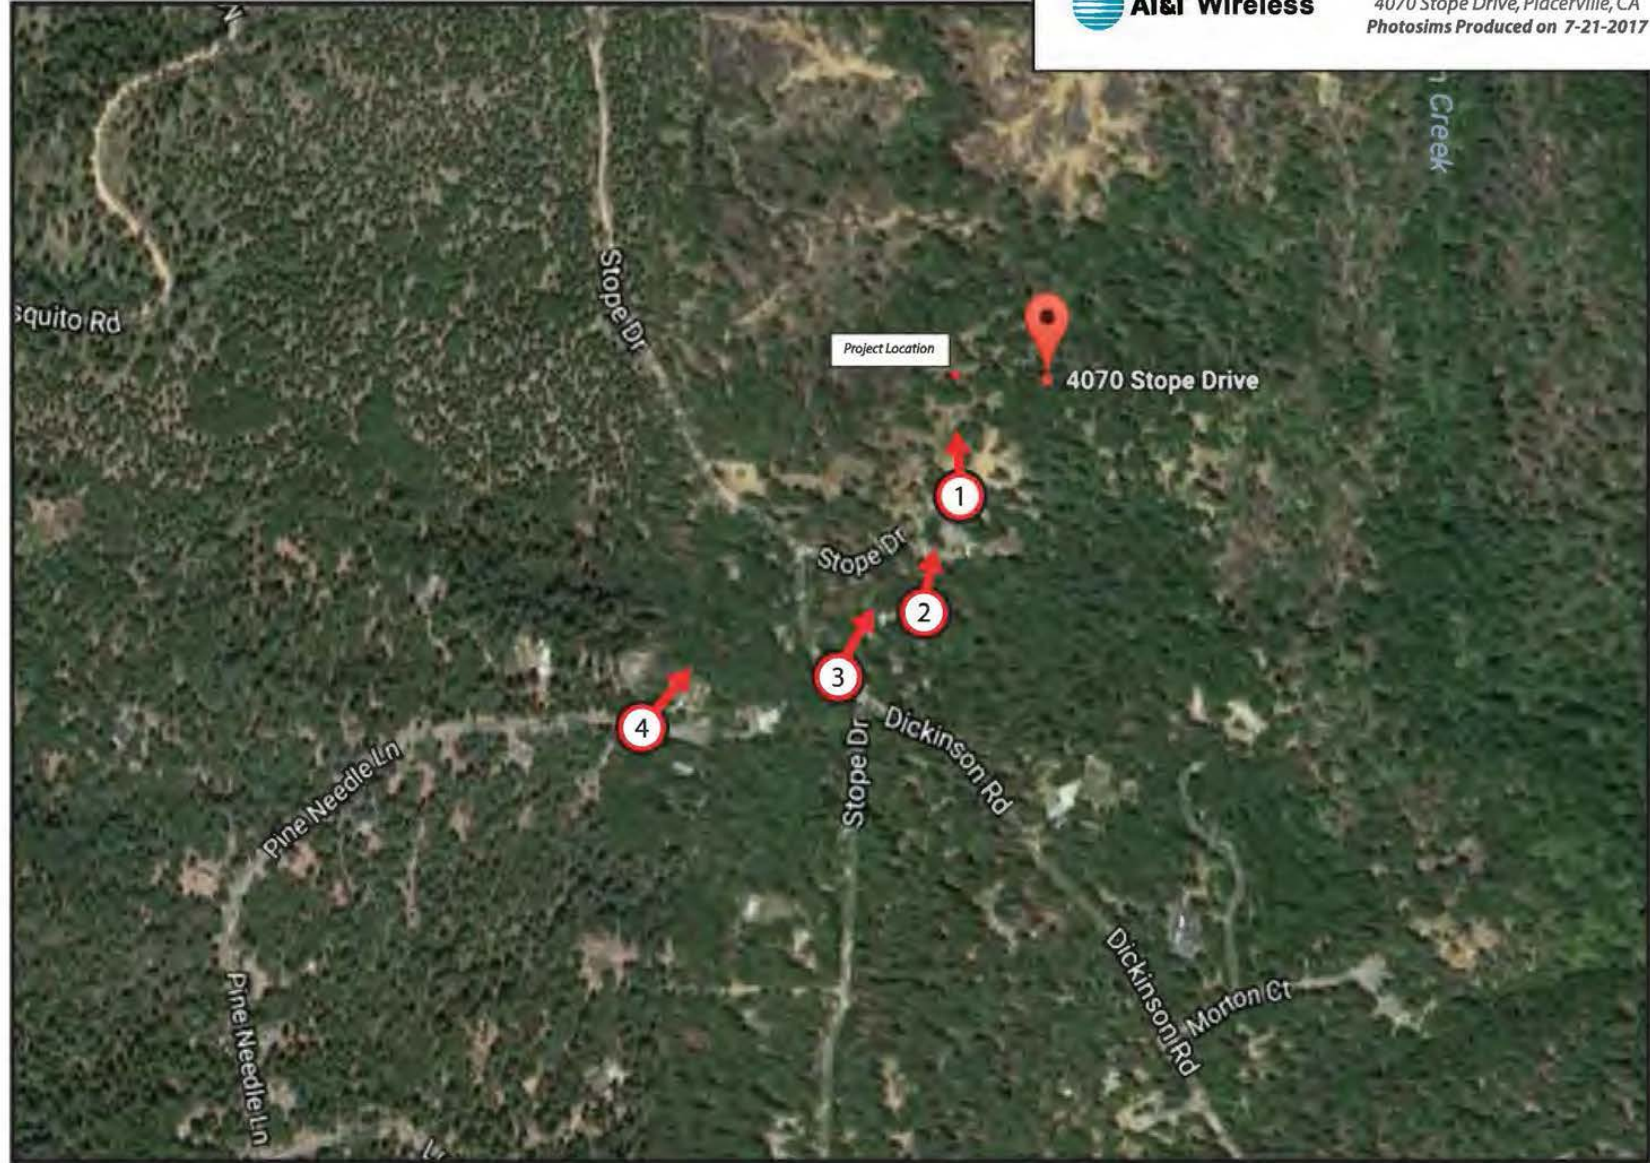

**Exhibit G**  
**Site 4 Soapweed**



Shot Point Map




*Existing*



*Proposed*



*view from property looking north at site*

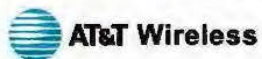

CVL03411 Soapweed  
4070 Stope Drive, Placerville, CA  
Photosims Produced on 7-21-2017





**Existing**




**Proposed**



Proposed AT&T  
Installation

*view from Awesome View looking north at site*

**AdvanceSim**  
Photo Simulation Solutions  
Contact ( 925 ) 202-8507

 **AT&T Wireless**

CVL03411 Soapweed  
4070 Stope Drive, Placerville, CA  
Photosims Produced on 7-21-2017




**Existing**



**Proposed**



*view from Stope Drive looking northeast at site*

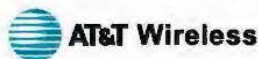

CVL03411 Soapweed  
4070 Stope Drive, Placerville, CA  
Photosims Produced on 7-21-2017





*Existing*



*Proposed*



*view from Pine Needle Lane looking northeast at site*



CVL03411 Soapweed  
4070 Stope Drive, Placerville, CA  
Photosims Produced on 7-21-2017




Contact ( 925 ) 202-8507

# CVL03411 Zoning Propagation Map

June 24, 2017

**Exhibit H**  
**Site 4 Soapweed**

# Existing LTE 700 Coverage (RC = 130')

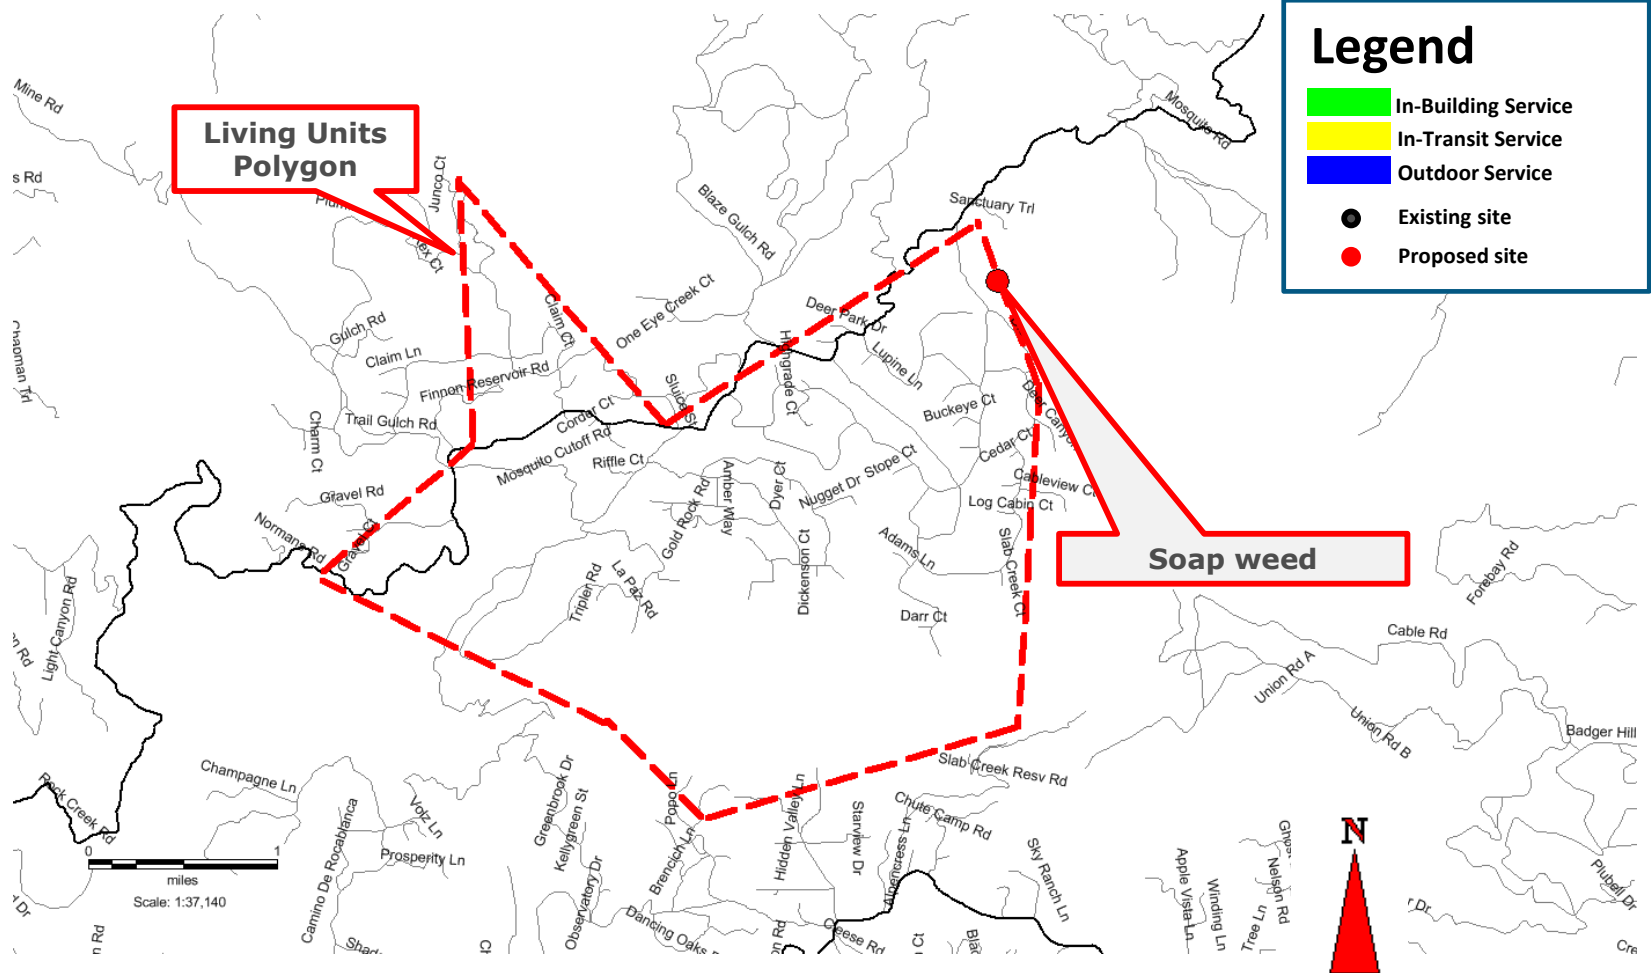


June 24, 2017





# Proposed LTE 700 Coverage (RC = 130')

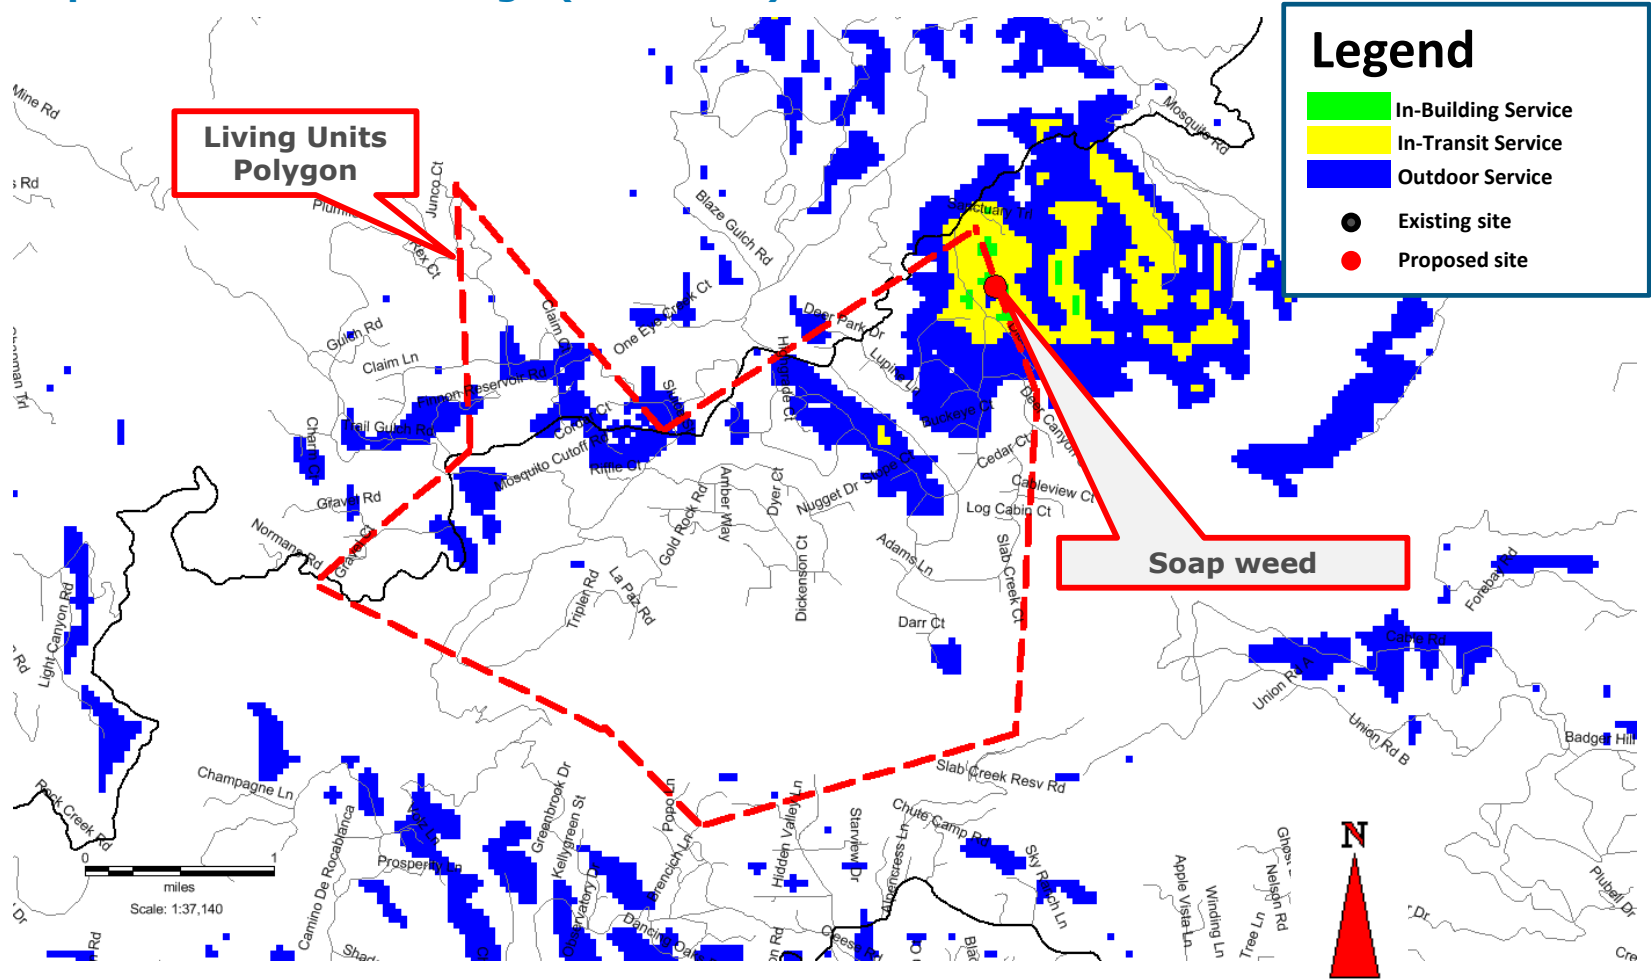

June 24, 2017





## Radio Frequency Emissions Compliance Report For AT&T Mobility

<b>Site Name:</b> Soapweed	<b>Site Structure Type:</b> Monopine
<b>Address:</b> 4070 Stope Drive Placerville, CA	<b>Latitude:</b> 38.80793
<b>Report Date:</b> July 14, 2017	<b>Longitude:</b> -120.697897
	<b>Project:</b> New Build

### General Summary

AT&T Mobility has contracted Waterford Consultants, LLC to conduct a Radio Frequency Electromagnetic Compliance assessment of the proposed Soapweed site located at 4070 Stope Drive, Placerville, CA. This report contains information about the radio telecommunications equipment to be installed at this site and the surrounding environment with regard to RF Hazard compliance. This assessment is based on installation designs and operational parameters provided by AT&T Mobility.

The compliance framework is derived from the Federal Communications Commission (FCC) Rules and Regulations for preventing human exposure in excess of the applicable Maximum Permissible Exposure (“MPE”) limits. At any location at this site, the power density resulting from each transmitter may be expressed as a percentage of the frequency-specific limits and added to determine if 100% of the exposure limit has been exceeded. The FCC Rules define two tiers of permissible exposure differentiated by the situation in which the exposure takes place and/or the status of the individuals who are subject to exposure. General Population / Uncontrolled exposure limits apply to those situations in which persons may not be aware of the presence of electromagnetic energy, where exposure is not employment-related, or where persons cannot exercise control over their exposure. Occupational / Controlled exposure limits apply to situations in which persons are exposed as a consequence of their employment, have been made fully aware of the potential for exposure, and can exercise control over their exposure.

Frequency (MHz)	<i>Limits for General Population/ Uncontrolled Exposure</i>		<i>Limits for Occupational/ Controlled Exposure</i>	
	Power Density (mW/cm <sup>2</sup> )	Averaging Time (minutes)	Power Density (mW/cm <sup>2</sup> )	Averaging Time (minutes)
30-300	0.2	30	1	6
300-1500	f/1500	30	f/300	6
1500-100,000	1.0	30	5.0	6

f=Frequency (MHz)

In situations where the predicted MPE exceeds the General Population threshold in an accessible area as a result of emissions from multiple transmitters, FCC licensees that contribute greater than 5% of the aggregate MPE share responsibility for mitigation.

Based on the computational guidelines set forth in FCC OET Bulletin 65, Waterford Consultants, LLC has developed software to predict the overall Maximum Permissible Exposure possible at any particular location given the spatial orientation and operating parameters of multiple RF sources. These theoretical results represent worst-case predictions as emitters are assumed to be operating at 100% duty cycle.

## Exhibit I Site 4 Soapweed

For any area in excess of 100% General Population MPE, access controls with appropriate RF alerting signage must be put in place and maintained to restrict access to authorized personnel. Signage must be posted to be visible upon approach from any direction to provide notification of potential conditions within these areas. Subject to other site security requirements, occupational personnel should be trained in RF safety and equipped with personal protective equipment (e.g. RF personal monitor) designed for safe work in the vicinity of RF emitters. Controls such as physical barriers to entry imposed by locked doors, hatches and ladders or other access control mechanisms may be supplemented by alarms that alert the individual and notify site management of a breach in access control. Waterford Consultants, LLC recommends that any work activity in these designated areas or in front of any transmitting antennas be coordinated with all wireless tenants.

## Analysis

AT&T Mobility proposes the following installation at this location:

- Install twelve (12) new panel antennas
- Install six (6) new RRUS-11, three (3) RRUS-12, twelve (12) new RRUS-32

The antennas will be mounted on a 140-foot Monopine with centerlines at 130 and 122 feet above ground level. The antennas will be oriented toward 90, 330 and 210 degrees. The Effective Radiated Power (ERP) in any direction from all AT&T Mobility operations will not exceed 25,831 Watts. Other appurtenances such as RRUs and hybrid cable are not sources of RF emissions. From this site, AT&T Mobility will enhance voice and data services to surrounding areas in licensed 700, 850, 1900, 2100 and 2300 MHz bands. No other antennas are known to be operating in the vicinity of this site.

Power density decreases significantly with distance from any antenna. The panel-type antennas to be employed at this site are highly directional by design and the orientation in azimuth and mounting elevation, as documented, serve to reduce the potential to exceed MPE limits at any location other than directly in front of the antennas. For accessible areas at ground level, the maximum predicted power density level resulting from all AT&T Mobility operations is 0.5455% of the FCC General Population limits (0.1091% of the FCC Occupational limits). Incident at adjacent buildings depicted in Figure 1, the maximum predicted power density level resulting from all AT&T Mobility operations is 0.121% of the FCC General Population limits (0.0242% of the FCC Occupational limits). The proposed operation will not expose members of the General Public to hazardous levels of RF energy and will not contribute to existing cumulative MPE levels on walkable surfaces at ground or at adjacent buildings by 5% of the General Population limits.

Waterford Consultants, LLC recommends posting contact information signage at the gate that informs personnel entering the site of basic precautions to be followed when working around antennas. RF alerting signage (Caution) should be posted at the base of the proposed Monopine to inform authorized climbers of potential conditions near the antennas. These recommendations are depicted in Figure 2.

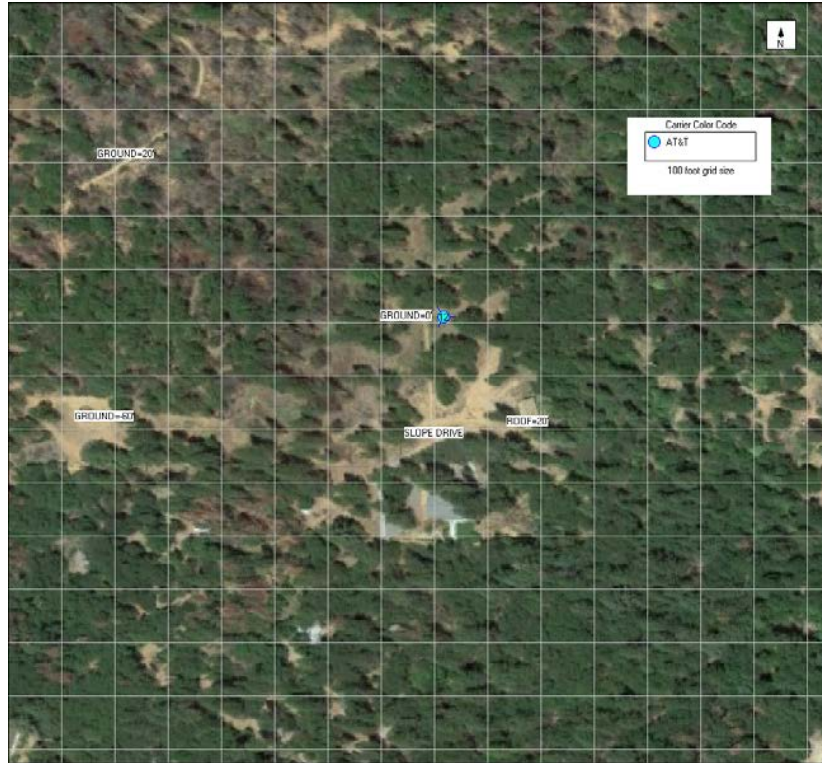


Figure 1: Antenna Locations

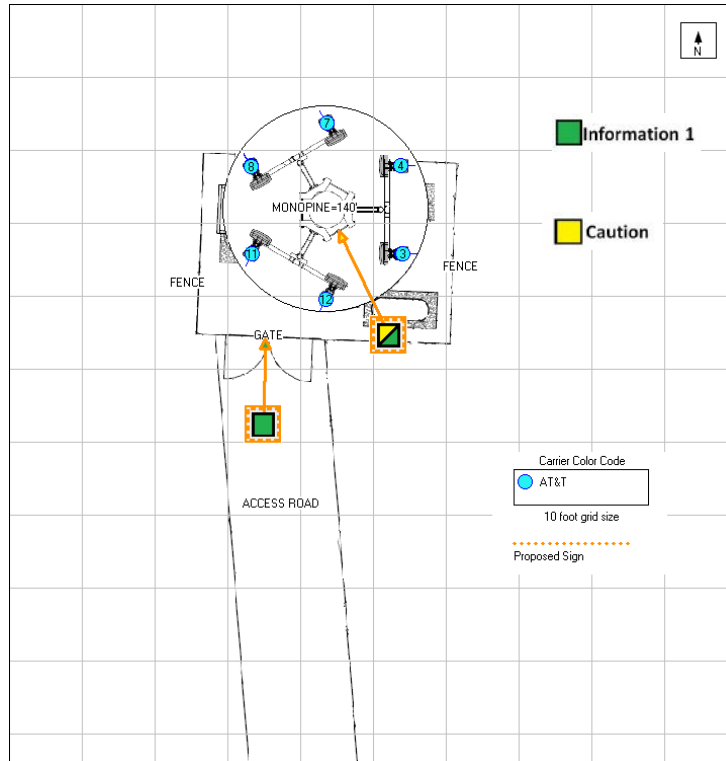


Figure 2: Mitigation Recommendations

**Compliance Statement**

Based on information provided by AT&T Mobility and predictive modeling, the installation proposed by AT&T Mobility at 4070 Stope Drive, Placerville, CA will be compliant with Radiofrequency Radiation Exposure Limits of 47 C.F.R. § 1.1307(b)(3) and 1.1310. RF alerting signage and restricting access to the Monopine to authorized climbers that have completed RF safety training is required for Occupational environment compliance.

**Certification**

I, David H. Kiser, am the reviewer and approver of this report and am fully aware of and familiar with the Rules and Regulations of both the Federal Communications Commissions (FCC) and the Occupational Safety and Health Administration (OSHA) with regard to Human Exposure to Radio Frequency Radiation, specifically in accordance with FCC's OET Bulletin 65. I have reviewed this Radio Frequency Exposure Assessment report and believe it to be both true and accurate to the best of my knowledge.

