INDEX OF SHEETS

SHEET	PLAN SHEET	TITLE	
1		TITLE SHEET	
2	CD-1	SURVEY CONTROL DIAGRAM	
3	X-1	TYPICAL SECTIONS	
4	L-1	LAYOUT PLAN & PROFILE	
5	D-1	DRAINAGE LAYOUT SYSTEMS 1 & 2	
6	D-2	DRAINAGE PROFILE SYSTEMS 1 & 2	
7	D-3	DRAINAGE DETAILS & QUANTITIES	
8	SC-1	STAGE 1 CONSTRUCTION	
9	SC-2	STAGE 2 CONSTRUCTION	
10	SC-3	STAGE 3 CONSTRUCTION	
11	R-1	RETAINING WALL PLAN & PROFILE	
12	R-2	RETAINING WALL NOTES & DETAILS	
13	R-3	RETAINING WALL NOTES & DETAILS	

DEPARTMENT OF TRANSPORTATION COUNTY OF EL DORADO, CA


PROJECT PLANS FOR THE CONSTRUCTION OF


WHITE MEADOWS ROAD SLIPOUT REPAIR

IN THE COUNTY OF EL DORADO, DISTRICT 4 APPROX. 1.25 MILES NORTHWEST OF THE U.S. HWY 50 AND ICE HOUSE ROAD INTERSECTION


To be supplemented with Standard Plans and Specifications dated May 2006, of the California Department of Transportation

The Contractor's license Classification: In accordance with the provisions of California Public Contract Code 3300, the Owner has determined that the contractor shall possess a valid Class A General Engineering Contractor license, or a combination of classes required by the catagories and type of work included in the contract, at the

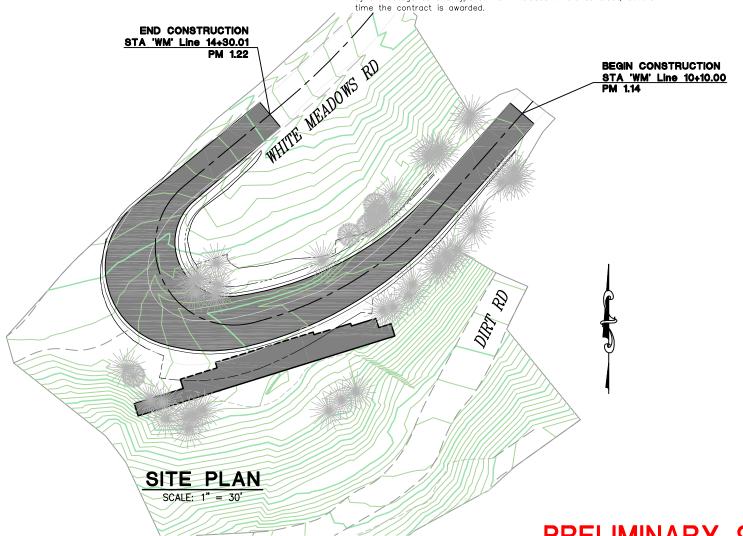

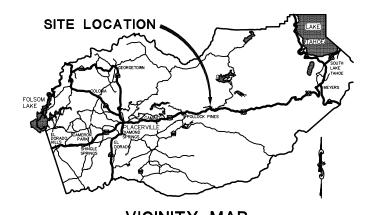

VICINITY MAP COUNTY OF EL DORADO

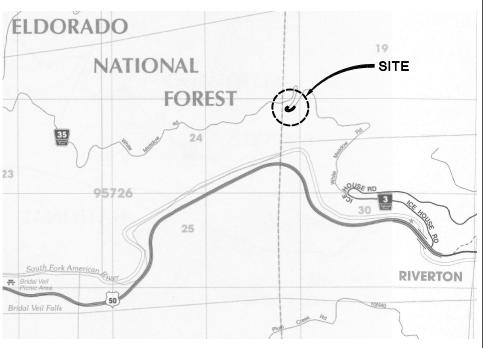

LOCATION MAP NOT TO SCALE

PRELIMINARY 90% 08/01/07

SUBMITTED BY: STEVEN K. PAYNE CIVIL ENGINEER STATE OF CALIFORNIA NO. 16686

CONTRACT NO. 78669

DATE HELEN K. BAUMANN CHAIRMAN, EL DORADO COUNTY BOARD OF SUPERVISORS RICHARD W. SHEPARD, P.E. NO. 35439
DIRECTOR, EL DORADO COUNTY DEPARTMENT OF TRANSPORTATION DATE DATE ELIZABETH B. DIAMOND, P.E. NO. 34339 DEPUTY DIRECTOR, EL DORADO COUNTY DEPARTMENT OF TRANSPORTATION

COUNTY OF EL DORADO DEPARTMENT OF TRANSPORTATION

2850 FAIRLANE COURT PLACERVILLE, CA 95667 (916) 621-5900



ı				REVISIONS	E
I					
II					
1	MARK	DATE	BY		\subseteq

DEVIOLANO

DAND OF CUREDVICOR

CADD BY: A. BISHOP

BOARD OF SUPERVISORS	
RUSTY DUPRAY I	
HELEN BAUMANN II	
JACK SWEENEY III	
RON BRIGGS IV	
NORMA SANTIAGO V	

WHITE MEADOWS ROAD SLIPOUT REPAIR TITLE SHEET


SHEET 1 OF



NOTE:

BEARINGS, DISTANCES, STATIONING AND COORDINATES SHOWN ARE ON THE CALIFORNIA STATE COORDINATE SYSTEM, NAD 83 ZONE 2. DISTANCES SHOWN ARE GRID DISTANCES. DIVIDE DISTANCES


SHOWN BY 0.999762 TO OBTAIN GROUND DISTANCES.

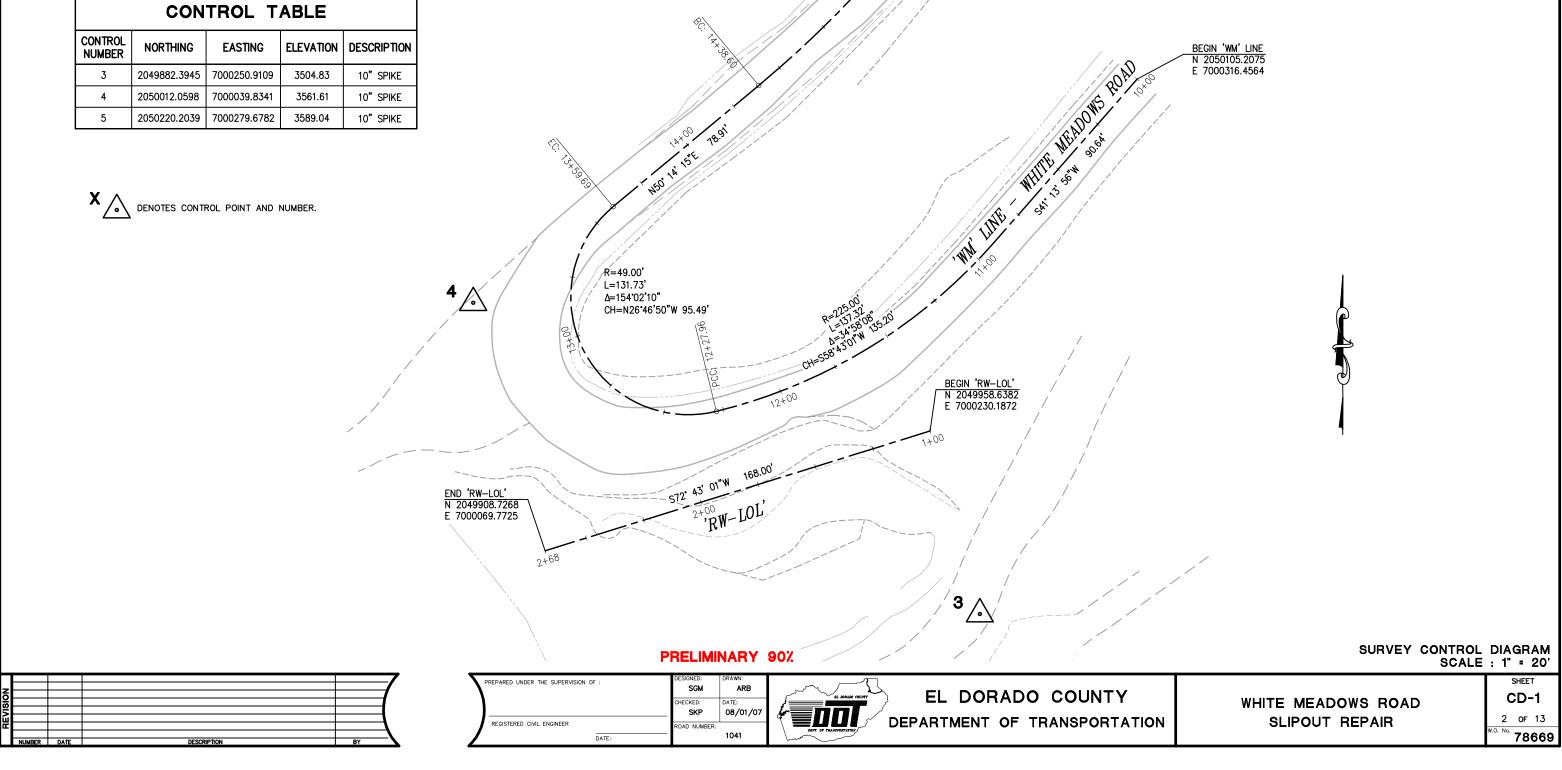



R=450.00' L=111.41' Δ=14'11'07"

CH=N43°08'41"E 111.13'


END 'WM' LINE N 2050203.8476 E 7000249.5044

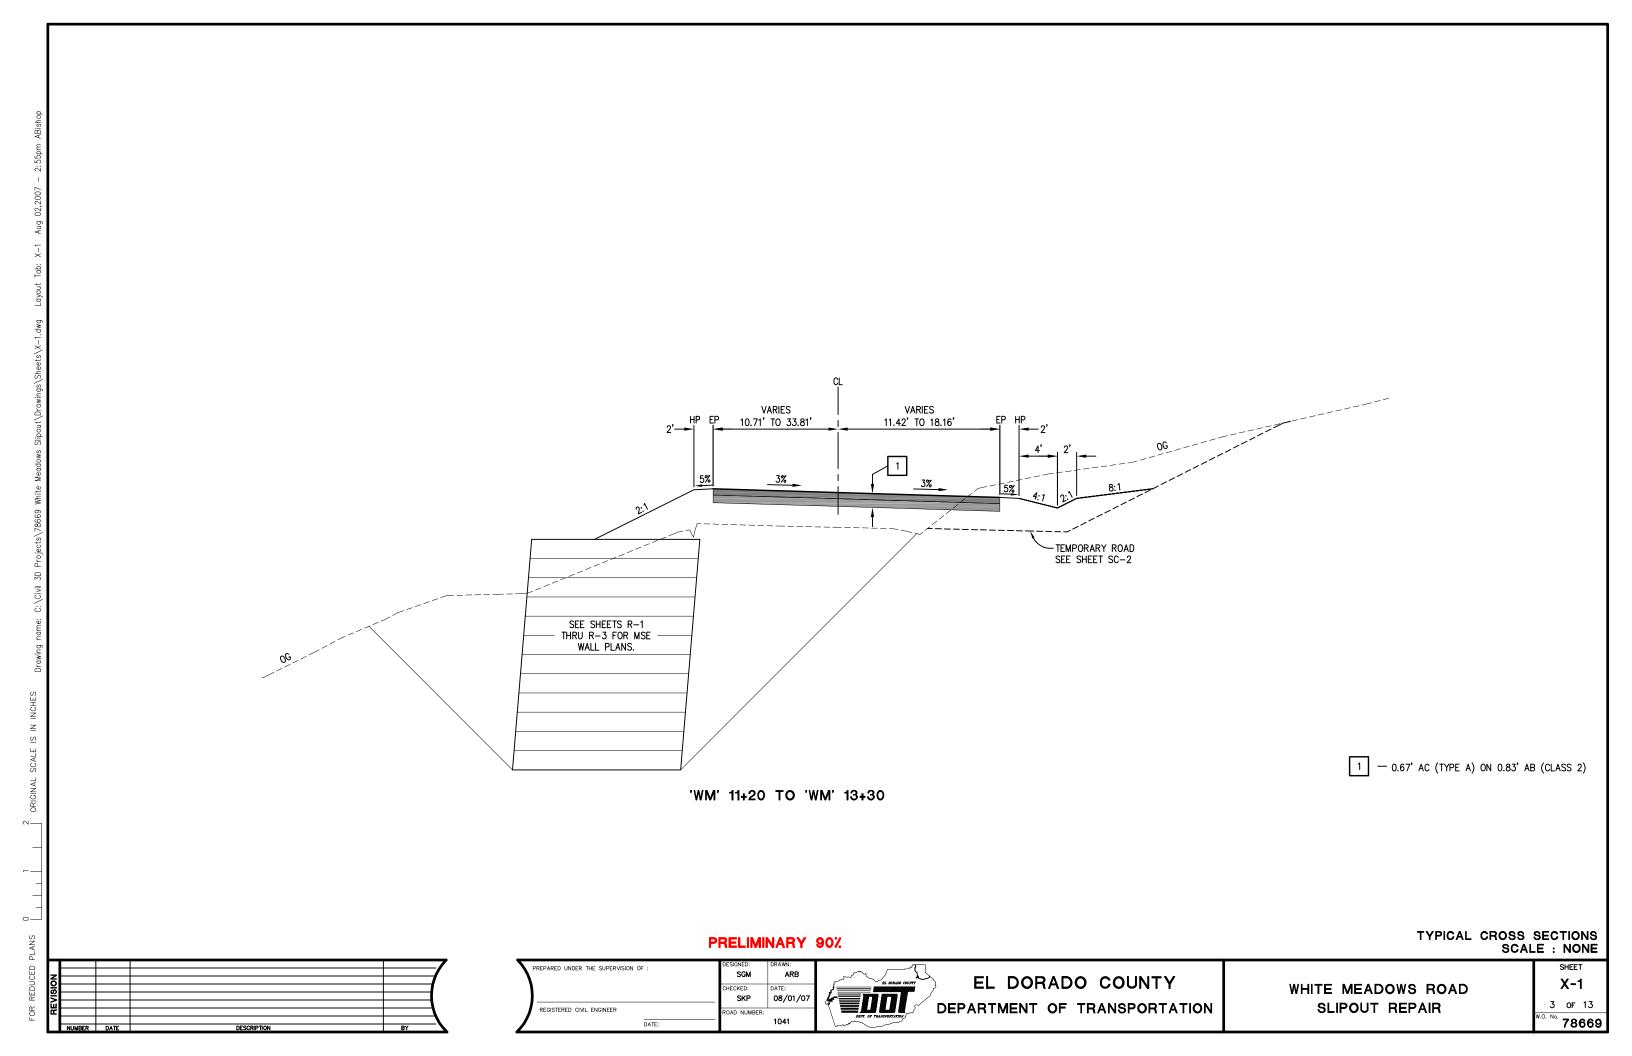

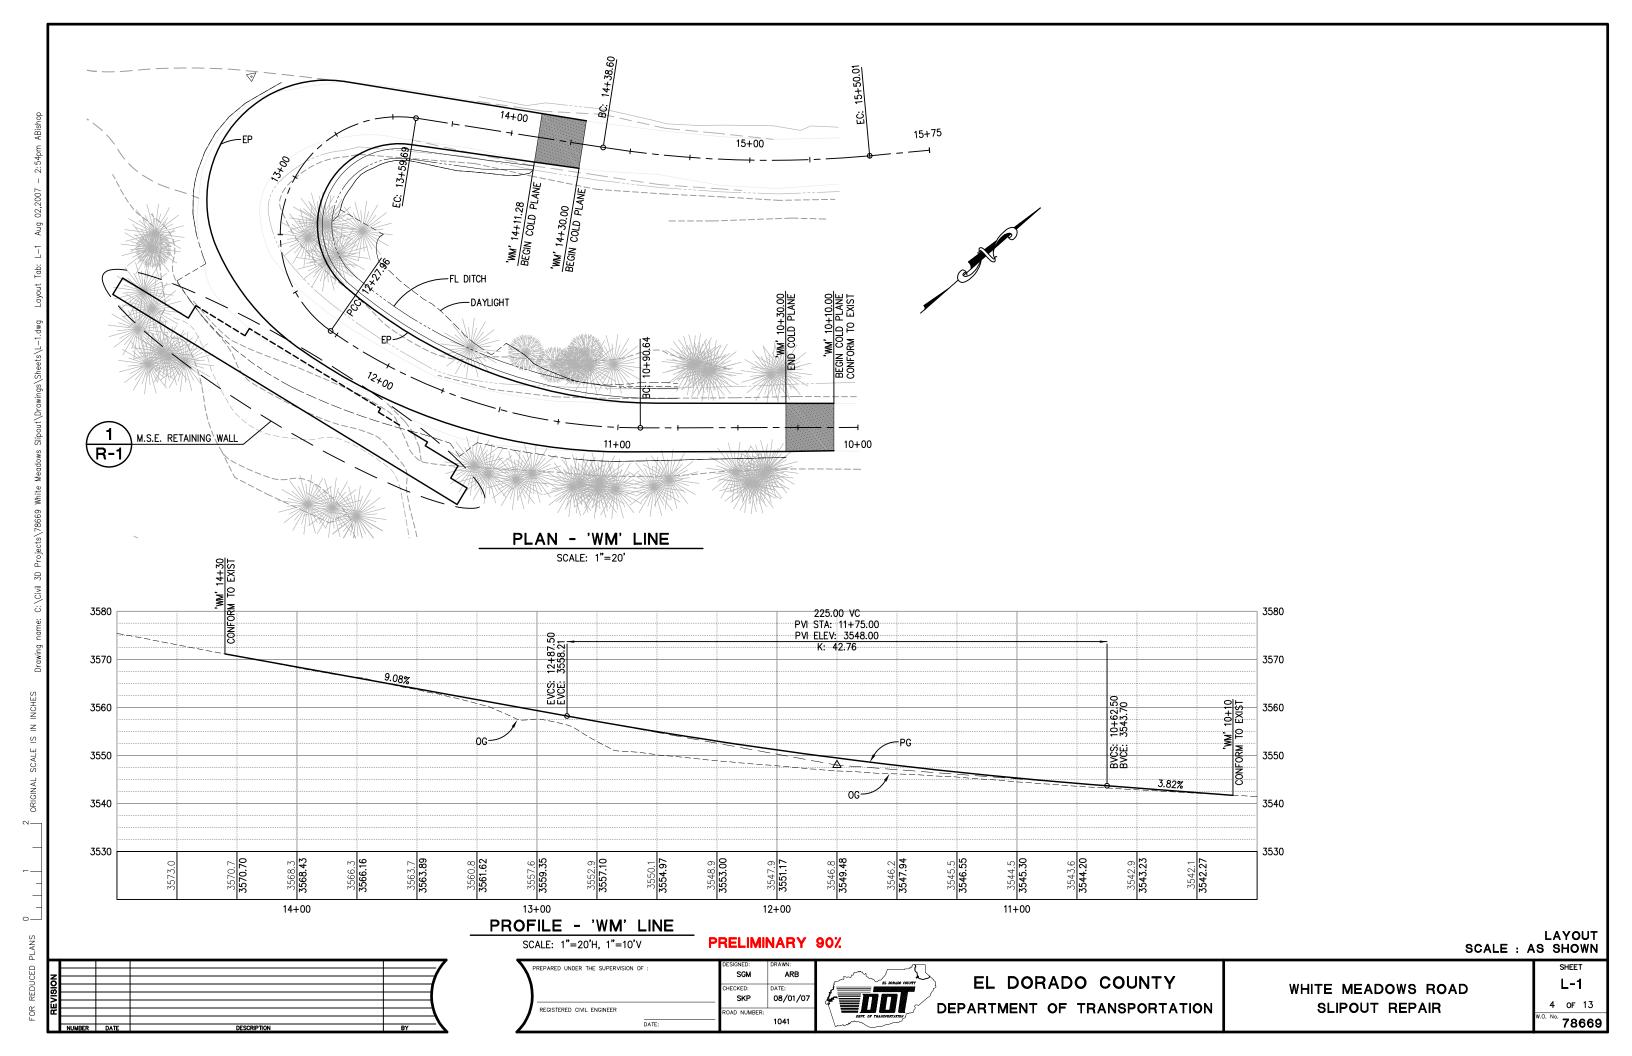

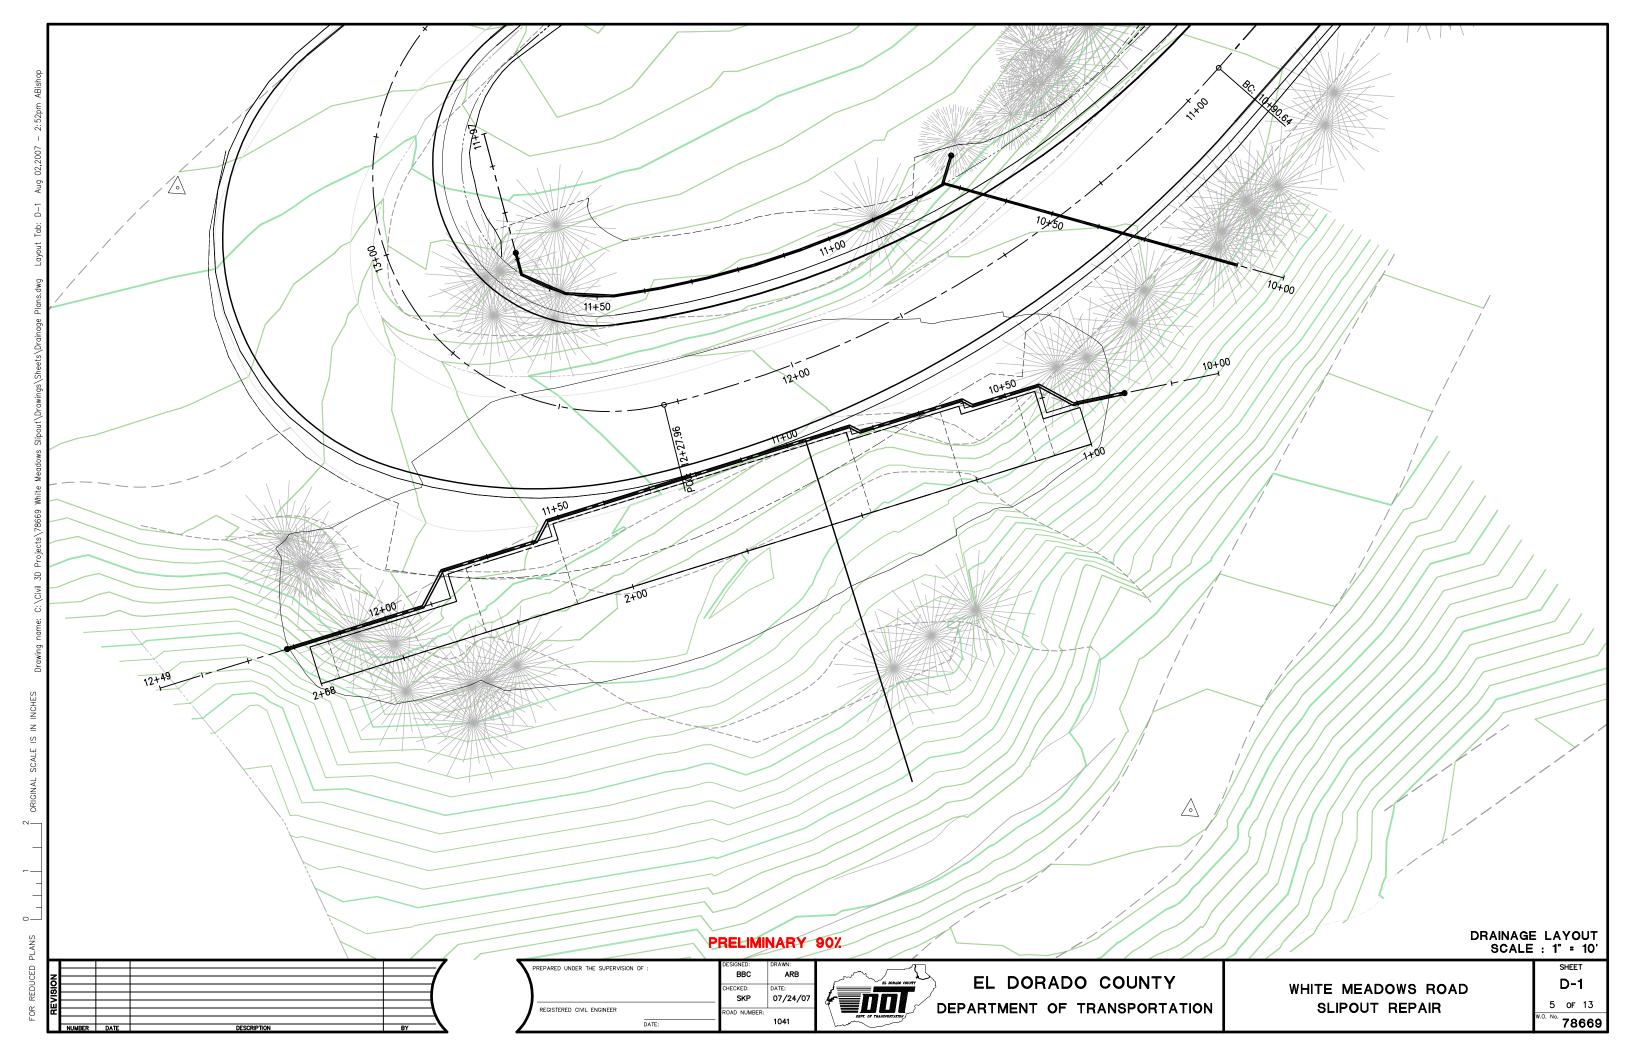




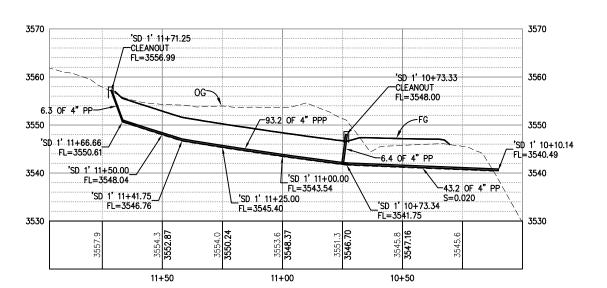

'SD 1' SUBDRAIN PROFILE

SCALE: 1"=20'H, 1"=10'V

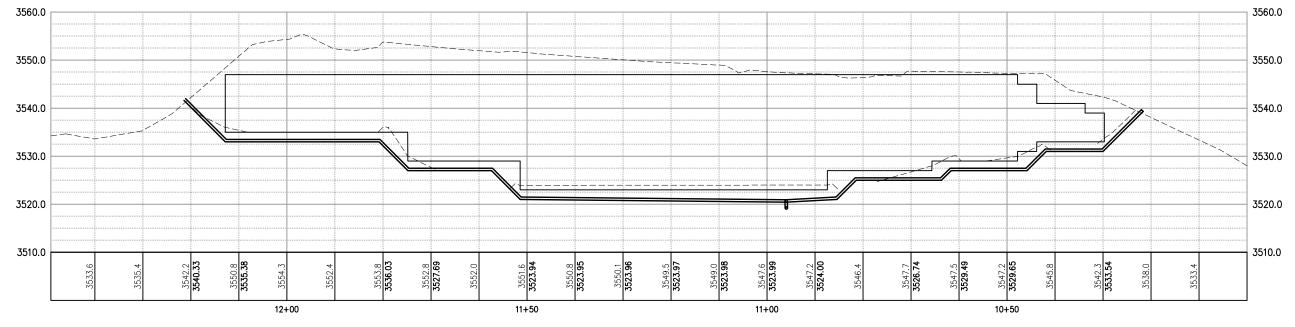

'SD 2' MSE Wall Drain PROFILE

SCALE: 1"=10'H, 1"=10'V

PRELIMINARY 90%


PREPARED UNDER THE SUPERVISION OF ARB EL DORADO COUNTY HECKED: 07/24/07 SKP DEPARTMENT OF TRANSPORTATION REGISTERED CIVIL ENGINEER OAD NUMBER:


WHITE MEADOWS ROAD SLIPOUT REPAIR

SHEET D-2 6 or 13 78669


M.S.E. RETAINING WALL

SCALE : AS SHOWN

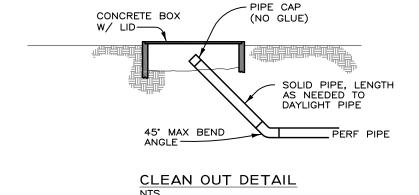

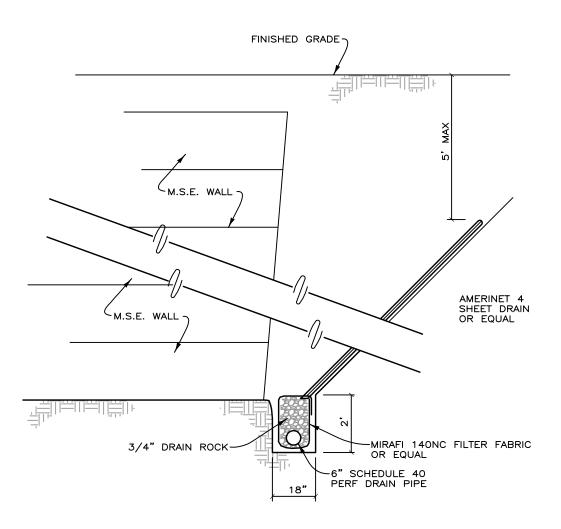

WALL DRAIN DETAIL

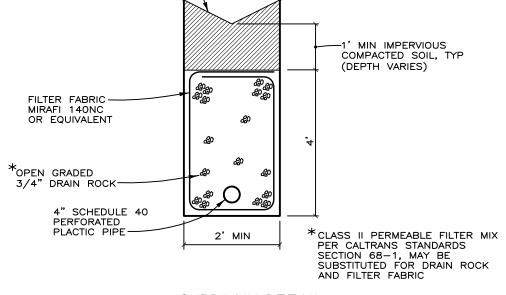

ROADSIDE DITCH-SEE L-1

SUBDRAIN DETAIL


PRELIMINARY 90%


REPARED UNDER THE SUPERVISION OF BBC ARB HECKED: SKP 07/24/07 REGISTERED CIVIL ENGINEER OAD NUMBER

EL DORADO COUNTY DEPARTMENT OF TRANSPORTATION M.S.E. RETAINING WALL SCALE : AS SHOWN SHEET

WHITE MEADOWS ROAD SLIPOUT REPAIR


D-3 7 of 13 78669

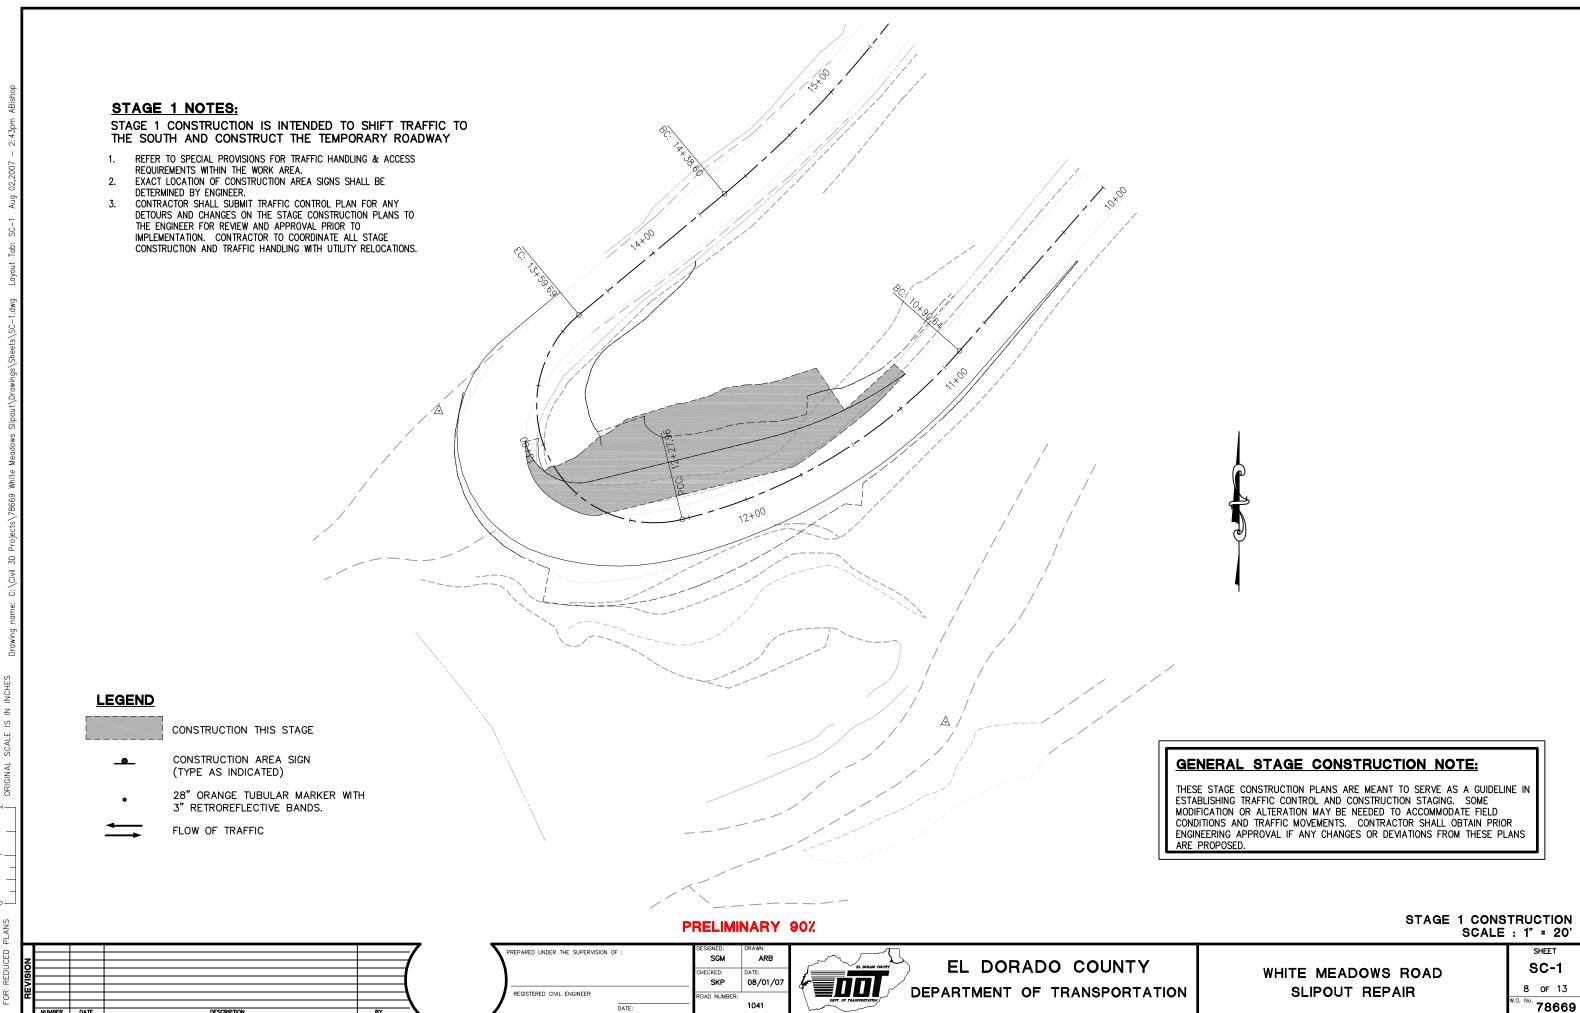

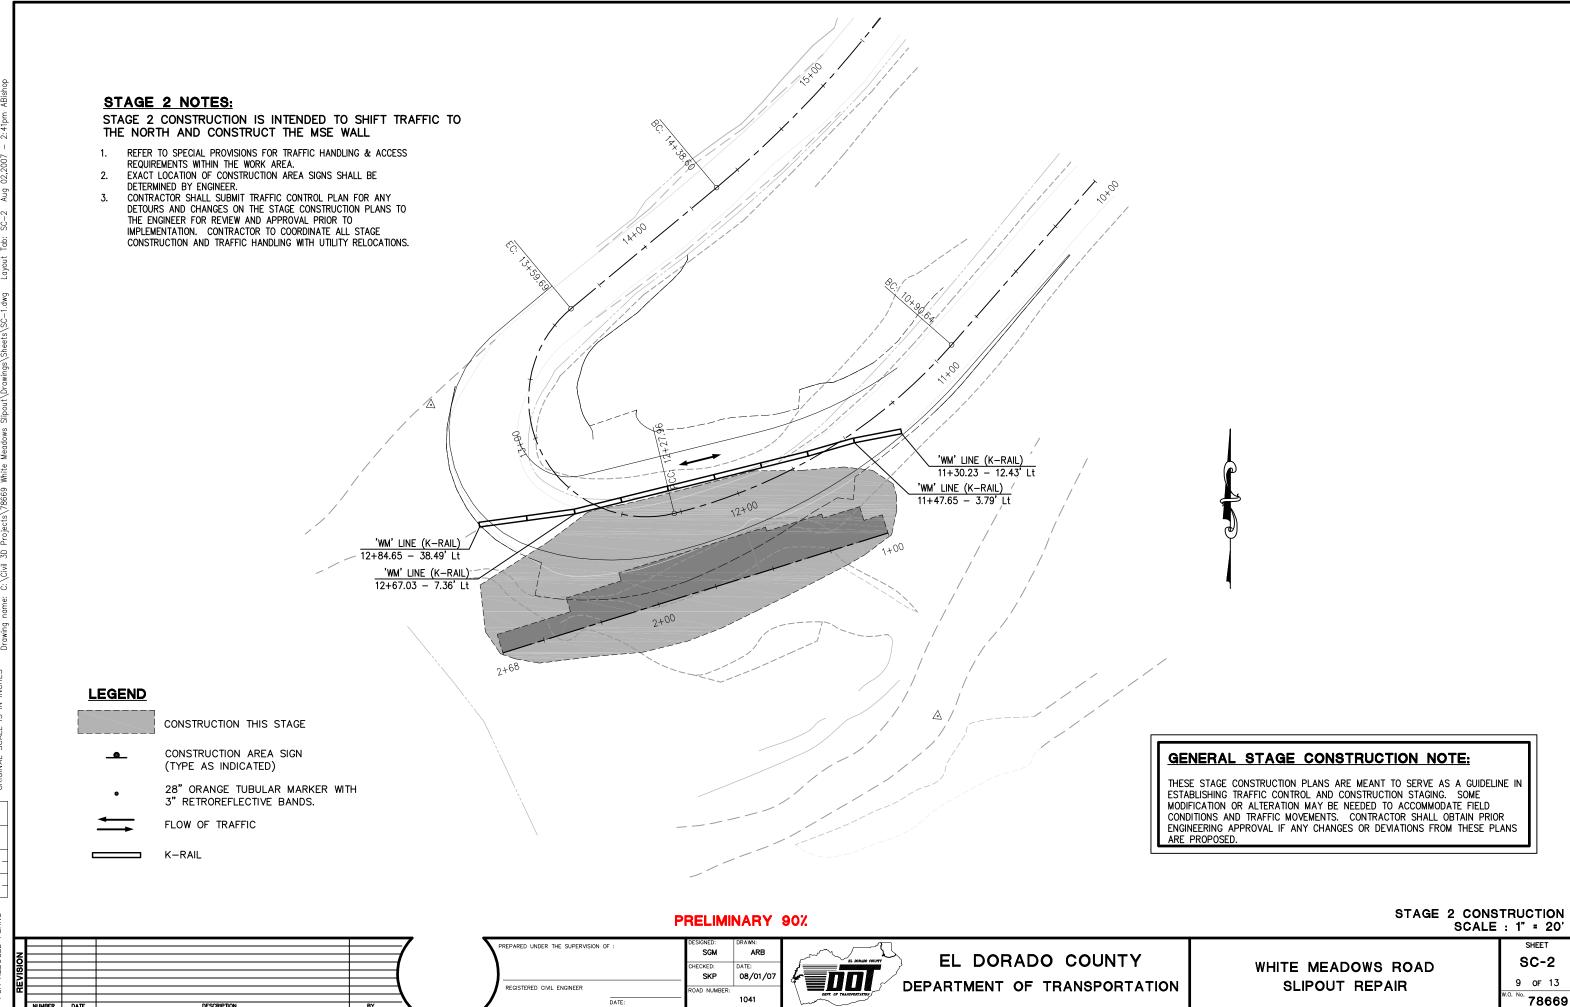


C


FOR REDUCED PLANS

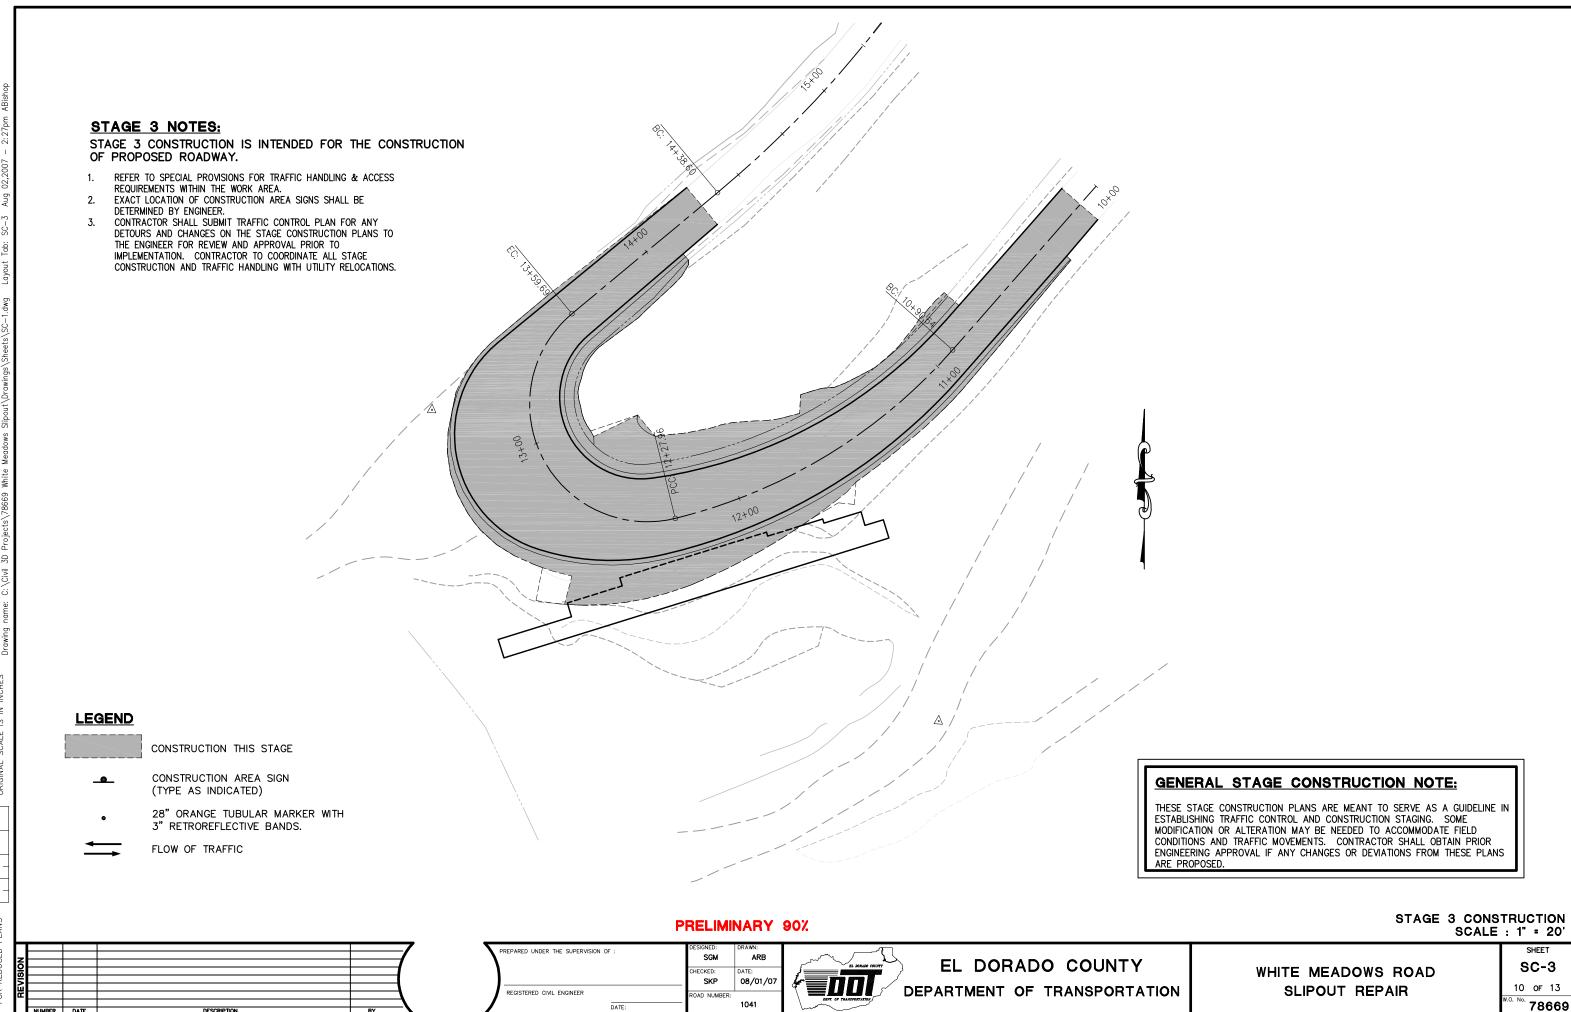


SINA IO CEDITICED BLANK

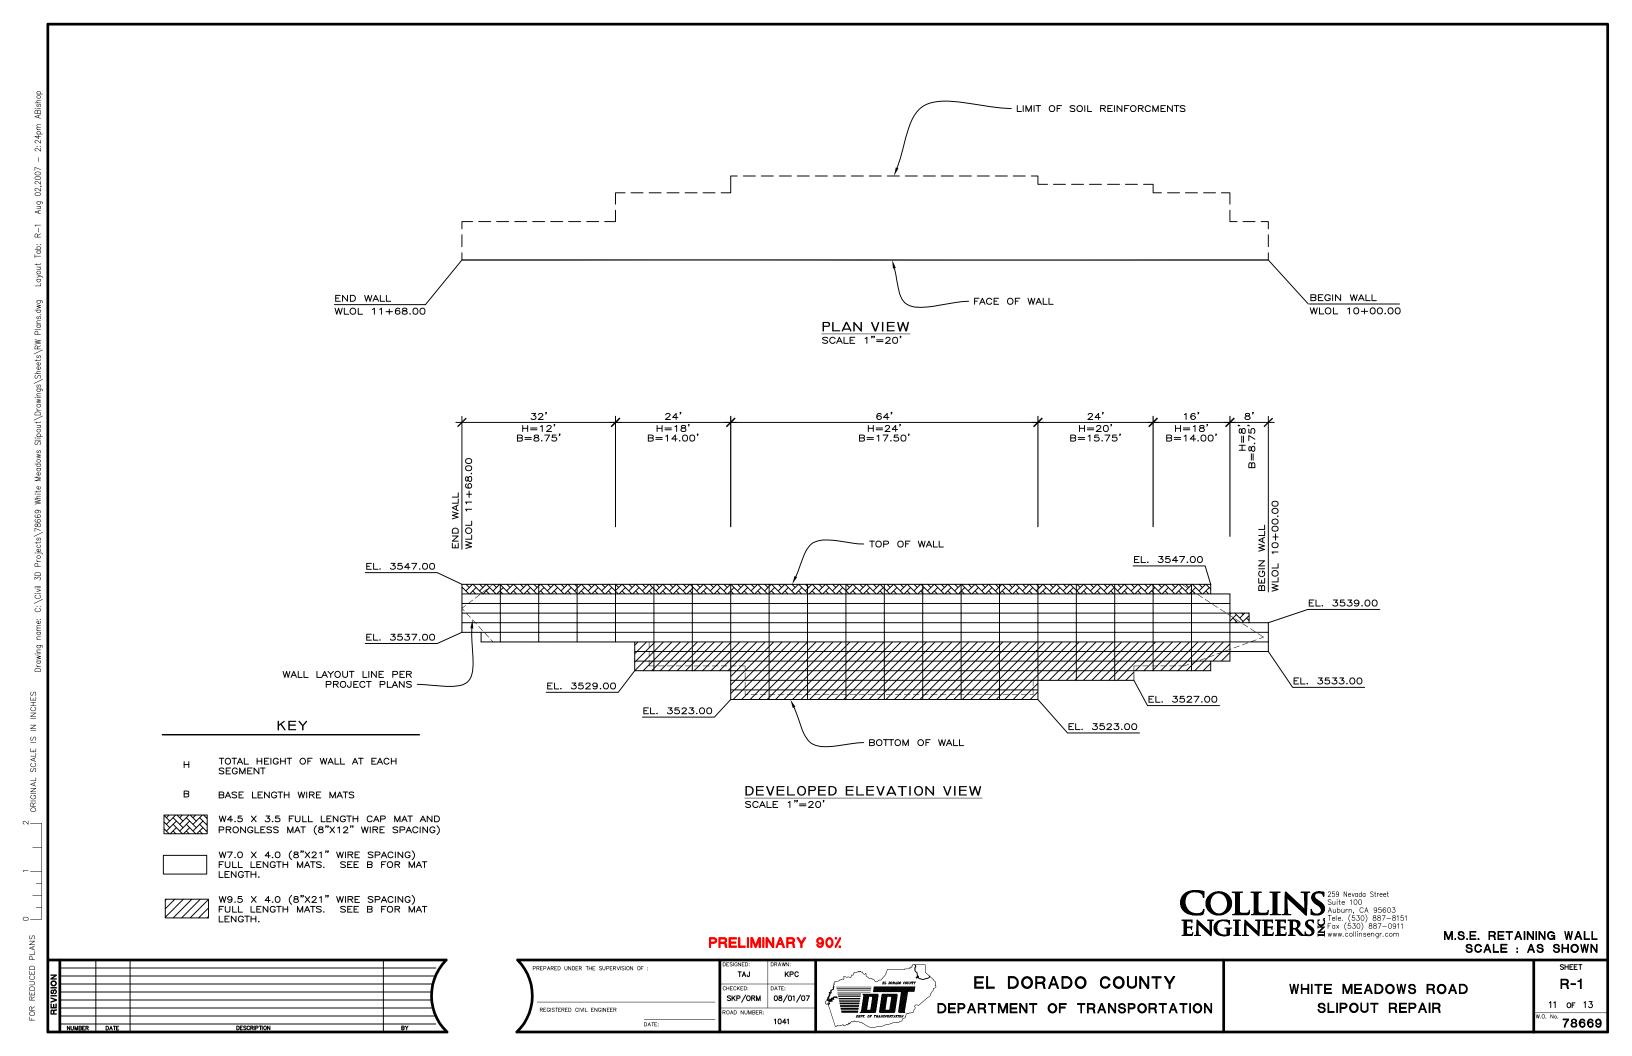



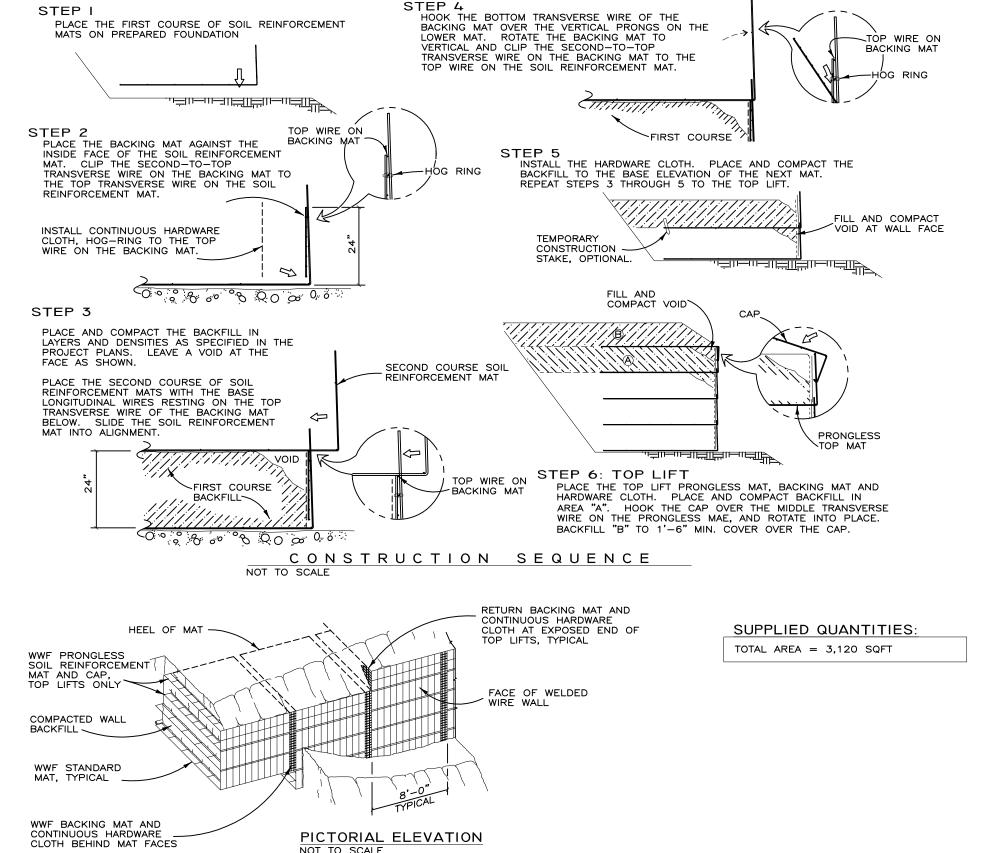

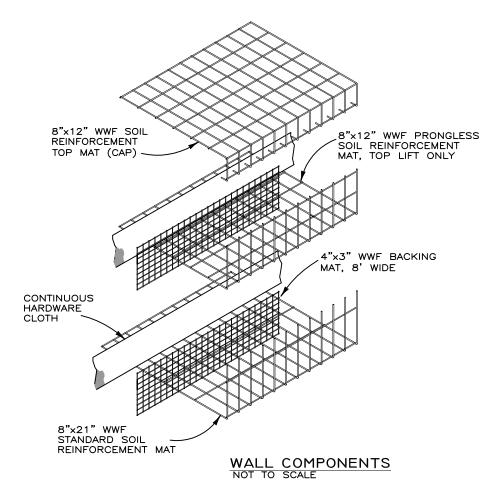

PROJECT-SPECIFIC NOTES:

- 1. REFERENCE DRAWINGS: BLACKBURN CONSTRUCTION DRAWINGS DATED JUNE 14TH, 2007, RECEIVED IN PDF FORMAT.
- 2. IT IS ASSUMED THAT ALL MATERIALS, BACKFILL AND CONSTRUCTION METHODS FOR HILFIKER M.S.E. WALLS WILL CONFORM TO HILFIKER'S SPECIFICATIONS AND/OR THOSE OF THE HILFIKER ENGINEERING CONSULTANT.
- 3. THIS IS NOT AN ENGINEERED SUBMITTAL. ALL INFORMATION HEREON IS DERIVED FROM THE REFERENCE DRAWINGS, AND IS SUBJECT TO GEOMETRIC AND GEOTECHNICAL CONFIRMATION. THE APPLICABLE HILFIKER CONSTRUCTION GUIDE AND SPECIFICATIONS ARE AN INTEGRAL PART OF THIS SUBMITTAL
- 4. UPON ENGINEERED DESIGN, HILFIKER RETAINING WALLS SHALL NOT BE RESPONSIBLE FOR THE GLOBAL STABILITY OR FOUNDATION BEARING CAPACITY. THE OWNER/CONTRACTOR SHALL BE RESPONSIBLE FOR ALL JOB SITE DRAINAGE, SAFETY AND FALL PROTECTION PROVISIONS FOR WORKERS IN COMPLIANCE WITH OSHA AND ANY OTHER APPLICABLE REQUIREMENTS.



M.S.E. RETAINING WALL SCALE : AS SHOWN

REPARED UNDER THE SUPERVISION O TAJ SKP/ORM REGISTERED CIVIL ENGINEER



PRELIMINARY 90%


EL DORADO COUNTY DEPARTMENT OF TRANSPORTATION

WHITE MEADOWS ROAD SLIPOUT REPAIR


SHEET R-2 12 OF 13

78669

KPC 08/01/0

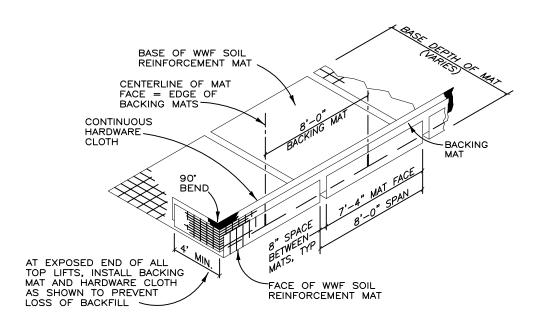


ISOMETRIC VIEW WELDED WIRE WALL COMPONENTS WITH RETURN MAT NOT TO SCALE

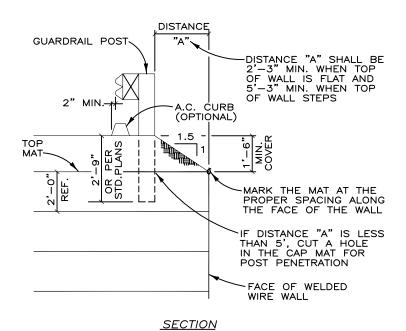


GUARDRAIL DETAIL

NOT TO SCALE (FENCE DETAIL SIMILAR)

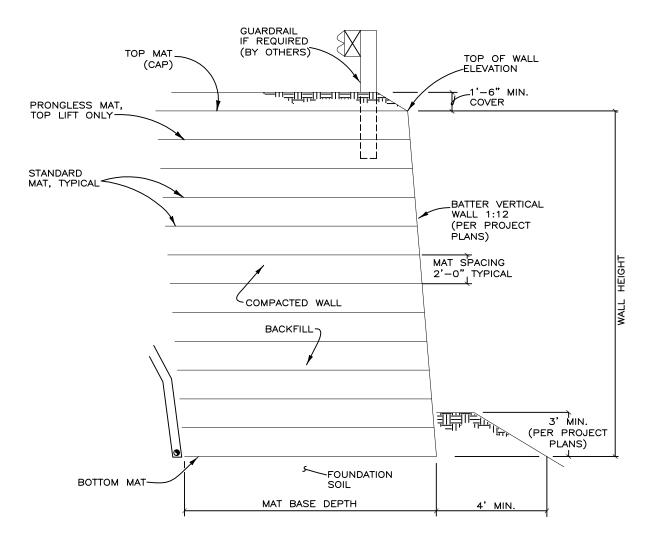

TYPICAL SECTION 3"=20

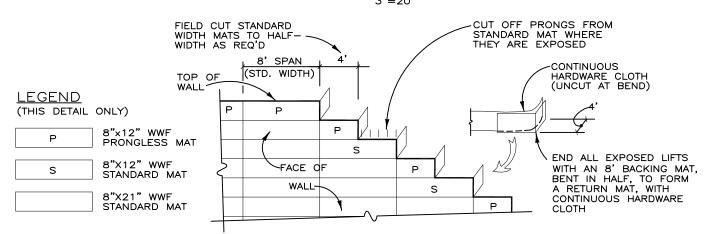

RETURN MATS AND TOP OF WALL DETAIL NOT TO SCALE

COLLINS 259 Nevada Street Suite 100 Auburn, CA 95603 Tele. (530) 887–8151 Fox (530) 887–0911 www.collinsengr.com

M.S.E. RETAINING WALL SCALE : AS SHOWN

PRELIMINARY 90%

\	PREPARED UNDER THE SUPERVISION OF :	DESIGNED: TAJ	DRAWN: KPC
)		CHECKED: SKP/ORM	DATE: 08/01/07
	REGISTERED CIVIL ENGINEER DATE:	ROAD NUMBER:	1041



EL DORADO COUNTY DEPARTMENT OF TRANSPORTATION

WHITE MEADOWS ROAD SLIPOUT REPAIR

R-3 13 of 13 78669

SHEET