


Item # 37

L. Kayne #37 BOS 5/12/11

1.13 miles
2.63 miles

3 min without tra
26 min walk me
7 min 3 min + 4 min
22 min + 43 min
walk

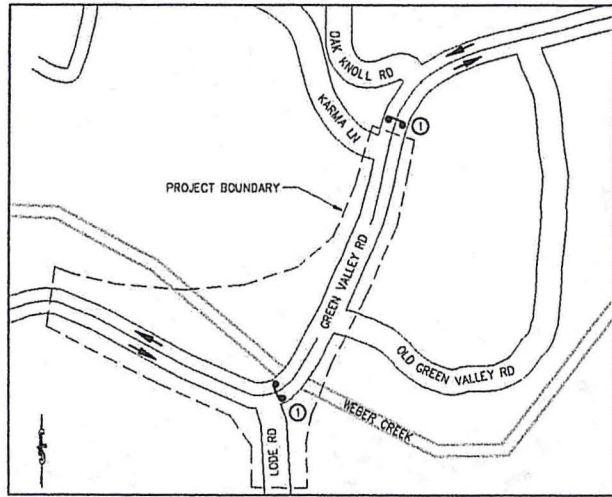

DETAIL "A"
NTS


PCMS No.	FIRST FLASH	SECOND FLASH	THIRD FLASH
⬠ A	WEBER CREEK BRIDGE CLOSED	(DATES CLOSED)	USE ALTERNATE ROUTE
①	WEBER CREEK BRIDGE CLOSED	USE MISSOURI FLAT RD	TO US 50
②	WEBER CREEK BRIDGE CLOSED	USE PLACERVILLE DR	TO US 50
③ ④	WEBER CREEK BRIDGE CLOSED	LOCAL TRAFFIC ONLY	--

LEGEND

- ➔ DIRECTION OF TRAVEL
- ⬠ PCMS - PORTABLE CHANGABLE MESSAGE SIGN
- ⬠ A ADVANCED PLACEMENT PCMS - TO BE POSTED SEVEN (7) DAYS PRIOR TO CLOSURE PERIOD
- ⬠ # PCMS No. (POSTED DURING CLOSURE PERIOD)
- ⚡ TYPE II BARRICADE w/ FLASHING BEACON
- ⚡ TEMPORARY SIGN

ADVANCED WARNING SIGNS TO BE PLACED PER CALIFORNIA MANUAL ON TRAFFIC CONTROL DEVICES. EXACT LOCATION OF SIGNS, BARRICADES AND RAILING TO BE DETERMINED BY THE ENGINEER.

- SIGN LEGEND
- ① R11-2 "ROAD CLOSED"
 - ② M4-10 "DETOUR" (ARROW)
 - ③ "ROAD CLOSED LOCAL TRAFFIC ONLY"

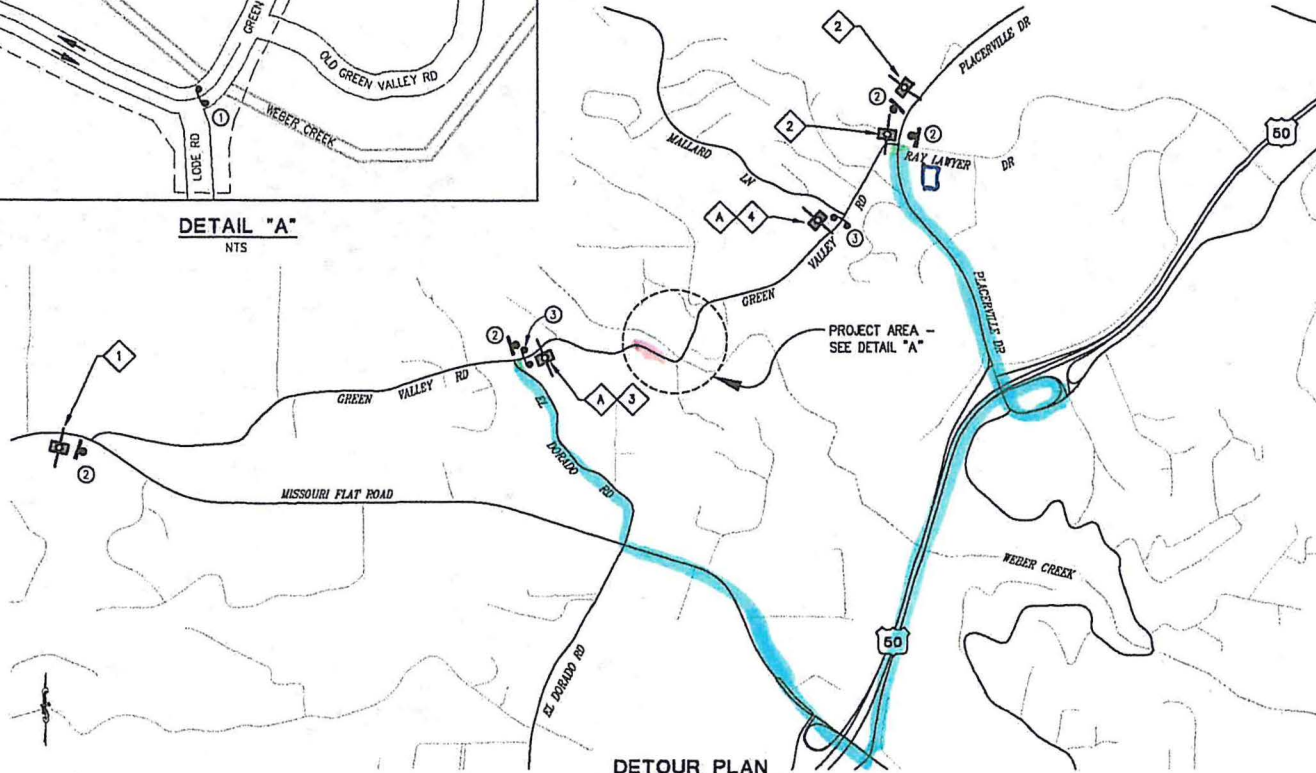

DETOUR PLAN
NTS








DETOUR PLAN
SCALE : AS SHOWN

FOR REDUCED PLANS SCALE IS IN INCHES
Drawing name: C:\Users\l.kayne\Documents\Projects\77114\Sheet\77114.dwg Level: 00-1 Exp 17/2011 - 9:07am Slippy

<p>DESIGNED BY: _____</p> <p>DRAWN BY: _____</p> <p>CHECKED BY: _____</p> <p>DATE: 08/23/14</p> <p>PROJECT NUMBER: 002</p>	<p>PREPARED UNDER THE SUPERVISION OF:</p> <p><i>[Signature]</i></p> <p>REGISTERED CIVIL ENGINEER</p> <p>DATE: 09/19/14</p>		<p>COUNTY OF EL DORADO COMMUNITY DEVELOPMENT AGENCY TRANSPORTATION DIVISION</p>	<p>GREEN VALLEY RD AT WEBER CREEK BRIDGE REPLACEMENT</p>	<p>SHEET DE-1 29 of 78 77114</p>
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1 of 6

FOR PRODUCED PLANS
 DESIGNER: SCHEFFEL & ASSOCIATES
 DRAWING NUMBER: C-10133 (REVISED) SHEET 1 OF 3
 PROJECT: GREEN VALLEY ROAD AT WEBER CREEK BRIDGE REPLACEMENT
 DATE: 09/19/14

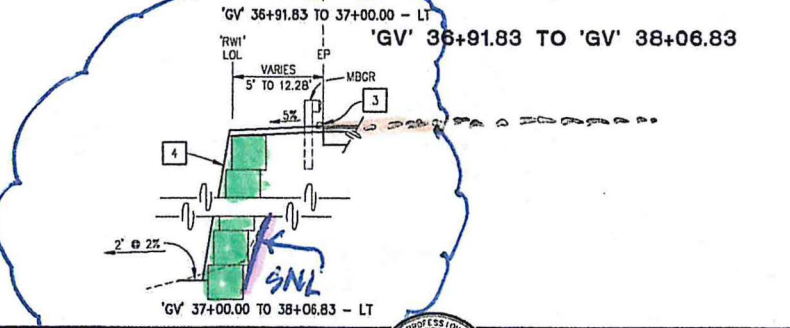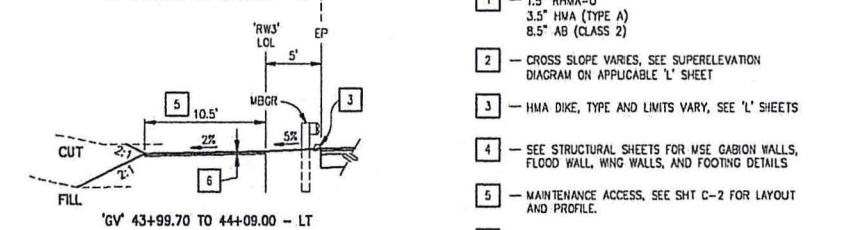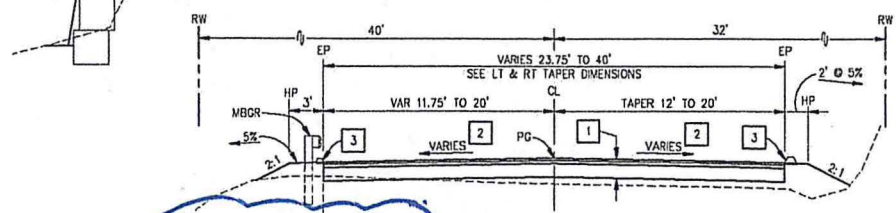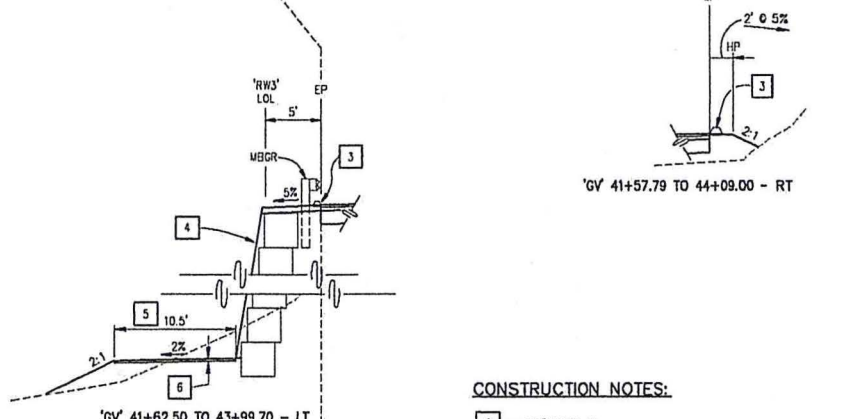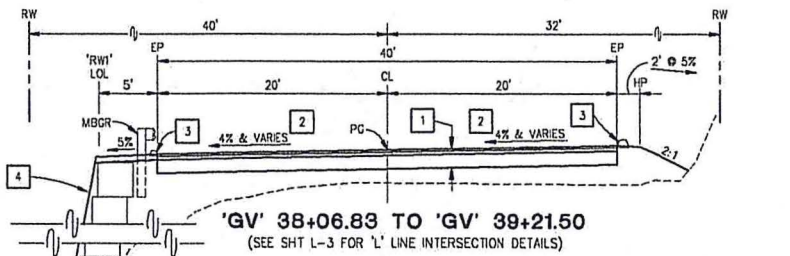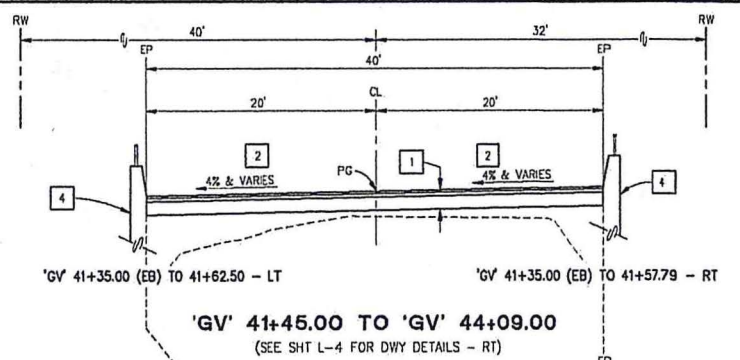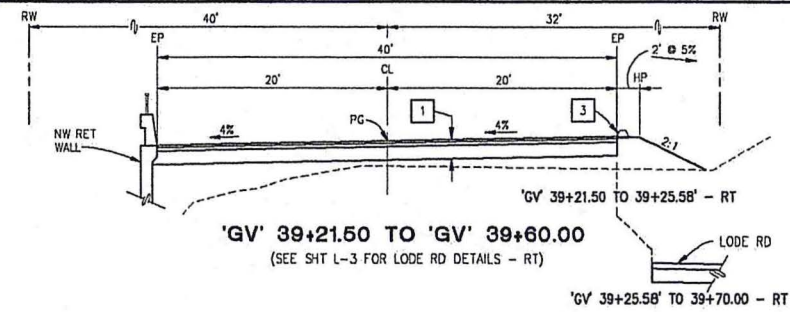

- CONSTRUCTION NOTES:**
- 1 - 1.5" RHMA-0
3.5" HVA (TYPE A)
8.5" AB (CLASS 2)
 - 2 - CROSS SLOPE VARIES, SEE SUPERELEVATION DIAGRAM ON APPLICABLE 'L' SHEET
 - 3 - HMA DIKE, TYPE AND LIMITS VARY, SEE 'L' SHEETS
 - 4 - SEE STRUCTURAL SHEETS FOR USE GABION WALLS, FLOOD WALL, WING WALLS, AND FOOTING DETAILS
 - 5 - MAINTENANCE ACCESS, SEE SHIT C-2 FOR LAYOUT AND PROFILE.
 - 6 - 3" CRUSHED GRAVEL (3/4" MINUS)

TYPICAL SECTIONS
SCALE: NONE

NO.	DATE	DESCRIPTION	BY



PREPARED UNDER THE SUPERVISION OF:
[Signature]
 REGISTERED CIVIL ENGINEER
 DATE: 09/19/14

DESIGNER: SCHEFFEL & ASSOCIATES
 DRAWN: DWH
 DATE: 06/11/14
 PROJECT NUMBER: 002




COUNTY OF EL DORADO
 COMMUNITY DEVELOPMENT AGENCY
 TRANSPORTATION DIVISION

GREEN VALLEY RD AT WEBER CREEK
 BRIDGE REPLACEMENT

SHEET
 X-1
 3 OF 78
 77114

3 of 4

7 78 h

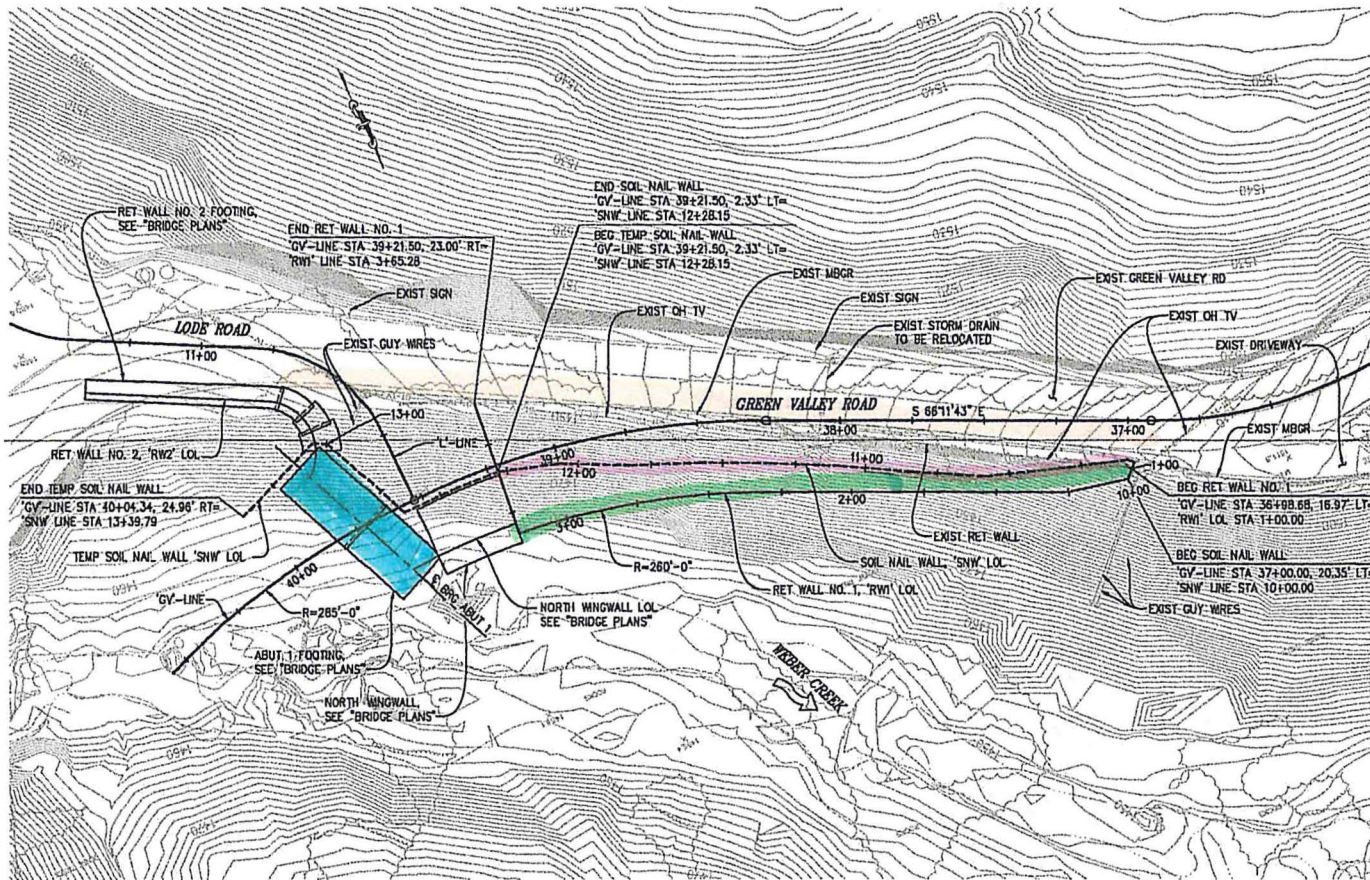

PLAN
SCALE: 1"=20'

- NOTES:**
1. FOR SURVEY CONTROL, SEE "ROAD PLANS".
 2. CONTOURS SHOWN ARE EXISTING GROUND.
 3. SEE "ROAD PLANS" FOR TYPE AND LOCATIONS OF ALL EXISTING AND PROPOSED UTILITIES.
 4. LOCATION OF EXISTING UTILITIES SHOWN ARE APPROXIMATE. THE CONTRACTOR SHALL VERIFY LOCATIONS OF ALL AFFECTED UTILITIES PRIOR TO PERFORMING ANY EXCAVATION.
 5. FOR HYDROLOGIC SUMMARY TABLE, SEE "FOUNDATION PLAN" ON "BRIDGE PLANS".


- LEGEND:**
- INDICATES SOIL NAIL WALL LOL.
 - INDICATES RET. WALL NO. 1 LOL.
 - INDICATES EXISTING FEATURES.

**RETAINING WALL NO. 1
FOUNDATION PLAN
SCALE: AS SHOWN**


FOR REDUCED PLANS 0 1 2 ORIGINAL SCALE IS 24 INCHES
Drawing Name: C:\Users\jordan\OneDrive\Documents\931\931\931\931.dwg Date: 7/31/12 5:35pm Jordan

	PREPARED UNDER THE SUPERVISION OF:	DESIGNED BY:	DRAWN BY:
		CHECKED BY:	DATE:
REGISTERED CIVIL ENGINEER	8/19/14	PROJECT NUMBER:	002
COUNTY OF EL DORADO COMMUNITY DEVELOPMENT AGENCY TRANSPORTATION DIVISION		GREEN VALLEY RD AT WEBER CREEK BRIDGE REPLACEMENT	
SHEET 8-19 53 OF 78 77114			14-1320 C 53 of 78

ORIGINAL SCALE IS IN HIGHS
 Drawing Name: C:\Users\jw\OneDrive\Documents\9315\VRM-12.dwg Layout File: Layout11 Aug 19, 2014 - 6:12pm local
 FOR REDUCED PLANS

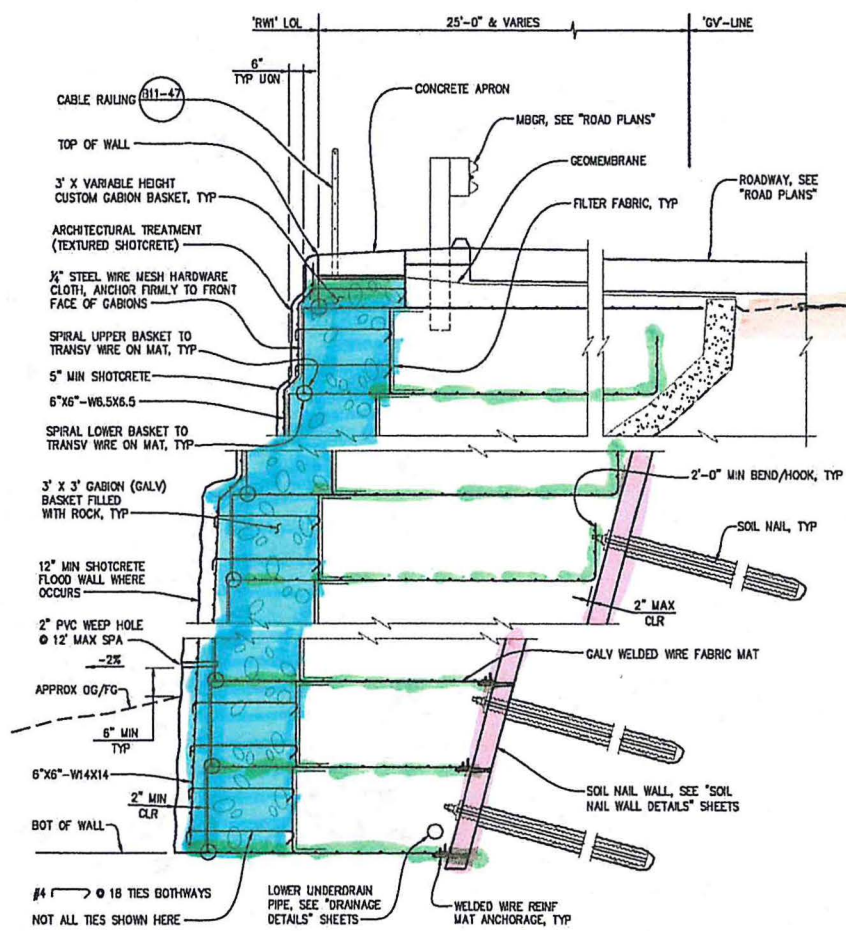

SECTION C-C
SCALE: 1/2" = 1'-0"

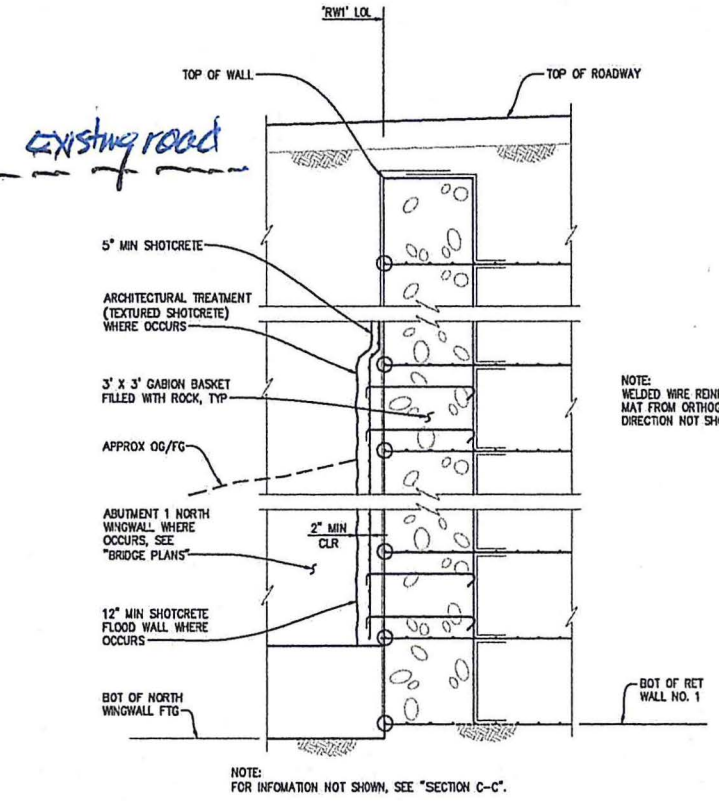

SECTION D-D
SCALE: 1/2" = 1'-0"


RETAINING WALL NO. 1
 GABION MSE WALL DETAILS NO. 1
 SCALE: AS SHOWN

		PREPARED UNDER THE SUPERVISION OF: 	DESIGNED BY: SP CHECKED BY: TK ROAD NUMBER: 002	DRAWN BY: JEV DATE: 7/31/12	COUNTY OF EL DORADO COMMUNITY DEVELOPMENT AGENCY TRANSPORTATION DIVISION	GREEN VALLEY RD AT WEBER CREEK BRIDGE REPLACEMENT	SHEET S-28 62 OF 78 77114
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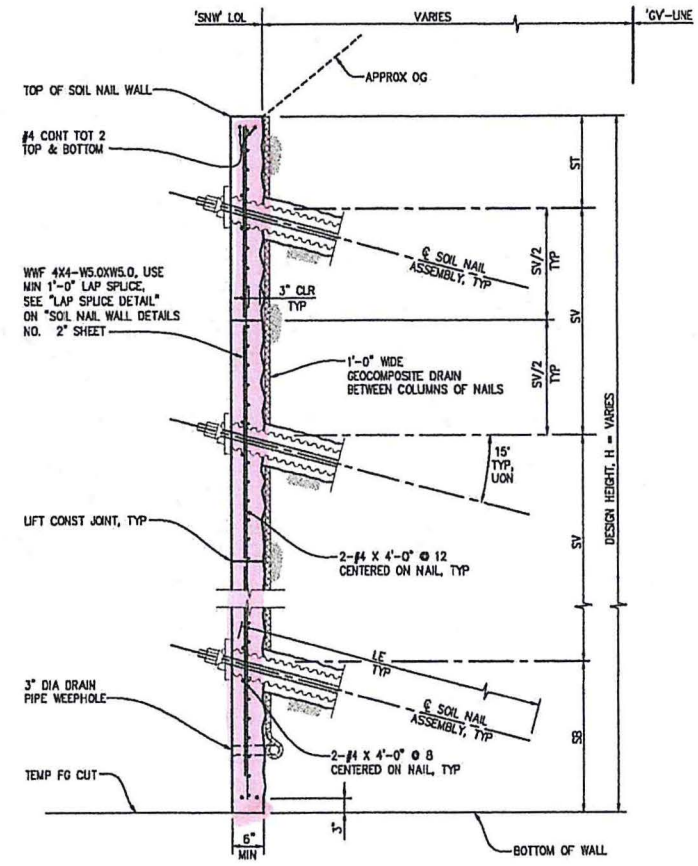
14-1320 C 62 of 78

S of 6

ORIGINAL SCALE IS IN INCHES
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 FOR REDUCED PLANS

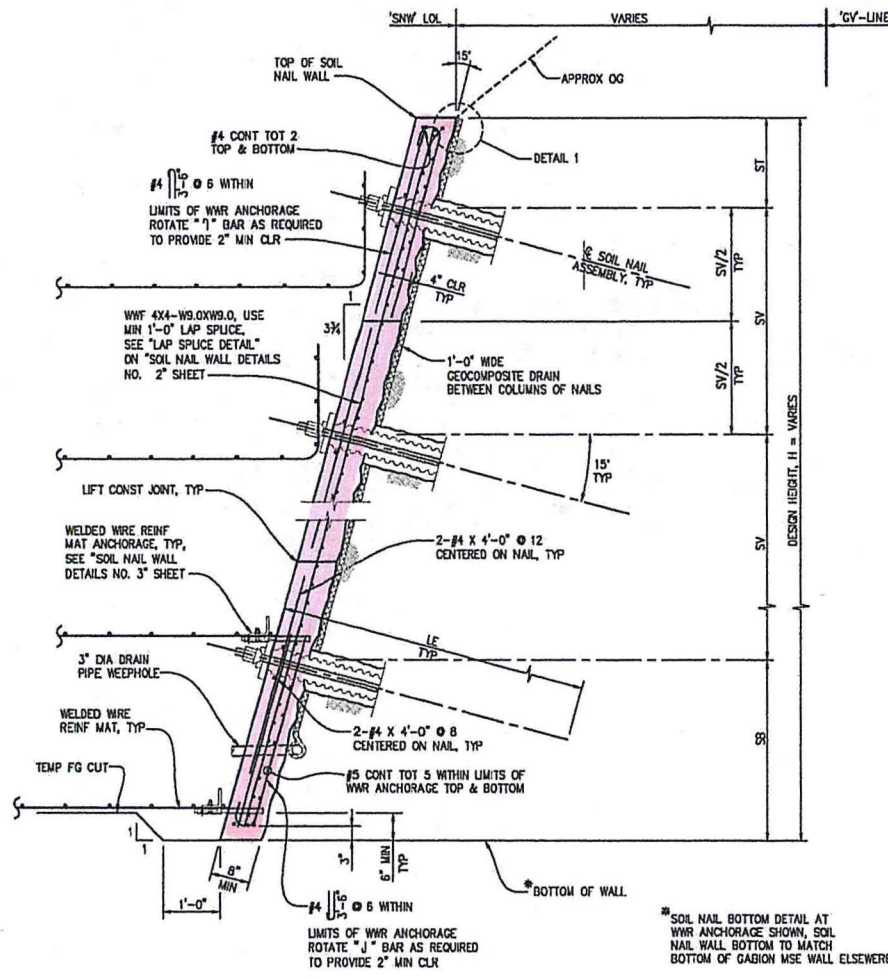

SECTION A-A
SCALE: 1" = 1'-0"



SECTION B-B
SCALE: 1" = 1'-0"

- NOTES:**
1. FOR GEOCOMPOSITE DRAIN DETAILS, SEE "DRAINAGE DETAILS" SHEETS
 2. FOR "DETAIL 1", SEE "SOIL NAIL DETAILS NO. 2" SHEET.

RETAINING WALL NO. 1
SOIL NAIL WALL DETAILS NO. 1
 SCALE: AS SHOWN

REVISION	DATE	DESCRIPTION	BY



PREPARED UNDER THE SUPERVISION OF:
 PREPARED CIVIL ENGINEER: *[Signature]*
 DATE: 8/19/14

DESIGNED BY: JYV
 CHECKED BY: TK
 DATE: 7/31/12
 ROAD NUMBER: 002



COUNTY OF EL DORADO
COMMUNITY DEVELOPMENT AGENCY
TRANSPORTATION DIVISION

GREEN VALLEY RD AT WEBER CREEK
BRIDGE REPLACEMENT

SHEET: **S-25**
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 77114

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