COUNTY OF EL DORADO, CA SUPERVISORS - = ≣ ≥ > INDEX OF SHEETS COMMUNITY DEVELOPMENT SERVICES SHEET PLAN SHEET TITLE DEPARTMENT OF TRANSPORTATION JOHN HIDAHL GEORGE TURNBOO WENDY THOMAS TITLE SHEET GENERAL NOTES, ABBREVIATIONS SHEET INDEX MAP AND FARTHWORK SUMMARY CD-1SURVEY AND CONTROL DIAGRAM PROJECT PLANS FOR THE CONSTRUCTION OF THE 2024 5-13 P-1 THRU P-9 LAYOUT SD-1 THRU SD-4 DRAINAGE APACHE AVENUE PEDESTRIAN COUNTY OF EL DORADO COMMUNITY DEVELOPMENT SERVICES DEPARTMENT OF TRANSPORTATION LAYOUT AND DRAINAGE QUANTITIES Q-1PROJECT 19-20 HC-1 THRU HC-2 HORIZONTAL CONTROL SITE SAFETY AND CONNECTIVITY D-1 THRU D-5 21-25 DETAILS PAVEMENT DELINEATION AND SIGN PLAN PD-1 THRU PD-3 26 - 28**PROJECT** 29 - 30EC-1 THRU EC-3 TEMPORARY EROSION CONTROL S S 31 - 32R-1 THRU R-2 REVEGETATION PLAN 33 T-1 TRAFFIC CONTROL IN THE COUNTY OF EL DORADO, DISTRICT 5, TAHOE PARADISE UNITS NO. 1, 2, 5 & 6 SUBDIVISIONS 924 B E SOUTH SOUTH TAHOE PUBLIC UTILITY DISTRICT WATER LINE RELOCATION SHEETS SHEET PLAN SHEET TITLE To be supplemented with the 2022 Standard Plans and Specifications of TITLE SHEET W-1the California Department of Transportation, unless otherwise noted COUNTY OF EL DORADO 35 W-2GENERAL NOTES W-3 THRU W-6 WATERLINE REPLACEMENT PLAN SHEETS W-7 THRU W-8 WATER SERVICE PROFILES WASHOF ST ARROWHEAD LAKE TAHOE ENVIRONMENTAL MAGNET SCHOOL FUNDING AGENCIES ACTIVE TRANSPORTATION AVE STATE BLOCK GRANT TRPA MITIGATION FUNDS ARROWHEAD CARBON REDUCTION PROGRAM APACHE AVENUE PEDESTRIAN SAFETY AND APACHE AVENUE PEDESTRIAN SAFETY AND CONNECTIVITY PDO IECT CONNECTIVITY PROJECT **IMPROVEMENTS** SHEET CONTRACTOR'S LICENSE CLASSIFICATION: Bidders shall be properly licensed to perform the Work pursuant to the State Contractor's License Law (Business and Professions Code section 7000 et seq.) and shall possess a CLASS A LICENSE and CLASS C27 LICENSE or equivalent combination of Classes required by LOCATION MAP the categories and type of Work included in the Contract Documents and Plans, at the time the Contract is awarded, and shall maintain a valid license through completion and acceptance of the Work including guarantee and warranty period. Failure of the successful Bidder to obtain proper and adequate licensing an award of the Contract shall constitute a failure to execute the Contract, and shall result in PROJECT LOCATION LEGEND **REVISIONS** • ADA CURB RAMPS SPEED FEEDBACK SIGN --- CLASS 1 BIKEWAY DECEMBER 31, 2023 SIDEWALK SUBMITTED BY: DANIEL W. KIKKERT P.E. SENIOR CIVIL ENGINEER STATE OF CALIFORNIA NO. 70168

MARK DATE BY

PROPOSED

EXISTING

CABLE TELEVISION

NATURAL GAS

SEWER & WATER

ELECTRIC


TELEPHONE

STORM DRAIN

- ALL IMPROVEMENTS WILL BE ACCOMPLISHED UNDER THE APPROVAL, INSPECTION, AND TO THE SATISFACTION OF THE COUNTY OF EL DORADO DEPARTMENT OF TRANSPORTATION (TD). IMPROVEMENT CONSTRUCTION MUST COMPLY WITH THESE PLANS AND THE 2018 CALTRANS STANDARD PLANS, UNLESS NOTED OTHERWISE. ALL REFERENCES TO THE "STANDARD SPECIFICATIONS" MEAN THE STATE OF CALIFORNIA, DEPARTMENT OF TRANSPORTATION (CALTRANS) 2015 STANDARD SPECIFICATIONS. CONSTRUCTION NOT SPECIFIED ON THESE PLANS OR IN SPECIFIC COUNTY OF EL DORADO (COUNTY) ORDINANCES MUST CONFORM TO THE REQUIREMENTS OF THE STANDARD SPECIFICATIONS. YOU ARE OBLIGATED TO BE FAMILIAR WITH APPLICABLE SECTIONS OF THE STANDARD SPECIFICATIONS NOT DISCUSSED IN THE GENERAL NOTES. THE CONTRACT SPECIAL PROVISIONS SUPERSEDE THE STANDARD SPECIFICATIONS WHERE DISCREPANCIES OCCUR.
- CONSTRUCTION HOURS WILL BE WEEKDAYS BETWEEN 8:00 A.M. AND 6:30 P.M. UNLESS PRIOR APPROVAL IS RECEIVED FROM THE COUNTY TO.
- THE LOCATIONS AND EXTENT OF UNDERGROUND UTILITIES IN THE WORK AREA AS SHOWN ARE APPROXIMATE AND ARE NOT NECESSARILY COMPLETE. A REASONABLE EFFORT HAS BEEN MADE TO LOCATE AND DELINEATE UTILITIES BASED UPON AVAILABLE RECORDS. YOU MUST DETERMINE THE TYPE, LOCATION, SIZE, AND/OR DEPTH OF THE UTILITIES WITHIN THE WORK AREA BEFORE STARTING WORK. YOU OR ANY SUBCONTRACTOR FOR THIS CONTRACT ARE RESPONSIBLE FOR DAMAGES DUE TO THE FAILURE TO EXACTLY LOCATE AND PRESERVE UNDERGROUND UTILITIES. YOU MUST CONTACT UNDERGROUND SERVICE ALERT AT (800) 642-2444 AT LEAST 48 HOURS BEFORE ANY CONSTRUCTION. SEE THE SPECIAL PROVISIONS FOR NOTIFICATION REQUIREMENTS. YOU ASSUME COMPLETE RESPONSIBILITY FOR DAMAGED
- UNLESS SHOWN OTHERWISE, YOU ARE RESPONSIBLE FOR THE PROTECTION OF ALL EXISTING SURVEY MONUMENTS AND OTHER SURVEY MARKERS, INCLUDING CONSTRUCTION STAKES DURING CONSTRUCTION AND YOU ARE RESPONSIBLE FOR THE COST TO REPLACE ANY SUCH SURVEY
- YOU WILL PROVIDE ALL LIGHTS, SIGNS, BARRICADES, FLAG PERSONS, PILOT CAR, OR OTHER DEVICES NECESSARY TO CONTROL TRAFFIC THROUGH THE JOB SITE AND FOR PUBLIC SAFETY UNDER THESE PLANS, THE STANDARD SPECIFICATIONS, AND CALIFORNIA MANUAL ON UNIFORM TRAFFIC
- YOU AGREE TO ASSUME SOLE RESPONSIBILITY FOR JOB SITE CONDITIONS DURING THE COURSE OF THE WORK, INCLUDING SAFETY OF ALL PERSONS AND PROPERTY, AND FURTHER AGREE THAT THIS REQUIREMENT APPLIES CONTINUOUSLY AND IS NOT LIMITED TO NORMAL WORKING HOURS UNDER THE CONTRACT AND STANDARD SPECIFICATIONS.
- THERE WILL BE NO GRADING OR LAND DISTURBANCE BETWEEN OCTOBER 15 AND MAY 1 UNLESS APPROVALS ARE OBTAINED FROM THE TAHOE REGIONAL PLANNING AGENCY (TRPA), AS PROVIDED IN THE LIMITED EXEMPTION DESCRIBED IN CHAPTER 64, SUBSECTION 64.2.B. OF THE TRPA CODE OF ORDINANCES. APPROVALS FOR GRADING BETWEEN OCTOBER 15 AND MAY 1 MUST ALSO BE OBTAINED FROM THE REGIONAL WATER QUALITY CONTROL BOARD, LAHONTAN. IF REQUIRED, THE COUNTY WILL OBTAIN THESE APPROVALS.
- YOU WILL MAINTAIN A SFT OF PLANS ON THE JOB SITE SHOWING "AS-CONSTRUCTED" CHANGES MADE TO DATE. UPON COMPLETION OF THE WORK, YOU WILL GIVE TO THE COUNTY A SET OF PLANS, MARKED UP TO THE SATISFACTION OF THE COUNTY, REFLECTING THE AS-CONSTRUCTED MODIFICATIONS.
- ALL CONTROL STATIONING AND DATA DIMENSIONING REFERENCE THE CENTERLINE OF THE FACILITY SHOWN, UNLESS NOTED OTHERWISE.
- YOU WILL NOT CLOSE OFF ANY UTILITY LINES OR OPEN VALVES OR TAKE ANY OTHER ACTION WHICH WOULD AFFECT THE OPERATION OF WATER OR SEWER SYSTEMS WITHOUT APPROVAL FROM THE SOUTH TAHOE PUBLIC UTILITY DISTRICT (STPUD). APPROVAL MUST BE REQUESTED AT LEAST 48 HOURS BEFORE INTERRUPTION OF THE UTILITY SERVICE IS REQUIRED. ANY INTERRUPTION TO ACTIVE WATER OR SEWER SERVICES, INCLUDING FIRE HYDRANTS, WHETHER INTENTIONAL OR NOT, MUST BE KEPT TO A MINIMUM TIME PERIOD. IF SERVICE TO BUILDINGS IS TO BE
- YOU ARE REQUIRED TO IMPLEMENT DUST CONTROL MEASURES TO ENSURE THAT DUST RESULTING FROM YOUR ACTIVITIES IS CONTROLLED AND COMPLIES WITH THE PROVISIONS OF SECTION 7, "LEGAL RELATIONS AND RESPONSIBILITY TO THE PUBLIC," AND SECTION 14, "ENVIRONMENTAL STEWARDSHIP," OF THE STANDARD SPECIFICATIONS, COUNTY, AND LOCAL ORDINANCES. SEE THE SPECIAL PROVISIONS FOR DUST AND TRACKING CONTROL AND SWEEPING REQUIREMENTS.
- YOU ARE RESPONSIBLE FOR IMPLEMENTING ALL TEMPORARY EROSION CONTROL MEASURES. THE TEMPORARY EROSION CONTROL MEASURES MUST COMPLY WITH THE TRPA "HANDBOOK OF BEST MANAGEMENT PRACTICES" AND THE STORM WATER POLLUTION PREVENTION PLAN (SWPPP). THE TO WILL CONTACT TRPA BEORE THE START OF THE WORK FOR A PRE-GRADING INSPECTION OF THE INSTALLED TEMPORARY EROSION CONTROL FACILITIES. YOU ARE RESPONSIBLE FOR THE MAINTENANCE AND PERFORMANCE OF THE TEMPORARY EROSION CONTROL MEASURES THROUGHOUT THE DURATION OF THE WORK. SEE THE SPECIAL PROVISIONS REGARDING TEMPORARY EROSION CONTROL FACILITY REMOVAL.
- 13. CONSTRUCTION LIMITS SHOWN DELINEATE THE BOUNDARIES FOR YOUR ACTIVITIES BEYOND THE COUNTY STREET RIGHT-OF-WAY. CONSTRUCTION LIMIT FENCING MUST BE ERECTED ALONG THESE BOUNDARIES BEFORE WORK STARTS. VEGETATION WITHIN THESE LIMITS MUST BE PROTECTED TO THE EXTENT FEASIBLE. ALL TREES MUST BE PROTECTED UNLESS SHOWN TO BE REMOVED.
- 14. UNLESS NOTED OTHERWISE, ALL REVEGETATION IS TO BE COMPLETED BY OTHERS
- 15. YOU WILL ONLY USE THE DESIGNATED SITES SHOWN FOR STORAGE OF EQUIPMENT AND MATERIALS. YOU ARE RESPONSIBLE FOR THE SECURITY
- 16. IT IS YOUR AND YOUR SUBCONTRACTOR(S) RESPONSIBILITY TO EXAMINE THE JOB SITE BEFORE THE OPENING OF BID PROPOSALS. YOU MUST BECOME FAMILIAR WITH THE NATURE AND LOCATION OF THE WORK AND THE GENERAL AND LOCAL CONDITIONS, PARTICULARLY THOSE AFFECTING THE AVAILABILITY OF TRANSPORTATION, THE DISPOSAL, HANDLING, AND STORAGE OF MATERIALS, AVAILABILITY OF LABOR, WATER, ELECTRICITY, ROADS, THE UNCERTAINTIES OF WEATHER, THE CONDITIONS OF THE GROUND, SURFACE AND SUBSURFACE MATERIALS, THE EQUIPMENT AND FACILITIES NEEDED FOR AND DURING THE PERFORMANCE OF THE WORK. FAILURE BY YOU OR YOUR SUBCONTRACTOR(S) TO ACQUAINT OURSELVES WITH THE INFORMATION AVAILABLE WILL NOT RELIEVE YOU OR YOUR SUBCONTRACTOR(S) FROM RESPONSIBILITY FOR PROPERLY ESTIMATING THE DIFFICULTY AND COST OF SUCCESSFULLY PERFORMING THE WORK.
- 17. ELEVATIONS FOR PIPE INVERTS, FLOWLINES, TOPS OF GRATES, RIMS, ETC., ARE BASED ON THE TOPOGRAPHIC INFORMATION SHOWN. YOU WILL VERIFY ALL NECESSARY SURFACE ELEVATIONS IN THE FIELD AND NOTIFY THE TD OF ANY DISCREPANCIES WHICH MIGHT AFFECT THE OPERATION OF THE NEW FACILITIES BEFORE BREAKING GROUND FOR THE INSTALLATION. THE TD MUST BE CONTACTED IF ELEVATIONS ARE INCORRECT SO PROPER ADJUSTMENTS CAN BE MADE BEFORE THE INSTALLATION OF THE FACILITIES.
- 18. EXCEPT FOR THOSE OBTAINED BY THE TD, YOU MUST OBTAIN, AT YOUR EXPENSE, ALL PERMITS, LICENSES, INSURANCE POLICIES, ETC., ECESSARY TO COMPLY WITH STATE AND LOCAL LAWS ASSOCIATED WITH THE PERFORMANCE OF THE WORL
- 19. YOU ARE RESPONSIBLE TO REVIEW THE CONTRACT DOCUMENTS FOR SUBMITTALS REQUIRED FOR COUNTY REVIEW AND ACCEPTANCE.
- THE COUNTY WILL PROVIDE CONSTRUCTION STAKING IN COMPLIANCE WITH SECTION 5-1.26 OF THE STANDARD SPECIFICATION.
- THE PLANS SHOW SLOPE LENGTHS FOR PIPE ROUNDED TO THE NEAREST FOOT. ALL PIPE LENGTHS AND INVERT ELEVATIONS SHOWN ON THE PLANS ARE TO THE CENTERLINE OF THE STRUCTURES TO WHICH THE PIPES ARE ATTACHED. SEE THE STANDARD SPECIFICATIONS FOR THE MAXIMUM ALLOWABLE DEFLECTION ANGLE AT EACH PIPE JOINT.
- 22. YOU ARE RESPONSIBLE TO MAINTAIN THE GRADING LIMITS AS SHOWN ON THE PLANS, DETAILS, CROSS SECTIONS, AND AS DIRECTED BY THE ENGINEER. SEE SHEET iii OF THE PLANS FOR THE RAW EARTHWORK QUANTITIES ASSOCIATED WITH GRADING.


Δ	DELTA = DEFLECTION ANGLE	MISC	MISCELLANEOUS
A	ARCH OR ASPEN	мос	MID POINT ON CURVE
AB	AGGREGATE BASE	MOD	MODIFIED
ABAND	ABANDONED	MV	MEADOW VALE
ABC	ARTICULATED BLOCK CHANNEL	N	NORTH
AC	ASPHALT CONCRETE	NEG	NEGLIGIBLE
AP	ANGLE POINT	NGVD	NATIONAL GEODETIC VERTICAL DATUM
APN	ASSESSOR'S PARCEL NUMBER	NIC	NOT IN CONTRACT
BC	BEGIN CURVE	NTS	NOT TO SCALE
BCR	BEGIN CURB RETURN	OAE	OR APPROVED EQUAL
BGN BLC	BEGIN BLANKET—LINED CHANNEL	OC	ON CENTER
BLC BR	BOCA RATON	OD OG	OUTSIDE DIAMETER ORIGINAL GROUND
BVCE	BEGIN VERTICAL CURVE ELEVATION	ОН	OVERHEAD
BVCS	BEGIN VERTICAL CURVE STATION		X OVEREXCAVATION
C	CEDAR	P	PINE
CALCS	CALCULATIONS	PC	POINT OF BEGINNING OF CURVE
CATV	CABLE TELEVISION	PCC	PORTLAND CEMENT CONCRETE OR
CC	CENTER TO CENTER		POINT OF COMPOUND CURVE
CF	CUBIC FEET OR CURB FACE	PED	PEDESTRIAN
CHD	CHORD DIRECTION	PERF	PERFORATED
CIR	CIRCLE	PCVCE	POINT OF COMPOUND VERTICAL CURVE ELEVA
<u>e</u>	CENTERLINE	PCVCS	POINT OF COMPOUND VERTICAL CURVE STATIO
CL	CLASS OR CENTERLINE	PL	PROPERTY LINE
CLR	CLEAR	POR	PORTION
CO	CURB OPENING OR CLEANOUT	PP DBC	POWER/UTILITY POLE
CO.	CONCRETE	PRC	POINT OF REVERSE CURVE PROPOSED
CONC	CONCRETE CONSTRUCT	PROP PRVCE	PROPOSED POINT OF REVERSE VERTICAL CURVE ELEVATIO
CONST CMP	CORRUGATED METAL PIPE	PRVCE PRVCS	POINT OF REVERSE VERTICAL CURVE ELEVATION POINT OF REVERSE VERTICAL CURVE STATION
CMP CSP	CORRUGATED METAL PIPE CORRUGATED STEEL PIPE	PRVCS PT	POINT OF REVERSE VERTICAL CURVE STATION POINT OR POINT OF TANGENCY
CT CT	CALTRANS OR COURT	PUE	PUBLIC UTILITY EASEMENT
CTC	CALIFORNIA TAHOE CONSERVANCY	PVC	POLYVINYL CHLORIDE
CY	CUBIC YARD	PVIE	POINT OF VERTICAL INTERSECTION ELEVATION
C&G	CURB AND GUTTER	PVIS	POINT OF VERTICAL INTERSECTION STATION
D	DEPTH	PVMT	PAVEMENT
DBL	DOUBLE	R	RADIUS
DET	DETAIL	R&R	REMOVE & REPLACE
DI	DRAINAGE INLET OR DUCTILE IRON	RC	RELATIVE COMPACTION
DIA OR Ø	DIAMETER	RCP	REINFORCED CONCRETE PIPE
DISS	DISSIPATOR	RD	ROAD
DR	DRIVE	REF	REFERENCE
D/W	DRIVEWAY	REQ'D	REQUIRED
E	EAST	RLC	ROCK-LINED CHANNEL
EA	EACH	ROW	RIGHT-OF-WAY
EC .	END OF CURVE	RSF	REINFORCED SILT FENCE
ECR ELEC	END OF CURB RETURN ELECTRIC	RSP RT	ROCK SLOPE PROTECTION RIGHT
ELEV	ELEVATION	RW	RETAINING WALL
ENGR	ENGINEER	S	SOUTH OR SANITARY SEWER
EP .	EDGE OF PAVEMENT	sco	SEWER CLEAN OUT
ESA	TEMPORARY FENCE	SD	STORM DRAIN
ESMT	EASEMENT	SDMH	STORM DRAIN MANHOLE
EVCE	END VERTICAL CURVE ELEVATION	SEZ	STREAM ENVIRONMENT ZONE
EVCS	END VERTICAL CURVE STATION	SF	SQUARE FEET
EX OR EXIST		SFHA	SPECIAL FLOOD HAZARD AREA
F	FIR	SHT	SHEET
FEMA	FEDERAL EMERGENCY MANAGEMENT	SL	SLOPE LENGTH
	AGENCY	SMH	SEWER MANHOLE
FES	FLARED END SECTION	ST	SEDIMENT TRAP OR STREET
FG	FINISHED GRADE	STA	STATION
FH	FIRE HYDRANT	STD	STANDARD
FL	FLOWLINE	STL	STEEL
FS	FINISH SURFACE	STPUD	SOUTH TAHOE PUBLIC UTILITY DISTRICT
G O	GAS	SWPPP	STORM WATER POLLUTION PREVENTION PLAN
GA GB	GAUGE	T	TELEPHONE
GB CLS	GRADE BREAK	TBC	TOP BACK OF CURB
GLS GW	GRASS-LINED SWALE GROUND WATER	TBD TBR	TOP BACK OF DIKE TO BE REMOVED
GW H	HORIZONTAL	TD	TOP OF DIKE
n HDPE	HIGH DENSITY POLYETHYLENE	TG	TOP OF GRATE
HP	HIGH POINT	TTL	TOTAL
HWL	HIGH WATER LINE	TRANS	TRANSITION
ID	INSIDE DIAMETER	TRM	TURF REINFORCEMENT MAT
IE	INVERT ELEVATION	TRPA	TAHOE REGIONAL PLANNING AGENCY
INCR	INCREASE	TYP	TYPICAL
INST	INSTALL	UG	UNDERGROUND
INTRXN	INTERSECTION	UKN	UNKNOWN
L	LENGTH	USFS	UNITED STATES FOREST SERVICE
LC	LENGTH OF CHORD	V	VERTICAL
LF	LINEAR FEET	W	WEST OR WATER
LP	LOW POINT	W /0	WITHOUT
LT	LEFT	WC	WILLOW CLUSTER
MAT'L	MATERIAL	WV	WATER VALVE

ABBREVIATIONS

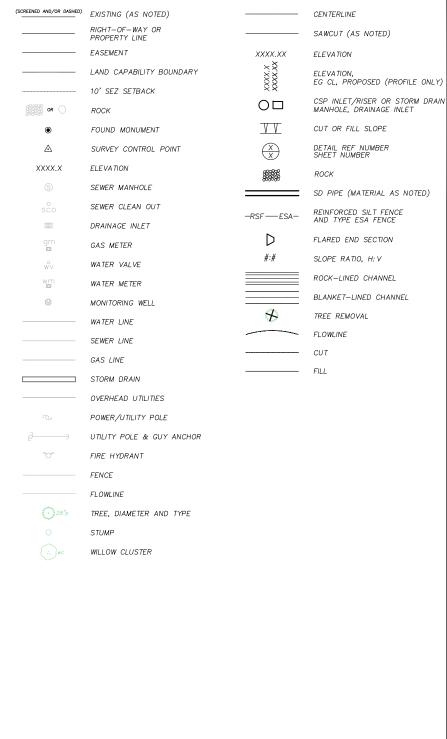





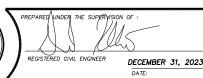



DMG

HECKED:

DWK

OAD NUMBER

DMG

12/2023

COUNTY OF EL DORADO COMMUNITY DEVELOPMENT SERVICES DEPARTMENT OF TRANSPORTATION

APACHE AVENUE PEDESTRIAN SAFETY AND CONNECTIVITY PROJECT

SOUTHWEST GAS, (530) 543-3225

LIBERTY UTILITIES, (530) 541-6400

AT&T, (530) 888-2031

SOUTH TAHOE PUD, (530) 544-6474

CHARTER SPECTRUM COMMUNICATIONS, (775) 588-1077

CO. OF EL DORADO TRANSPORTATION DIVISION. (530) 573-3180



FACILITY	CUT	FILL	TOPSOIL MIX
CHANNEL / ROCK ENERGY DISSIPATOR	5	1	2
ROADWAY / PATHWAY / SIDEWALK	2194	20	97
TOTALS	2199	21	99

NOTES:
THE QUANTITIES SHOWN HAVE BEEN CALCULATED USING THE TOPOGRAPHIC INFORMATION SHOWN ON THE PLANS. THE VOLUMES SHOWN ARE RAW, MEANING THAT NETHER SHRINKAGE, SUBSIDENCE, NOR BULKING HAVE BEEN TAKEN INTO ACCOUNT. FOR THE QUANTITIES SHOWN IT IS ASSUMED THAT NO ROCK WAS ENCOUNTERED. IT IS YOUR RESPONSIBILITY TO REVIEW THESE QUANTITIES AND APPLY THE NECESSARY FACTORS TO DETERMINE THE VOLUME OF IMPORT MATERIAL NECESSARY (OR IF IT IS NECESSARY).

DELTA = AMOUNT TO BE BANKED

CLASS	QUANTITY TBR (SF)	QUANTITY TO BE PLACED (SF) (ROAD)	QUANTITY TO BE PLACED (SF) (SIDEWALK)	DELTA (SF)
SEZ 1B*	0	0	0	0
5*	-87,277	68,972	8,060	-10,245
TOTALS	-87,277	68,972	8,060	-10,245

- NOTES:

 1. NONE OF THE PROJECT AREA WAS MAPPED AS SEZ PER TRPA, 2012.

 2. PER TRPA CLASS 1 TRAILS AND BMPS ARE NOT CONSIDERED IN COVERAGE CALCULATIONS. SIDEWALKS ARE NOT EXEMPT FROM COVERAGE CALCULATIONS

 3. TO BE REMOVED (TBP) QUANTITY ACCOUNTS FOR HARD COVERAGE REMOVED OUTSIDE OF THE LIP OF CURB.

 4. TO BE PLACED QUANTITY INCLUDES ANY PAVING OUTSIDE OF THE TOP BACK OF CURB FOR THE SIDEWALK AND CURB RAMPS ASSOCIATED WITHE SIDEWALK.

DMG

12/2023

WARNING !!

THE LOCATION AND/OR ELEVATION OF EXISTING UNDERGROUND UTILITIES SHOWN ON THESE PLANS ARE ONLY APPROXIMATE. CONTRACTOR TO VERIFY LOCATION AND ELEVATION OF ALL EXISTING UNDERGROUND UTILITIES.



SCALE: 1" = 150'






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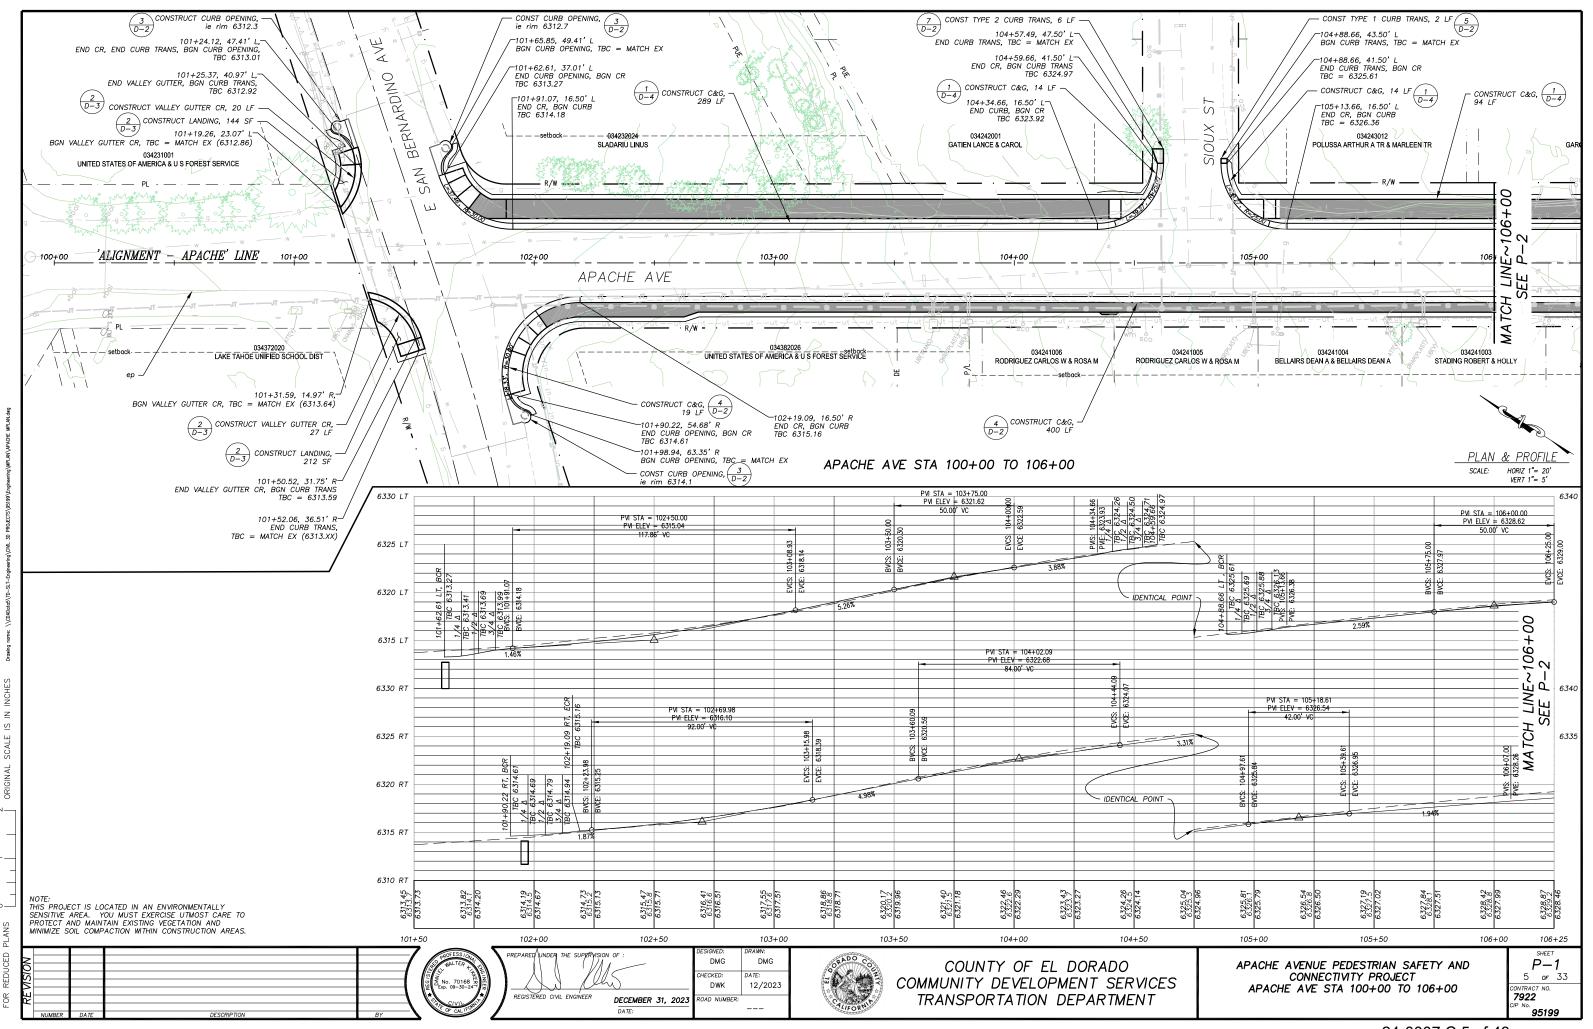



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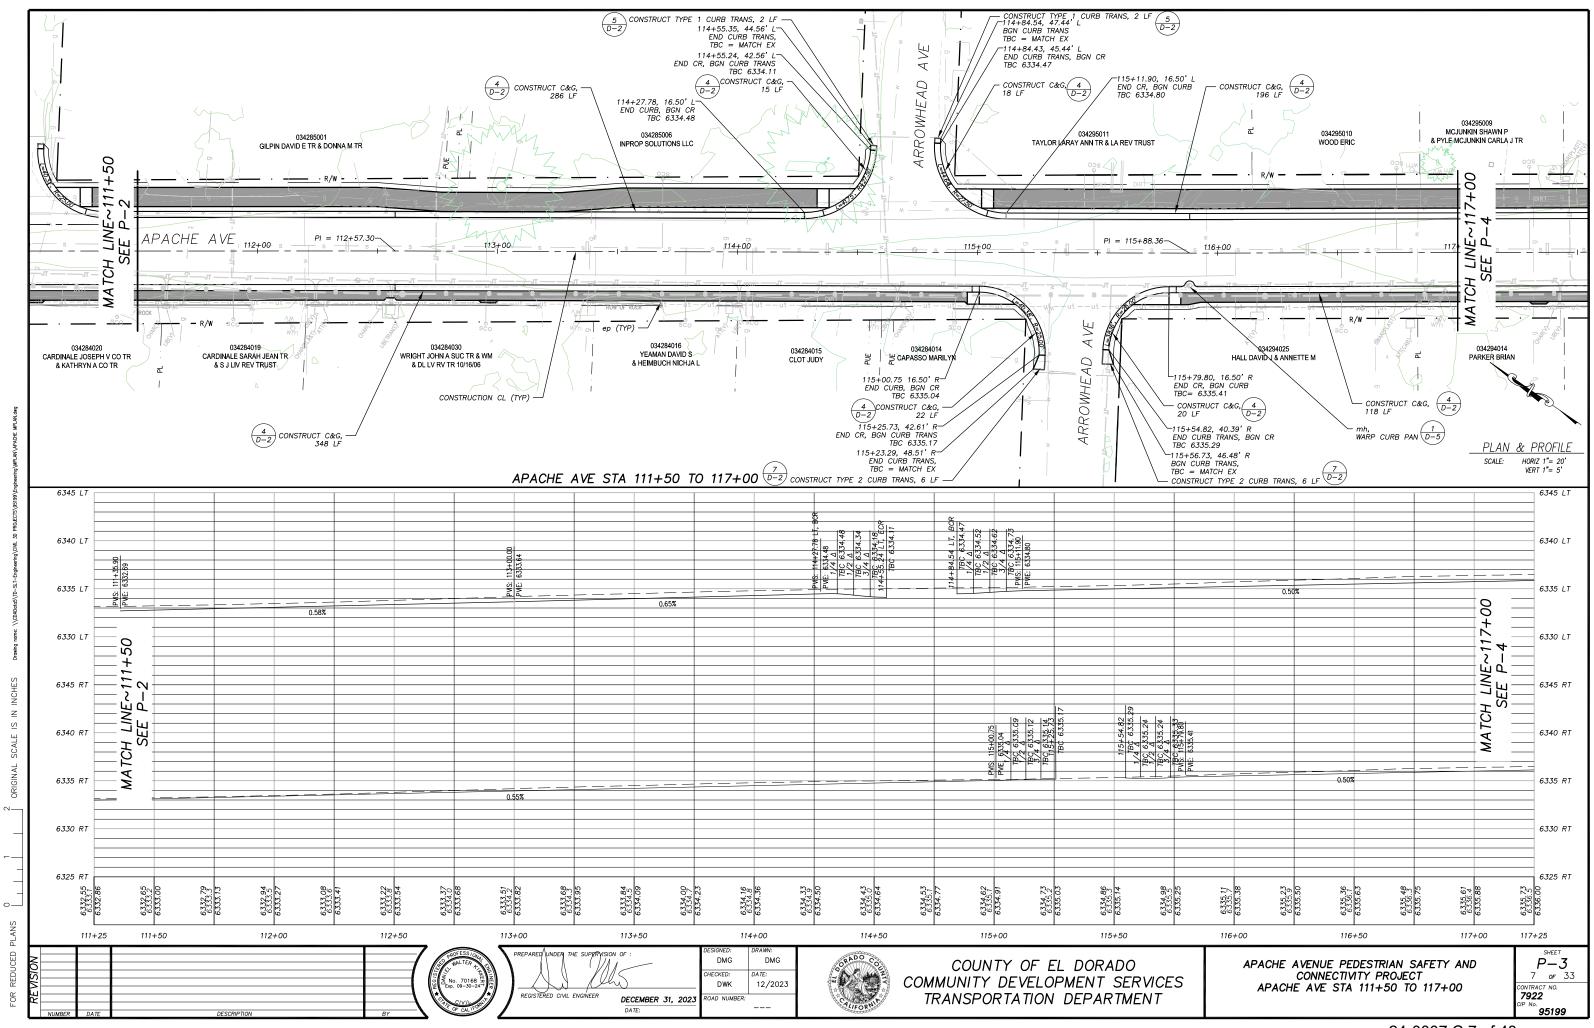
APACHE AVENUE PEDESTRIAN SAFETY AND CONNECTIVITY PROJECT SHEET INDEX MAP AND EARTHWORK SUMMARY TABLE


SHEET 3 of 33 CONTRACT NO. **7922** 95199







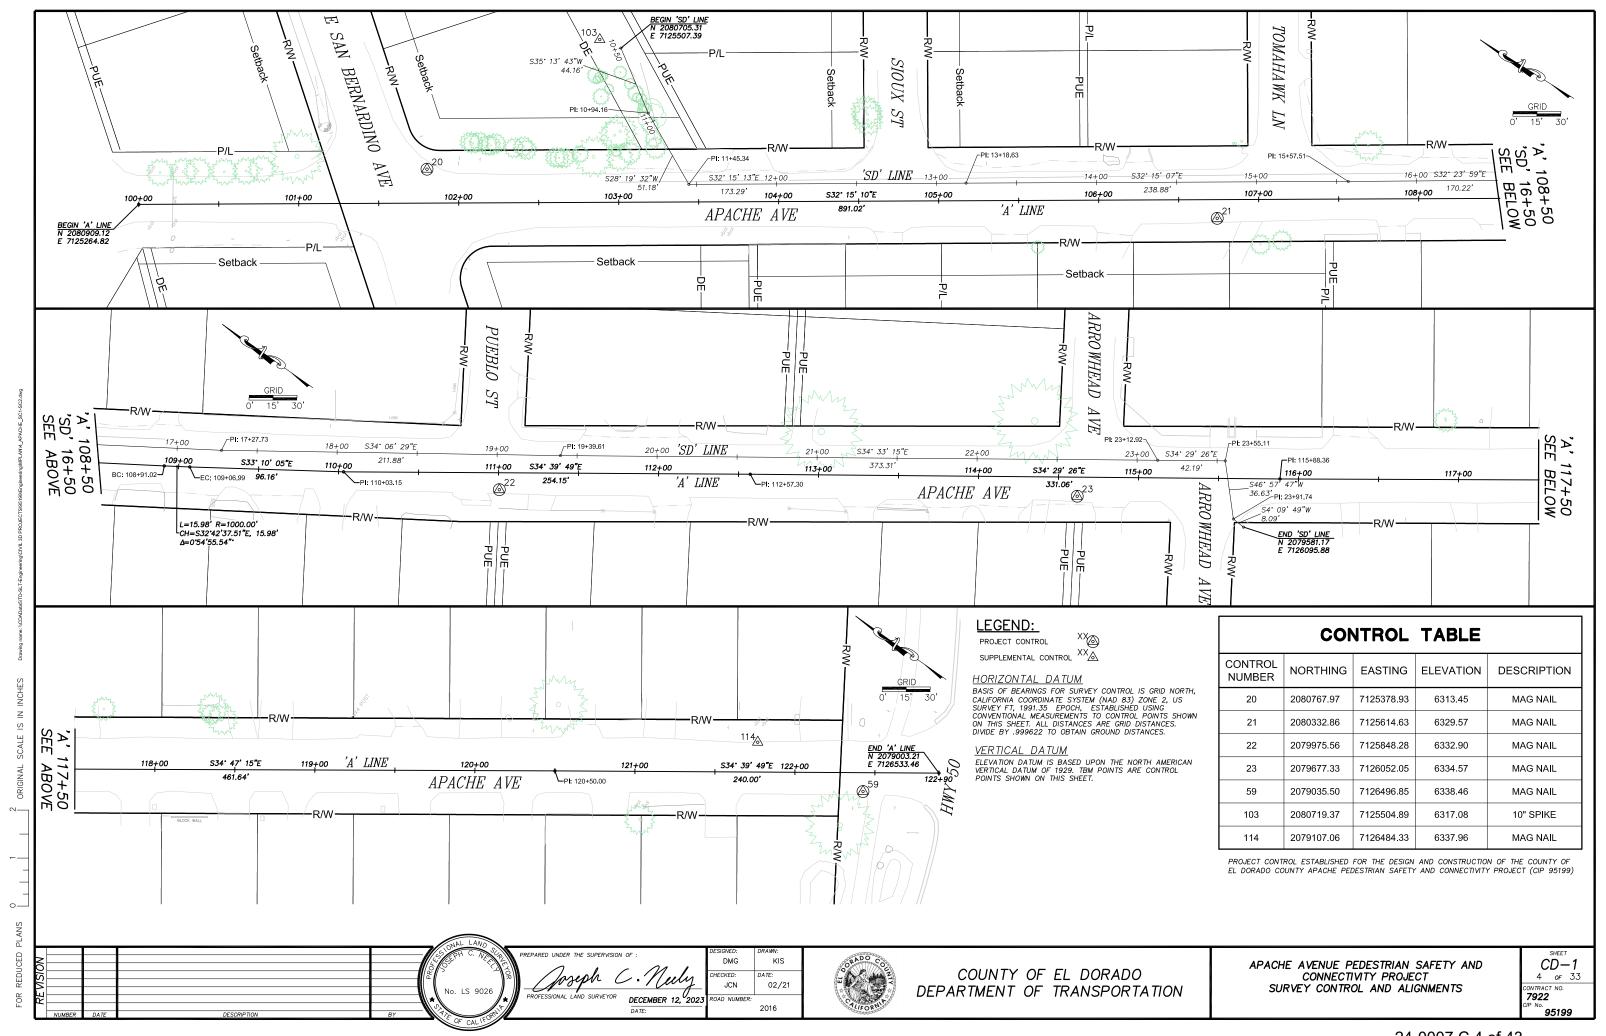


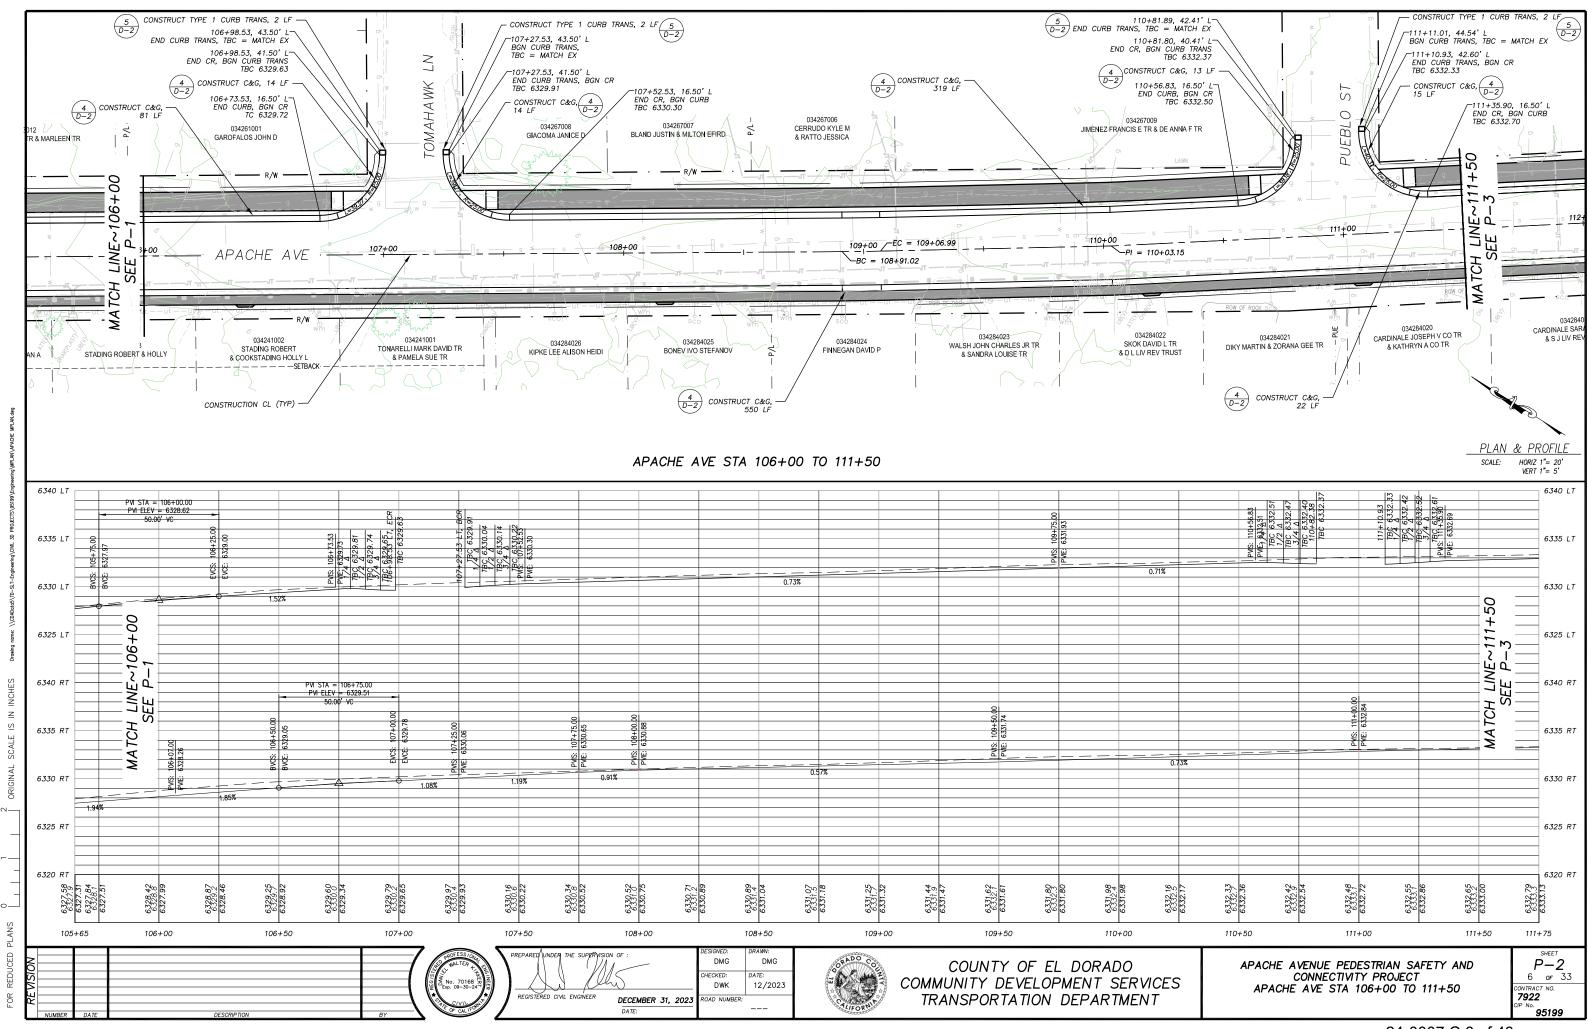


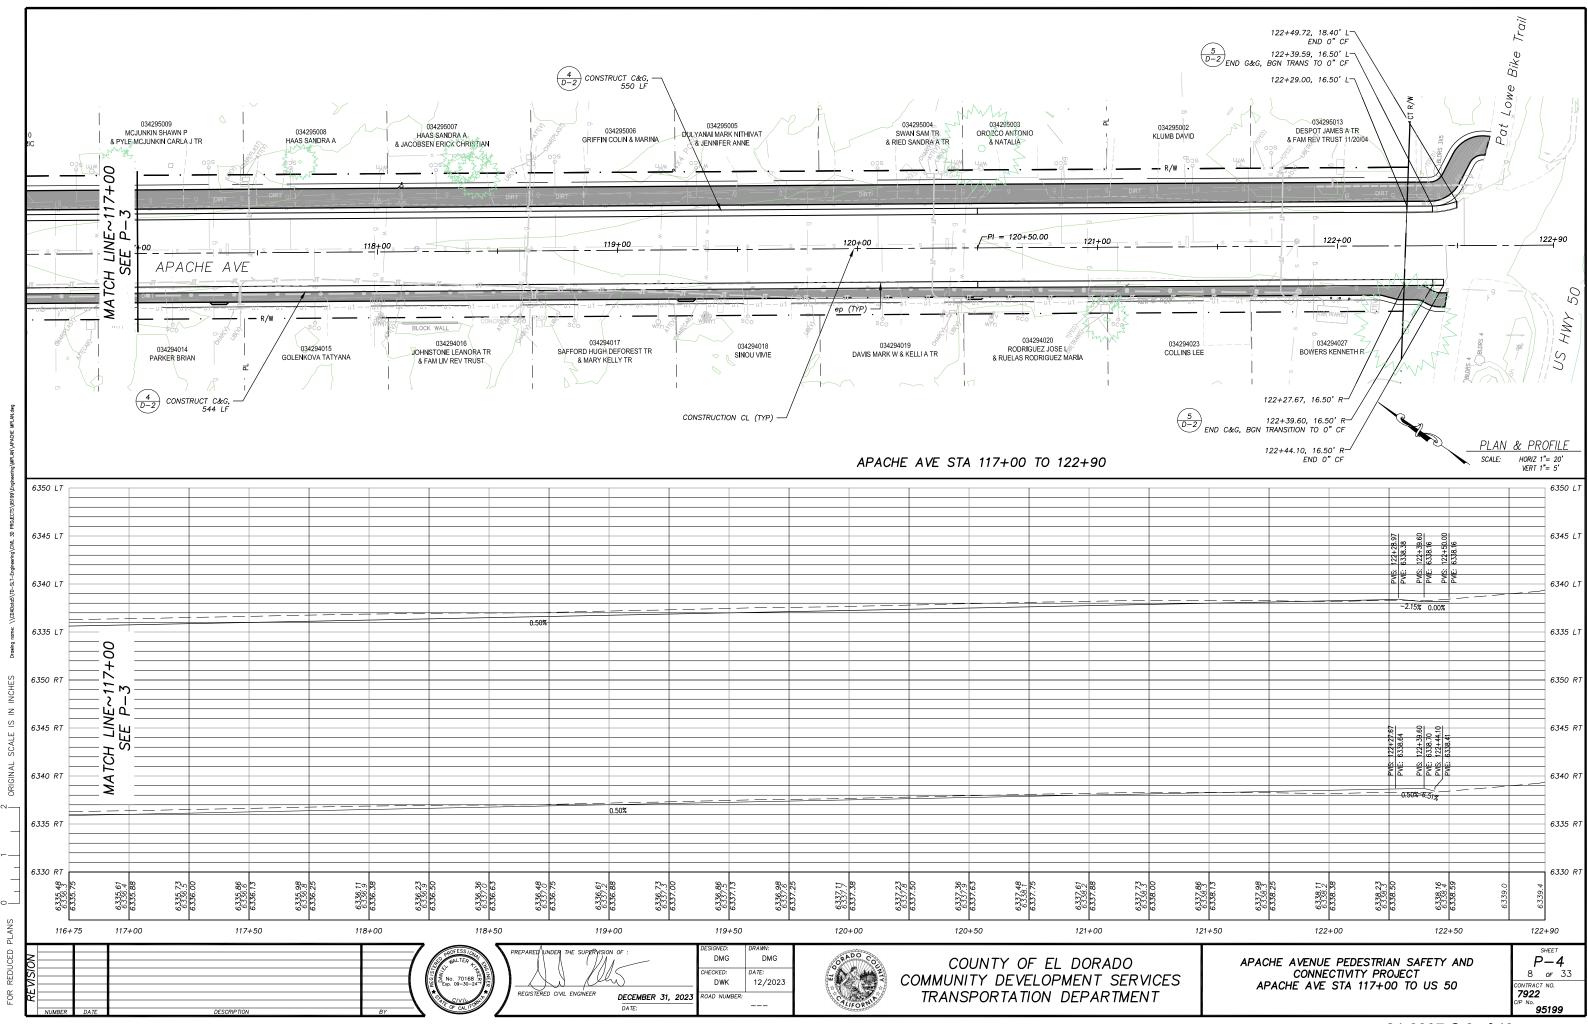


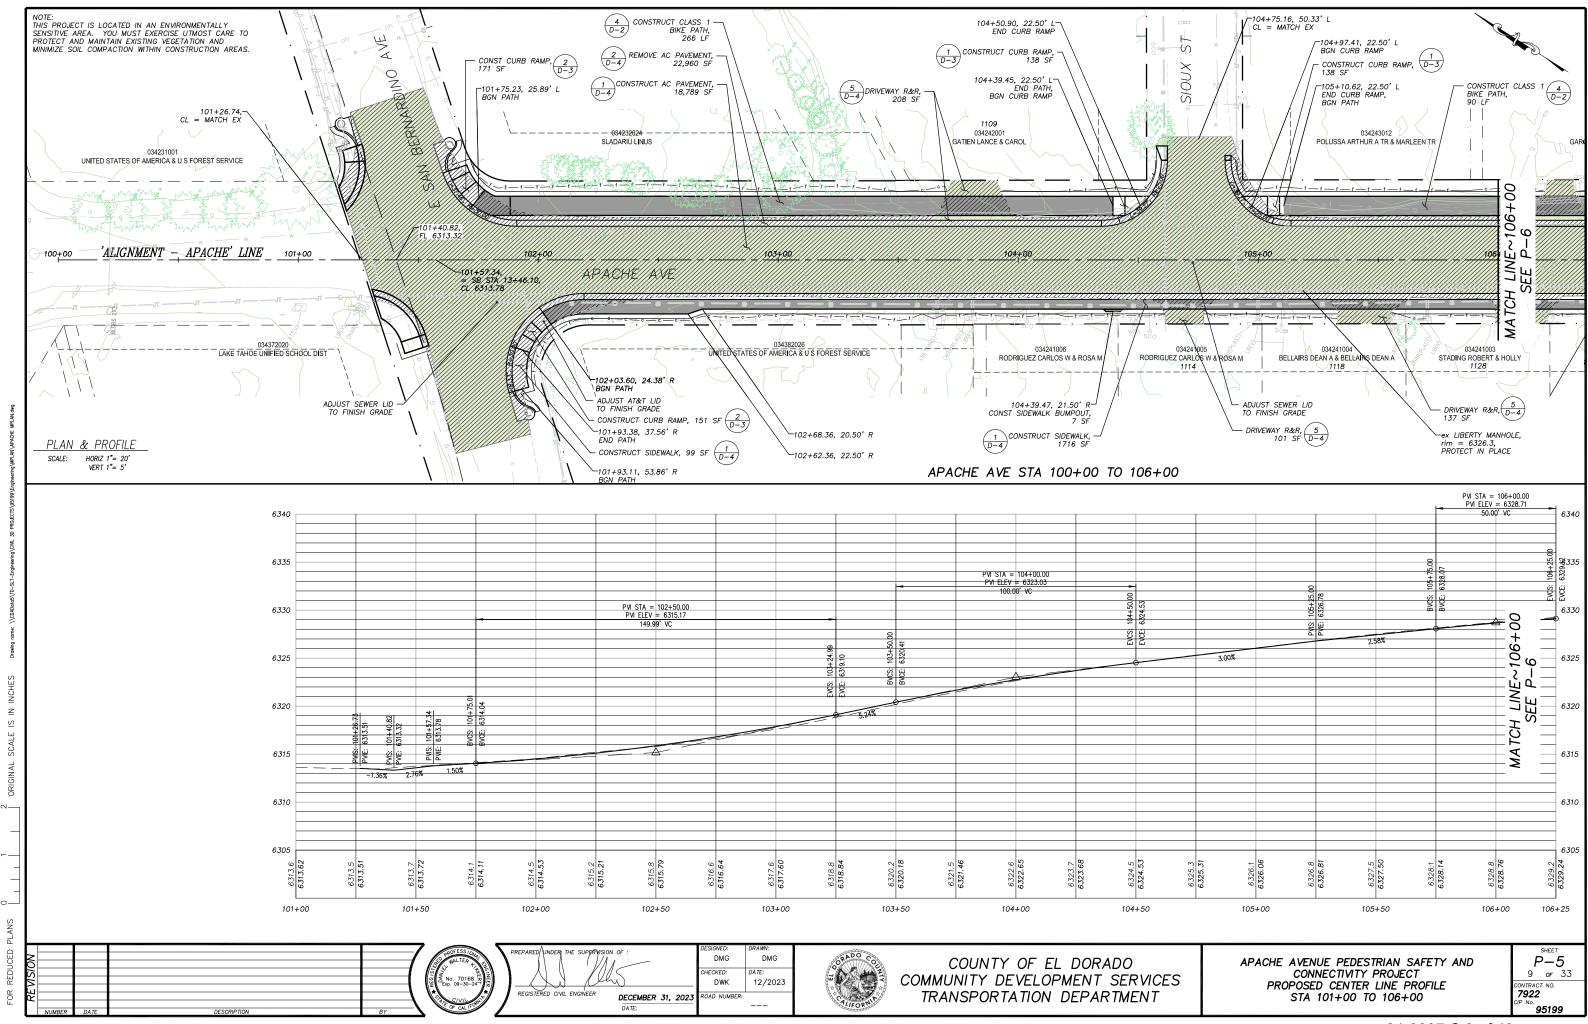


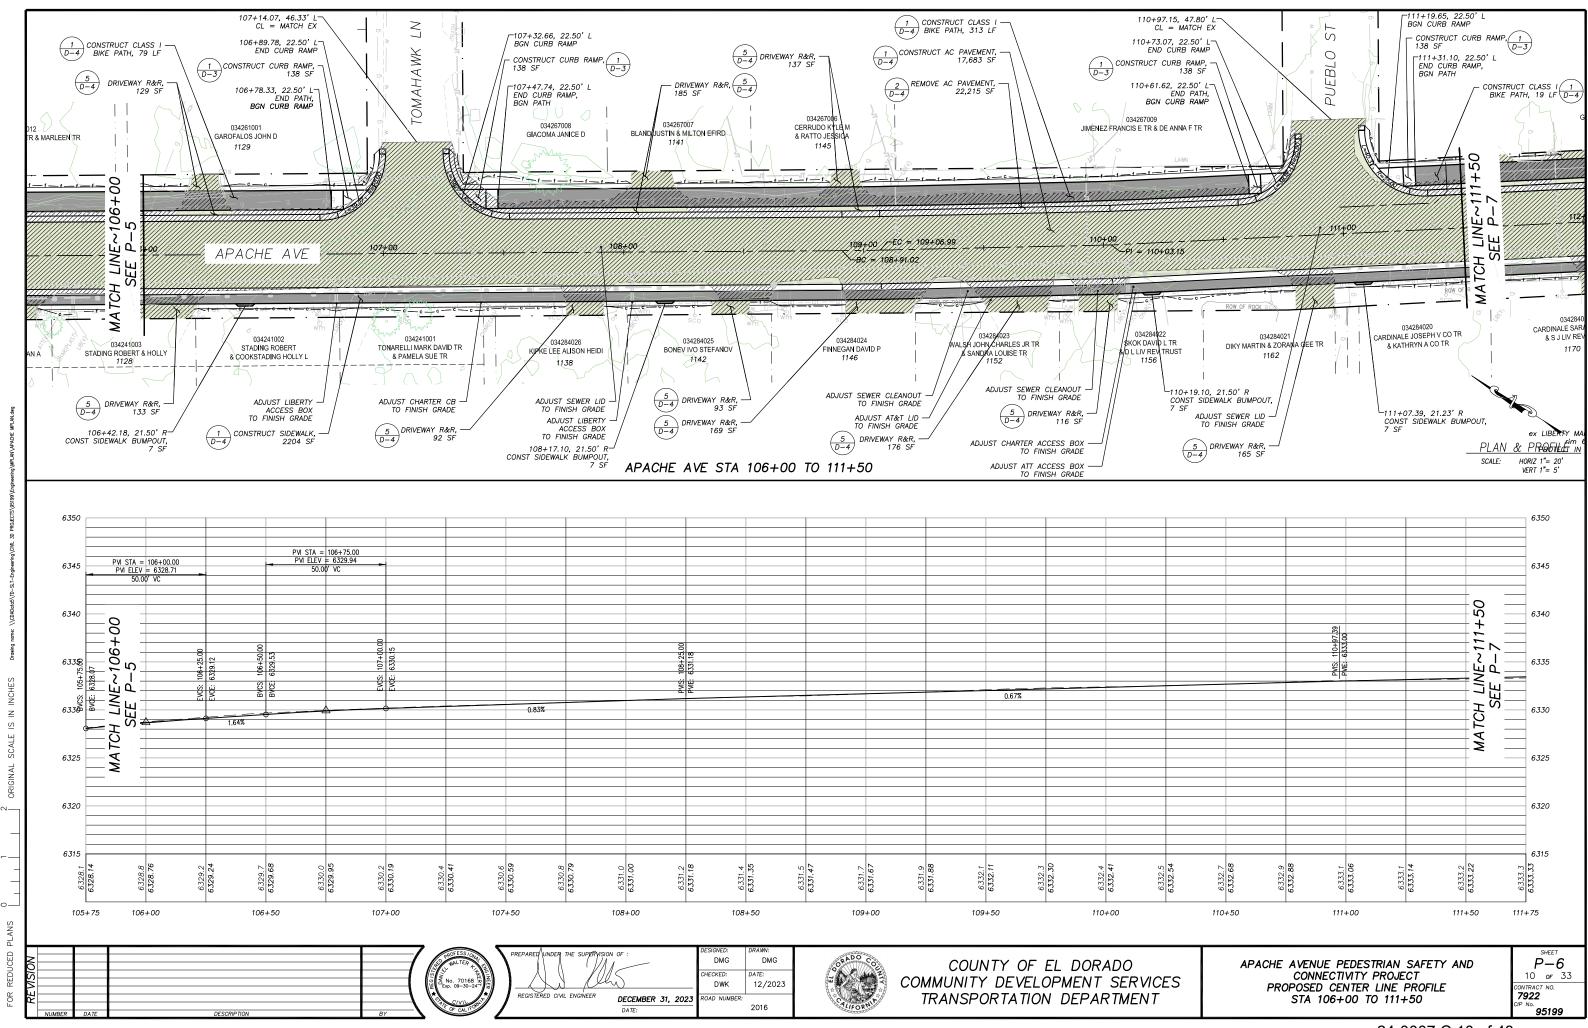


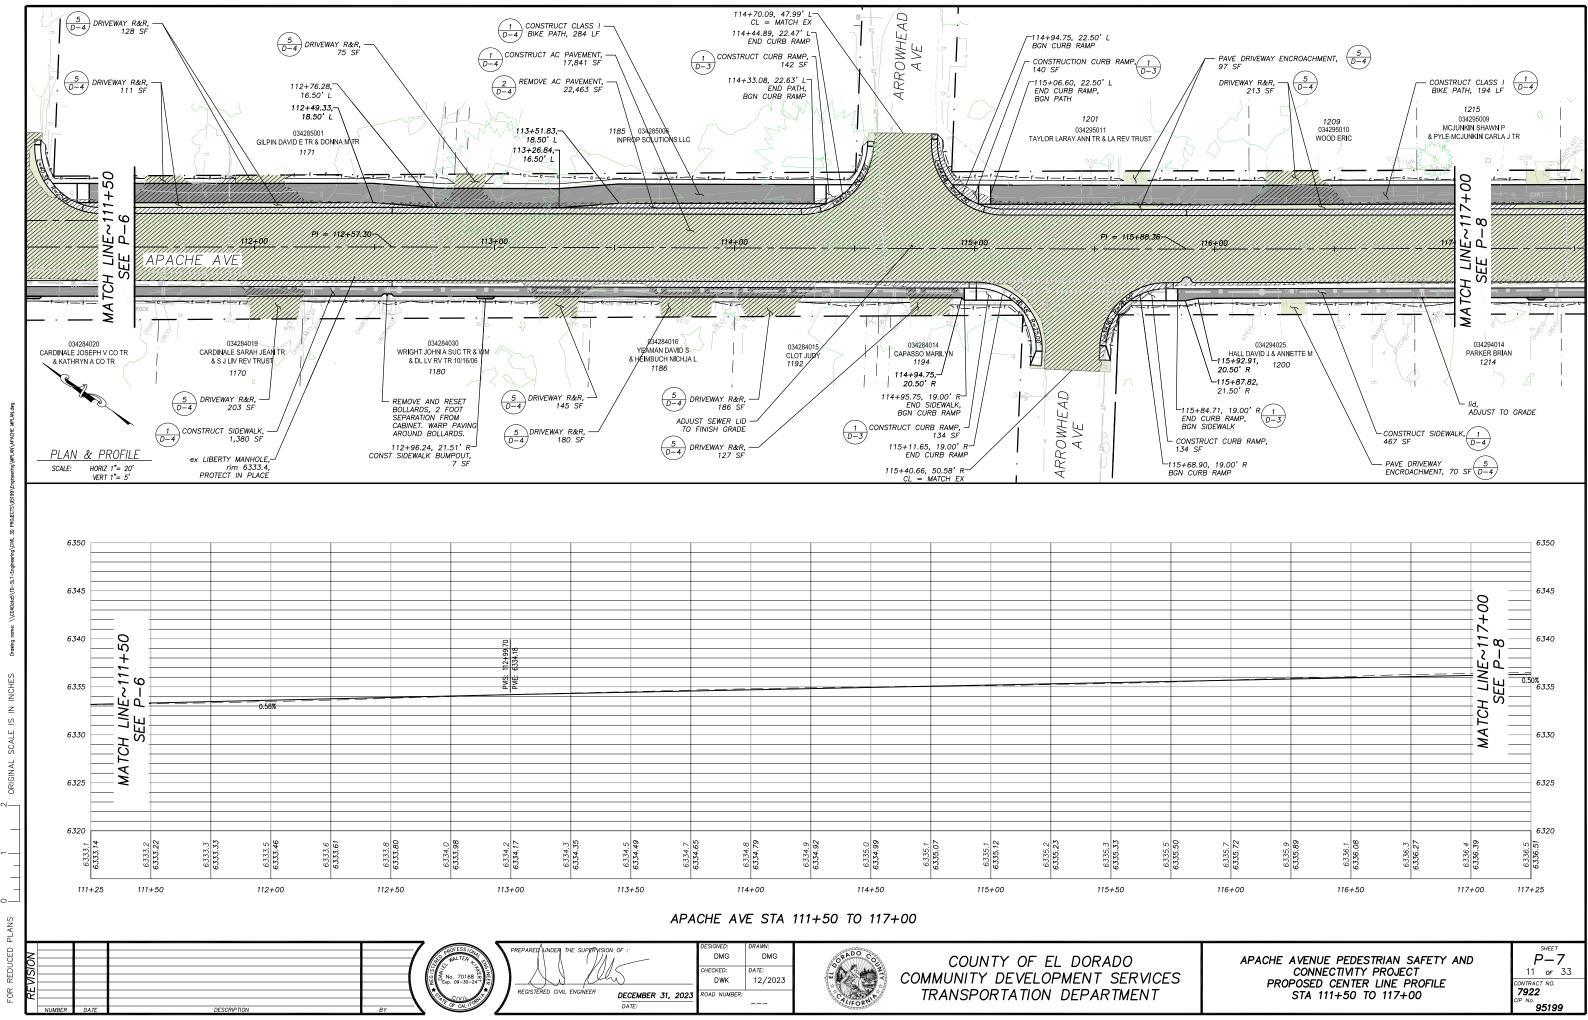


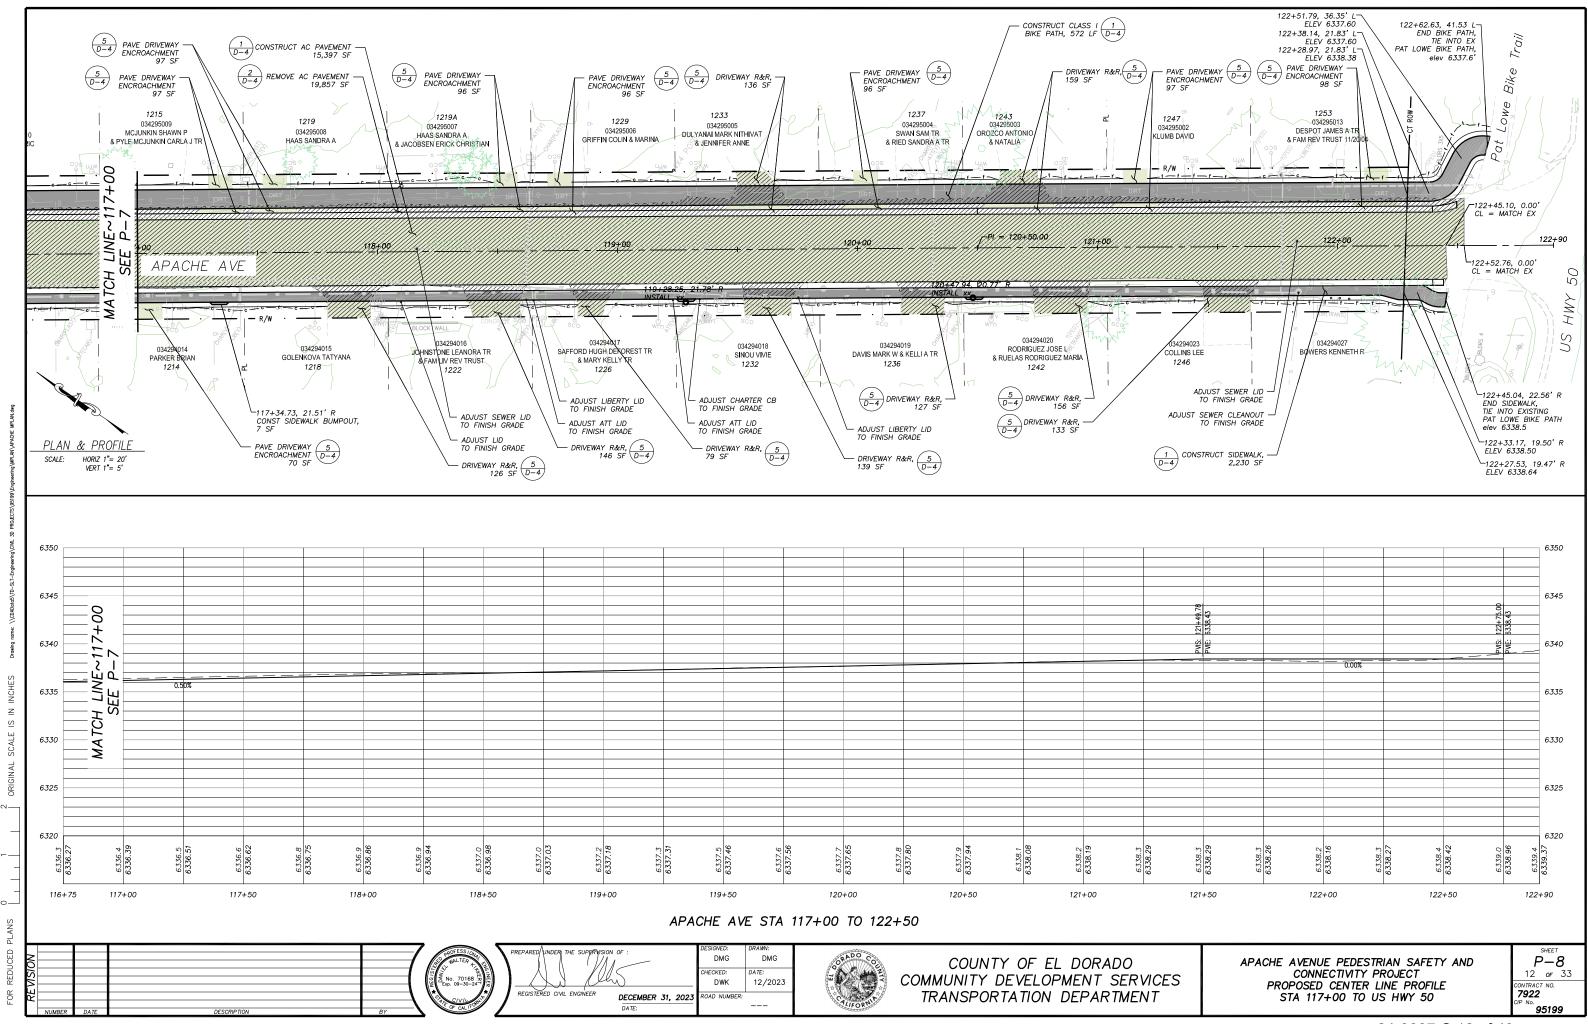


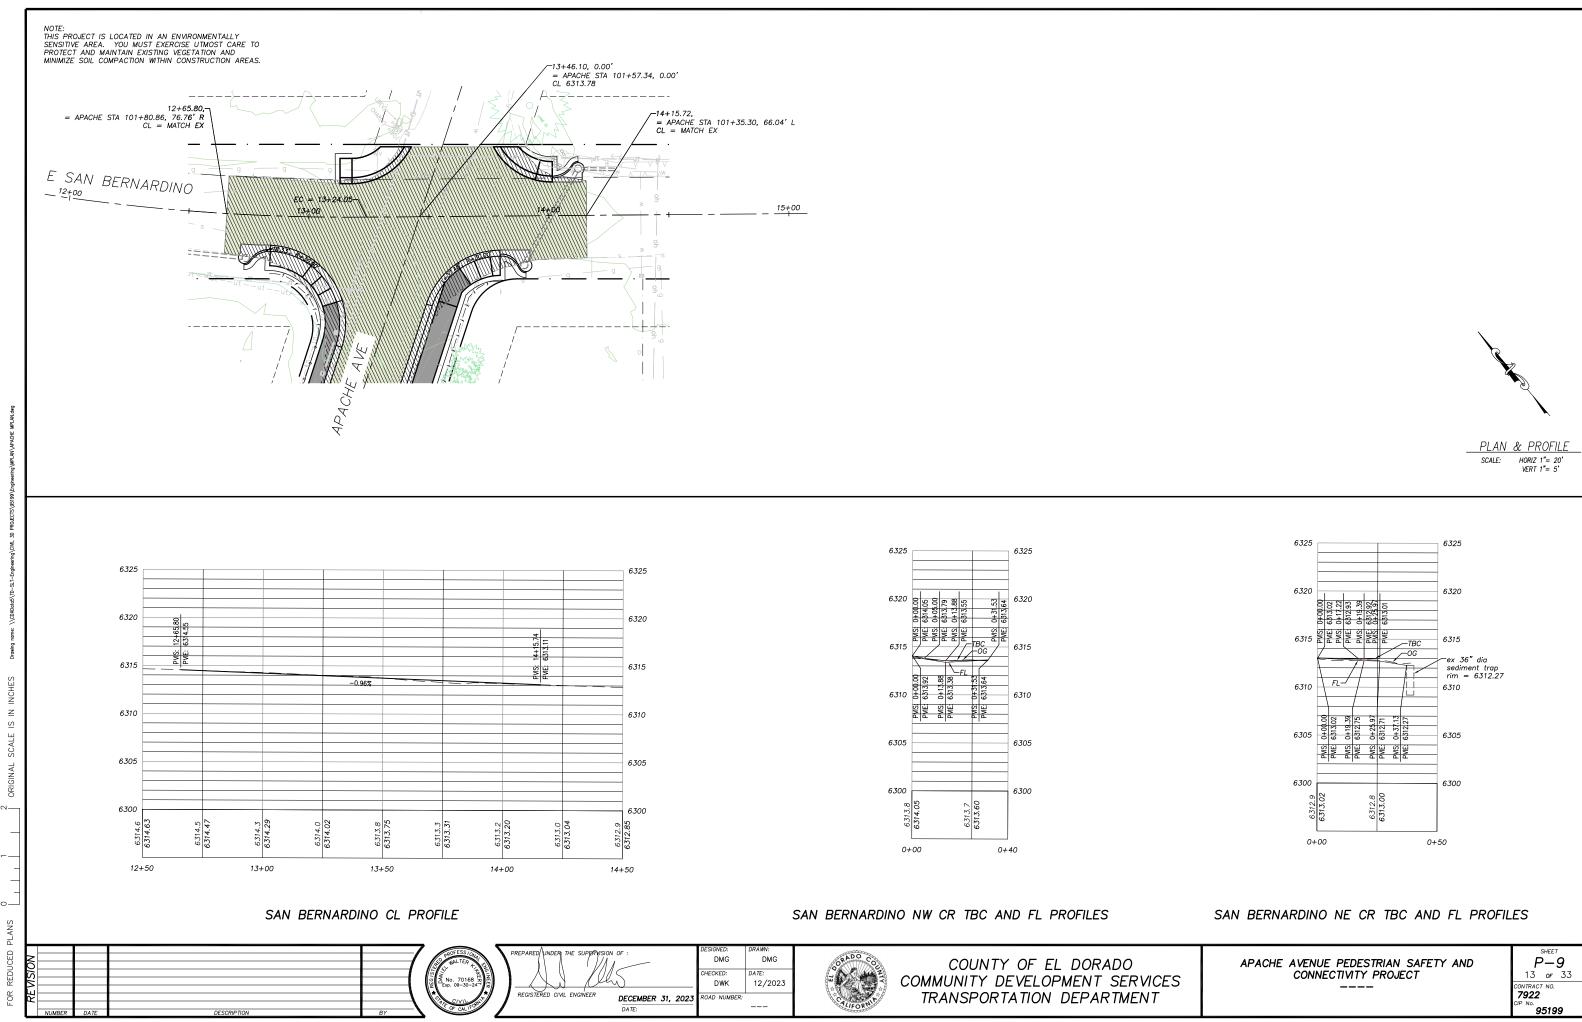

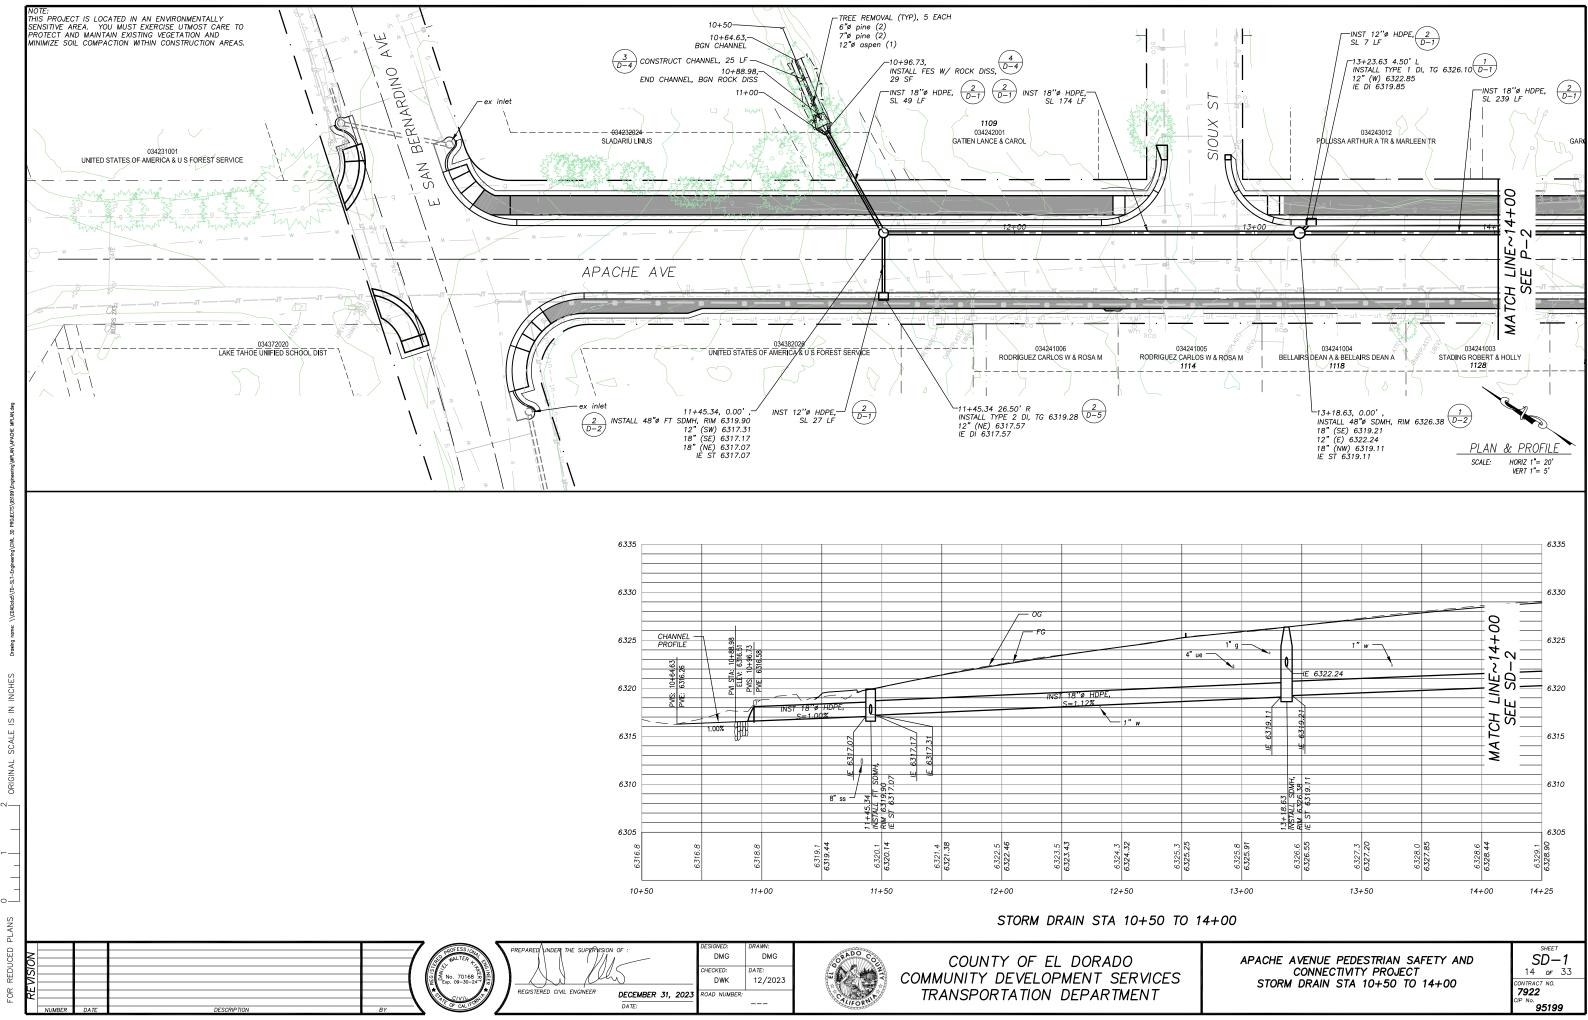

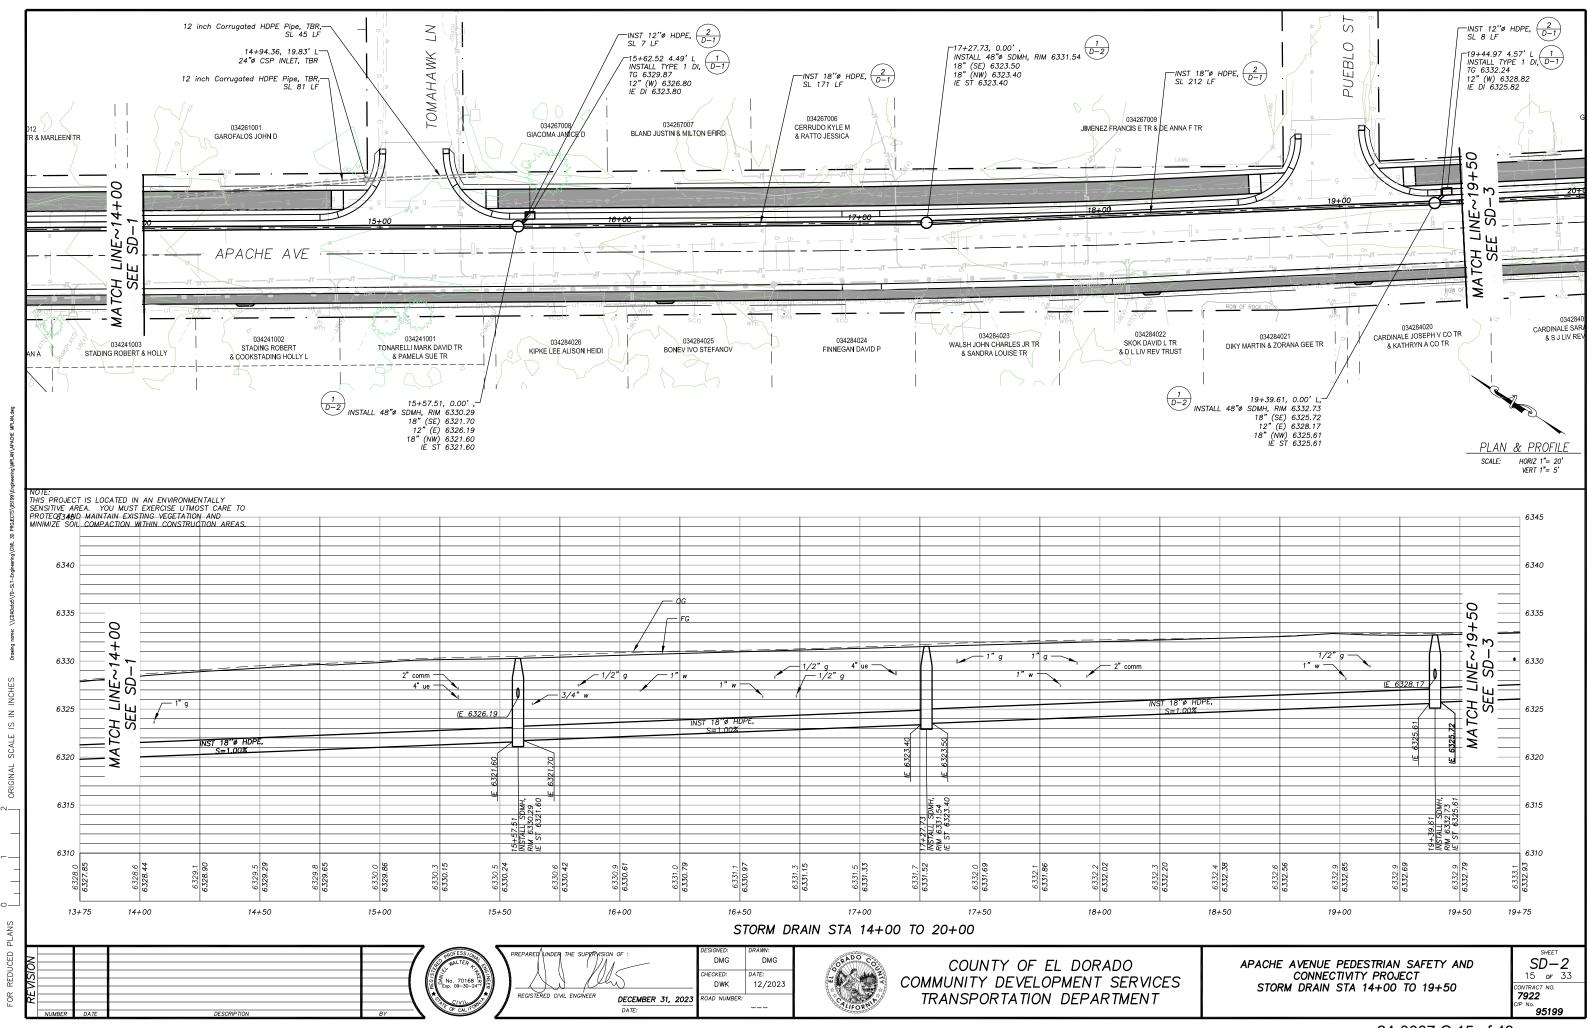

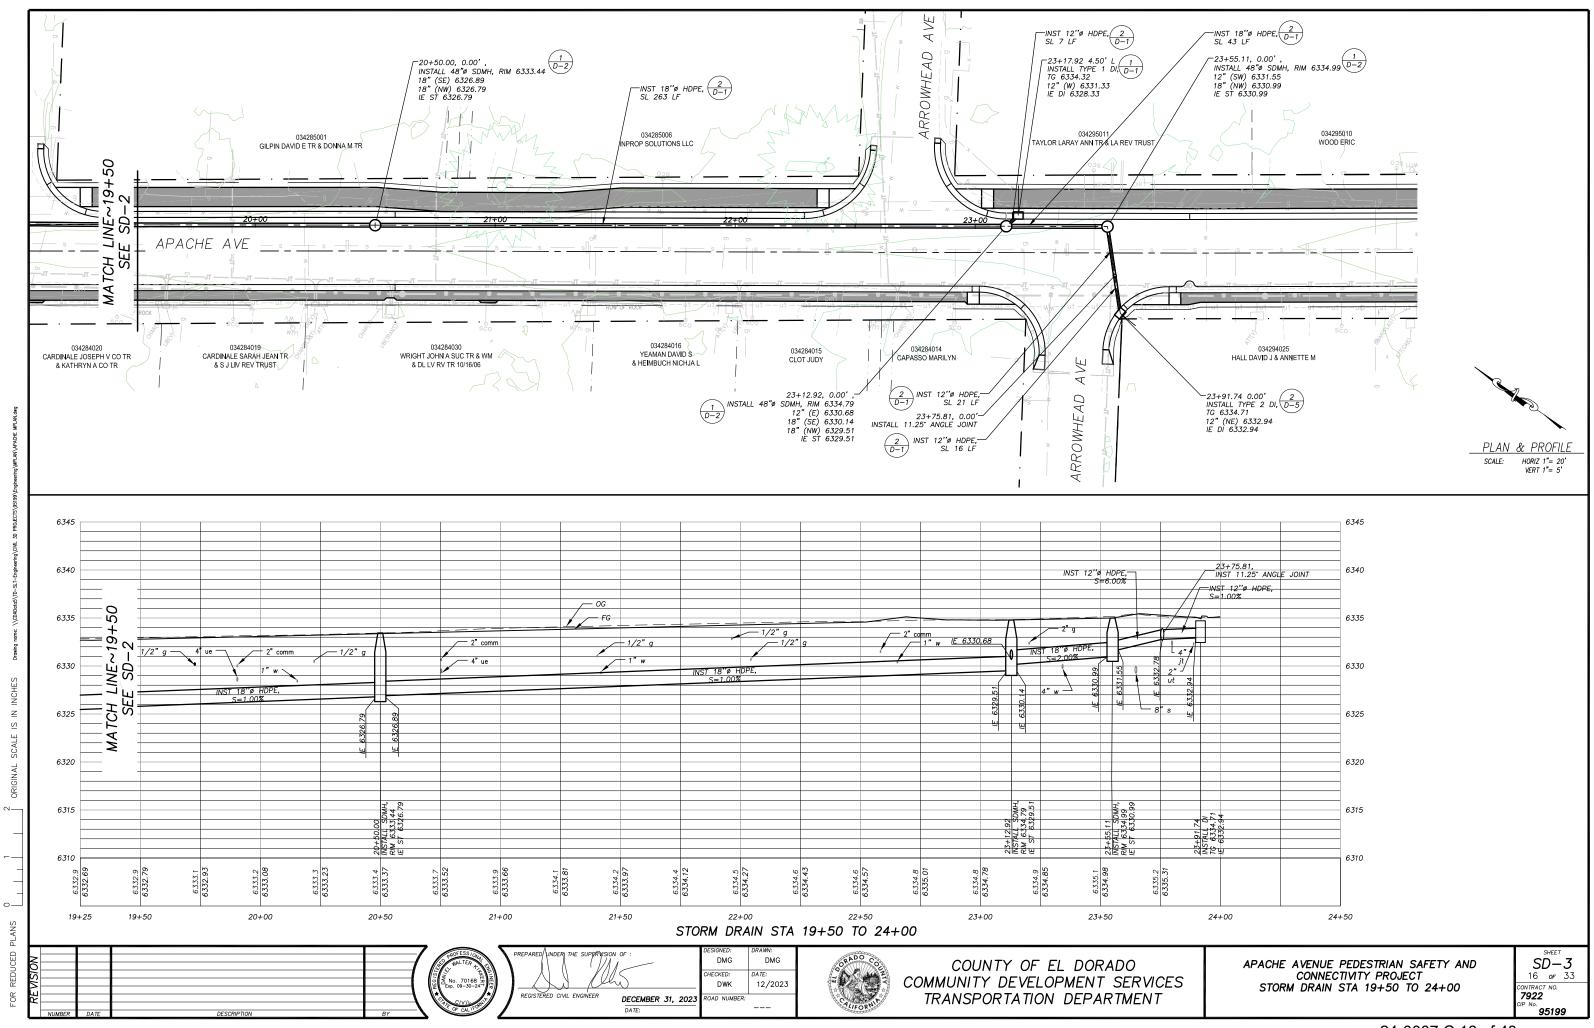

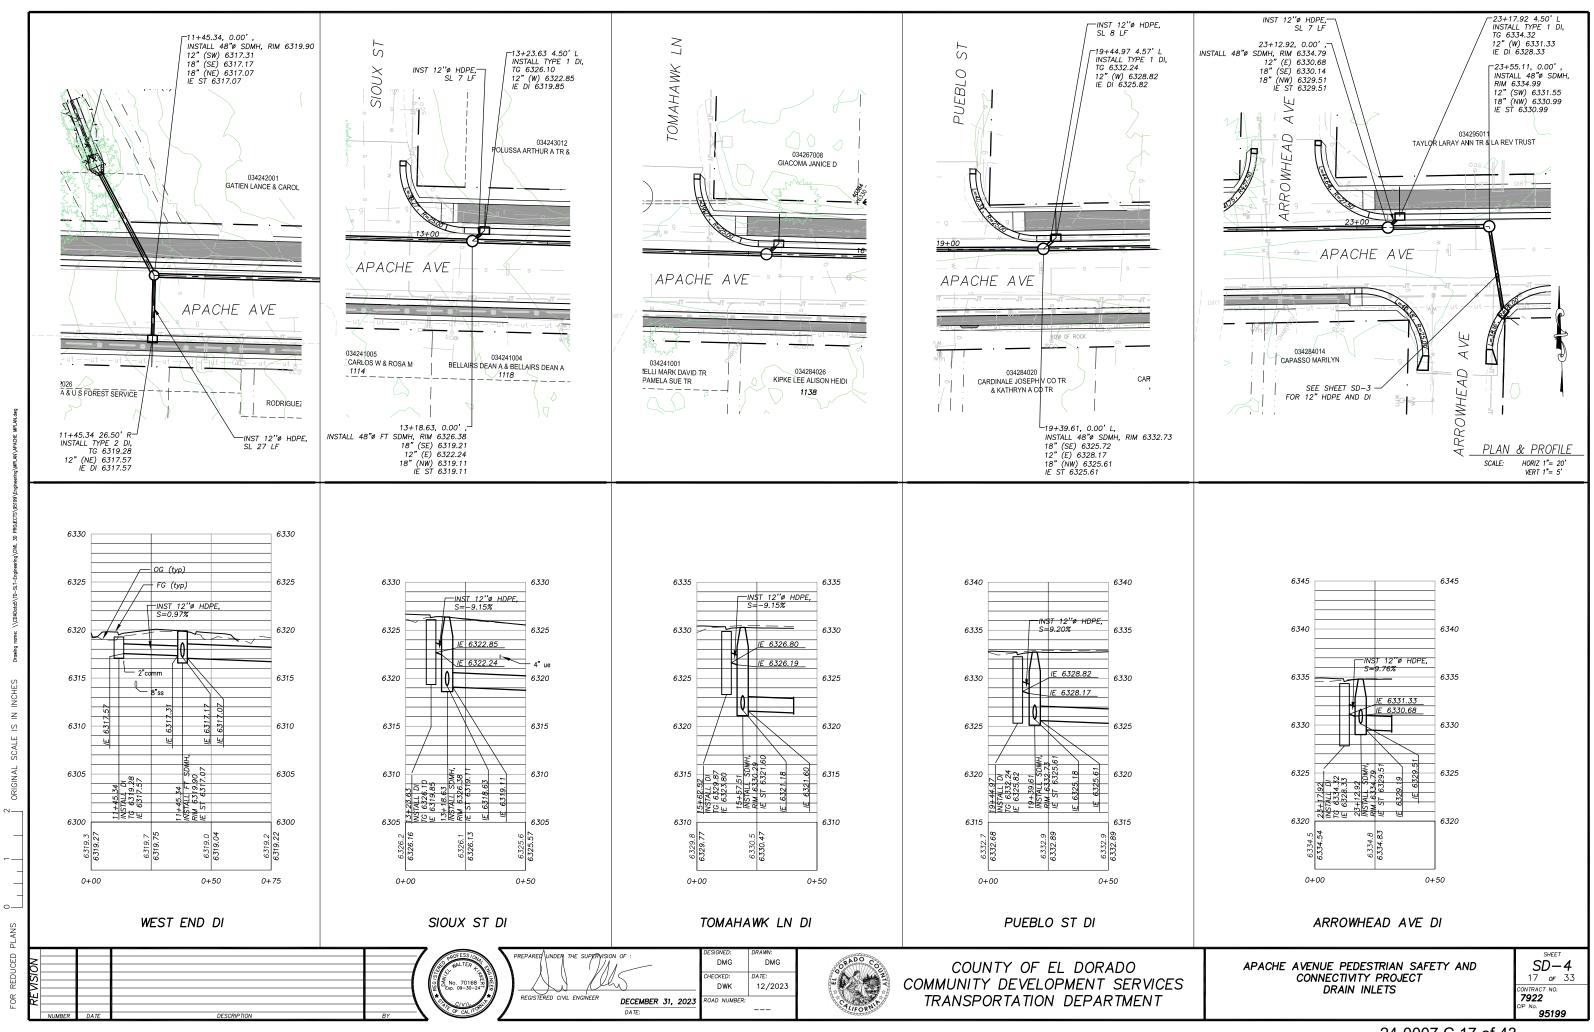

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Į,	NUMBER	DATE	DESCRIPTION	BY

				APACHE A	AVENUE PI	EDESTRIAN	SAFETY	AND CON	NECTIVITY	PROJECT	QUANTITIE	ES				
PLAN SHEET NO.	STATION	CURB & GUTTER	VALLEY GUTTER	CROSSWALK LANDING	CURB OPENING	TYPE 1 CURB TRANS	TYPE 2 CURB TRANS	CURB RAMP	REMOVE AC PAVEMENT	AC PAVEMENT	CLASS 1 BIKE PATH	SIDEWALK	DRIVEWAY R&R	PAVE DRIVEWAY ENCROACHMENT	ADJUST ACCESS BOX	ADJUST FRAME AND LID
		LF	LF	SF	EA	EA	EA	SF	SF	SF	LF	SF	SF	SF	EA	EA
P-1	100+00 TO 106+00	832	47	356	3	1	1									
P-2	106+00 TO 111+50	1036				4										
P-3	111+50 TO 117+00	1027				2	2									
P-4	117+00 TO 122+90	1094														
P-5	100+00 TO 106+00							598	22960	18789	356	1822	446			3
P-6	106+00 TO 111+50							552	22328	17683	411	2232	1395		5	3
P-7	111+50 TO 117+00							550	22463	17841	478	1854	1368	167	1	2
P-8	117+00 TO 122+90								19857	15397	572	2251	1201	747	7	2
	TOTALS	3989	47	356	3	7	3	1700	87608	69710	1817	8159	4410	914	13	10

P1 - P8 QUANTITIES

1. CURB RAMP QUANTITY INCLUDES VALLEY GUTTER AND CURB TRANSITION LIMITS.


- 2. CLASS 2 AGGREGATE BASE QUANTITIES INCLUDE SHOULDERS AND BASE UNDER CURB & GUTTER, SIDEWALK, AND CLASS 1 BIKE PATH.
- 3. QUANTITY FOR ROCK SLOPE PROTECTION (60 LB, CLASS III, METHOD A) IS INCLUDED IN ROCK ENERGY DISSIPATOR ON SHEET SD-1.
- 4. [N] NOT A SEPARATE PAY ITEM, FOR INFORMATION ONLY.


	APACHE AVENUE PEDESTRIAN SAFETY AND CONNECTIVITY PROJECT QUANTITIES									
PLAN SHEET NO.	STATION	12" HDPE SD PIPE	18" HDPE SD PIPE	DI — TYPE 1	DI – TYPE 2 (NO HOOD)	48" DIA SD MH	48" FLAT TOP SD MH	CHANNEL	FES	RSP
		LF	LF	EA	EA	EA	EA	LF	EA	SF
SD-1	100+00 TO 106+00	34	462	1	1	1	1	25	1	29
SD-2	106+00 TO 111+50	14	383	2		3				
SD-3	111+50 TO 117+00	44	306	1	1	3				
	TOTALS	92	1151	4	2	7	1	25	1	29


SD-1 TO SD-3 QUANTITIES


	DESIGNED:	DRAWN:	
	DMG	DMG	l
	CHECKED:	DATE:	
	DWK	12/2023	
2023	ROAD NUMBER:		

COUNTY OF EL DORADO COMMUNITY DEVELOPMENT SERVICES TRANSPORTATION DEPARTMENT APACHE AVENUE PEDESTRIAN SAFETY AND
CONNECTIVITY PROJECT
P AND SD SHEET QUANTITIES

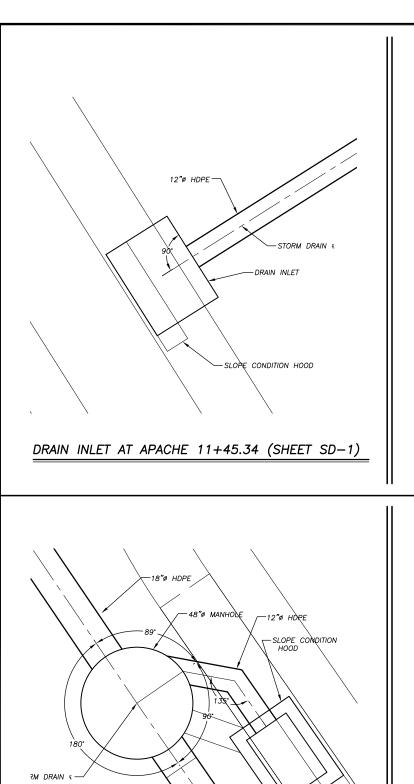

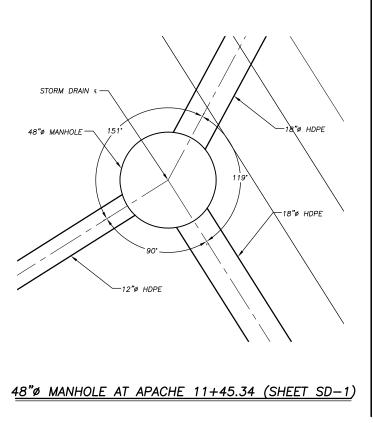

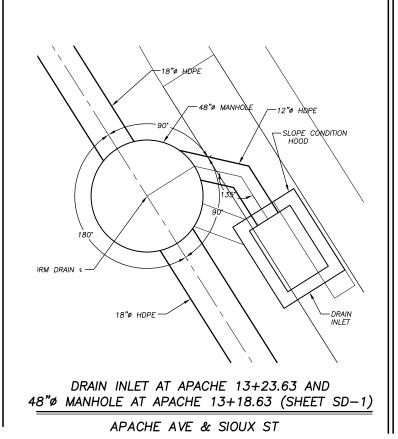

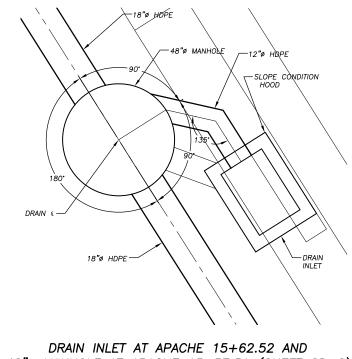


48" MANHOLE AT APACHE 15+57.51 (SHEET SD-2)


APACHE AVE & TOMAHAWK LN

18"ø HDPE-

DRAIN INLET AT APACHE 19+44.97 AND 48" MANHOLE AT APACHE 19+39.61 (SHEET SD-2) APACHE AVE & PUEBLO ST

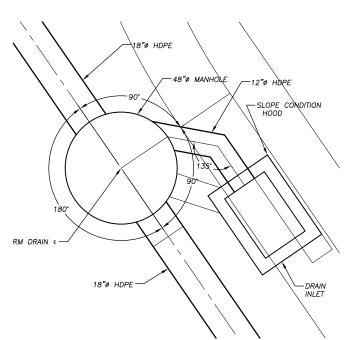

DRAIN INLET AT APACHE 23+17.92 AND 48" MANHOLE AT APACHE 23+12.92 (SHEET SD-3)

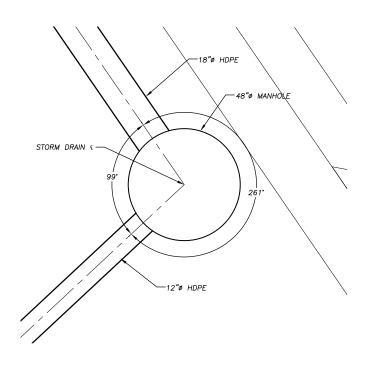

48" MANHOLE AT APACHE 23+55.11 (SHEET SD-3) APACHE AVE & ARROWHEAD AVE

DRAIN -INLET 12"ø HDPE-SUMP CONDITION. -STORM DRAIN *PIPE SHALL ENTER THROUGH FRONT FACE OF DI

DRAIN INLET AT APACHE 23+92.19 (SHEET SD-3)

APACHE AVE & ARROWHEAD AVE

PROFESSIONAL CENTRAL C	PREPARED UNDER THE SUPPRYISION OF :	_	DESIGNED: DMG	DRAWN: DMG
No. 70168 R	July Clas		CHECKED: DWK	DATE: 12/2023
CIVIL OF CALIFORNIA	REGISTÈRED CIVIL ENGINEER DECEM DATE:	BER 31, 2023	ROAD NUMBER:	


APACHE AVE & ARROWHEAD AVE




COUNTY OF EL DORADO COMMUNITY DEVELOPMENT SERVICES TRANSPORTATION DEPARTMENT


APACHE AVENUE PEDESTRIAN SAFETY AND CONNECTIVITY PROJECT HORIZONTAL CONTROL

HC-1 19 of 33 CONTRACT NO. **7922**

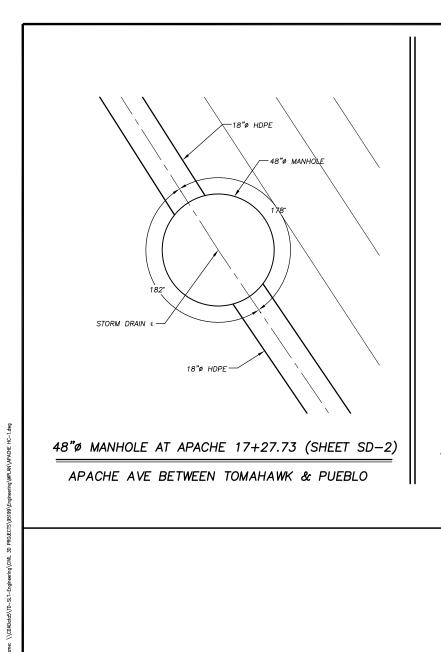

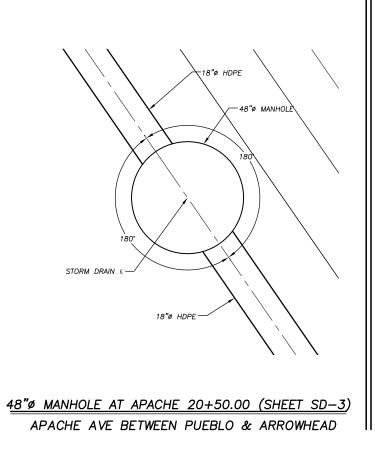




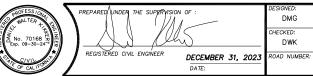






12/2023


COUNTY OF EL DORADO COMMUNITY DEVELOPMENT SERVICES TRANSPORTATION DEPARTMENT APACHE AVENUE PEDESTRIAN SAFETY AND CONNECTIVITY PROJECT HORIZONTAL CONTROL SHEET HC-2 20 of 33 CONTRACT NO. 7922 CIP No. 95199

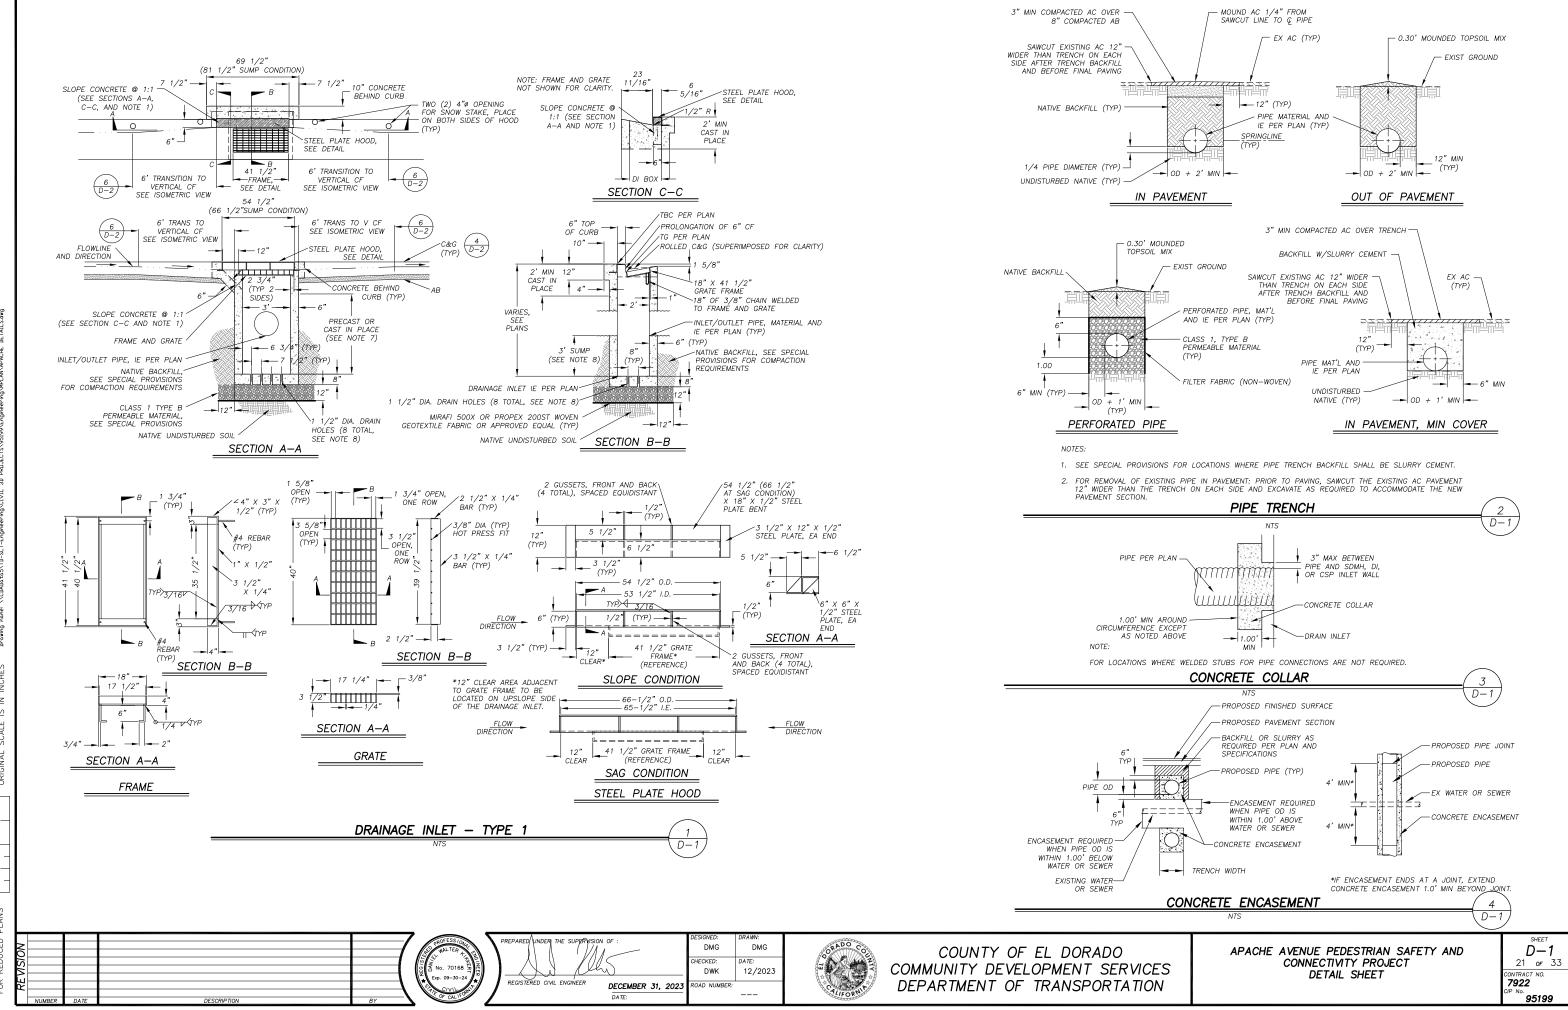


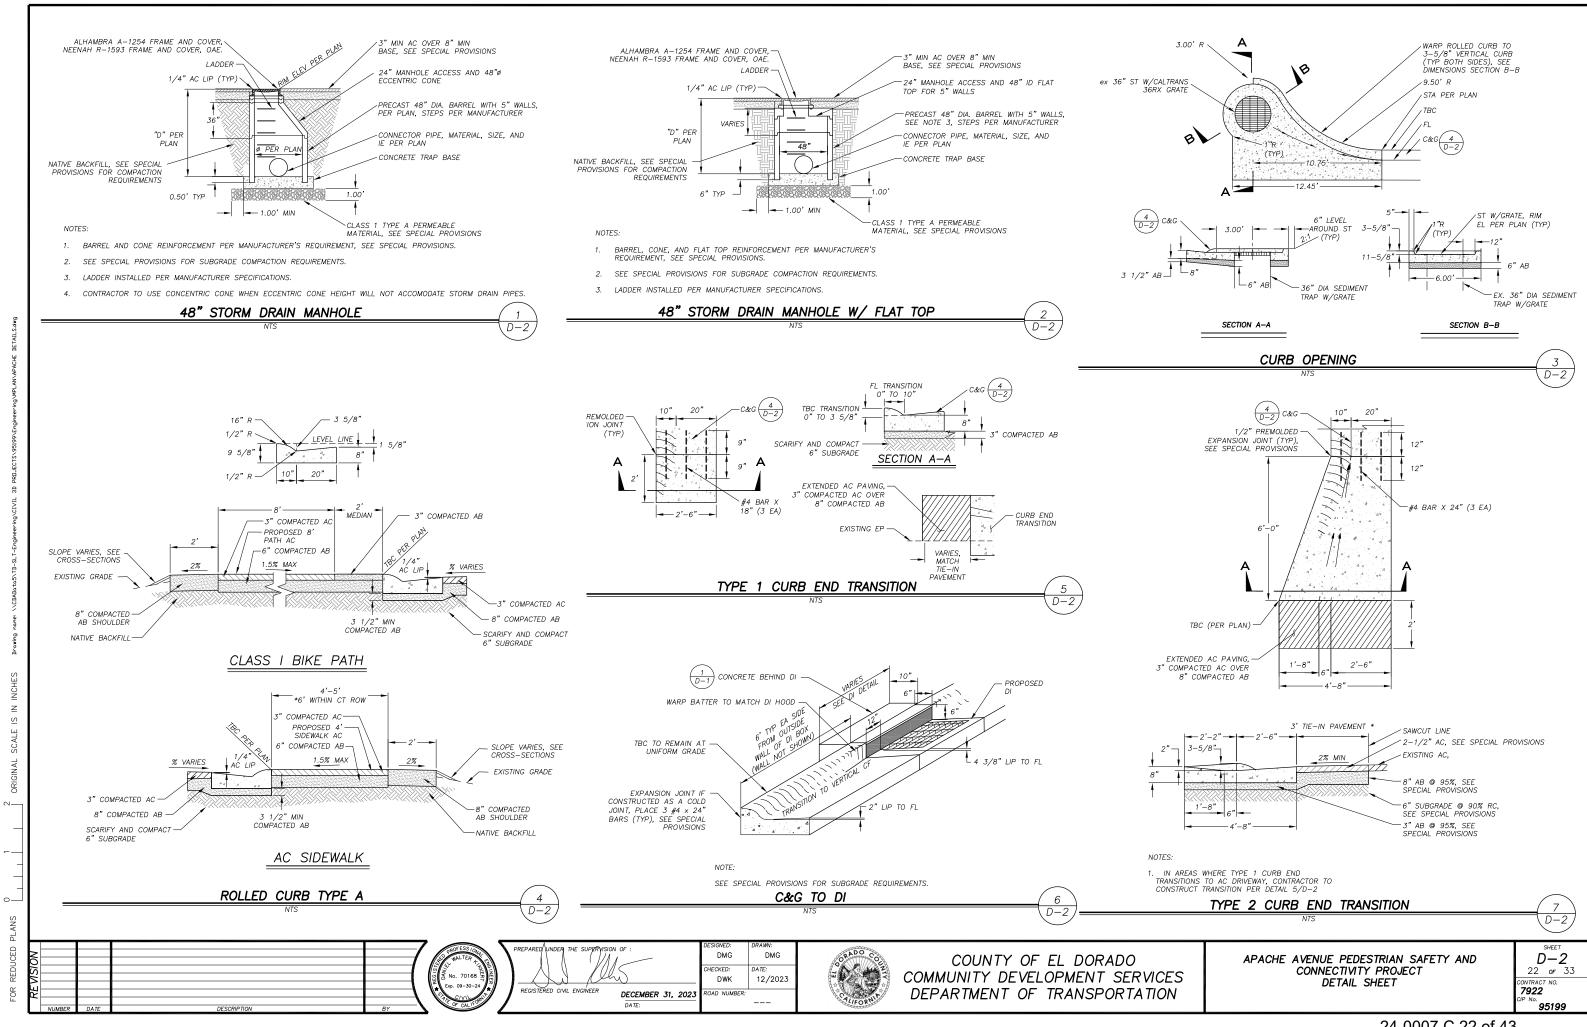

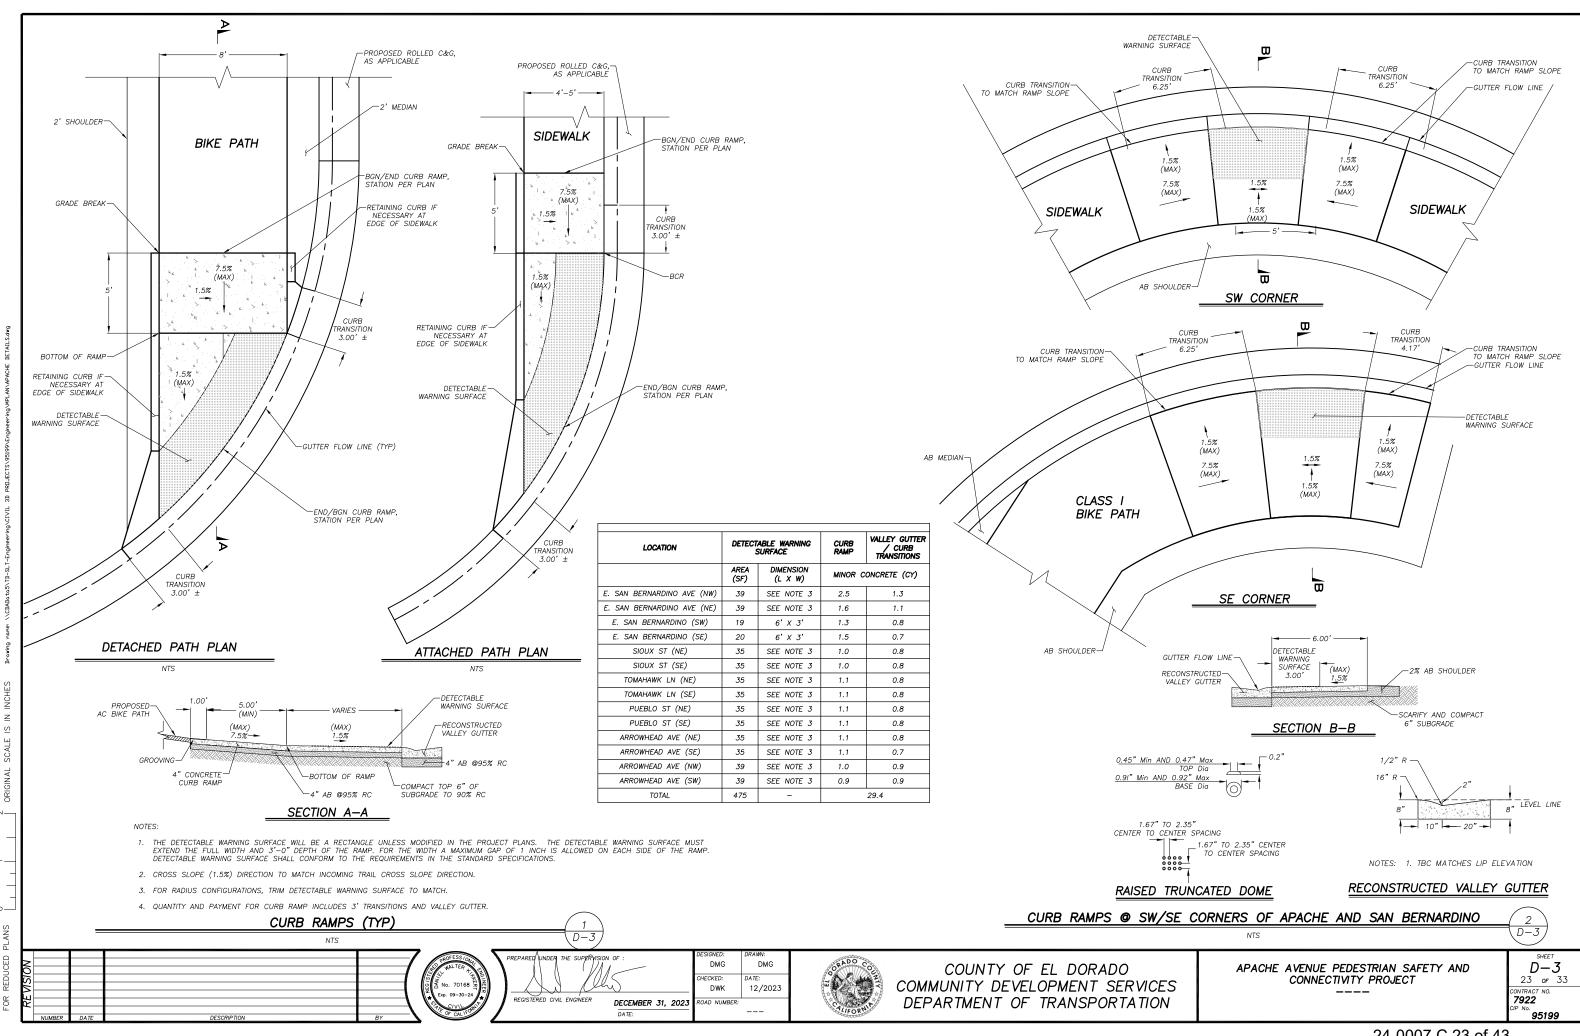

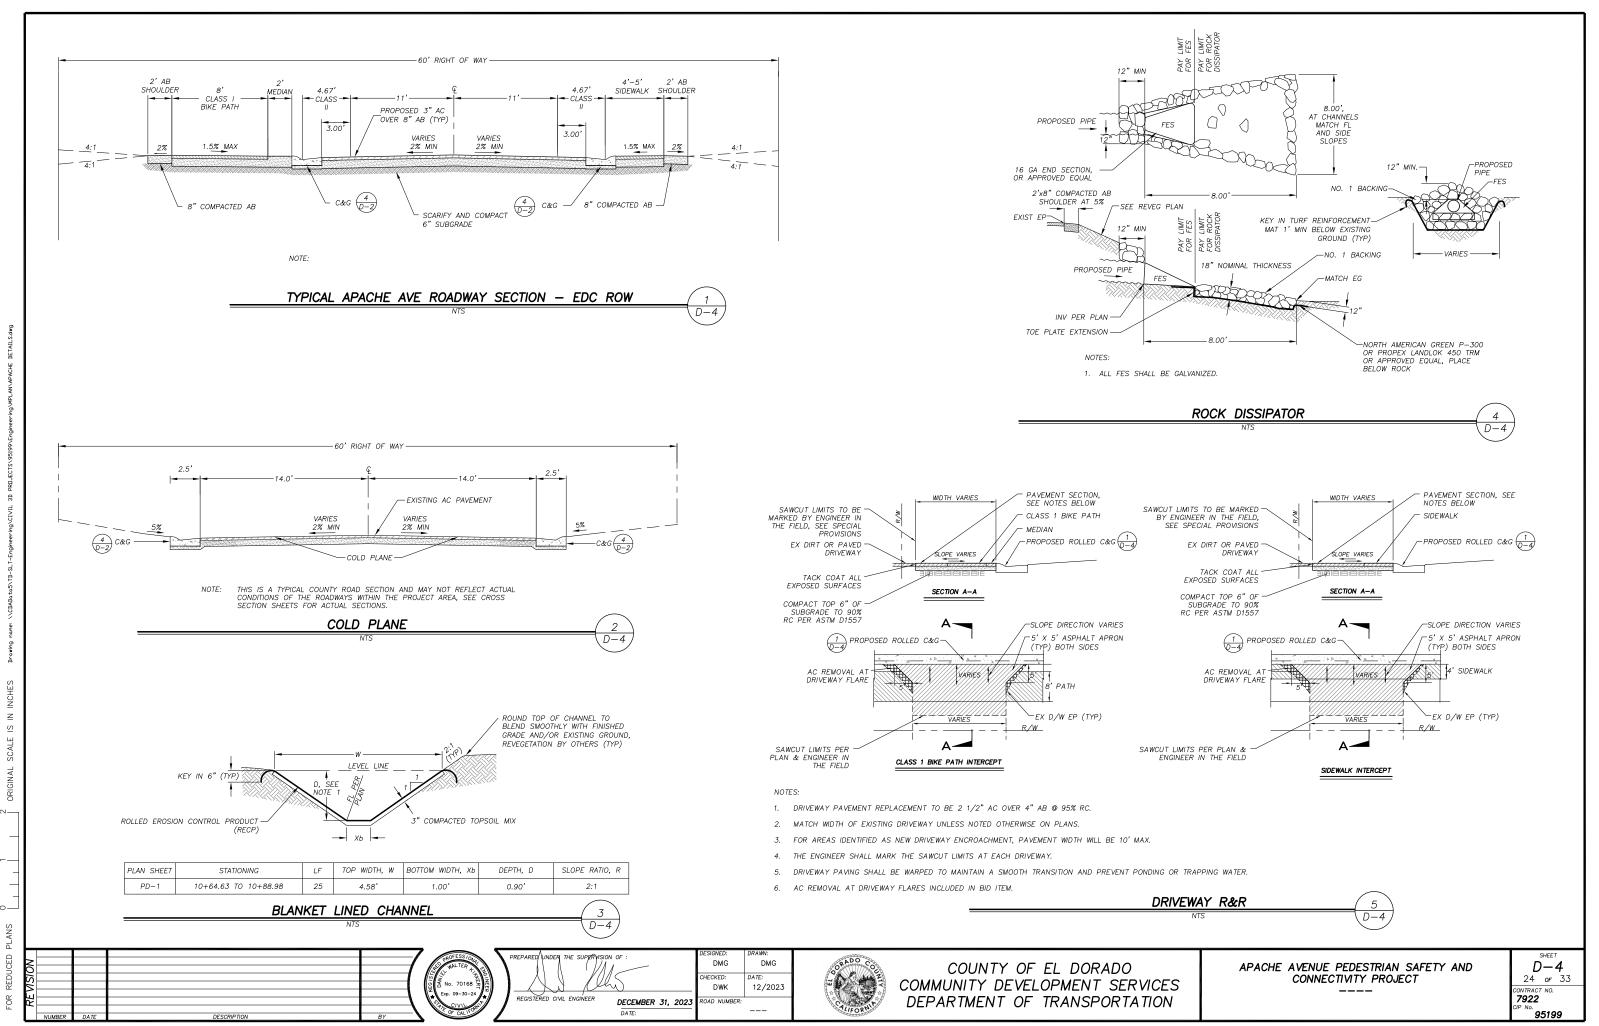

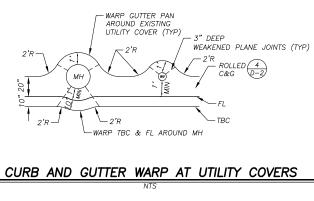

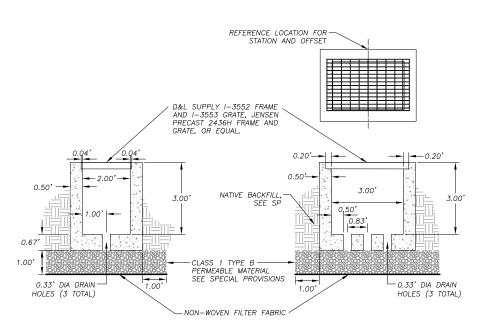

DRAINAGE INLET - TYPE 2









DMG

DWK

HECKED:


DMG

12/2023

COUNTY OF EL DORADO COMMUNITY DEVELOPMENT SERVICES DEPARTMENT OF TRANSPORTATION

APACHE AVENUE PEDESTRIAN SAFETY AND CONNECTIVITY PROJECT

D-525 of 33 CONTRACT NO. **7922** ^{P No.} 95199

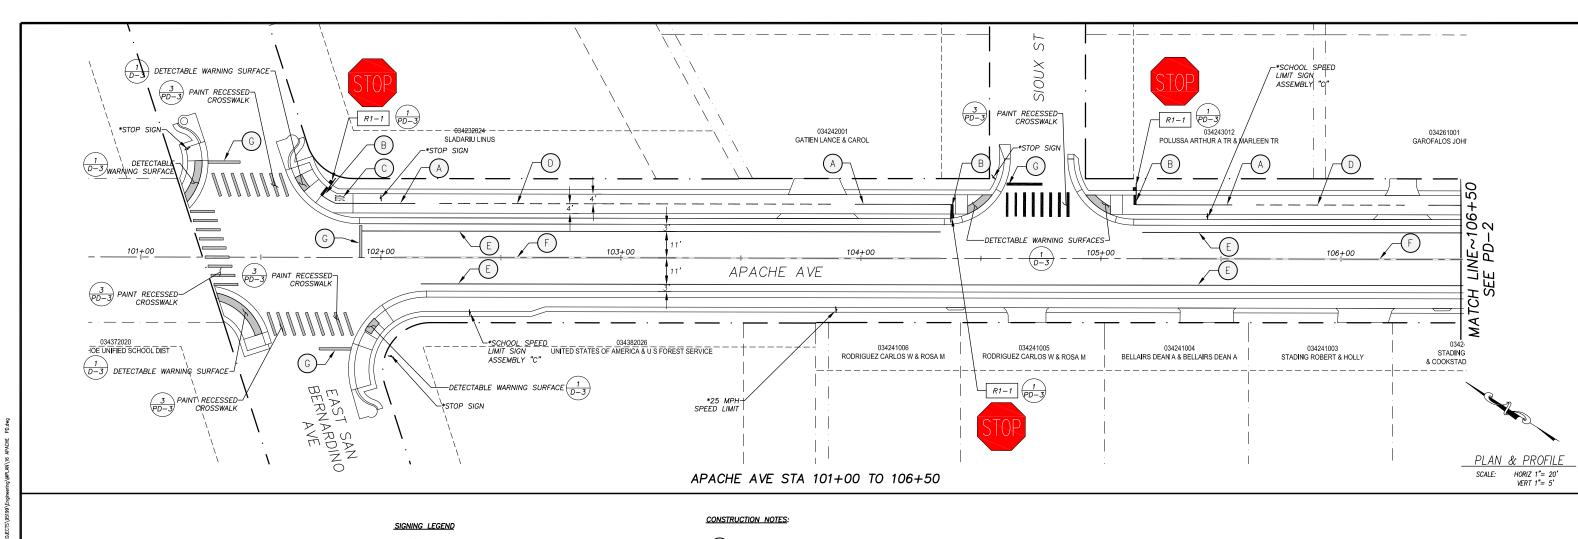

- SIGN NUMBER, SEE TABLE DETAILS

- EXIST SIGN - INSTALL SIGN

- INSTALL DOUBLE SIDED SIGN

- REMOVE AND REPLACE

NOTES: 1) FINISH ON BACK OF SIGN: MIDNIGHT GREEN ENDURA SHIELD IV, TNEMEC SEMIGLOSS HIGH BUILD ACRYLIC POLYURETHANE ENAMEL

2) ALL TRAFFIC CONTROL DEVICES SHALL BE IN ACCORDANCE WITH THE LATEST APPROVED CALIFORNIA MANUAL ON UNIFORM TRAFFIC CONTROL DEVICES (CA MUTCD).

3) ASTM DESIGNATION APPLIES TO ALL COLORS ON SIGN OR RAIL. BLACK SHALL BE NON-REFLECTIVE.

4) HIGH INTENSITY MICROPRISMATIC (HIP) FILM, ASTM 4956 REQUIRED IN COUNTY RIGHT OF WAY

	ROADWAY AND BIKE PATH SIGNS									
SIGN DESIGNATION	SIGN MESSAGE AND DESCRIPTION	SIGN SIZE	QTY	SIGN COLORS	RETROREFLECTIVE ASTM TYPE					
R1-1	"STOP" SIGN	18"x18"	2	WHITE ON RED	HIP III, IV					
W5-4A	"BIKEWAY NARROWS" SIGN	18"x18"	10	BLACK ON YELLOW	HIP III, IV					
R44A (CA)	"NO MOTOR VEHICLES" SIGN	12"x24"	1	BLACK ON WHITE	III					

— 4" SOLID YELLOW STRIPE PAINTED PER DIMENSIONS SHOWN

- 1' WIDE X 4' WHITE PAINTED LIMIT LINE PER CALTRANS RSP A24E

- "STOP" PAVEMENT MARKING (H=48", W=38") PER CALTRANS RSP A24D (SIZE) PLACE 5' & FROM LIMIT LINE

- DASHED CENTERLINE STRIPING PER CAMUTCD FIG 9C-2

- 6" SOLID WHITE EDGELINE STRIPING PER STD PLANS A20B (DETAIL 27B)

- 6" DBL YELLOW LINE PER STD PLANS A20A (DETAIL 21)

— 1' WIDE X 14' WHITE PAINTED LIMIT LINE PER CALTRANS RSP A24E

PATH PAVEMENT STRIPING							
TYPE	SHEET	SPRAYABLE PAINT					
1		YELLOW					
		FT					
SOLID YELLOW STRIPING	PD-1	134					
	PD-2	226					
\bigcirc	PD-3	39					
BROKEN YELLOW	PD-1	225					
CENTERLINE STRIPING (D)	PD-2	671					
	PD-3	392					
	TOTAL	1,687					

DMG

DWK

OAD NUMBER

HECKED:

DMG


12/2023

ROADWAY PAVEMENT STRIPING								
TYPE	SHEET	SPRAYABLE PAINT						
		FT						
SOLID YELLOW STRIPING	PD-1	722						
(F	PD-2	1,710						
	PD-3	854						
SOLID WHITE	PD-1	807						
EDGELINE STRIPING (E) PD-2	2,019						
	PD-3	845						
	TOTAL	6,957						

PAVEMENT MARKINGS					
SYMBOL DESCRIPTION	QUANTITY (EA)	AREA (SF)	TOTAL AREA (SF)		
CROSSWALK (E. SAN BERNARDINO AVE)	03	90	270		
CROSSWALK (SIOUX ST)	01	80	80		
CROSSWALK (TOMAHAWK LN)	01	90	90		
CROSSWALK (PUEBLO ST)	01	90	90		
CROSSWALK (ARROWHEAD AVE)	02	90	180		
LIMIT LINES — ROADWAY	08	13.3	106.4		
LIMIT LINES — PATH	10	4	40		
TOTAL			856.4		

APPROVED FOR PAVEMENT DELINEATION AND SIGN WORK ONLY




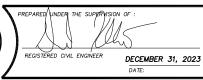






COUNTY OF EL DORADO COMMUNITY DEVELOPMENT SERVICES TRANSPORTATION DEPARTMENT


APACHE AVENUE PEDESTRIAN SAFETY AND CONNECTIVITY PROJECT PAVEMENT DELINEATION AND SIGN PLAN

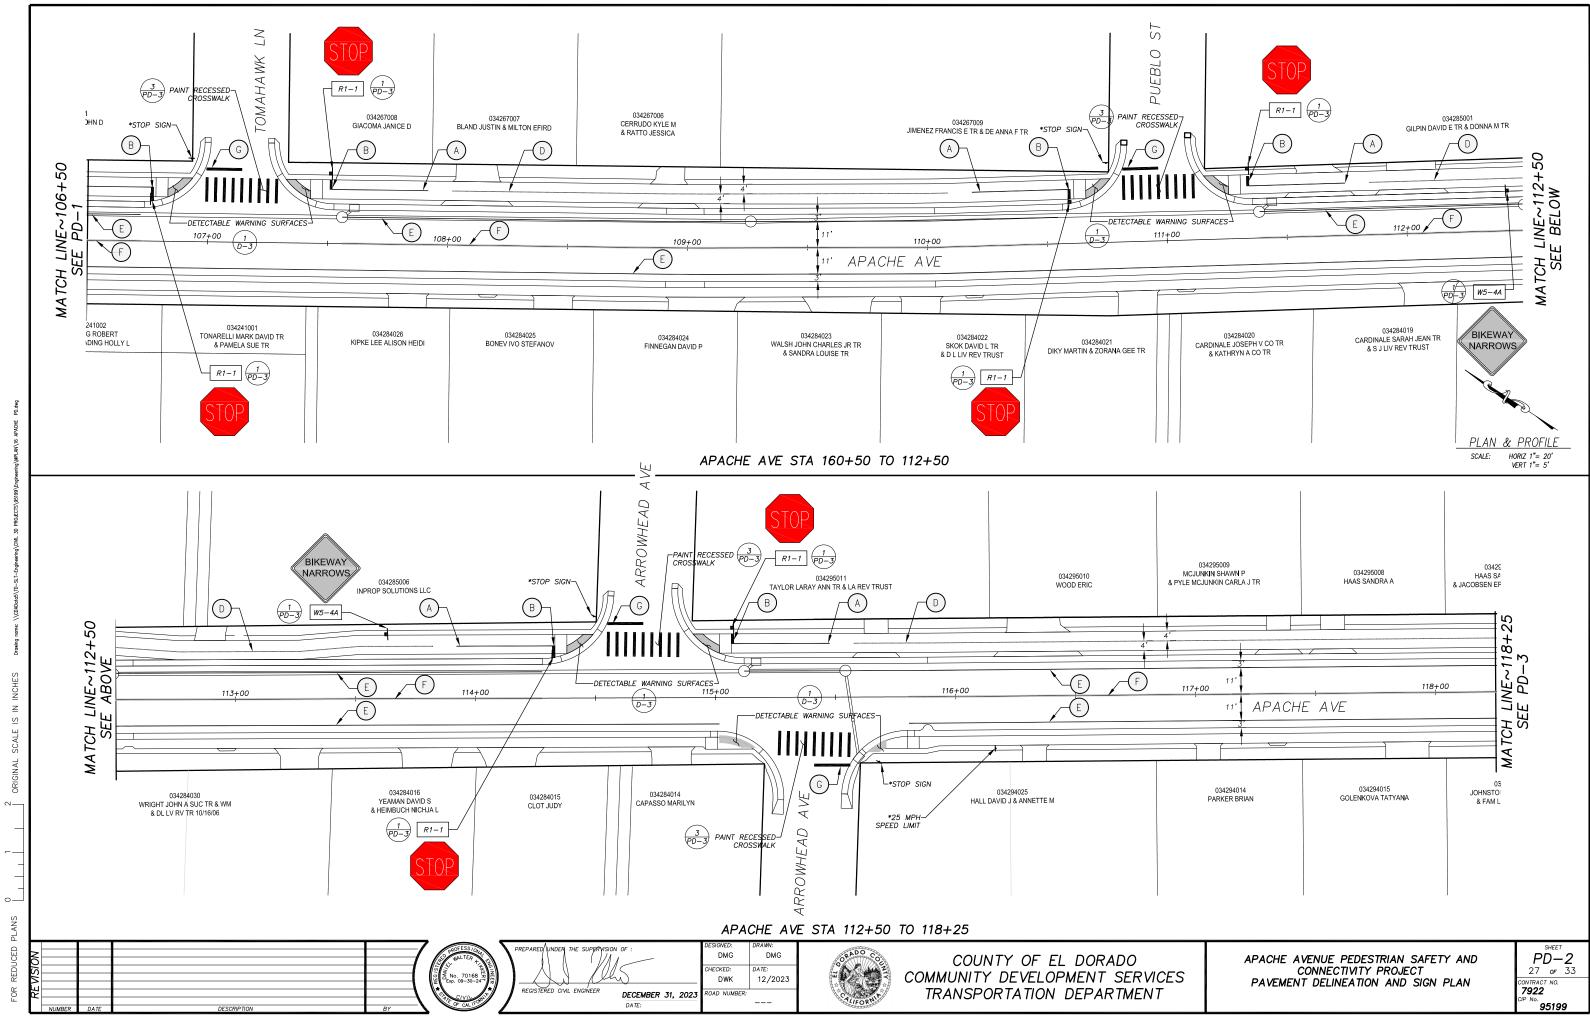


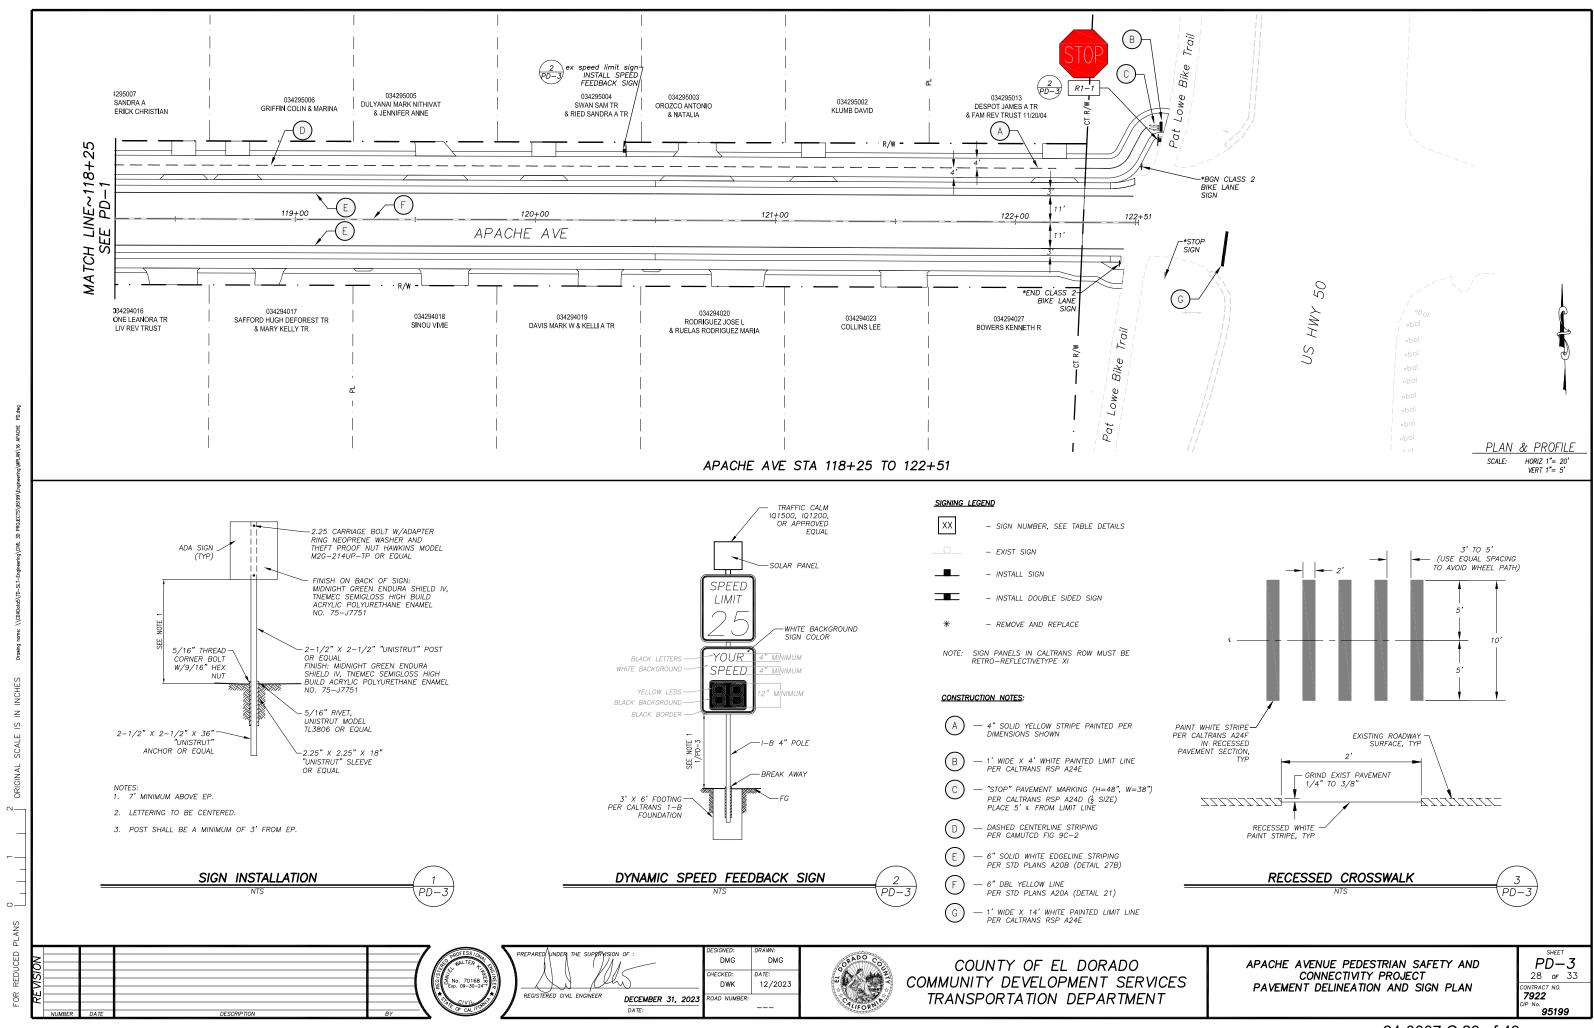


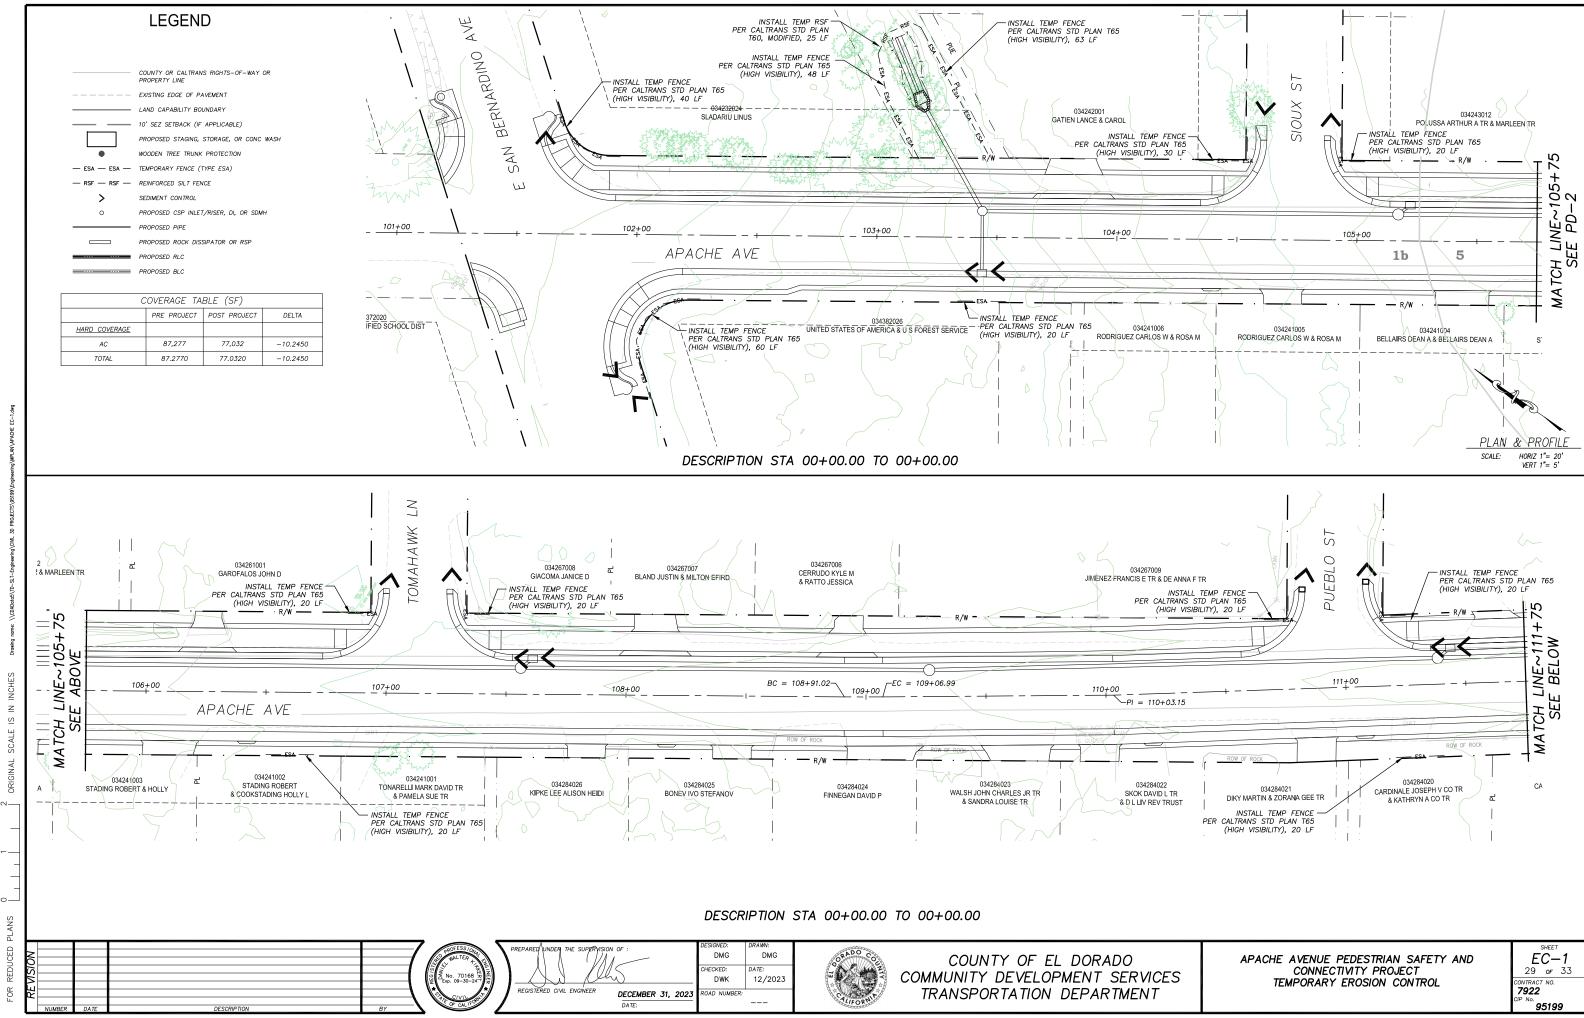

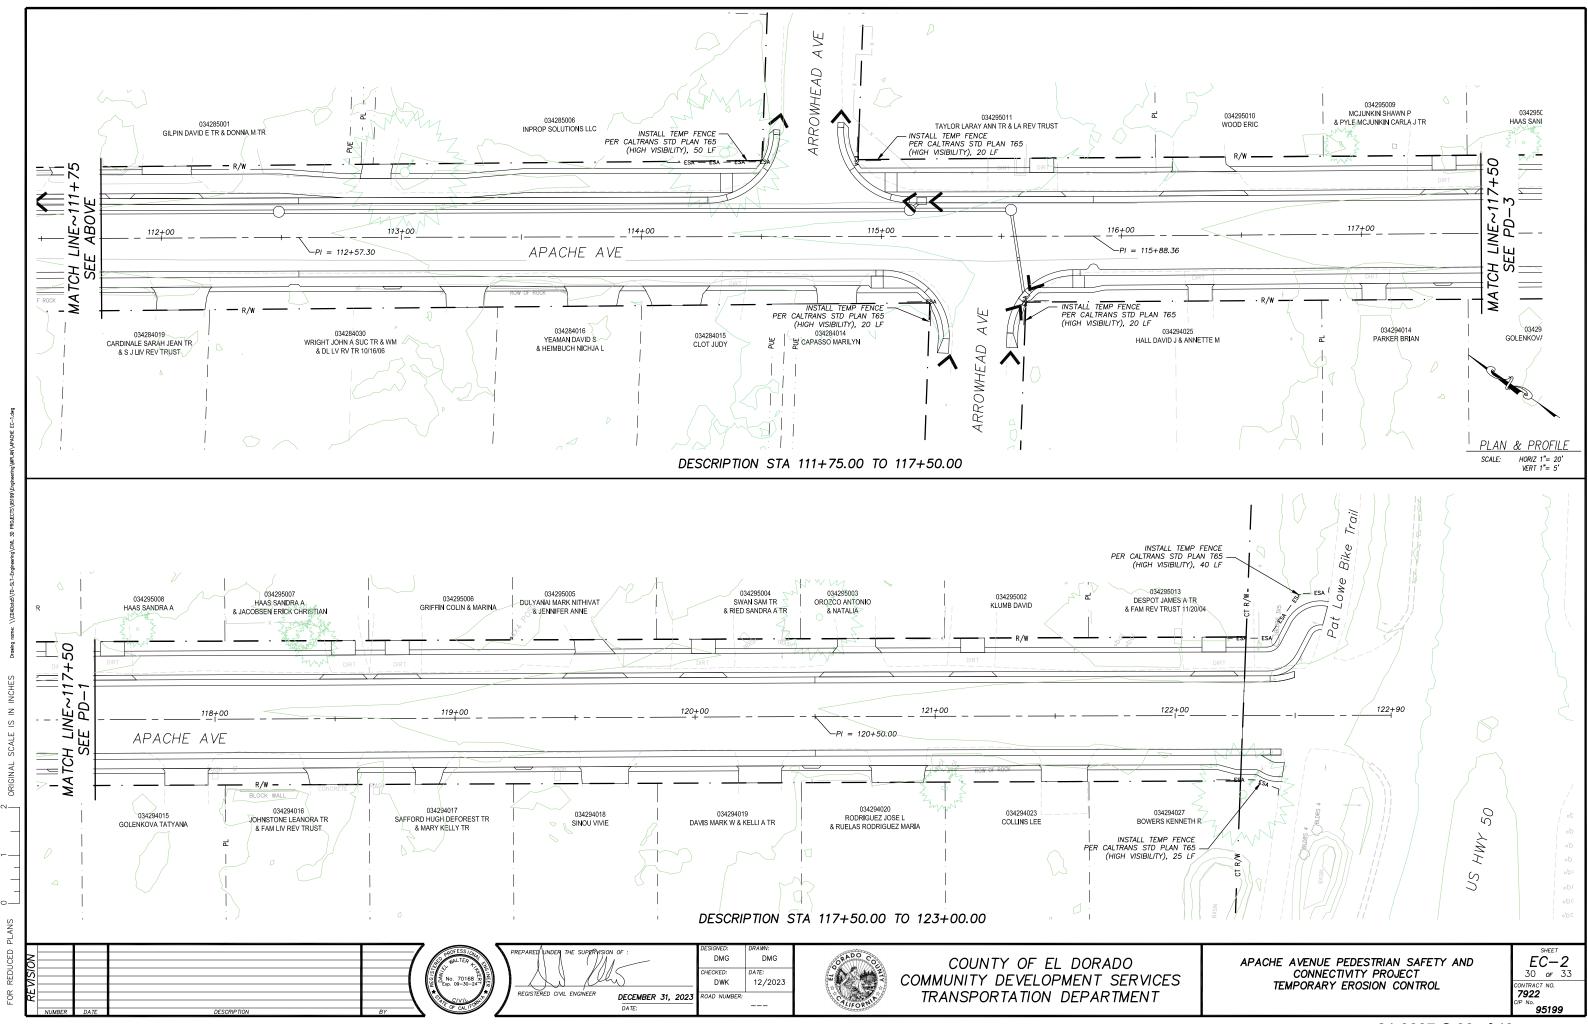


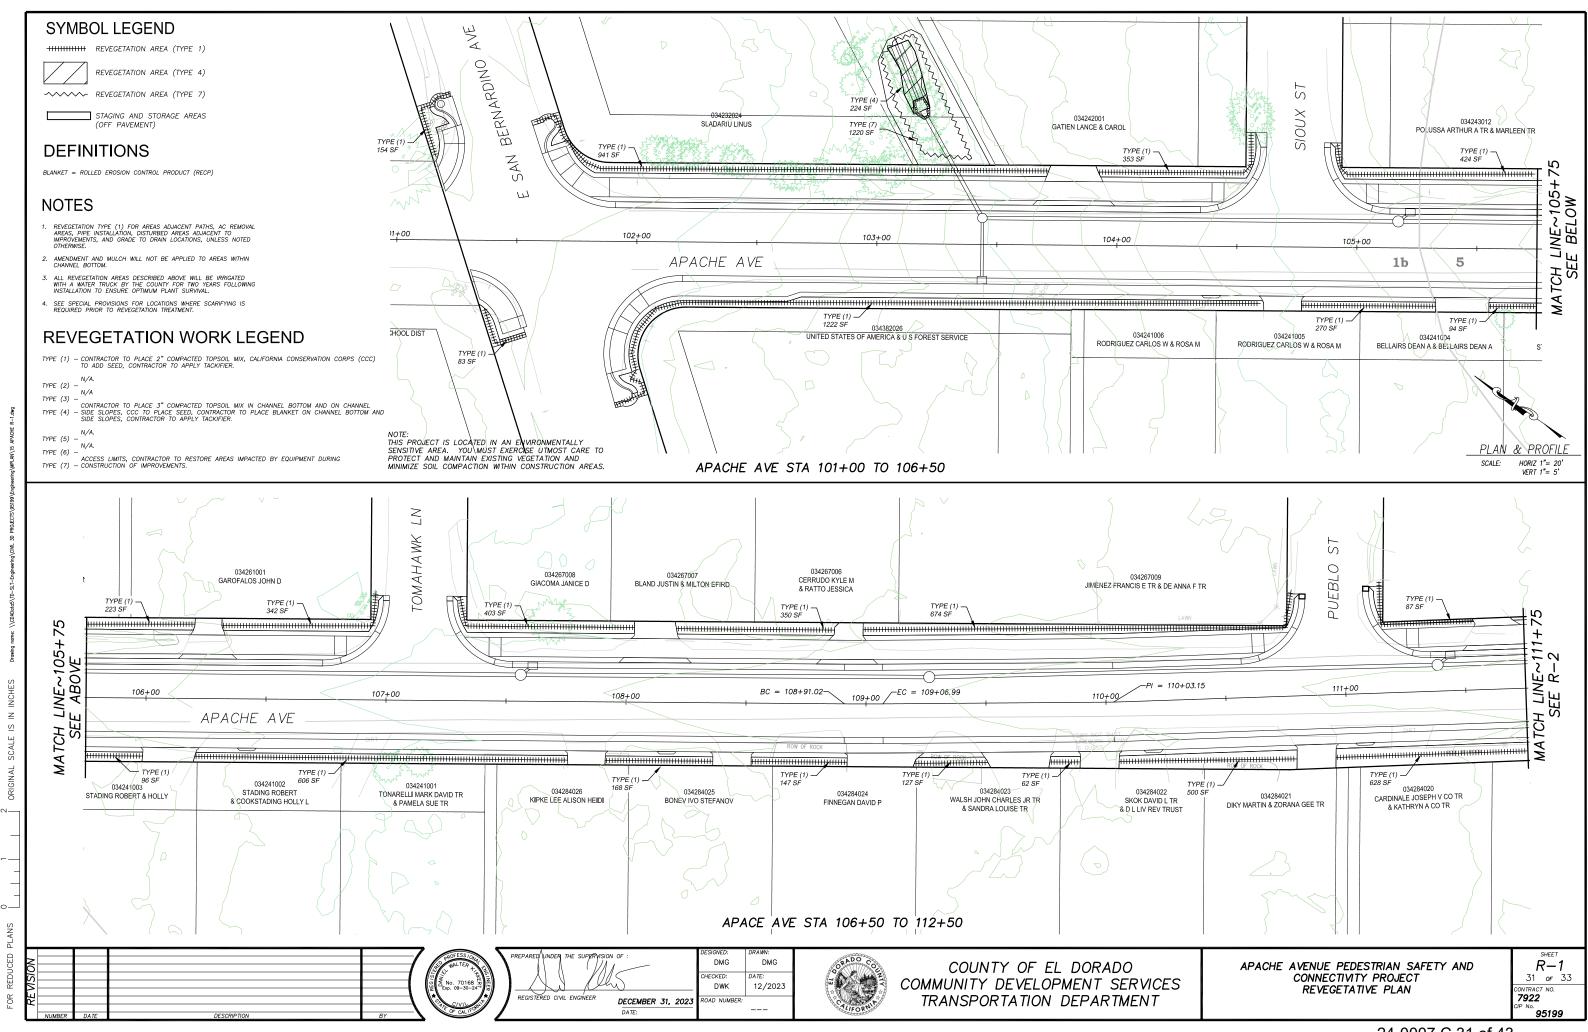

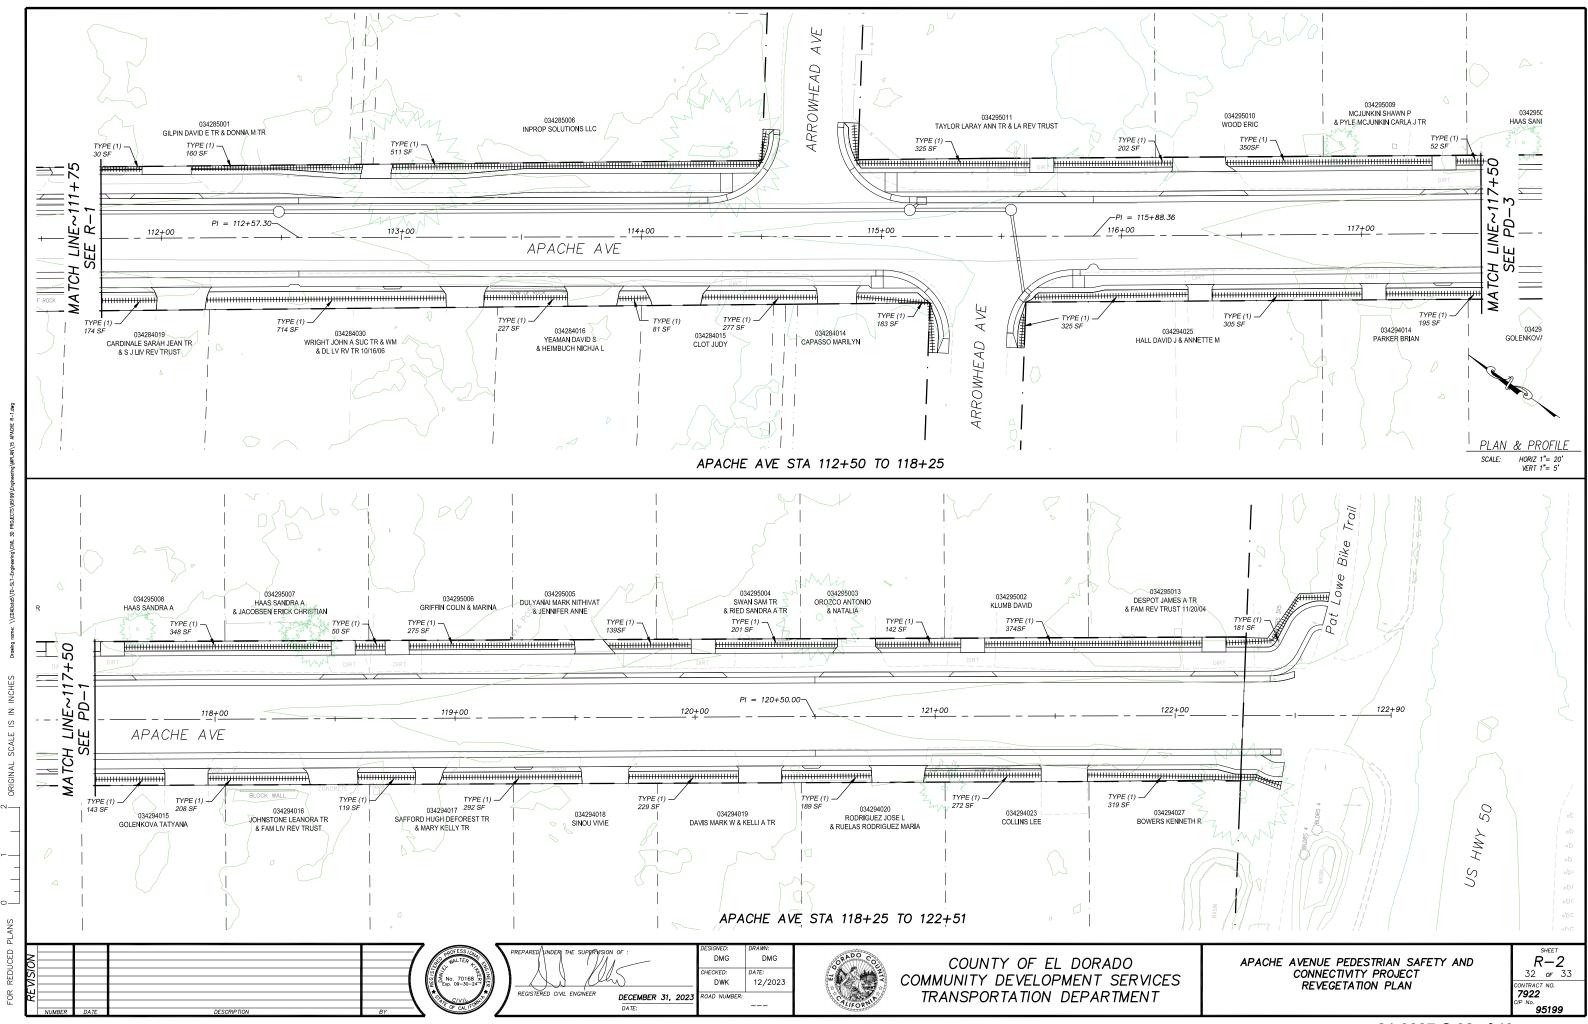

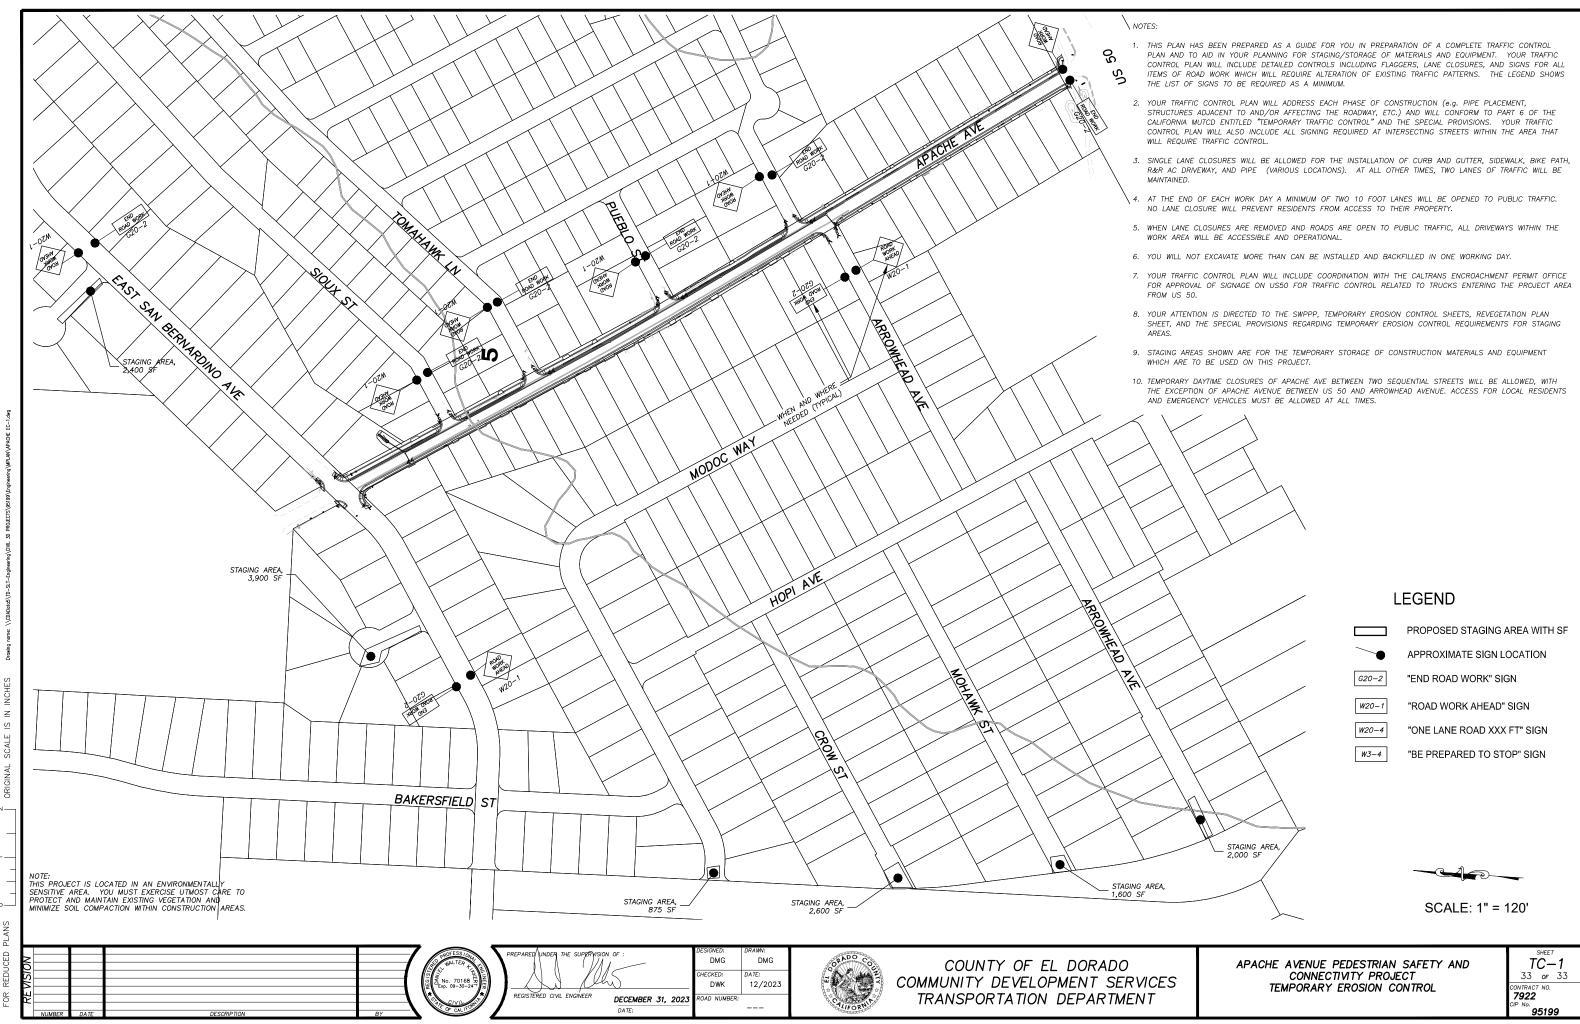

SHEET INDEX

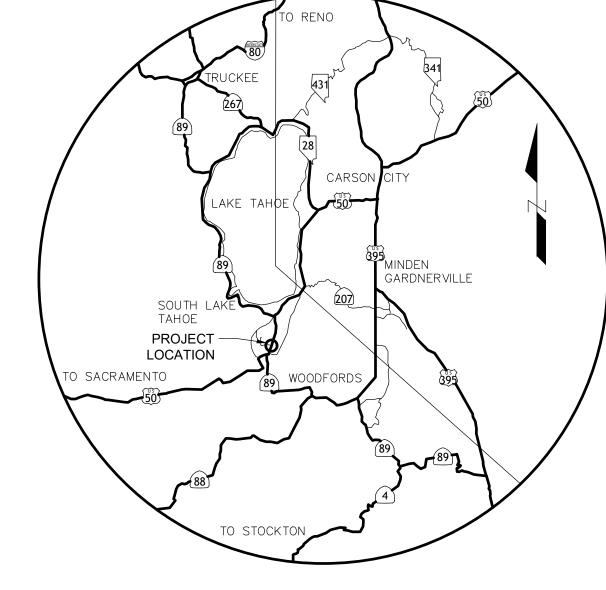


VICINITY MAP


SHEET TITLE

COVER SHEET GENERAL NOTES W2

PLAN SHEET - STA 100+00 TO STA 105+63 PLAN SHEET - STA 105+63 TO STA 111+32 PLAN SHEET - STA 111+32 TO STA 116+94 PLAN SHEET - STA 116+94 TO STA 122+34

DETAILS DETAILS W8 **PROFILES** W9 W10 PROFILES

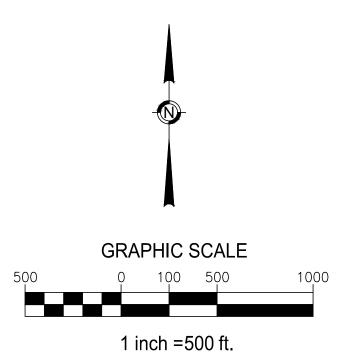

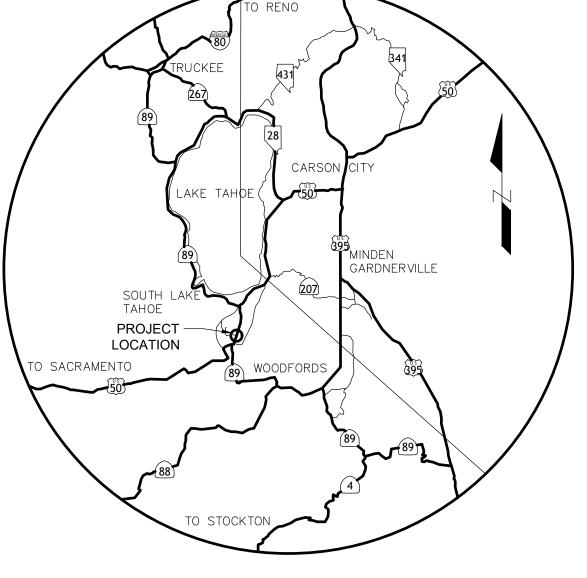

DATE: JAN 2024

WATERLINE

APACHE

2024

REPLACEMENT PROJECT

SHEET

COVER

SCALE: AS SHOWN

DRAWN: TCJ DESIGN: AC/TCJ

AS BUILT:

W1 34 OF 43 SHEETS

BOARD OF DIRECTORS SOUTH TAHOE PUBLIC UTILITY DISTRICT

DIRECTORS

NICK EXLINE NICK HAVEN DAVID PETERSON SHANE ROSMOS KELLY SHEEHAN

GENERAL MANAGER

PAUL HUGHES

ABBREVIATIONS

ARRKE	VIATIONS	
AB	AGGREGATE BASE	OHU
ABND	ABANDONED	OS
AC	ASPHALT CONCRETE	Р
APPX	APPROXIMATELY	PCC
AVE	AVENUE	PE, PO
C&G	CURB AND GUTTER	PL
CF	CUBIC FEET	PP
CL	CENTERLINE	PSF
CPLG CPS	COUPLING COPPER PIPE SIZE	PSI PTW
CSLT	CITY OF SOUTH LAKE TAHOE	PUE
DI	DRAINAGE INLET	PVC
DIA	DIAMETER	QTY
DIP	DUCTILE IRON PIPE	R
DW	DRIVE WAY	RCP
E	EXISTING	REF
EA	EACH	REQ'D
EDC	EL DORADO COUNTY	REVEG
EG ELEC	EXISTING GRADE	RJ
ELEV	ELECTRIC ELEVATION	RT ROW
ELL	ELBOW	SCO
EOP	EDGE OF PAVEMENT	SCH
ESMT	EASEMENT	SD
FE	FLANGE	SDMH
FG	FINISHED GRADE	SFD
FH	FIRE HYDRANT	SQ FT
FL	FLOW LINE	SHT
FM	FORCE MAIN	SPEC
G GA	GAS GAUGE	SQ
GALV	GALVANIZED	SS SSL
GB	GRADE BREAK	SSMH
GPM	GALLONS PER MINUTE	ST
GS	GAS SERVICE, GROUND SHOT	STA
Н	HEIGHT	STD
HORZ, HO	HORIZONTAL, HORIZONTAL OFFSET	STL
HWY	HIGHWAY	STPUD
ID	INSIDE DIAMETER	STR
IE INV	INVERT ELEVATION INVERT	SVC
IPS	IRON PIPE SIZE	TEL TAN
JT	JOINT	TBC
L L	LENGTH	TBD
_ LF	LINEAR FEET	TBR
LN	LANE	TEMP
LOC	LOCATION	TG
LT	LEFT	TR
LTUSD	LAKE TAHOE UNIFIED SCHOOL DISTRICT	TRPA
MAX MECH	MAXIMUM MECHANICAL	TYP
MFR	MANUFACTURER	UG UGE
MH	MANHOLE	USFS
MJ	MECHANICAL JOINT	UTIL
MIN	MINIMUM	V, VO
N	NORTH/NEW	VAR
NA	NOT APPLICABLE	VEG
NIC	NOT IN CONTRACT	W
NO	NORMALLY OPEN	WL
NTS	NOT TO SCALE	W/
OC OD	ON CENTER OUTSIDE DIAMETER	WM
OD	OUTSIDE DIAIVIÉTER	WS

STORM DRAIN STORM DRAIN MANHOLE SINGLE FAMILY DWELLING SQUARE FOOT SHEET **SPECIFICATIONS**

SQUARE

OVERHEAD UTILITY

PORTLAND CEMENT CONCRETE

POUNDS PER SQUARE FOOT

POUNDS PER SQUARE INCH

PUBLIC UTILITY EASEMENT

REINFORCED CONCRETE PIPE

POLYVINYL CHLORIDE

OFFSET

PROPOSED

POLYETHYLENE

PROPERTY LINE

PIPE TRACER WIRE

POWER POLE

QUANTITY

REFERENCE

REVEGETATION

RIGHT-OF-WAY

SCHEDULE

RESTRAINED JOINT

SEWER CLEAN OUT

REQUIRED

RADIUS

SANITARY SEWER, STAINLESS STEEL SANITARY SEWER LATERAL SANITARY SEWER MANHOLE STREET STATION STANDARD STEEL SOUTH TAHOE PUBLIC UTILITY DISTRICT STRUCTURE SERVICE

WV ΥD

TELEPHONE TANGENT TOP BACK CURB TO BE DETERMINED TO BE REMOVED TEMPORARY TOP OF GRATE

TOP OF RIM TAHOE REGIONAL PLANNING AGENCY TYPICAL UNDERGROUND UNDERGROUND ELECTRICAL U.S. FOREST SERVICE UTILITY VERTICAL, VERTICAL OFFSET VARIES

VEGETATION WATER WATER LINE WITH WATER METER WATER SERVICE WATER VALVE

LEGEND

EXISTING:

FIRE HYDRANT:

POWER POLE:

TREE OR BUSH:

SEWER MANHOLE

ELEC/COMM/TELE VAULT:

LAISTING.	
SEWER:	s s
WATER:	—— w —— w —
ABANDONED WATER:	W(A) W(A)
GAS:	—— g —— g ——
JOINT TRENCH:	————JT ———JT ——
UNDERGROUND UTILITY:	————ut ——ut ——ut —
OVERHEAD UTILITY:	—— oh —— oh ——
EDGE OF GRADING:	c c c c c c
STORM DRAIN:	SD SD SD
PROPERTY LINE:	
RIGHT-OF-WAY:	
EASEMENT:	
SETBACK:	
EDGE OF PAVEMENT:	
EDGE OF SD CHANNEL:	· · · · · · · · · · · · · · · · · · ·
WATER MAIN VALVE:	w _V
WATER METER:	<u> </u>

AGENCY & UTILITY CONTACTS

CALTRANS 24HOUR EMERGENCY (530) 426-7600 (916) 859-7900

EL DORADO COUNTY SHERIFF'S OFFICE NON EMERGENCY

(530) 573-3000

EL DORADO COUNTY DEPARTMENT OF **TRANSPORTATION** (530) 573-3180

SOUTH TAHOE PUBLIC UTILITY DISTRICT (530) 544-6474

EL DORADO COUNTY **ENVIRONMENTAL MANAGEMENT** (530) 573-3450

TAHOE REGIONAL PLANNING AGENCY (775) 588-4547

SOUTHWEST GAS (NATURAL GAS) (800) 772-4555

CHARTER COMMUNICATIONS INC. (CABLE TV) (775) 588-1077

LIBERTY ENERGY (ELECTRIC) (530) 541-1628 (775) 689-4100 COLLECT

ATT/SBC (TELEPHONE) 611 (PRESS "0" FOUR TIMES) (800) 310-2355 OPTION #2


LAKE VALLEY FIRE PROTECTION DISTRICT (530) 577-3737

GENERAL NOTES

- CONTRACTOR SHALL HAVE SIGNED PLANS, SPECIFICATION AND PERMITS IN THEIR POSSESSION PRIOR TO COMMENCEMENT OF WORK.
- THE CONTRACTOR SHALL BE RESPONSIBLE FOR CONTACTING ALL UTILITY COMPANIES, LOCAL AGENCIES AND/OR UTILITY DISTRICTS AS TO THE LOCATION OF ALL UNDERGROUND FACILITIES. LOCATION AND DEPTH OF EXISTING UTILITIES WHERE SHOWN ON PLANS ARE BASED ON BEST AVAILABLE INFORMATION. NO GUARANTEE IS MADE AS TO THE ACCURACY OF THIS INFORMATION OR THAT ALL UTILITIES ARE SHOWN. IT SHALL BE THE CONTRACTORS RESPONSIBILITY TO LOCATE, PROTECT, AND MAINTAIN ALL EXISTING UTILITIES. THE CONTRACTOR OR ANY SUBCONTRACTOR FOR THIS CONTRACTOR SHALL NOTIFY MEMBERS OF UNDERGROUND SERVICE ALERT 48 HOURS IN ADVANCE OF PERFORMING EXCAVATION WORK BY CALLING UNDERGROUND SERVICE ALERT 811. EXCAVATION IS DEFINED AS BEING 18 OR MORE INCHES OF DEPTH BELOW THE EXISTING SURFACE.
- THE CONTRACTOR SHALL POTHOLE ALL UTILITY AND STORM DRAIN CROSSINGS ALONG THE PIPELINE ALIGNMENT IN ADVANCE OF INSTALLATION. THE CONTRACTOR SHALL REPORT THE RESULTS OF THE POTHOLE IN WRITING TO THE ENGINEER 48 HOURS (NOT TO INCLUDE WEEKENDS OR HOLIDAYS) PRIOR TO UNDERTAKING ANY CORRECTIVE ACTION BY THE CONTRACTOR REGARDING FACILITY LOCATION OR ALIGNMENT. SHOULD ANY CORRECTIVE WORK BE DONE PRIOR TO NOTIFICATION, THE DISTRICT ASSUMES NO LIABILITY FOR THE COSTS INCURRED FOR THIS
- 4) CONTRACTOR TO BE RESPONSIBLE FOR THE PROTECTION OF ALL EXISTING MONUMENTS AND ANY OTHER SURVEY MARKERS DURING CONSTRUCTION. ALL SUCH MONUMENTS OR MARKERS DISTURBED OR DESTROYED DURING CONSTRUCTION SHALL BE REPLACED BY A CALIFORNIA LICENSED SURVEYOR AT CONTRACTOR'S EXPENSE.
- THE CONTRACTOR SHALL APPLY EITHER WATER OR DUST PALLIATIVE OR BOTH, AS REQUIRED AT THE OPTION OF THE OWNER OR HIS REPRESENTATIVE, FOR THE ALLEVIATION OR PREVENTION OF DUST NUISANCE.
- 6) THE CONTRACTOR SHALL COMPLY WITH THE TAHOE REGIONAL PLANNING AGENCY STANDARD CONDITIONS OF APPROVAL. A PRE-GRADE INSPECTION SHALL BE COMPLETED PRIOR TO ANY SAWCUTTING OR EXCAVATION ACTIVITIES.
- THE CONTRACTOR SHALL COMPLY WITH THE STATE WATER QUALITY CONTROL BOARD WASTE DISCHARGE REQUIREMENTS FOR THIS PROJECT AND EL DORADO COUNTY REQUIREMENTS.
- 8) ALL AREAS DISTURBED BY CONSTRUCTION ACTIVITY SHALL BE REVEGETATED BY THE CONTRACTOR IN ACCORDANCE WITH THE TAHOE REGIONAL PLANNING AGENCY HANDBOOK OF BEST MANAGEMENT PRACTICES. APPLICATION OF A MULCH MAY ENHANCE VEGETATIVE ESTABLISHMENT. NO EQUIPMENT OR VEHICLES SHALL BE PLACED OUTSIDE THE STATE, CITY, OR COUNTY RIGHT OF WAY. ANY DISTURBANCE OF PRIVATE PROPERTY SHALL BE RESTORED BY THE CONTRACTOR AT THEIR EXPENSE.
- ALL EXCESS MATERIAL FROM THE PROJECT IS TO BE REMOVED FROM THE SITE AND DISPOSED OF AT A SITE APPROVED BY THE TAHOE REGIONAL PLANNING AGENCY. NO EXCESS MATERIAL SHALL BE STORED ON SITE AFTER HOURS.
- 10) ALL INTERTIES BETWEEN NEW WATER MAINS AND THE EXISTING WATER SYSTEM, INCLUDING NEW WATER SERVICE CONNECTIONS, AND FIRE HYDRANT INSTALLATIONS AND TRANSFERS, SHALL ONLY BE MADE AFTER ALL PRESSURE TESTING AND DISINFECTION REQUIREMENTS ARE SATISFACTORILY MET. THE CONTRACTOR SHALL BE RESPONSIBLE TO PROVIDE ALL BLOW OFFS NECESSARY FOR FLUSHING AND SAMPLING OF ALL NEW WATER MAINS AS REQUIRED BY THE CALIFORNIA STATE WATER RESOURCES CONTROL BOARD AND PROJECT SPECIFICATIONS.
- 11) THE CONTRACTOR SHALL REPLACE ALL TRAFFIC STRIPING THAT IS DISTURBED DURING CONSTRUCTION.
- 12) ALL EXCAVATIONS SHALL BE BACKFILLED OR TRENCH PLATED AT THE END OF EACH DAY'S WORK PER THE SPECIFICATIONS. EXCAVATIONS WITHIN EXISTING PAVED AREAS SHALL BE COLD PATCHED AS REQUIRED PER SPECIFICATIONS TO MATCH THE EXISTING PAVEMENT AT THE END OF EACH DAY'S WORK. ALL TRENCH PLATES SHALL BE NON-SKID TYPE AND HAVE COLD PATCH APPLIED TO THE EDGE FOR TRAFFIC APPROACH AND DEPARTURE.
- 13) THE CONTRACTOR SHALL PROVIDE, ON ALL NON-CONDUCTIVE PIPING, CONTINUOUS INSULATED TRACER WIRE RATED FOR DIRECT BURY (#10 SOLID COPPER OR #12 COPPER CLAD STEEL WIRE ALONG THE PIPELINE AND PROVIDE ACCESS TO TRACER WIRE AT ALL VALVE BOX INSTALLATIONS WITH A MINIMUM OF 1 FT EXCESS TRACER WIRE FOR FUTURE SERVICE CONNECTIONS. THIS SHALL ALSO APPLY TO ALL CONDUCTIVE PIPING UNLESS PERMANENTLY BONDED AT EACH JOINT. ALL TRACER WIRE CONNECTIONS SHALL BE MADE USING 3M DBR-6 SPLICE KIT OR APPROVED EQUAL
- 14) THE CONTRACTOR SHALL PROTECT AND BE RESPONSIBLE FOR ANY DISTURBANCE OR

CONTAMINATION TO ANY DRY WELLS, STORM WATER COLLECTION OR RETAINAGE SYSTEMS INCLUDING STORM DRAIN PIPE, CURB & GUTTER, VALLEY GUTTERS AND HORIZONTAL DRAINS THROUGH OUT THE PROJECT AREA. ANY DAMAGE SHALL BE REPAIRED AT NO ADDITIONAL COST TO THE DISTRICT. THE CONTRACTOR SHALL NOT STOCK PILE ANY MATERIAL UPON ANY DRAINAGE FACILITIES.

- 15) CONTRACTOR SHALL REMOVE ALL MATERIAL GENERATED BY ANY ASPHALT SAW CUTTING OPERATION DURING OR IMMEDIATELY AFTER SAWCUTTING BY USING ADEQUATELY SIZED VACUUMING EQUIPMENT TO ACCOMMODATE THE REMOVAL PROCESS.
- 16) ALL SEWER PIPES DAMAGED DURING THE EXECUTION OF THE PROJECT SHALL BE REPAIRED PER DETAILS.
- 17) AFTER THE NEW MAIN IS PLACED INTO SERVICE, THE EXISTING WATER MAINS, WHERE SHOWN ON THE PROJECT DRAWINGS, ARE TO BE ABANDONED IN PLACE BY CUTTING OUT A SECTION OF PIPE AND WELDING A CAP ON THE END OF THE PIPELINE, OR OTHER APPROVED METHOD OF CAPPING. BLIND-FLANGE CAPPING SHALL BE UTILIZED WHERE POSSIBLE. ALL EXPOSED CORPORATION STOPS ON THE EXISTING WATER MAINS ARE TO BE LEFT IN PLACE IN THE CLOSED POSITION. FOR CORPORATION STOPS THAT HAVE NOT BEEN EXPOSED, THE CAPPING OF THE END OF THE SERVICE LINE USING AN APPROVED COMPRESSION FITTING SHALL BE ACCEPTABLE. EXISTING FIRE HYDRANTS TO BE ABANDONED AT THE ISOLATION VALVE, REMOVED FROM THE PROJECT AREA AND RETURNED TO THE DISTRICT, BY THE CONTRACTOR. THE ISOLATION VALVE IS TO BE BLIND FLANGED OR CAPPED BY OTHER APPROVED METHOD.
- 18) ALL EXISTING WATER SERVICES FOR THIS PROJECT SHALL BE ABANDONED PER NOTE #17. ONLY NEW WATER SERVICE CONNECTIONS WHERE SHOWN ON THE PROJECT PLANS SHALL BE INSTALLED PER THE DISTRICTS STANDARD DETAILS AND PROJECT DRAWINGS. THE LOCATIONS OF ALL EXISTING WATER SERVICES SHALL BE VERIFIED AND MARKED IN THE FIELD.
- 19) THE CONTRACTOR SHALL BE RESPONSIBLE FOR THE HANDLING AND PROPER DISPOSAL OF DISTRIBUTION SYSTEM WATER ENCOUNTERED DURING SYSTEM TIE-INS IN ACCORDANCE WITH THE SPECIFICATIONS. FOR THIS PROJECT, THE CONTRACTOR SHALL ASSUME THAT UP TO 1,250 GALLONS WILL BE ENCOUNTERED AT EACH TIE-IN.
- 20) CONTRACTOR SHALL EXPECT SHALLOW GROUNDWATER TO BE ENCOUNTERED. DEWATERING PER SPECIFICATIONS REQUIRED.

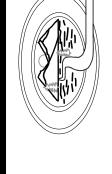

Z \mathbf{E} R 0 П X Ь NERAL CEME **APACHE** П 24 Ь RE 20



DATE: JAN 2024

SCALE: AS SHOWN

DRAWN: TCI DESIGN: AC/TCJ

AS BUILT:

35 OF 43 **SHEETS**

WATER MAIN VALVE:

CUT AND CAP EXISTING MAIN:

PROPOSED:

YARD


WATER MAIN LINE:

SVC & FH LINES:

FIRE HYDRANT:

WATER REDUCER:




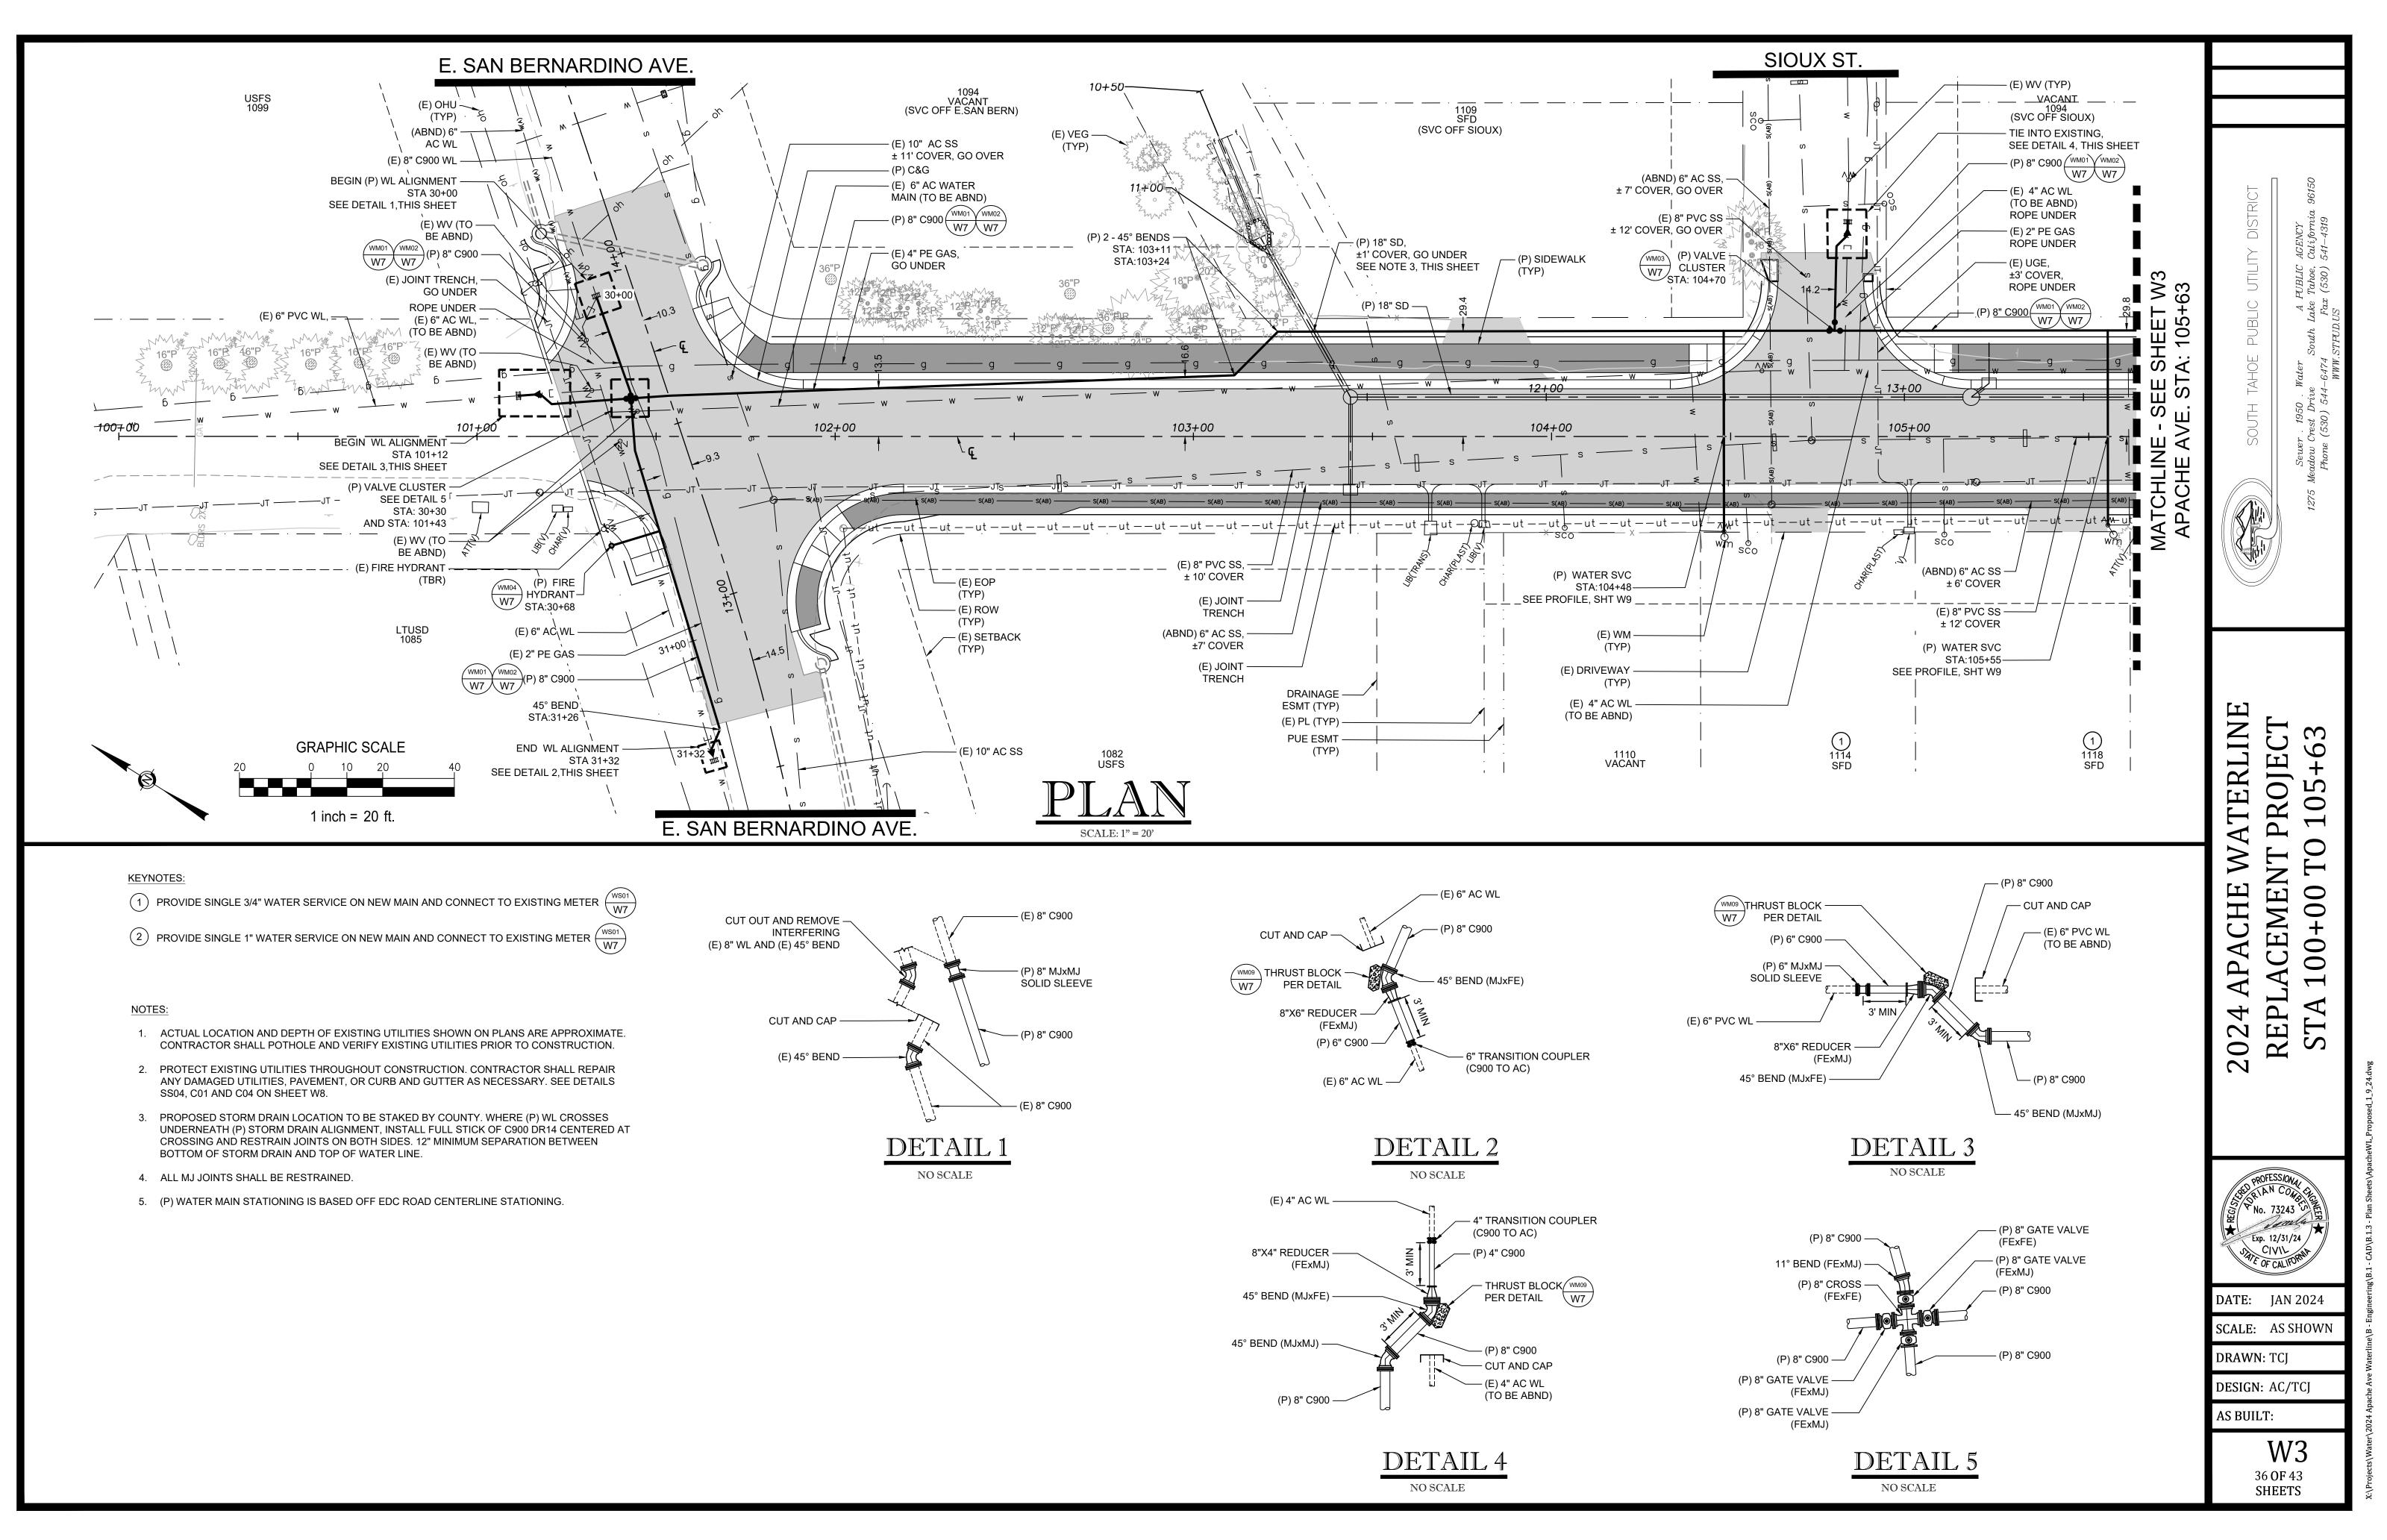

KEYNOTES:

- 1) PROVIDE SINGLE 3/4" WATER SERVICE ON NEW MAIN AND CONNECT TO EXISTING METER W7
- 2 PROVIDE SINGLE 1" WATER SERVICE ON NEW MAIN AND CONNECT TO EXISTING METER $\frac{\text{(WS01)}}{\text{W7}}$

- 1. ACTUAL LOCATION AND DEPTH OF EXISTING UTILITIES SHOWN ON PLANS ARE APPROXIMATE. CONTRACTOR SHALL POTHOLE AND VERIFY EXISTING UTILITIES PRIOR TO CONSTRUCTION.
- 2. PROTECT EXISTING UTILITIES THROUGHOUT CONSTRUCTION. CONTRACTOR SHALL REPAIR ANY DAMAGED UTILITIES, PAVEMENT, OR CURB AND GUTTER AS NECESSARY. SEE DETAILS SS04, C01 AND C04 ON SHEET W8.
- 3. PROPOSED STORM DRAIN LOCATION TO BE STAKED BY COUNTY. WHERE (P) WL CROSSES UNDERNEATH (P) STORM DRAIN ALIGNMENT, INSTALL FULL STICK OF C900 DR14 CENTERED AT CROSSING AND RESTRAIN JOINTS ON BOTH SIDES. 12" MINIMUM SEPARATION BETWEEN BOTTOM/TOP OF STORM DRAIN AND TOP/BOTTOM OF WATER LINE.
- 4. ALL MJ JOINTS SHALL BE RESTRAINED.
- 5. CUT AND CAP HYDRANT LATERAL AFTER REMOVING (E) FIRE HYDRANT.
- 6. (P) WATER MAIN STATIONING IS BASED OFF EDC ROAD CENTERLINE STATIONING.

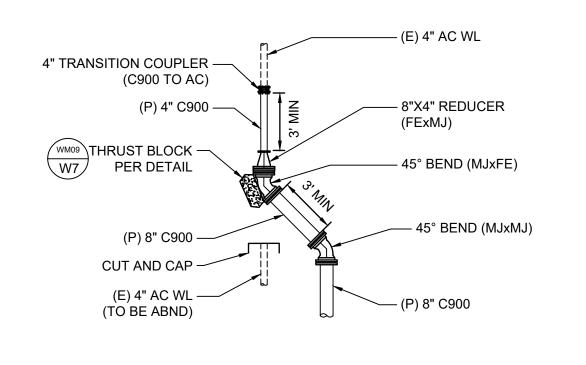

DETAIL 1 SCALE: 1" = 5

TERLINE **PROJECT** \mathcal{C} M ACHE H S CEM 0 AP, STA 2024 Ь RE


Exp. 12/31/24 STATE OF CALIFORN DATE: JAN 2024

SCALE: AS SHOWN DRAWN: TCJ

DESIGN: AC/TCJ

AS BUILT:

39 OF 43 SHEETS

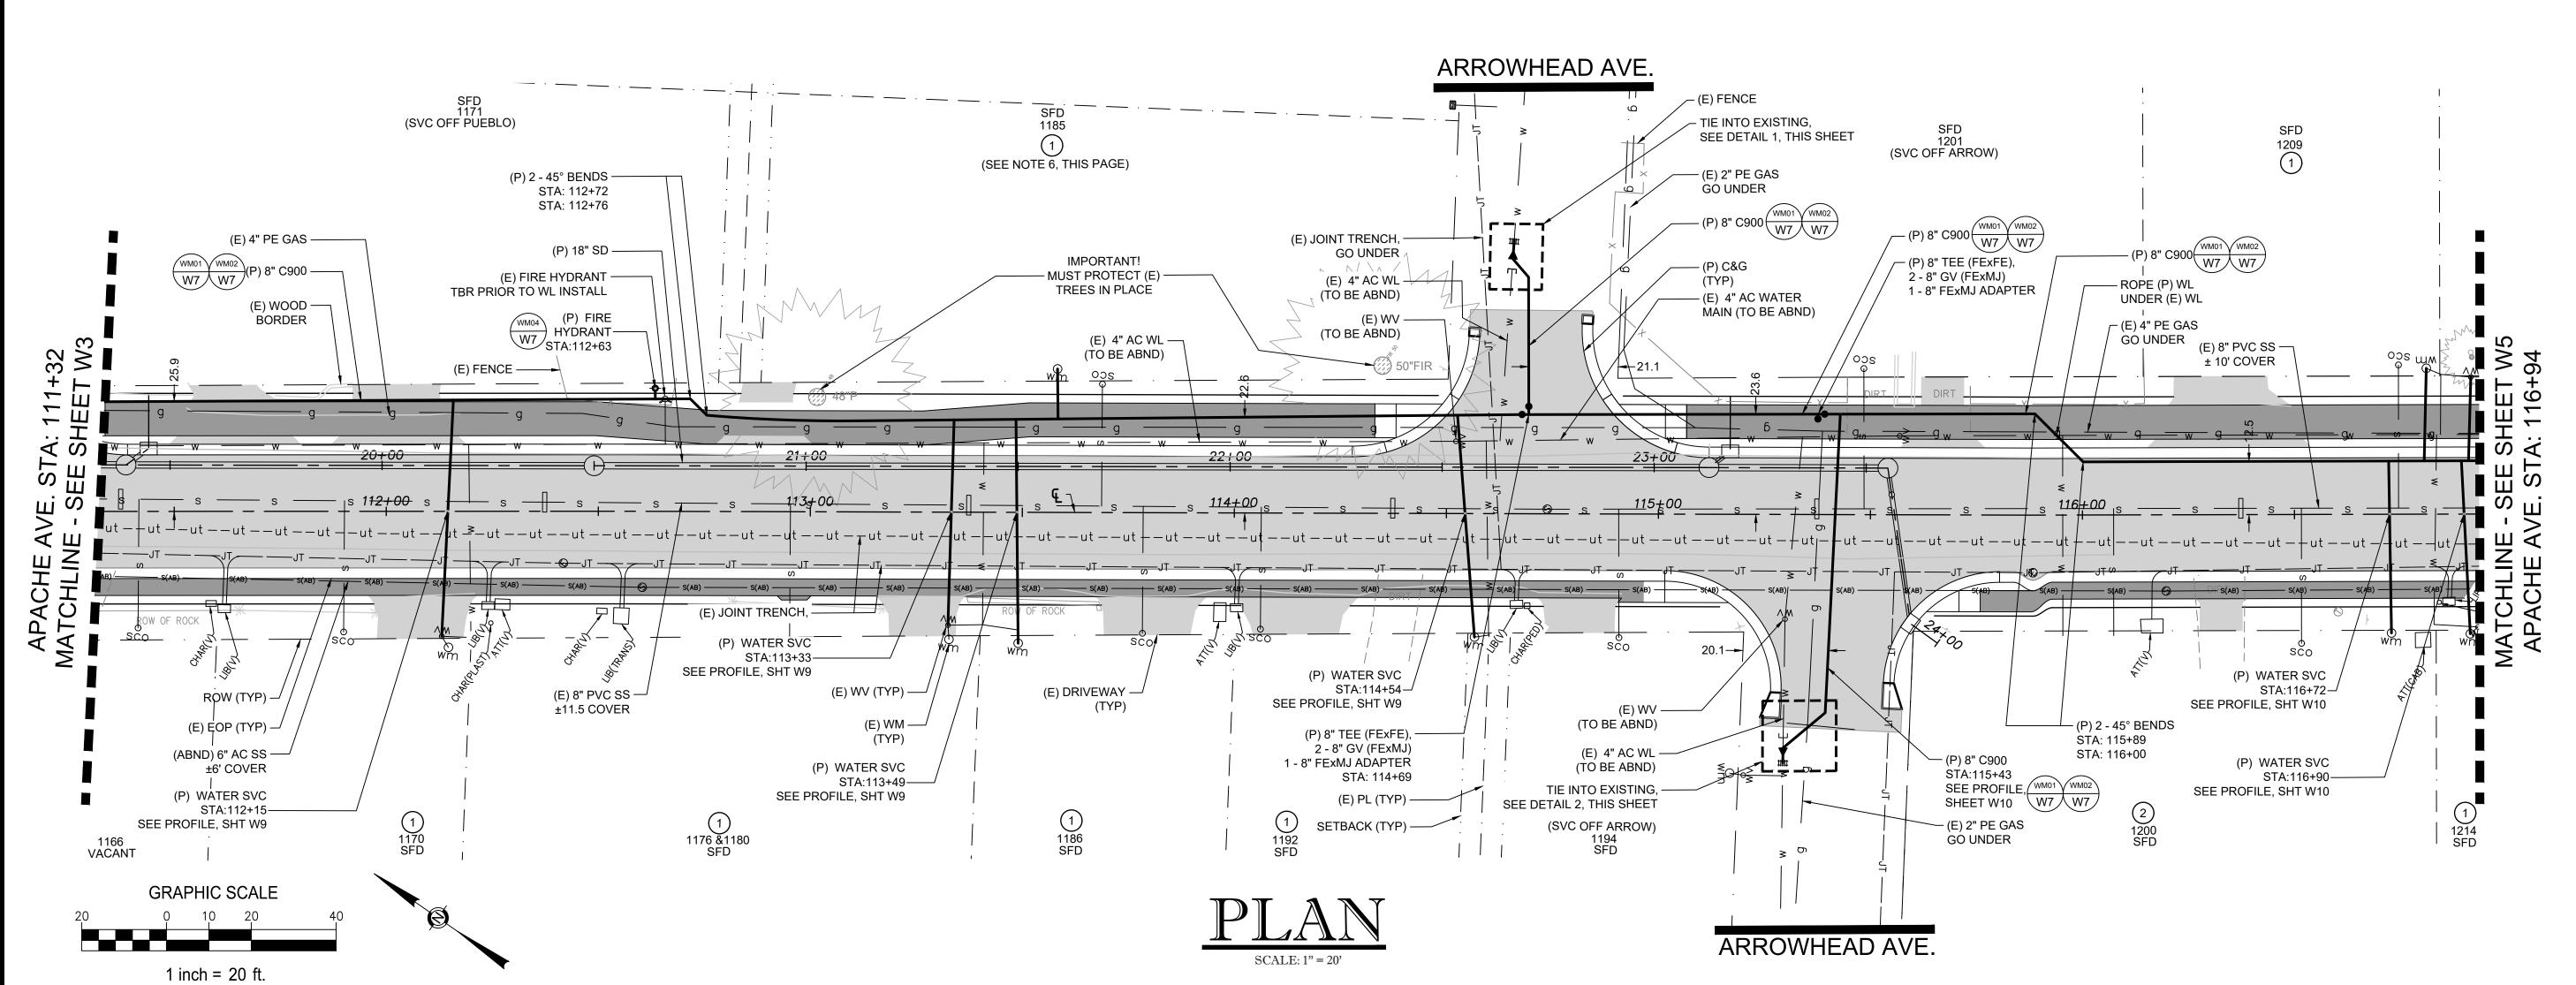


KEYNOTES:


1) PROVIDE SINGLE 3/4" WATER SERVICE ON NEW MAIN AND CONNECT TO EXISTING METER (WS01)

2 PROVIDE SINGLE 1" WATER SERVICE ON NEW MAIN AND CONNECT TO EXISTING METER $\frac{\text{(WS01)}}{\text{W7}}$

- 1. ACTUAL LOCATION AND DEPTH OF EXISTING UTILITIES SHOWN ON PLANS ARE APPROXIMATE. CONTRACTOR SHALL POTHOLE AND VERIFY EXISTING UTILITIES PRIOR TO CONSTRUCTION.
- 2. PROTECT EXISTING UTILITIES THROUGHOUT CONSTRUCTION. CONTRACTOR SHALL REPAIR ANY DAMAGED UTILITIES, PAVEMENT, OR CURB AND GUTTER AS NECESSARY. SEE DETAILS SS04, C01 AND C04 ON SHEET W8.
- 3. PROPOSED STORM DRAIN LOCATION TO BE STAKED BY COUNTY. WHERE (P) WL CROSSES UNDERNEATH (P) STORM DRAIN ALIGNMENT, INSTALL FULL STICK OF C900 DR14 CENTERED AT CROSSING AND RESTRAIN JOINTS ON BOTH SIDES. 12" MINIMUM SEPARATION BETWEEN BOTTOM/TOP OF STORM DRAIN AND TOP/BOTTOM OF WATER LINE.
- 4. ALL MJ JOINTS SHALL BE RESTRAINED.
- 5. (P) WATER MAIN STATIONING IS BASED OFF EDC ROAD CENTERLINE STATIONING.
- 6. WATER METER COULD NOT BE FOUND IN FIELD DURING DESIGN. LOCATION SHOWN ON PLANS IS THE BEST ESTIMATION BASED ON AVAILABLE DATA AT THE TIME. LOCATE METER DURING CONSTRUCTION PRIOR TO TYING WATER SERVICES INTO NEW MAIN.

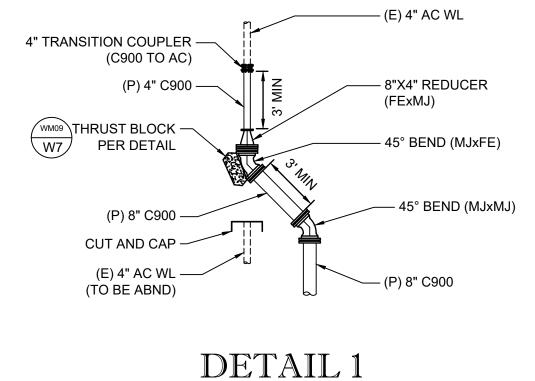


SCALE: 1" = 5

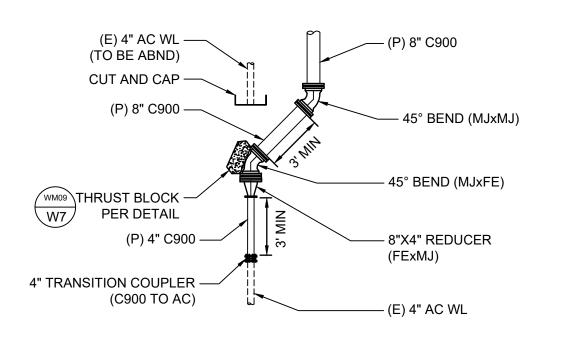

DETAIL 2 SCALE: 1" = 5



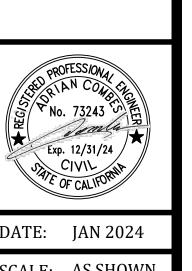

DATE: JAN 2024 SCALE: AS SHOWN

DRAWN: TCJ DESIGN: AC/TCJ

AS BUILT:


38 OF 43 **SHEETS**

KEYNOTES:

- 1) PROVIDE SINGLE 3/4" WATER SERVICE ON NEW MAIN AND CONNECT TO EXISTING METER $\frac{W_{SUI}}{W_{I}}$
- (2) PROVIDE SINGLE 1" WATER SERVICE ON NEW MAIN AND CONNECT TO EXISTING METER (WS01)

NOTES:

- 1. ACTUAL LOCATION AND DEPTH OF EXISTING UTILITIES SHOWN ON PLANS ARE APPROXIMATE. CONTRACTOR SHALL POTHOLE AND VERIFY EXISTING UTILITIES PRIOR TO CONSTRUCTION.
- 2. PROTECT EXISTING UTILITIES THROUGHOUT CONSTRUCTION. CONTRACTOR SHALL REPAIR ANY DAMAGED UTILITIES, PAVEMENT, OR CURB AND GUTTER AS NECESSARY. SEE DETAILS SS04, C01 AND C04 ON SHEET W8.
- 3. PROPOSED STORM DRAIN LOCATION TO BE STAKED BY COUNTY. WHERE (P) WL CROSSES UNDERNEATH (P) STORM DRAIN ALIGNMENT, INSTALL FULL STICK OF C900 DR14 CENTERED AT CROSSING AND RESTRAIN JOINTS ON BOTH SIDES. 12" MINIMUM SEPARATION BETWEEN BOTTOM/TOP OF STORM DRAIN AND TOP/BOTTOM OF WATER LINE.
- 4. ALL MJ JOINTS SHALL BE RESTRAINED.
- 5. (P) WATER MAIN STATIONING IS BASED OFF EDC ROAD CENTERLINE STATIONING.

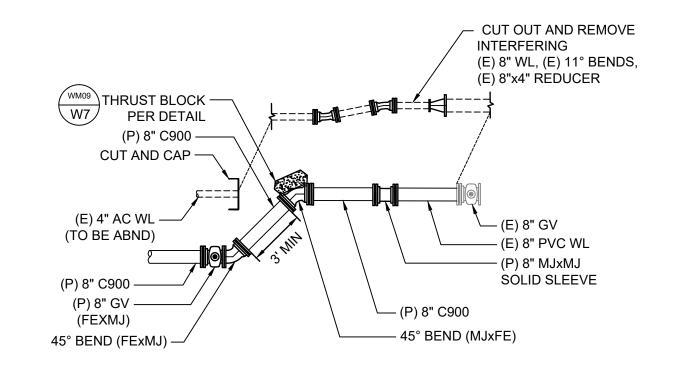





Exp. 12/31/24 OF CALIFORN


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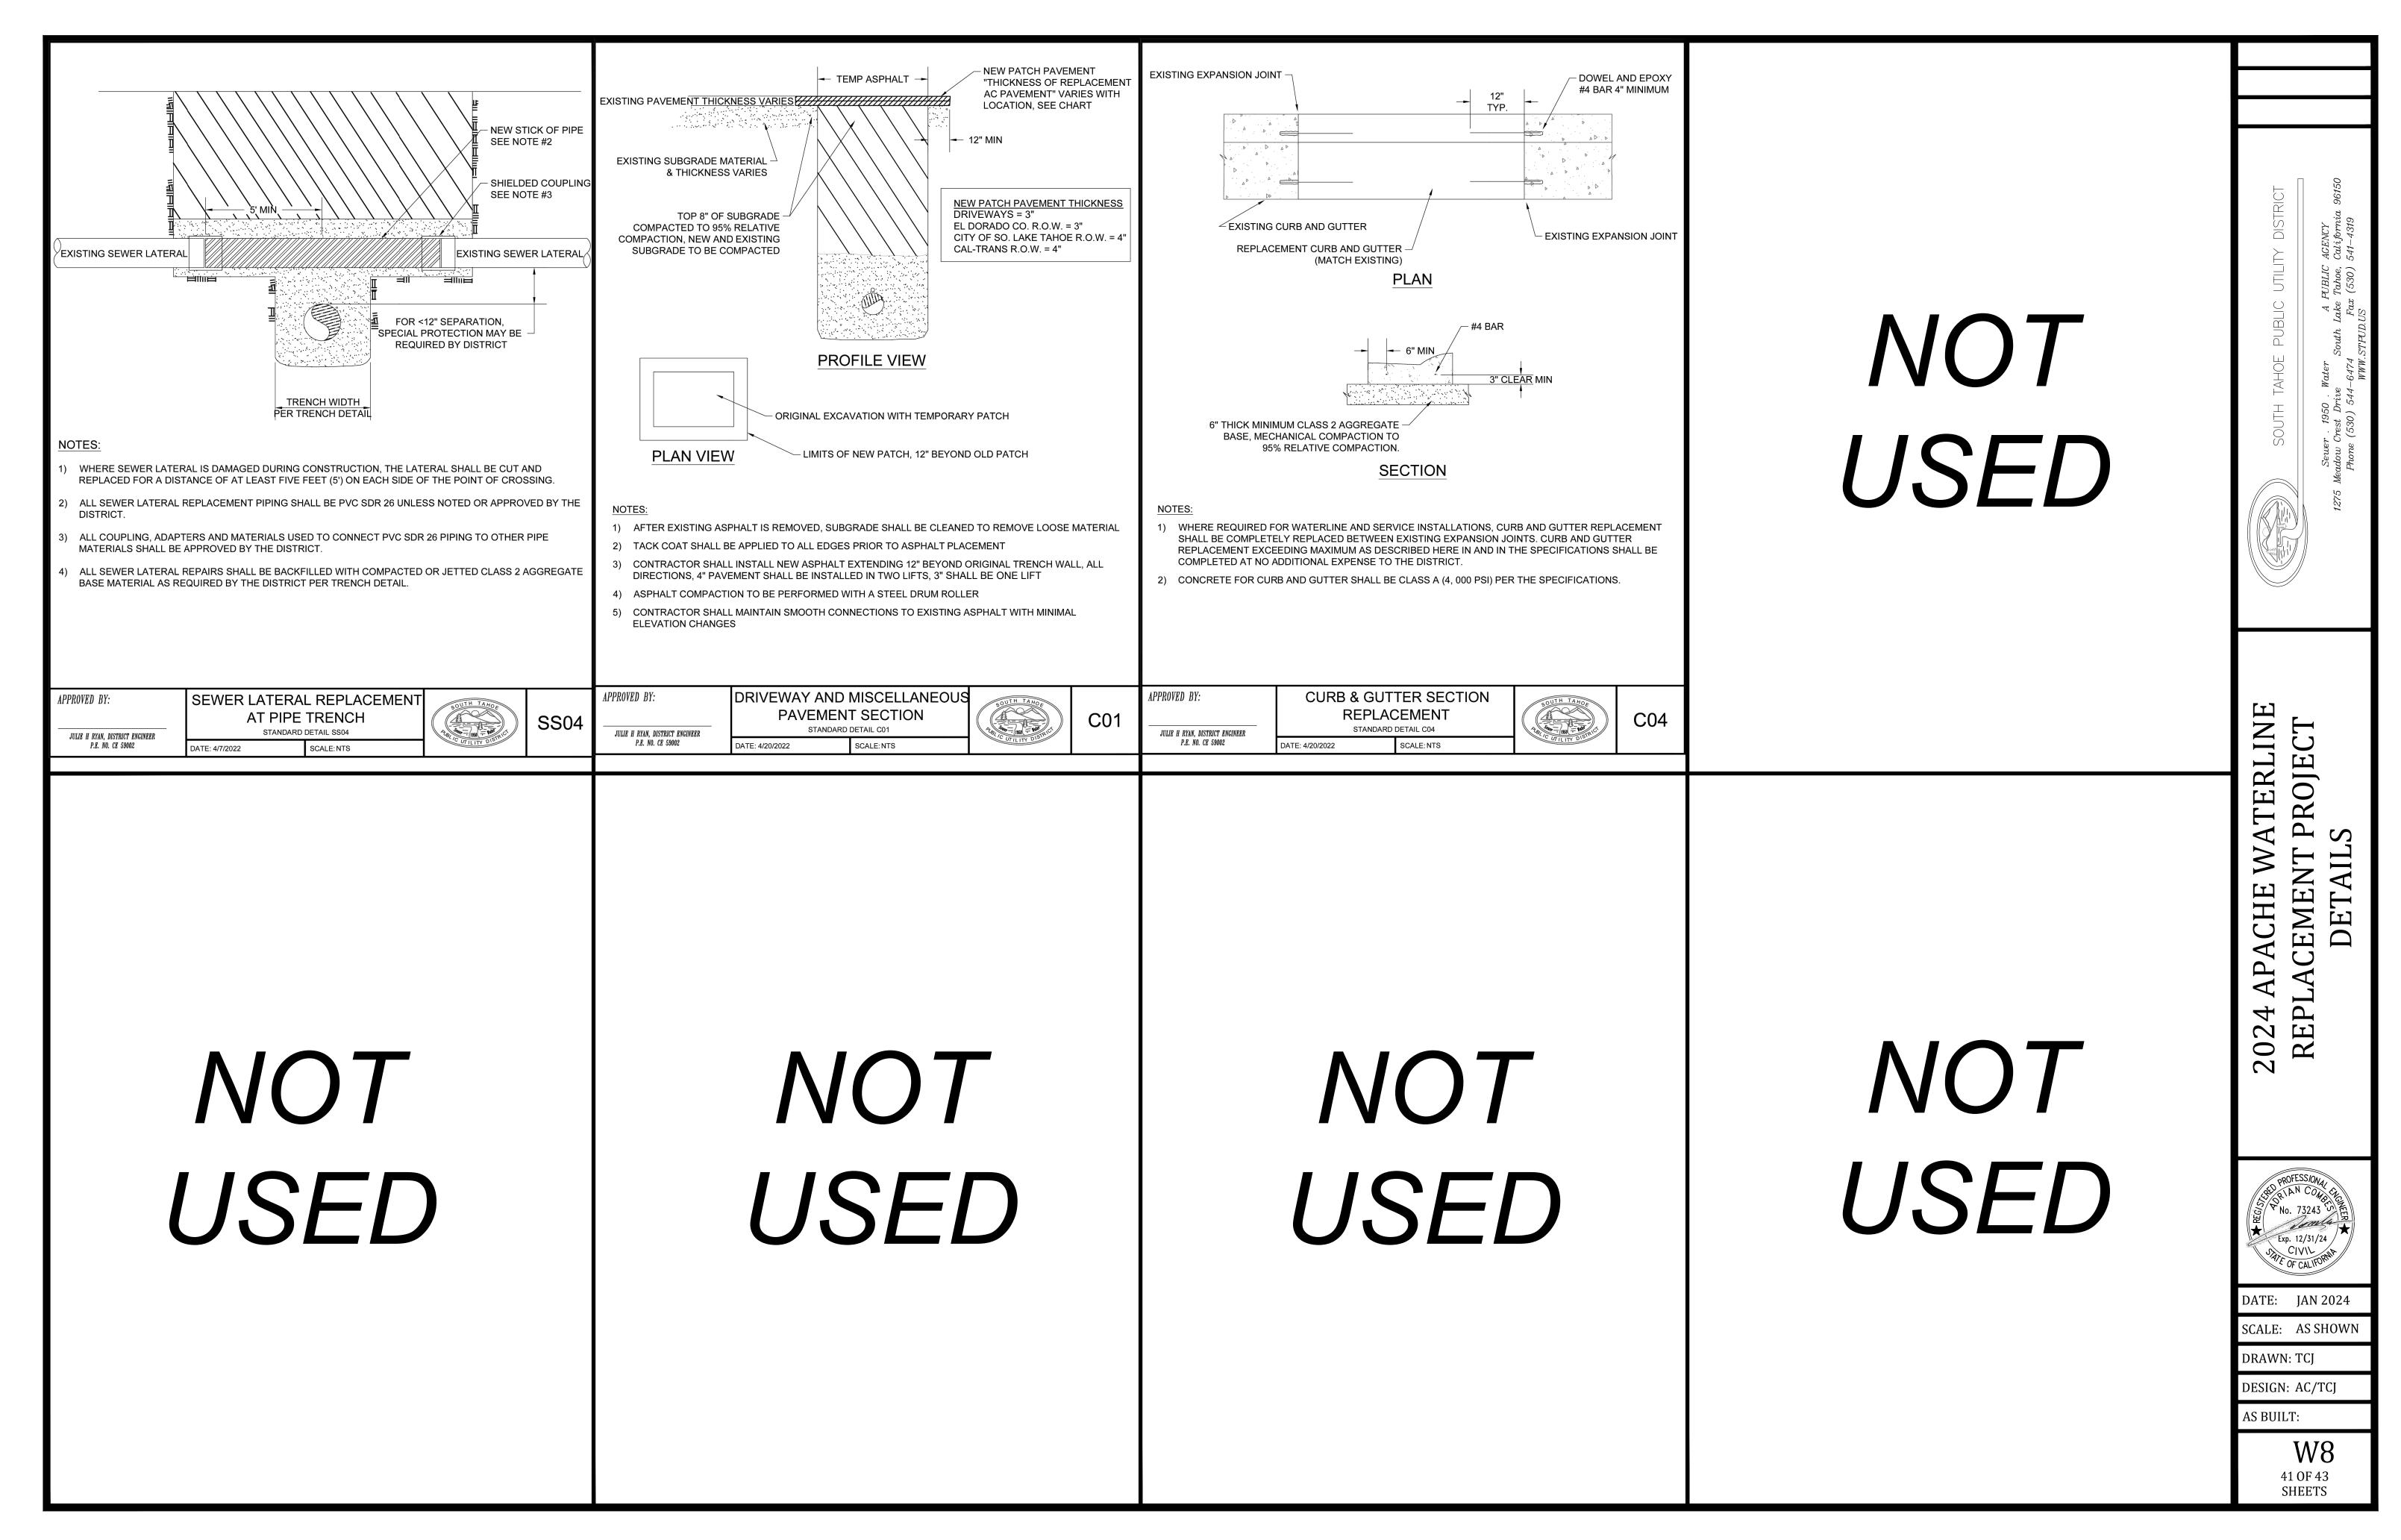
SCALE: AS SHOWN


DRAWN: TCJ DESIGN: AC/TCJ


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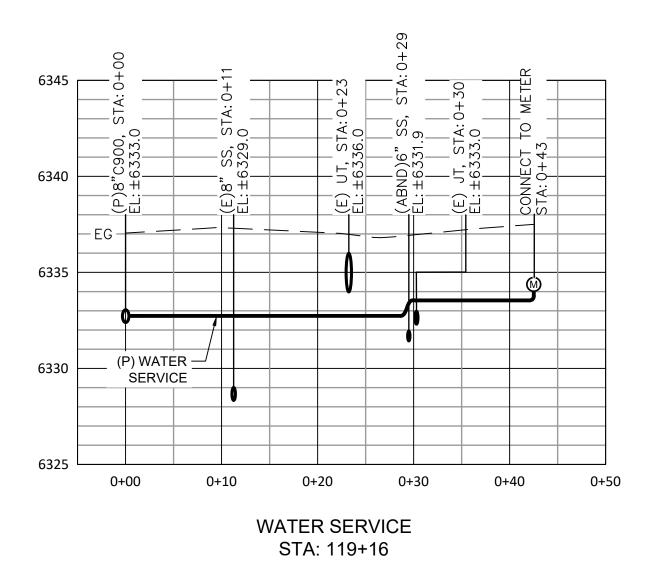
39 OF 43 SHEETS







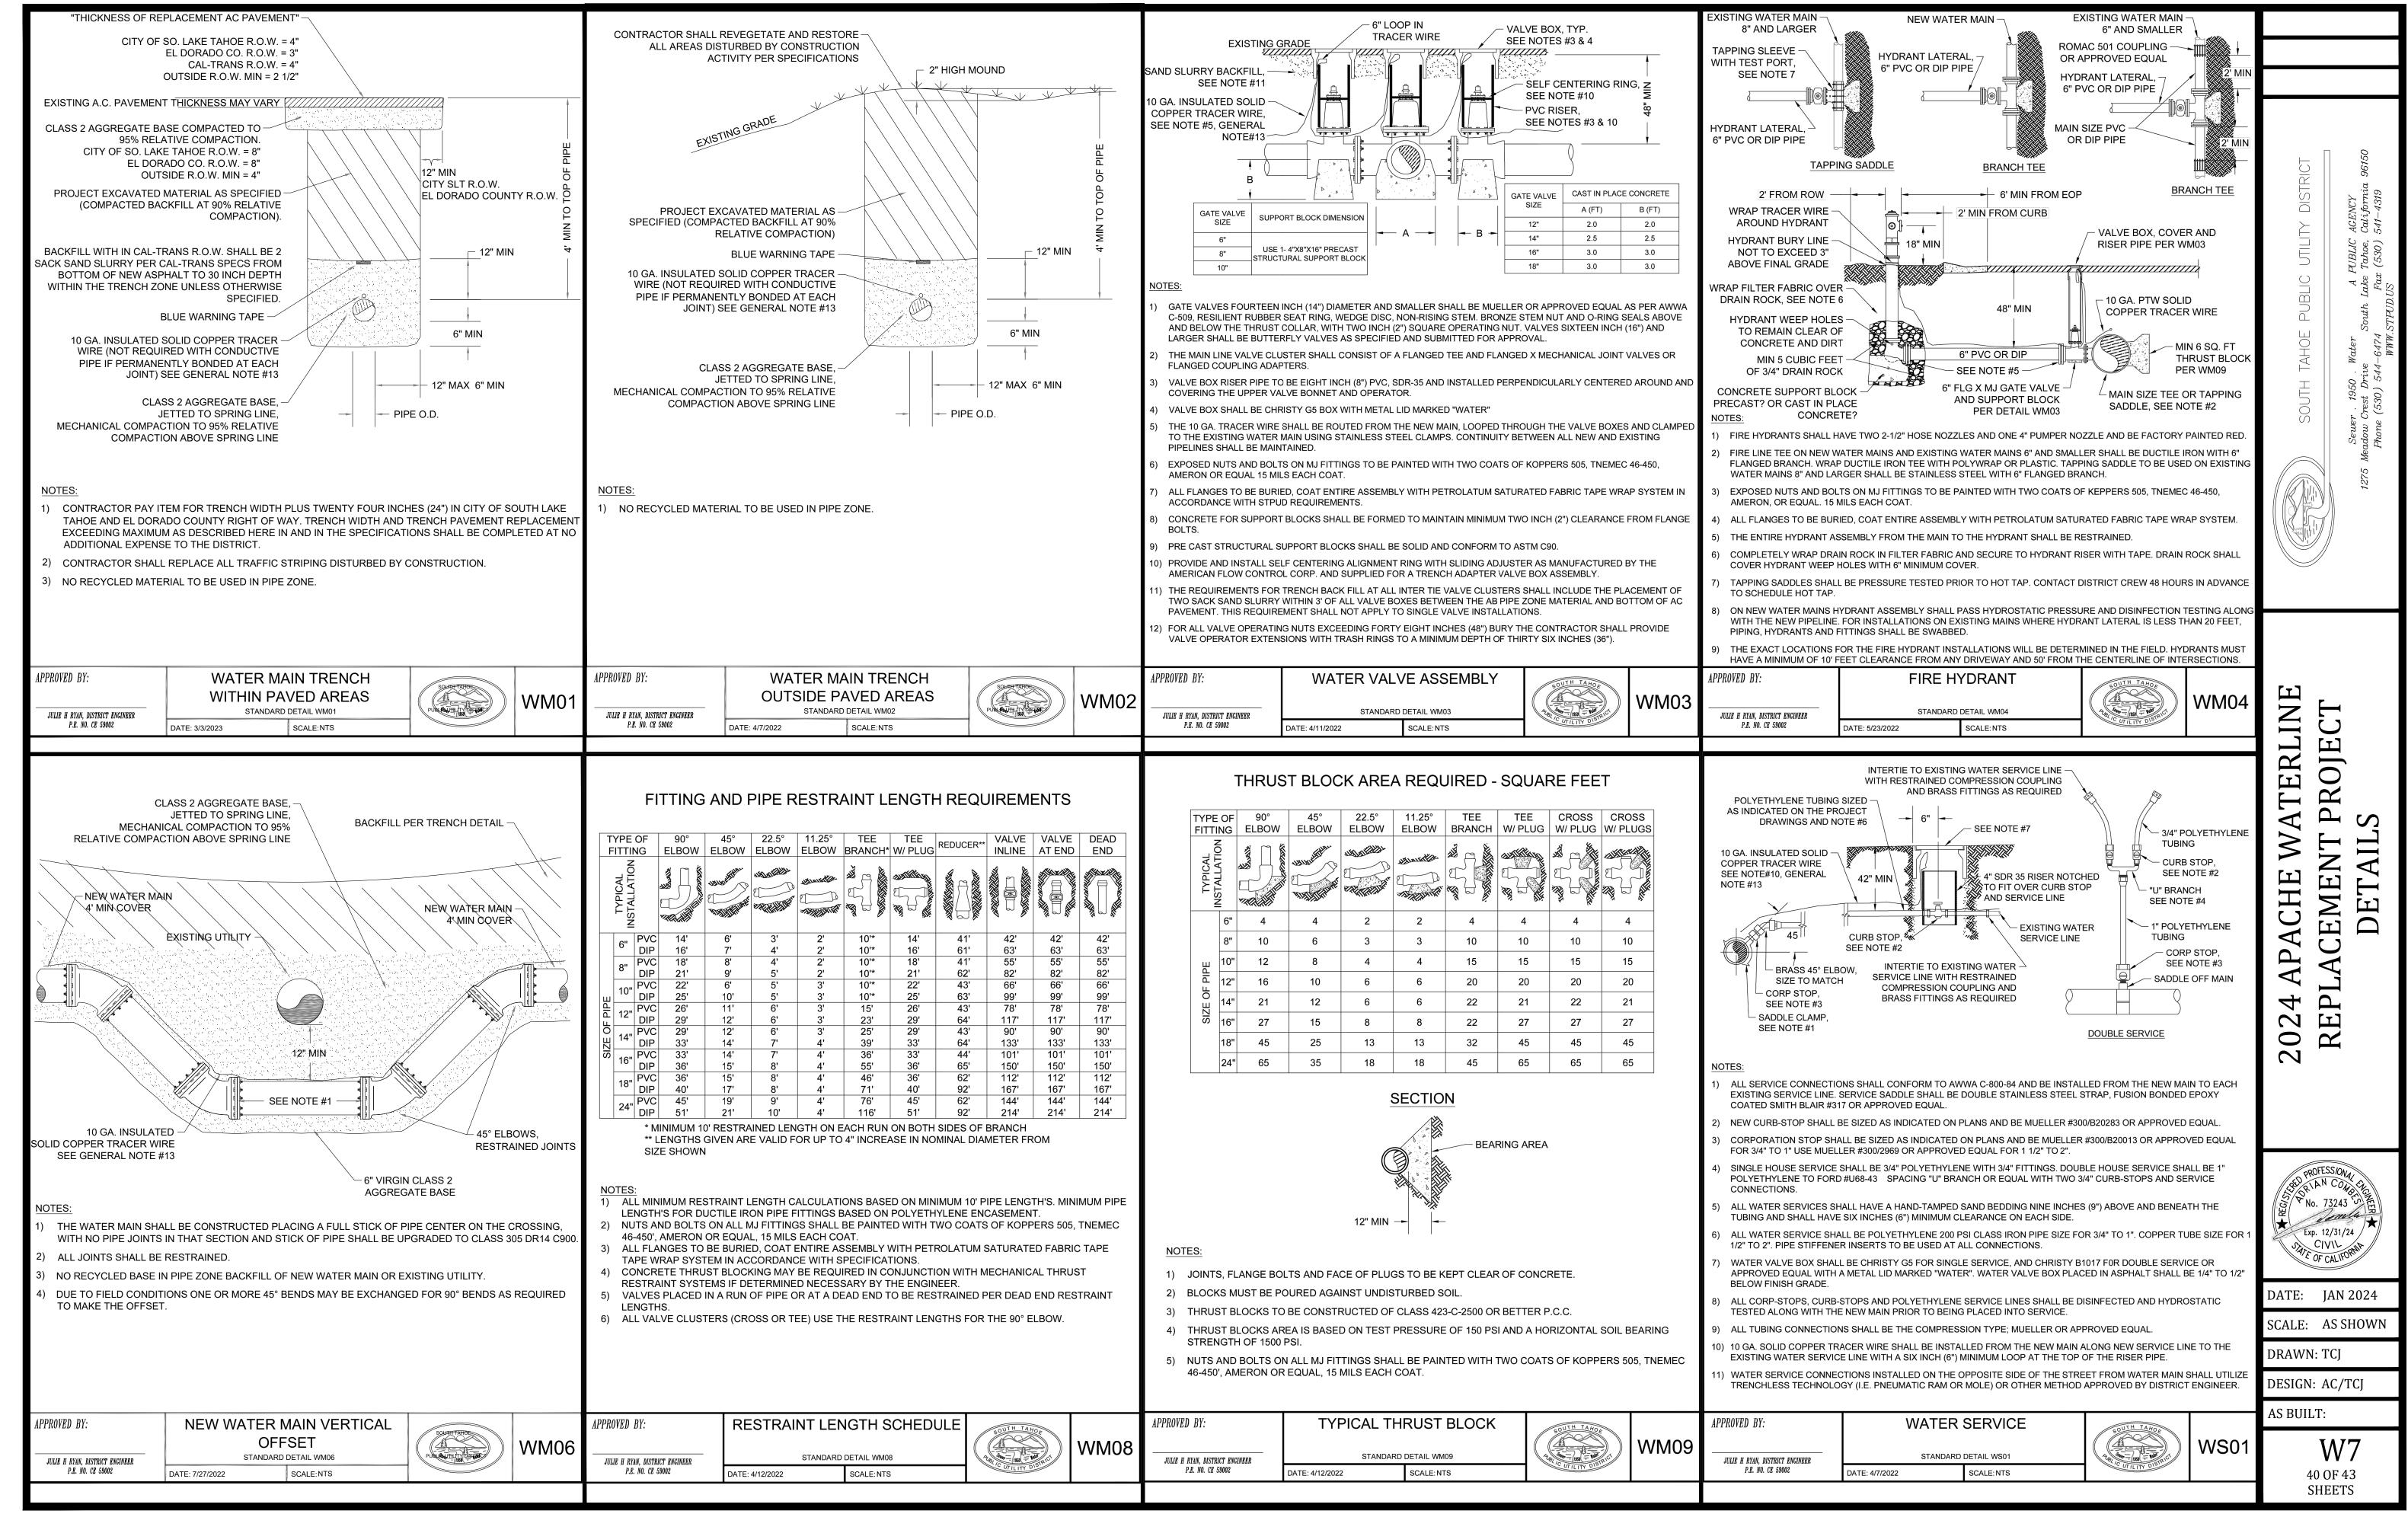

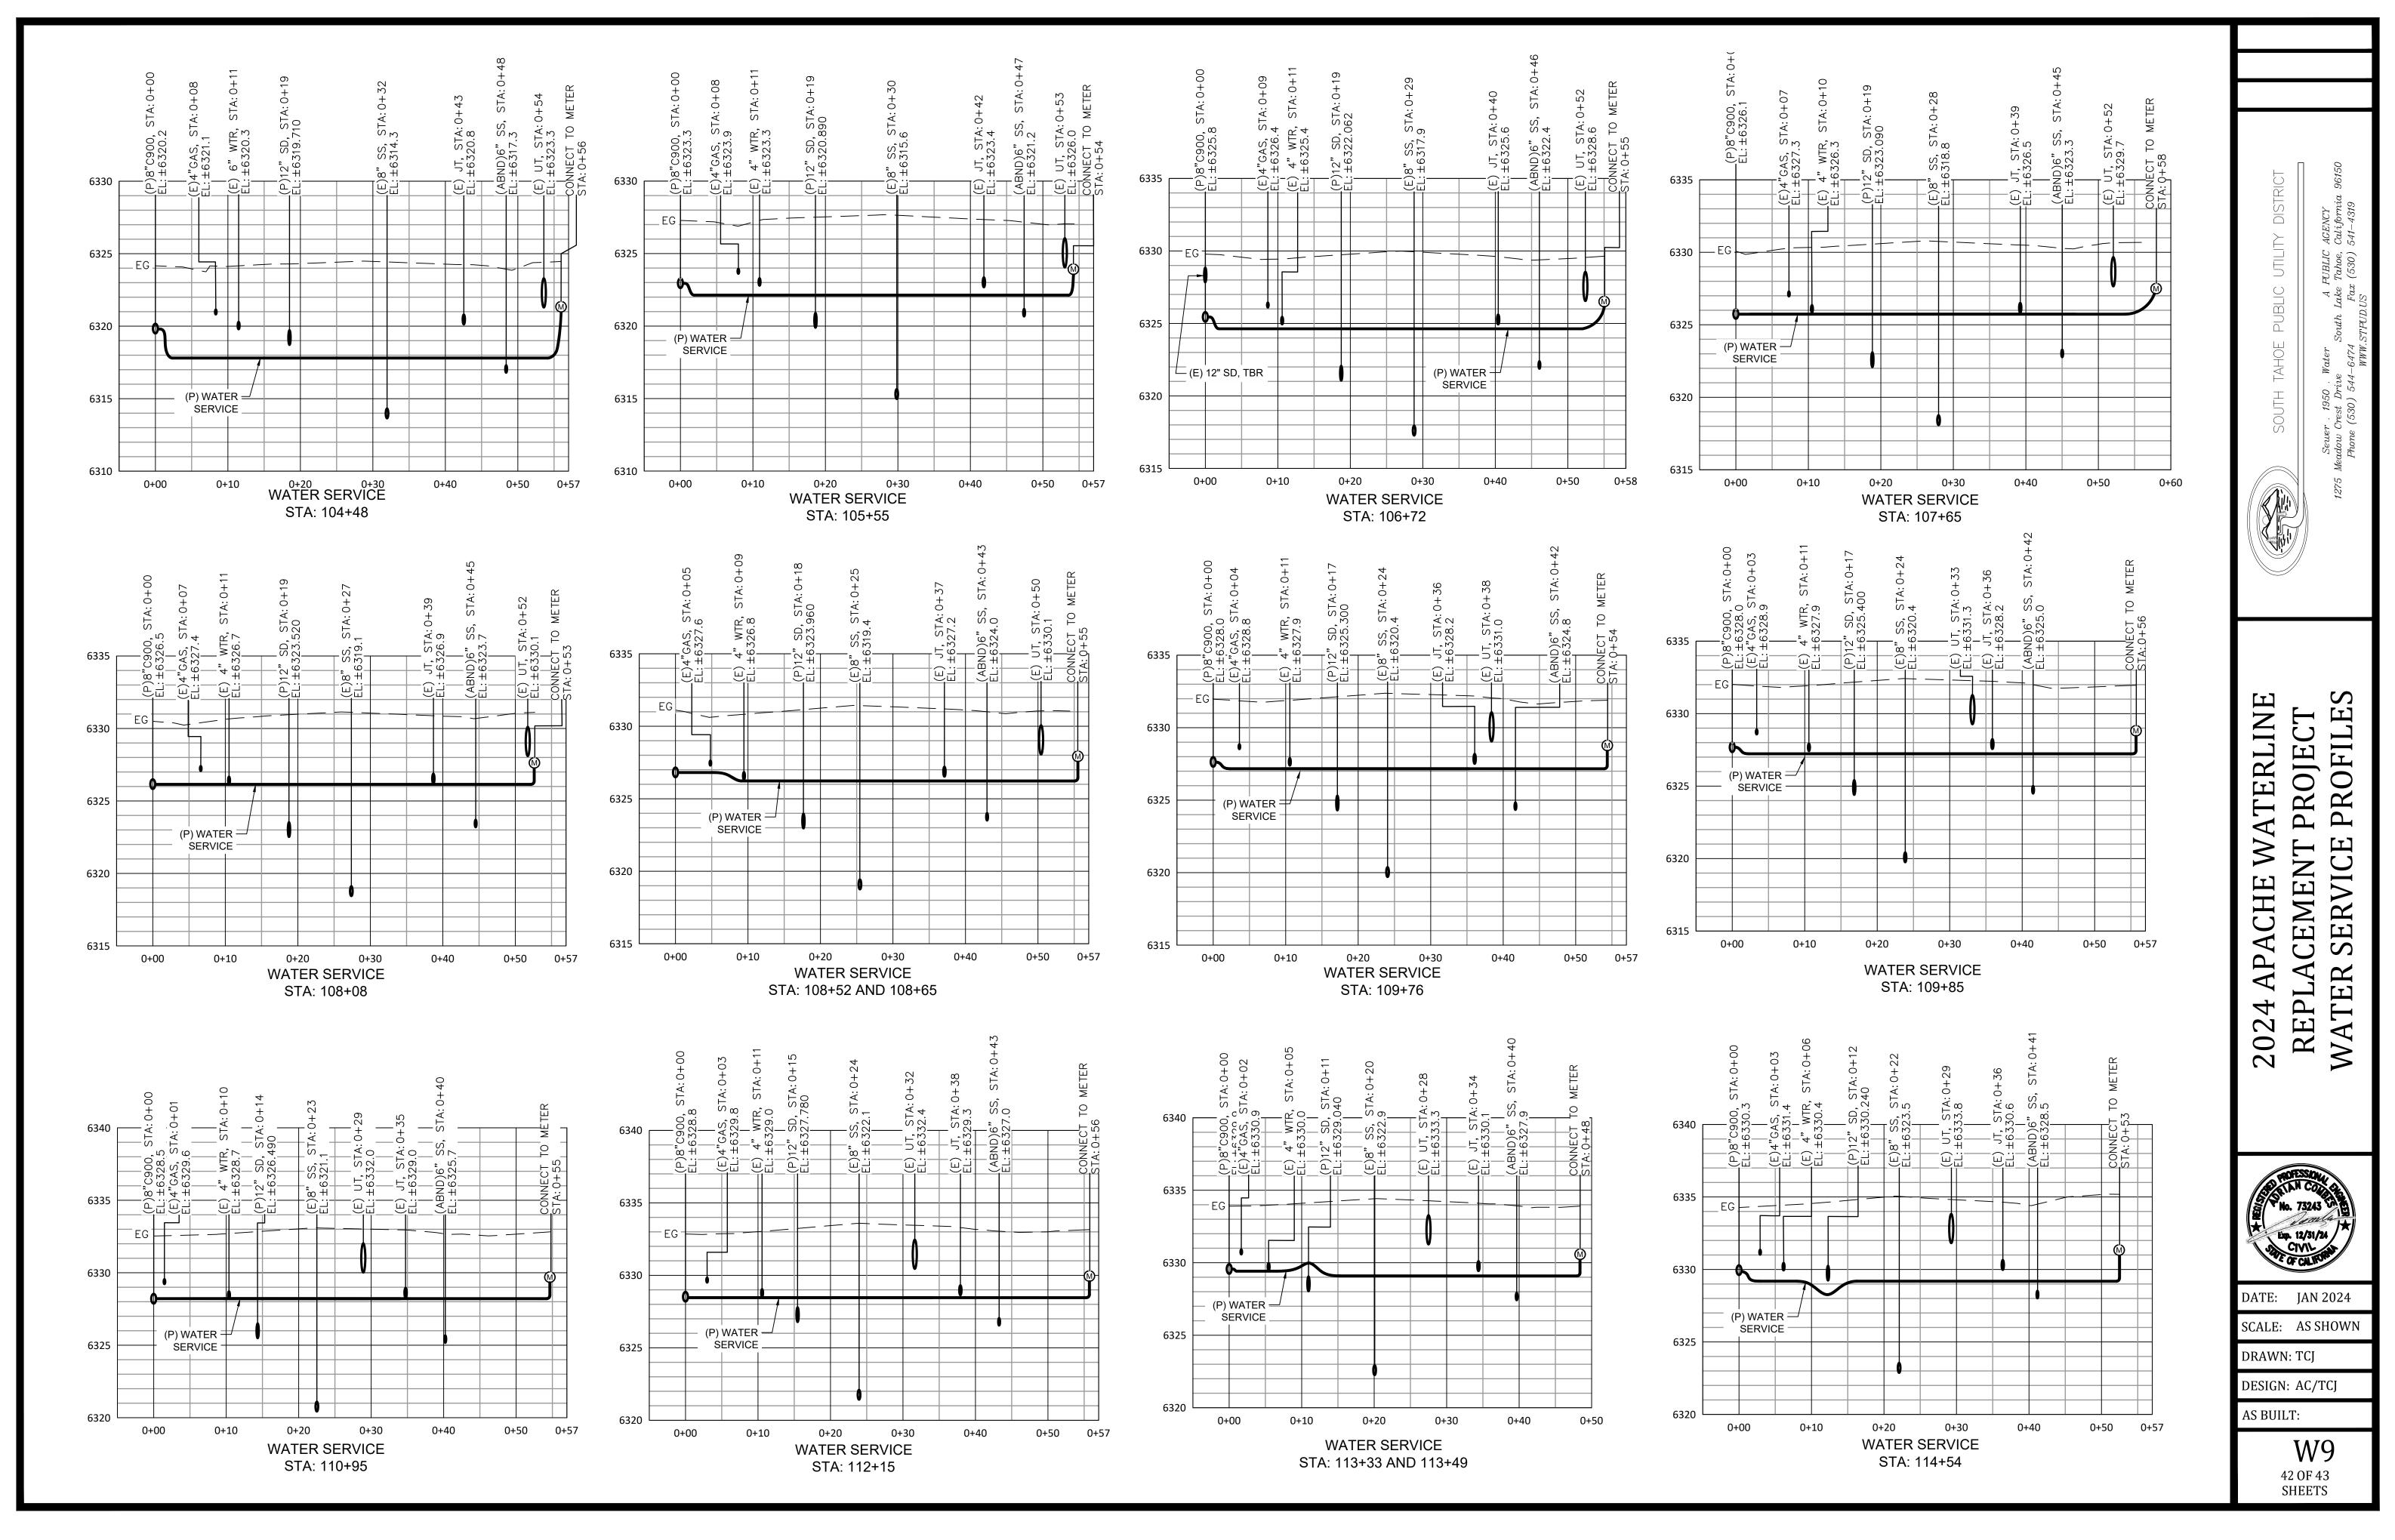


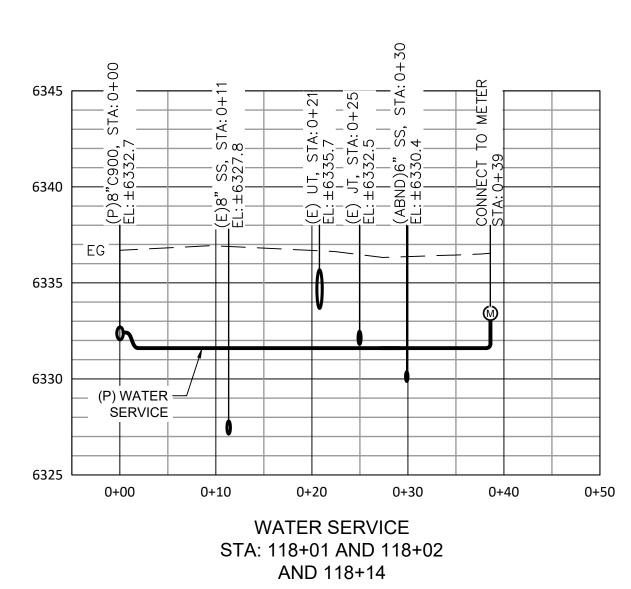

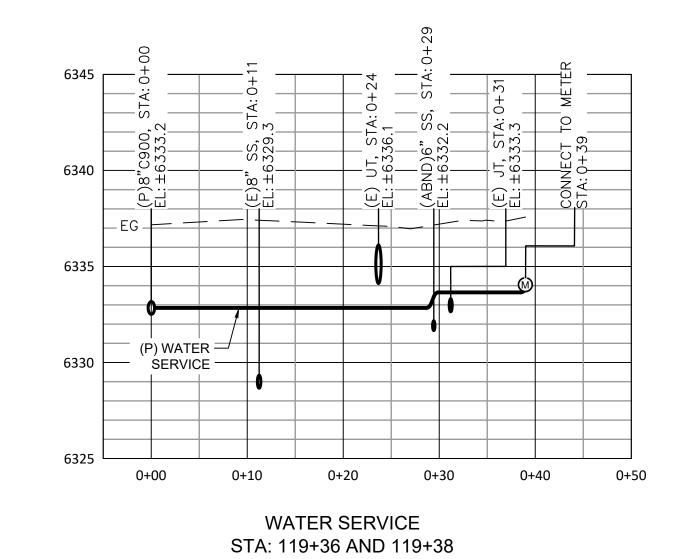


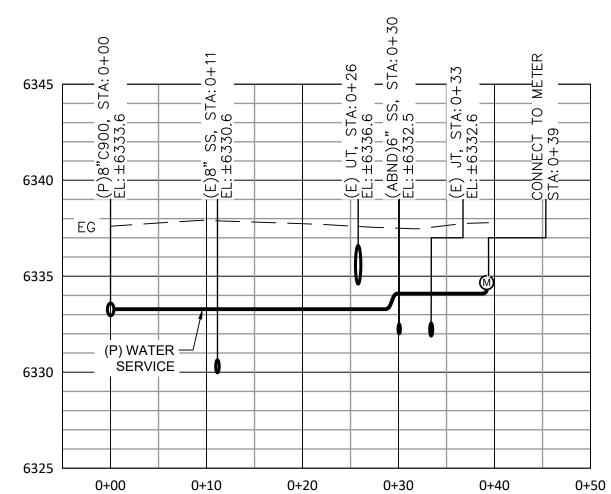


(P) WATER = 6325 0+00 0+50 WATER SERVICE STA: 121+52

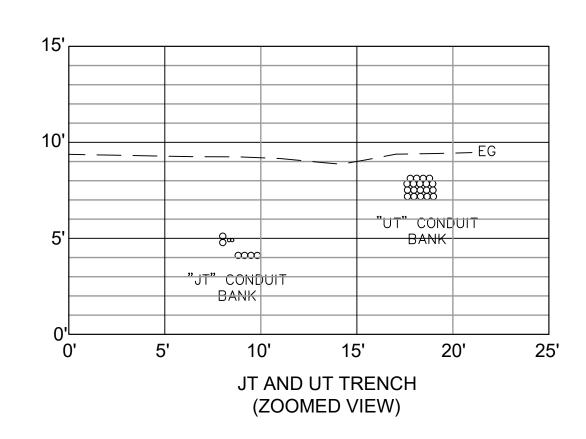

NOTE: THIS DIAGRAM IS FOR SHOWING GENERAL CONFIGURATION OF UTILITY CONDUIT BANKS ALONG APACHE AVE. POSITION OF CONDUITS SHOWN VARY. HORIZONTAL AND VERTICAL DISTANCES ARE TO SHOW SCALE ONLY AND DO NOT REPRESENT STATIONING OR ELEVATION.

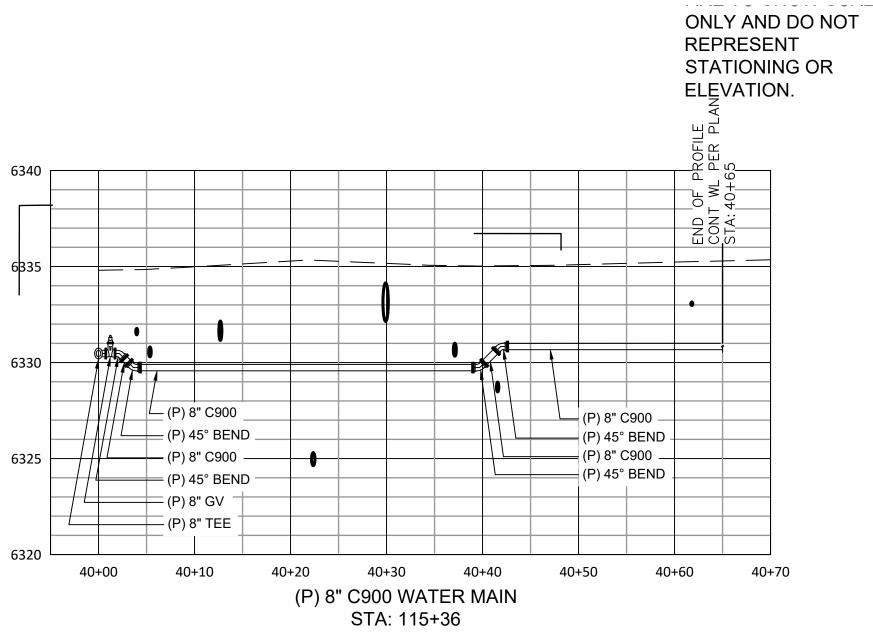

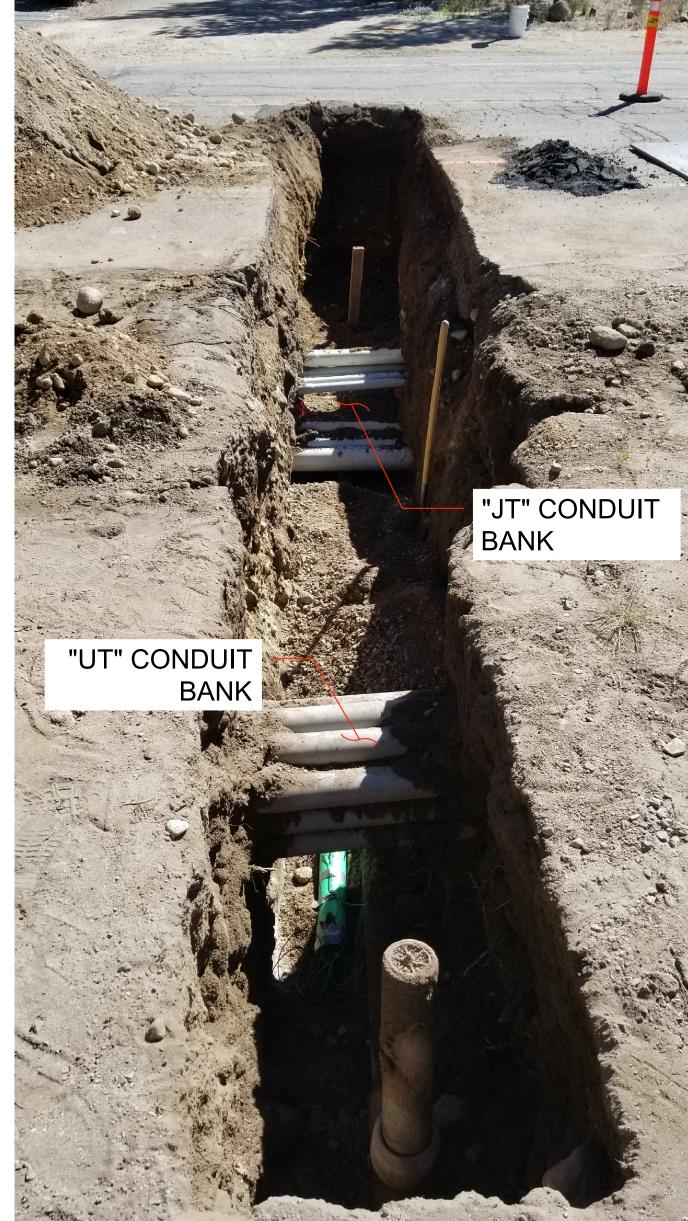





DATE: JAN 2024

SCALE: AS SHOWN

DRAWN: TCJ DESIGN: AC/TCJ

AS BUILT:

W10 43 OF 43 SHEETS