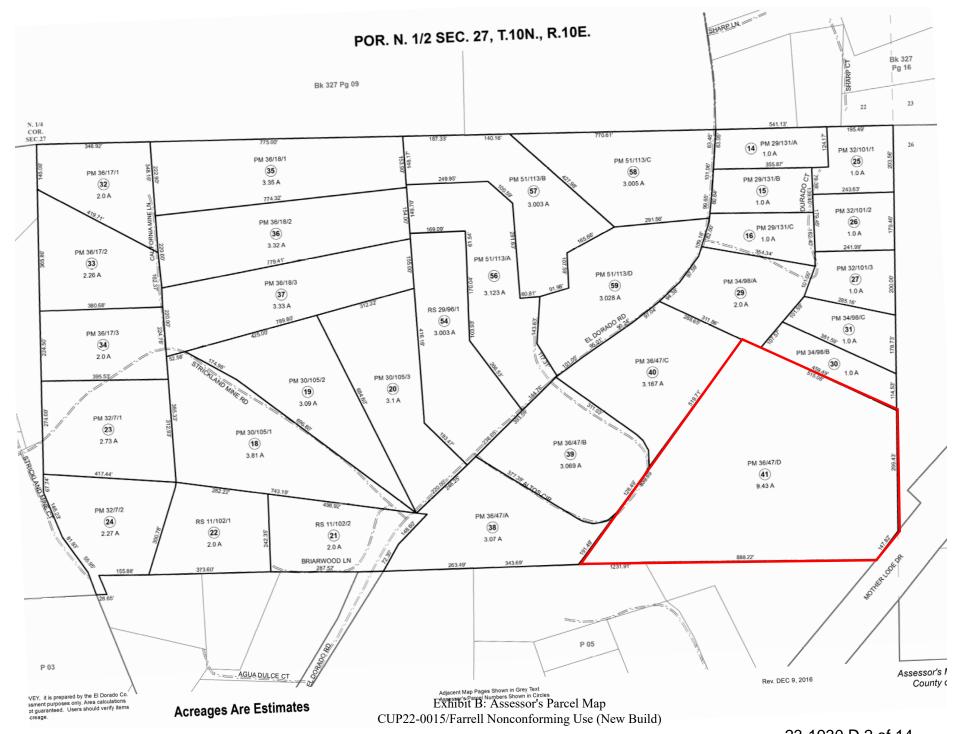


Exhibit A: Location/Vicinity Map CUP22-0015/Farrell Nonconforming Use (New Build)




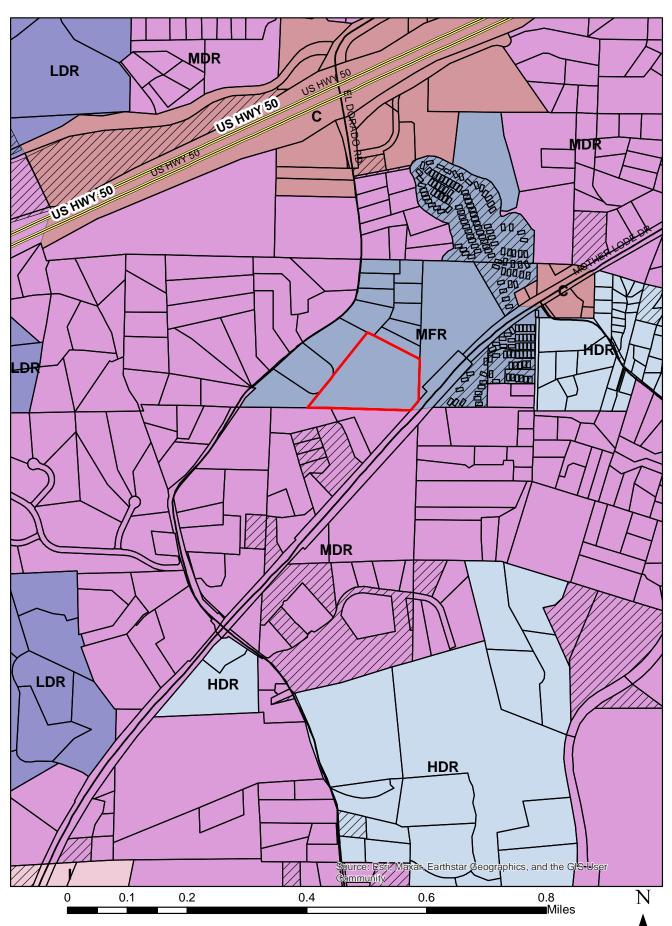


Exhibit C: General Plan Land Use Map CUP22-0015/Farrell Nonconforming Use (New Build)



CUP22-0015/Farrell Nonconforming Use (New Build)


LIVING ROOM AND POOL HOUSE ADDITION 2040 ALTOS CIRCLE, PLACERVILLE, CA 95667

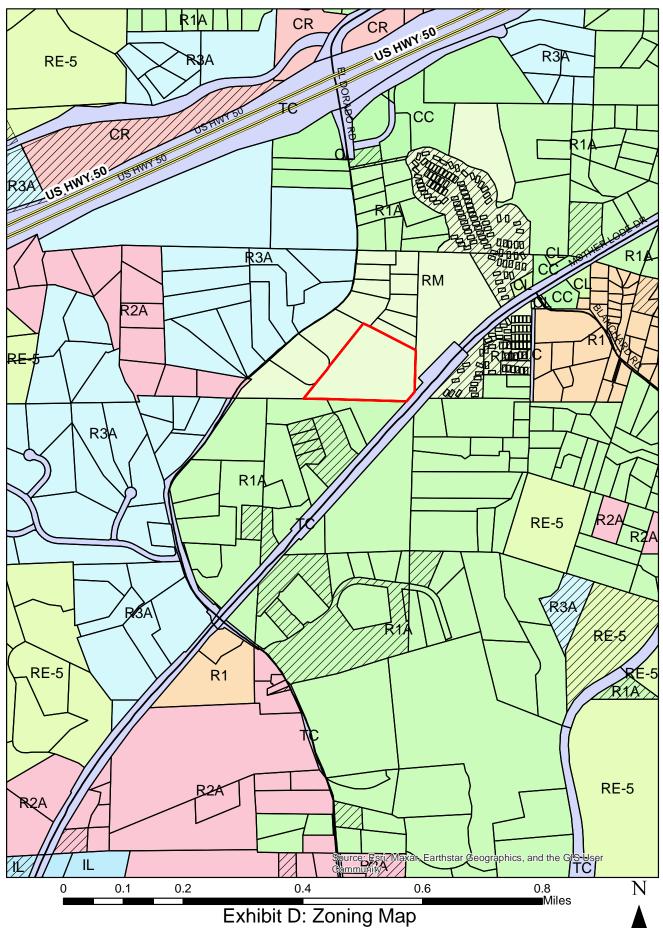




C-000	COVER SHEET
C-100	SITE PLAN
A-100	HOUSE EXISTING FLOOR PLAN
A-101	HOUSE NEW FLOOR PLAN
A-102	POOL HOUSE FLOOR PLAN
A-200	ELEVATIONS
A-201	ELEVATIONS
A-202	ELEVATIONS .
A-300	SECTIONS
A-301	SECTIONS
A-400	3D VIEWS
A-401	3D VIEWS
E-100	ELECTRICAL AND PLUMBING
E-101	ELECTRICAL AND PLUMBING
S-000	NOTES AND SPECIFICATIONS
S-001	NOTES AND SPECIFICATIONS
S-100	FOUNDATION PLAN - POOL HOUSE
S-101	FRAMING PLAN - POOL HOUSE
S-102	ROOF FRAMING PLAN - POOL HOUSE
S-103	FOUNDATION PLAN
S-104	FRAMING PLAN
S-105	ROOF FRAMING PLAN
S-300	SECTIONS
S-301	SECTIONS
S-302	SECTIONS
S-500	STRUCTURAL DETAILS
S-501	STRUCTURAL DETAILS
S-502	STRUCTURAL DETAILS
S-503	STRUCTURAL DETAILS
S-504	STRUCTURAL DETAILS
S-505	STRUCTURAL DETAILS

THE SOLAR SYSTEM PLANS ARE A SEPARATE DRAWING SET, SEE THEM FOR INFORMATION REGARDING THAT SYSTEM.

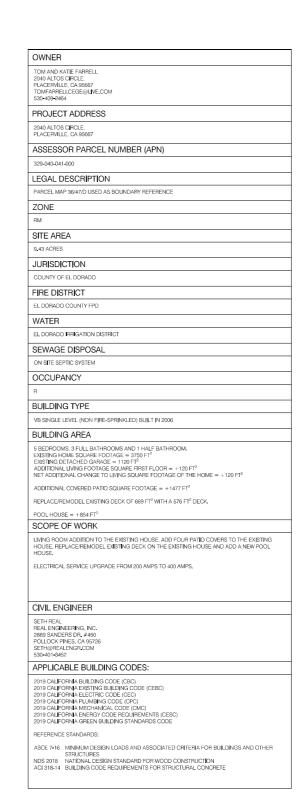

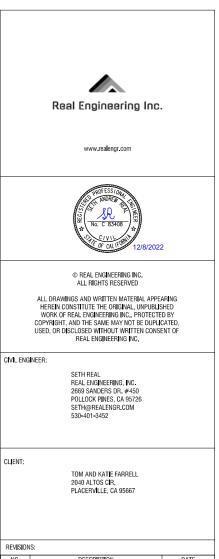

NO.	DESCRIPTION	DATE		
CLIENT NA	ME:			
TOM AND KATIE FARRELL				

TOM AND KATIE FARRELL

PROJECT NAME:

LIVING ROOM AND POOL HOUSE

ADDITION

SHEET NUMBER:

C-000

COVER SHEET

SHEET NAME:

GENERAL NOTES ALL CONSTRUCTION SHALL CONFORM WITH THE 2019 CALIFORNIA RESIDENTIAL CODE (CRC), 2019 CALIFORNIA ELECTRIC CODE (CEC), 2019 CALIFORNIA PLUMBING CODE (CPC), 2019 CALIFORNIA MECHANICAL CODE (CMC), THE 2019 CALIFORNIA ENERGY CODE REQUIREMENTS (CESC), 2019 CALIFORNIA GREEN BUILDING STANDARDS CODE (LOW-RISE RESIDENTIAL) AND LOCAL ORDINANCES TO ASSURE THE SAFETY AND COMPLIANCE OF THE BUILDINGS CONSTRUCTED FROM THESE PLANS. THE CONTRACTOR(S) SHALL REMAIN RESPONSIBLE FOR ALL DETAILING, FABRICATION AND CORRECT FITTING OF MATERIALS, INCLUDING COORDINATION WITH OTHER TRADES. ANY DISCREPANCIES IN THESE PLANS SHALL BE BROUGHT TO THE IMMEDIATE ATTENTION OF THE ENGINEER, BEFORE PROCEEDING WITH THE WORK. CONTRACTORS AND SUB-CONTRACTOR ARE RESPONSIBLE FOR COMPLETE JOB SITE SAFETY PER THE "CONSTRUCTION SAFETY ORDERS" ISSUED BY THE STATE OF CALIFORNIA AND ALL OSHA REQUIREMENTS. THE PROJECT OWNERS, ENGINEERS AND DESIGN CONSULTANTS SHALL NOT BE HELD RESPONSIBLE FOR THE CONTRACTOR'S FAILURE TO COMPLY WITH THESE FILL PLACEMENT: FILLS SHALL BE CONSTRUCTED IN LAYERS (MAXIMUM LOOSE THICKNESS OF 8") OF EARTHEN MATERIAL WITH

NO DETRIMENTAL AMOUNTS OF ORGANIC MATTER AND NO ROCKS

GROUND PREPARATION FOR FILL PLACEMENT: THE NATURAL GROUND MUST BE PREPARED FOR RECEIVING FILL BY REMOVING VEGETATION TOP SOIL LINSUITABLE MATERIAL AND EXISTING NON-COMPLYING FILL. WHERE THE EXISTING SLOPE IS 5:1 OR STEEPER, THE FILL MUST BE BENCHED INTO COMPETENT ORIGINAL MATERIAL WITH A 10 MINIMUM WIDTH KEY WAY AT THE BOTTOM.

SETBACKS: ALL GRADING MUST COMPLY WITH THE SETBACKS SPECIFIED IN THE CALIFORNIA BUILDING CODE.

DRAINAGE: DRAINAGE MUST BE DESIGNED TO PROTECT CUT AND FILL SLOPES AND STRUCTURES FROM EROSION AND WATER DAMAGE AND SHALL DIRECT FLOWS TO THE NEAREST ADEQUATE STREET, STORM DRAIN, OR NATURAL WATER COURSE. WHEN SURFACE DRAINAGE IS DISCHARGED ONTO ADJOINING PROPERTY, IT SHALL BE IN SUCH A MANNER THAT IT WILL NOT CAUSE EROSION OR SEDIMENTATION OR ENDANGER ANY CUTS, FILLS OR STRUCTURES ON THE ADJOINING PROPERTY.

ANY FILL PLACED WITHIN THE BUILDING ENVELOPE, SHALL BE DONE UNDER THE SUPERVISION OF A SOILS ENGINEER.

OWNER TO VERIFY THAT ALL IMPROVEMENTS TO BE MADE TO THE PROPERTY ARE NOT WITHIN RESTRICTED AREAS (EASEMENTS, SETBACKS, ETC.) AND ARE IN CONFORMANCE WITH C.C. AND R's. (IF ANY).

ESTIMATED EARTHWORK: 18 \pm C.Y.s AREA OF DISTURBANCE: 1950 S.F.

EROSION CONTROL AND WINTERIZATION

- SEDIMENT CONTROL MEASURES SHALL BE UTILIZED WHENEVER A 3-DAY FORECAST OF RAIN IS MADE BY THE NATIONAL WEATHER SERVICE ANY TIME DURING THE YEAR. PERMANENT EROSION CONTROL MEASURES MUST BE IN PLACE PRIOR TO FINAL APPROVAL OF THE PERMITTED STRUCTURE OR BY OCTOBER 13 TO MAY 1 IN ANY GIVEN YEAR.

 B. MAN-MADE SLOPES SHALL BE HAND- OR HYDRO-SEEDED AND COVERED WITH PROPERLY-ANCHORED
- BURLAP JUTE OR STRAW MULCH, OR BE PLANTED WITH PERMANENT GROUND COVER.

 C. DITCHES OR SWALES STEEPER THAN 10% SHALL BE COBBLE-LINED, OR PROTECTED WITH AN APPROVED ALTERNATE MATERIAL.

 D. RUNOFF FROM ALL DISTURBED AREAS WILL BE RUN THROUGH A STRAW BALE CHECK DAM OR
- SEDIMENT BASIN AT POINTS OF CONCENTRATION.



www.realengr.com



© REAL ENGINEERING INC. ALL RIGHTS RESERVED

ALL DRAWINGS AND WRITTEN MATERIAL APPEARING HEREIN CONSTITUTE THE ORIGINAL, UNPUBLISHED WORK OF REAL ENGINEERING INC., PROTECTED BY COPYRIGHT, AND THE SAME MAY NOT BE DUPLICATED, USED, OR DISCLOSED WITHOUT WRITTEN CONSENT OF REAL ENGINEERING INC.

CIVIL ENGINEER:


SETH REAL REAL ENGINEERING, INC. 2669 SANDERS DR. #450 POLLOCK PINES, CA 95726 SETH@REALENGR.COM 530-401-3452

CLIENT:

TOM AND KATIE FARRELL

REVISIONS DESCRIPTION TOM AND KATIE FARRELL PROJECT NAME: LIVING ROOM AND POOL HOUSE ADDITION SHEET NUMBER: C-100 SHEET NAME: SITE PLAN 12/08/2022 185 SR

1" = 50'

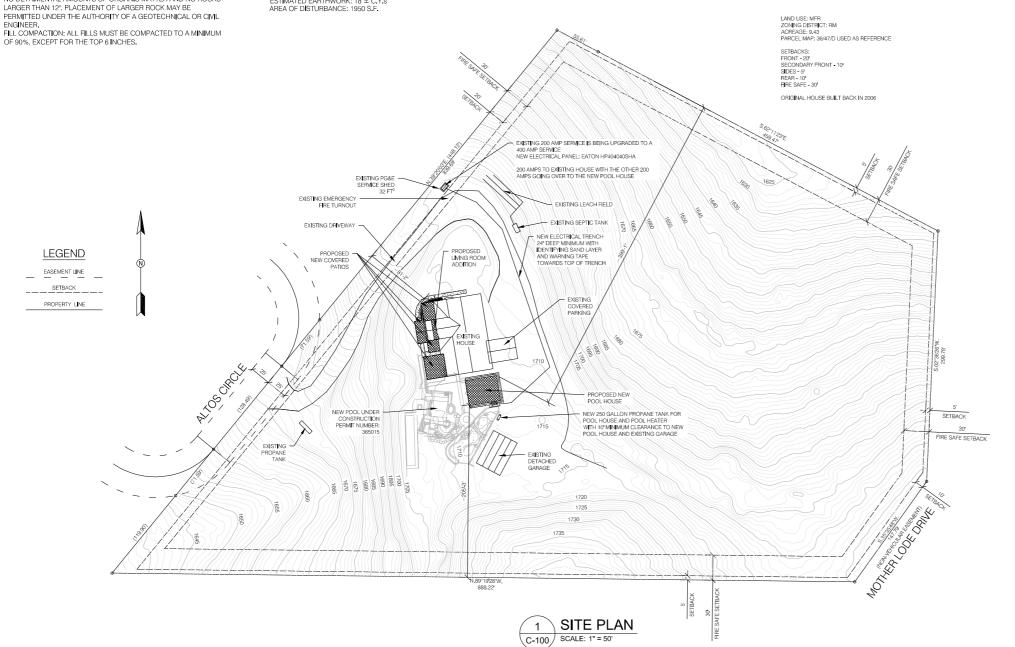

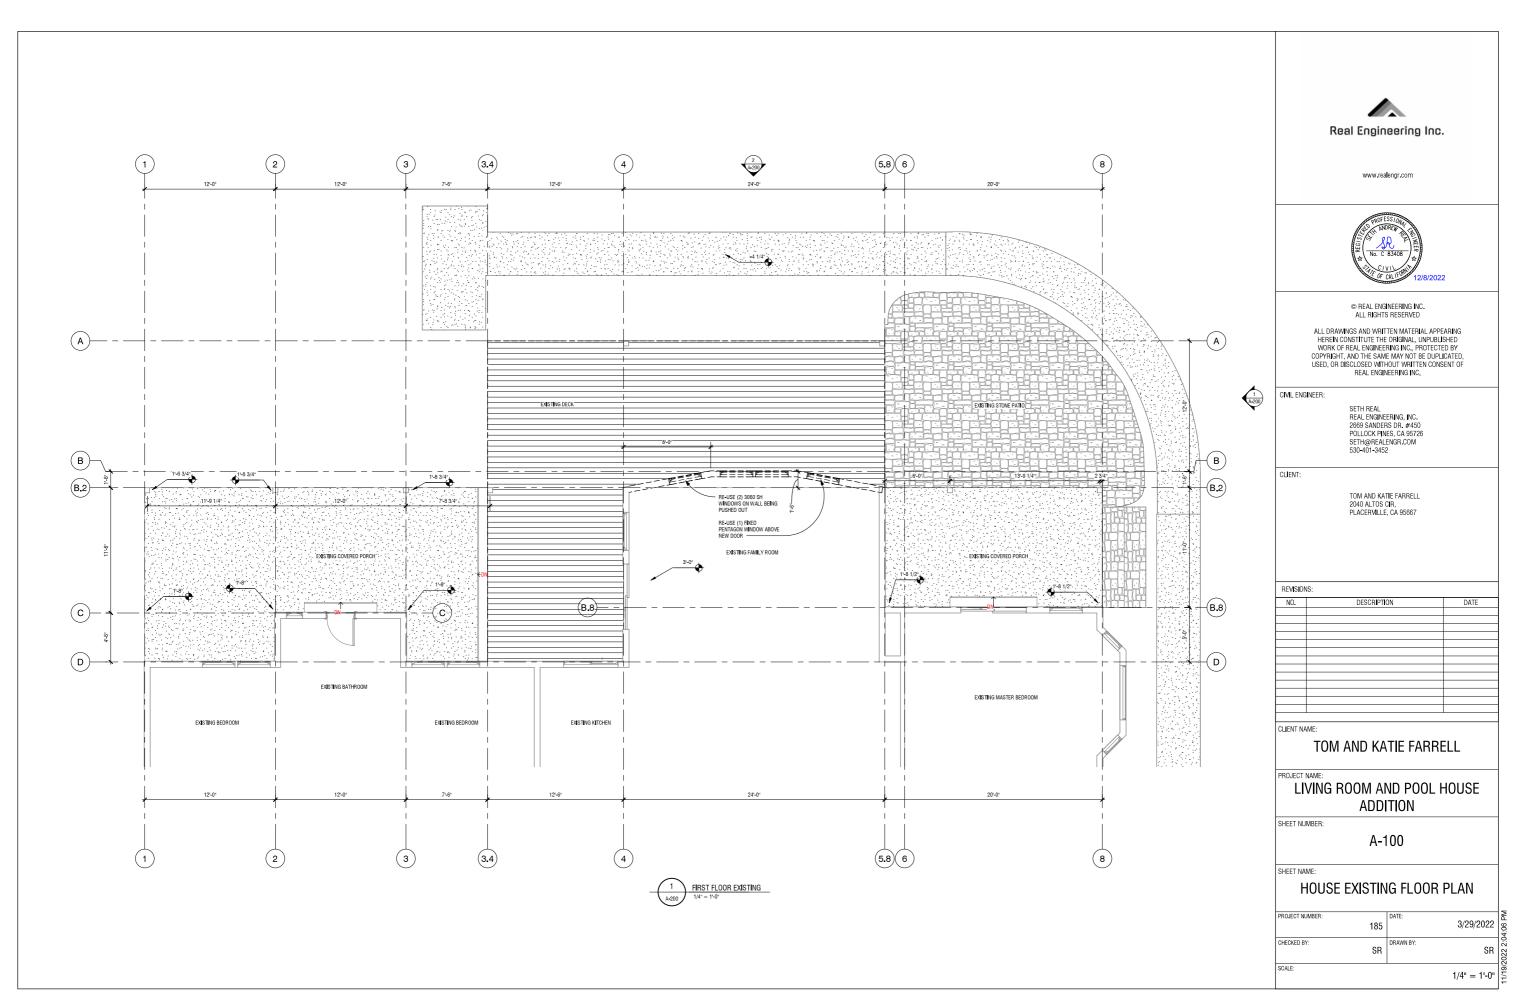
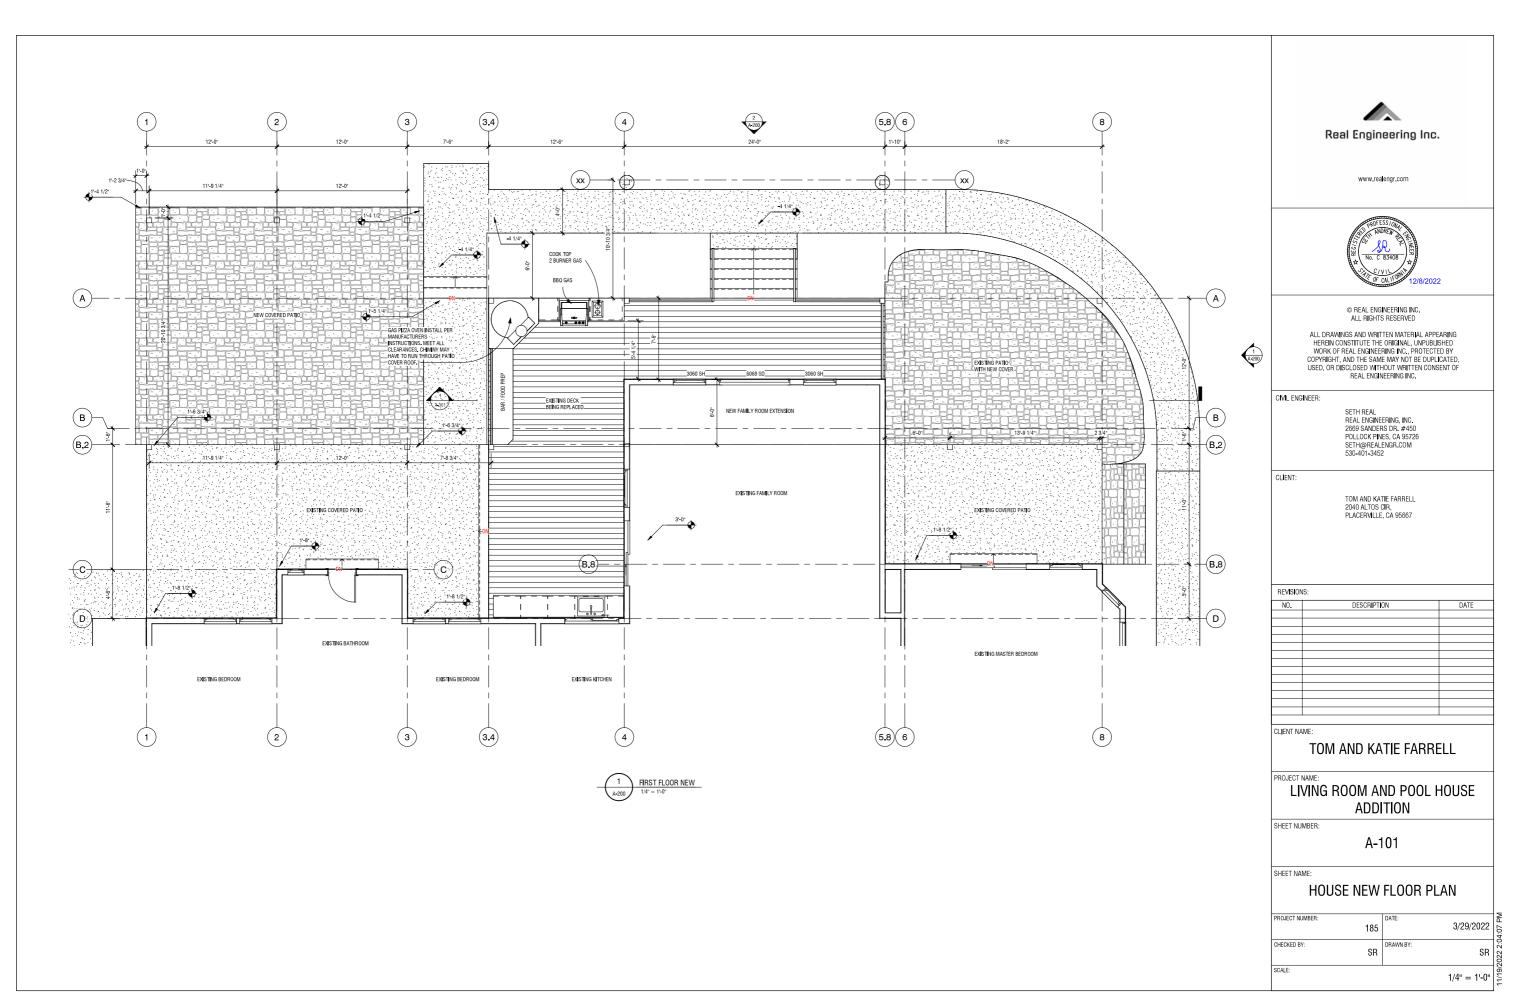


Exhibit E: Project Plan Sheets CUP22-0015/Farrell Nonconforming Use (New Build)



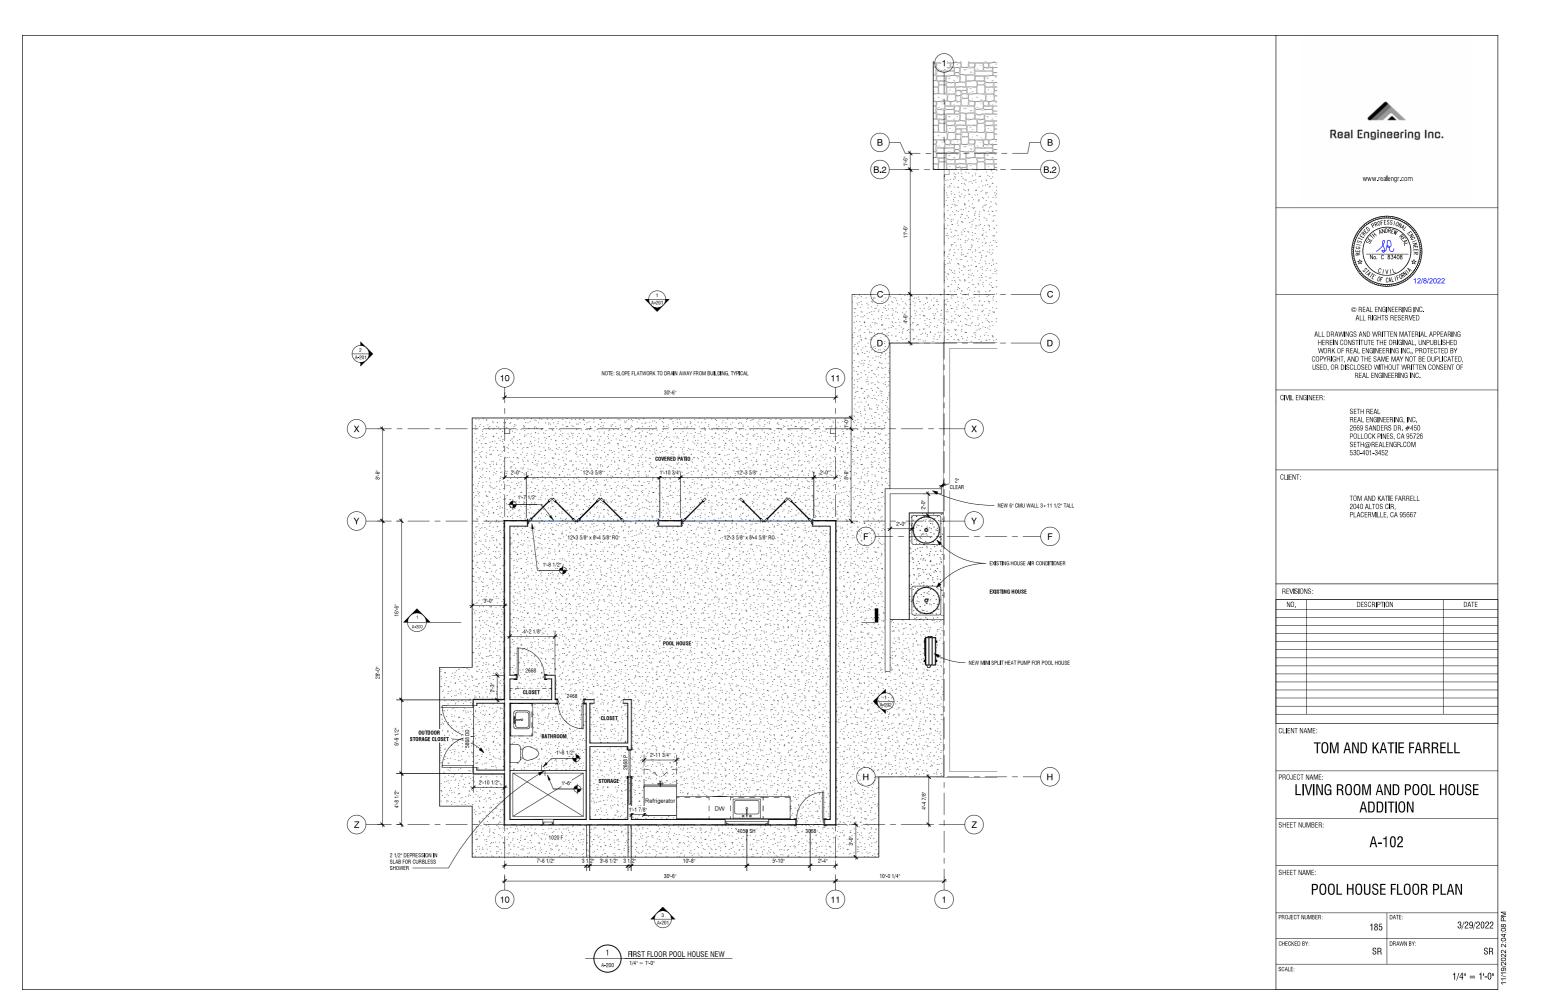


Exhibit E: Project Plan Sheets CUP22-0015/Farrell Nonconforming Use (New Build)

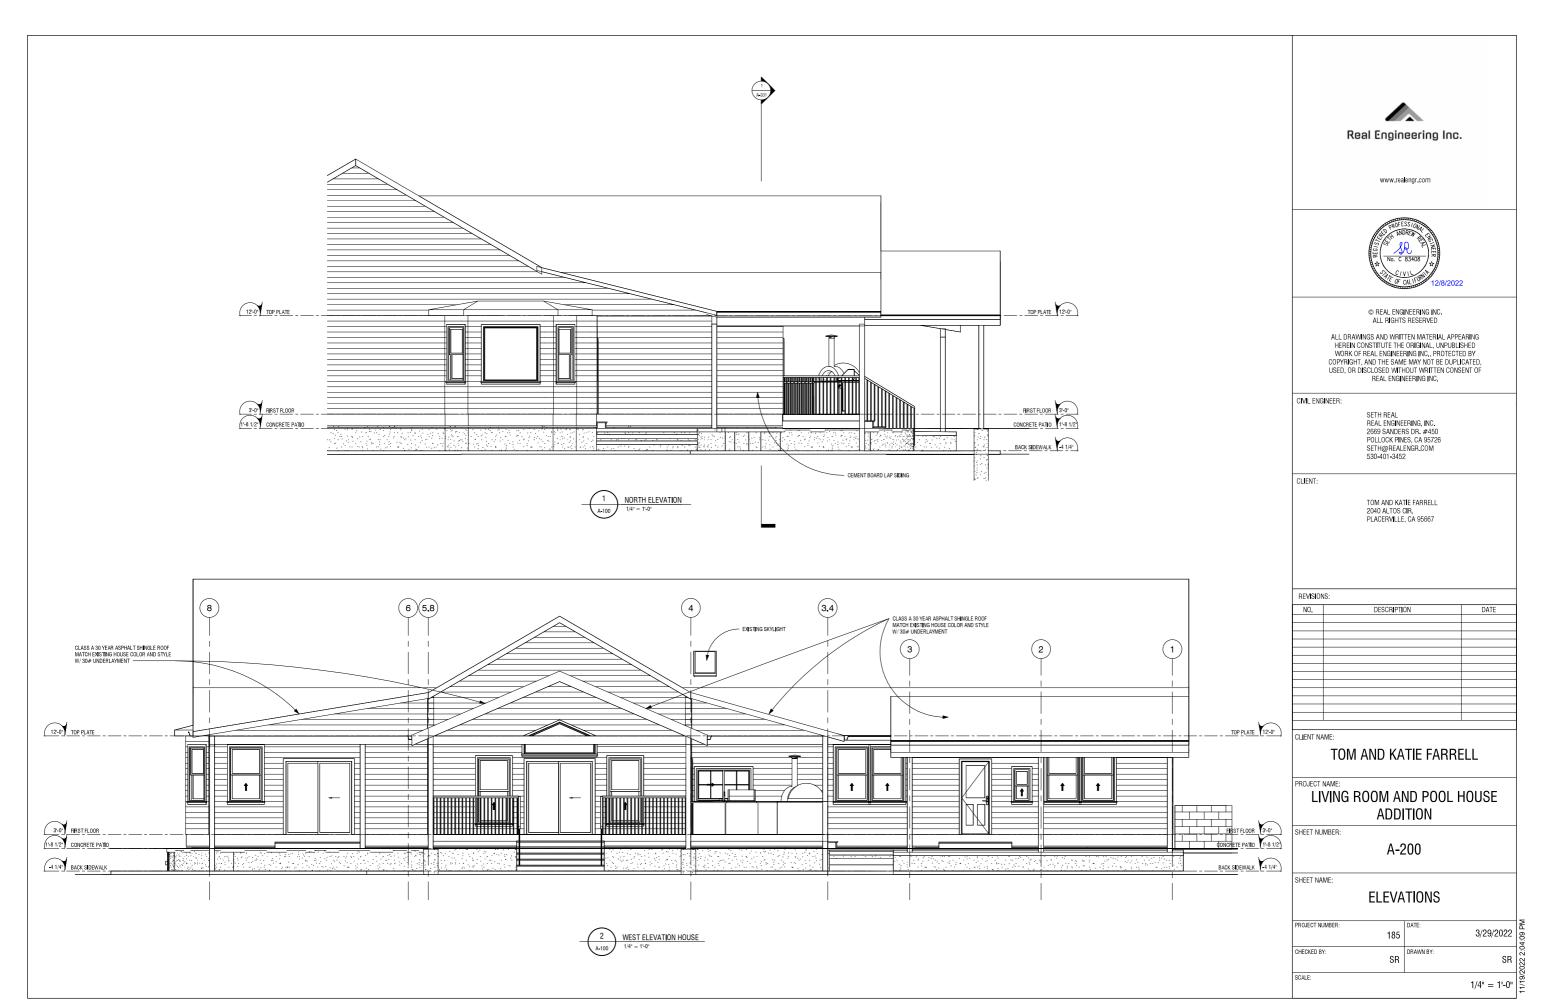


Exhibit E: Project Plan Sheets CUP22-0015/Farrell Nonconforming Use (New Build)

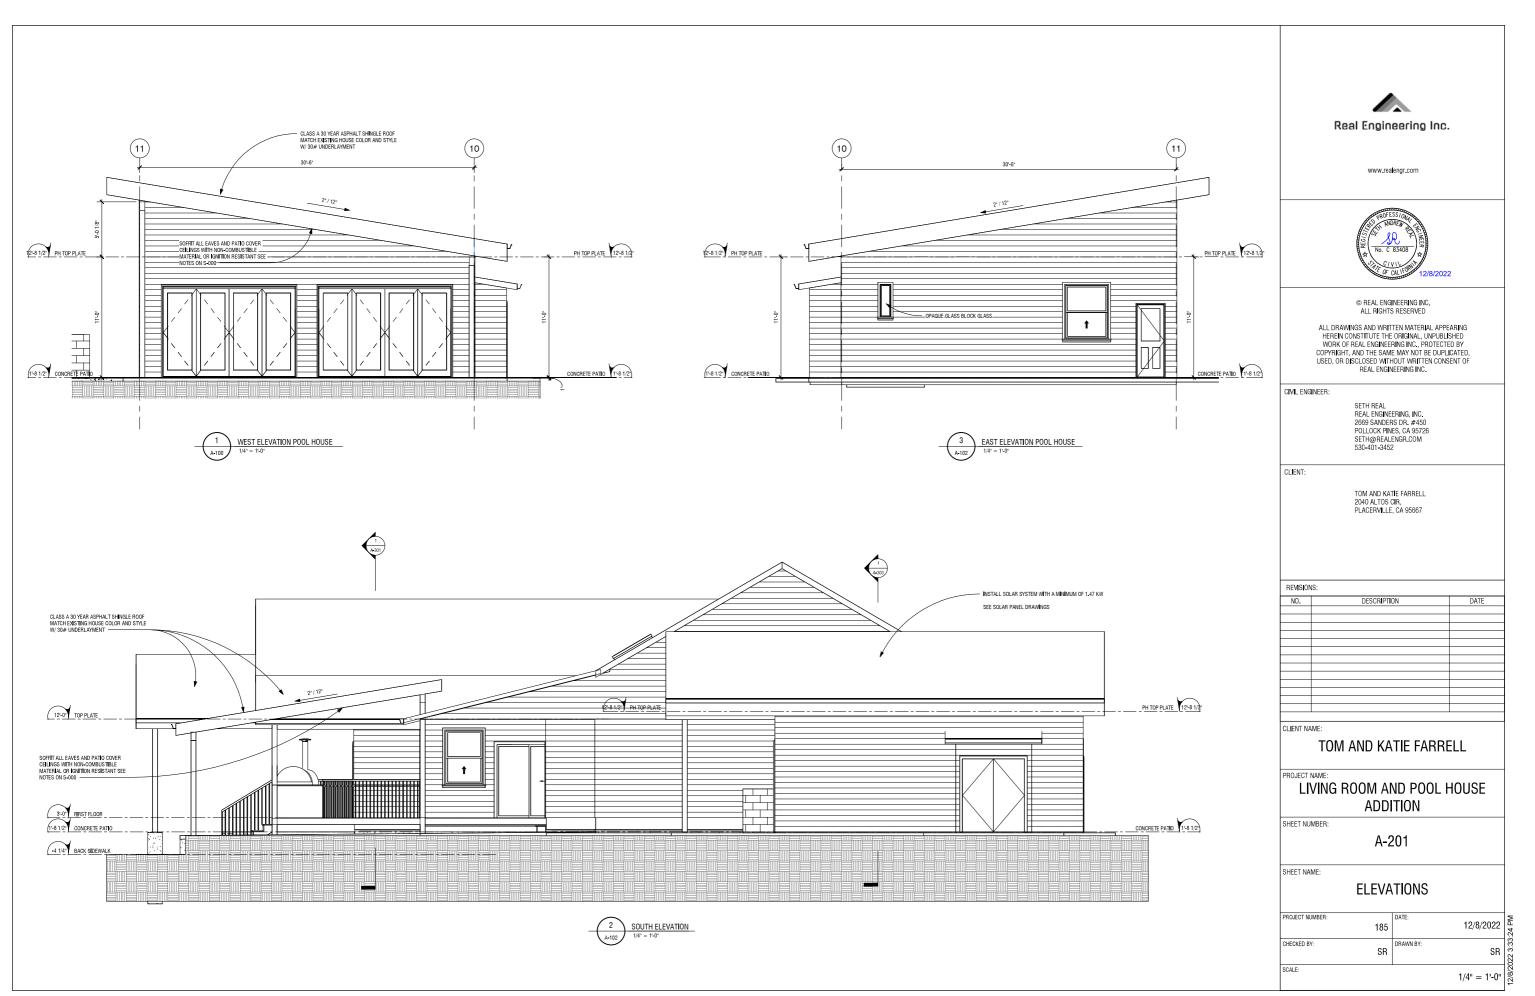


Exhibit E: Project Plan Sheets CUP22-0015/Farrell Nonconforming Use (New Build)

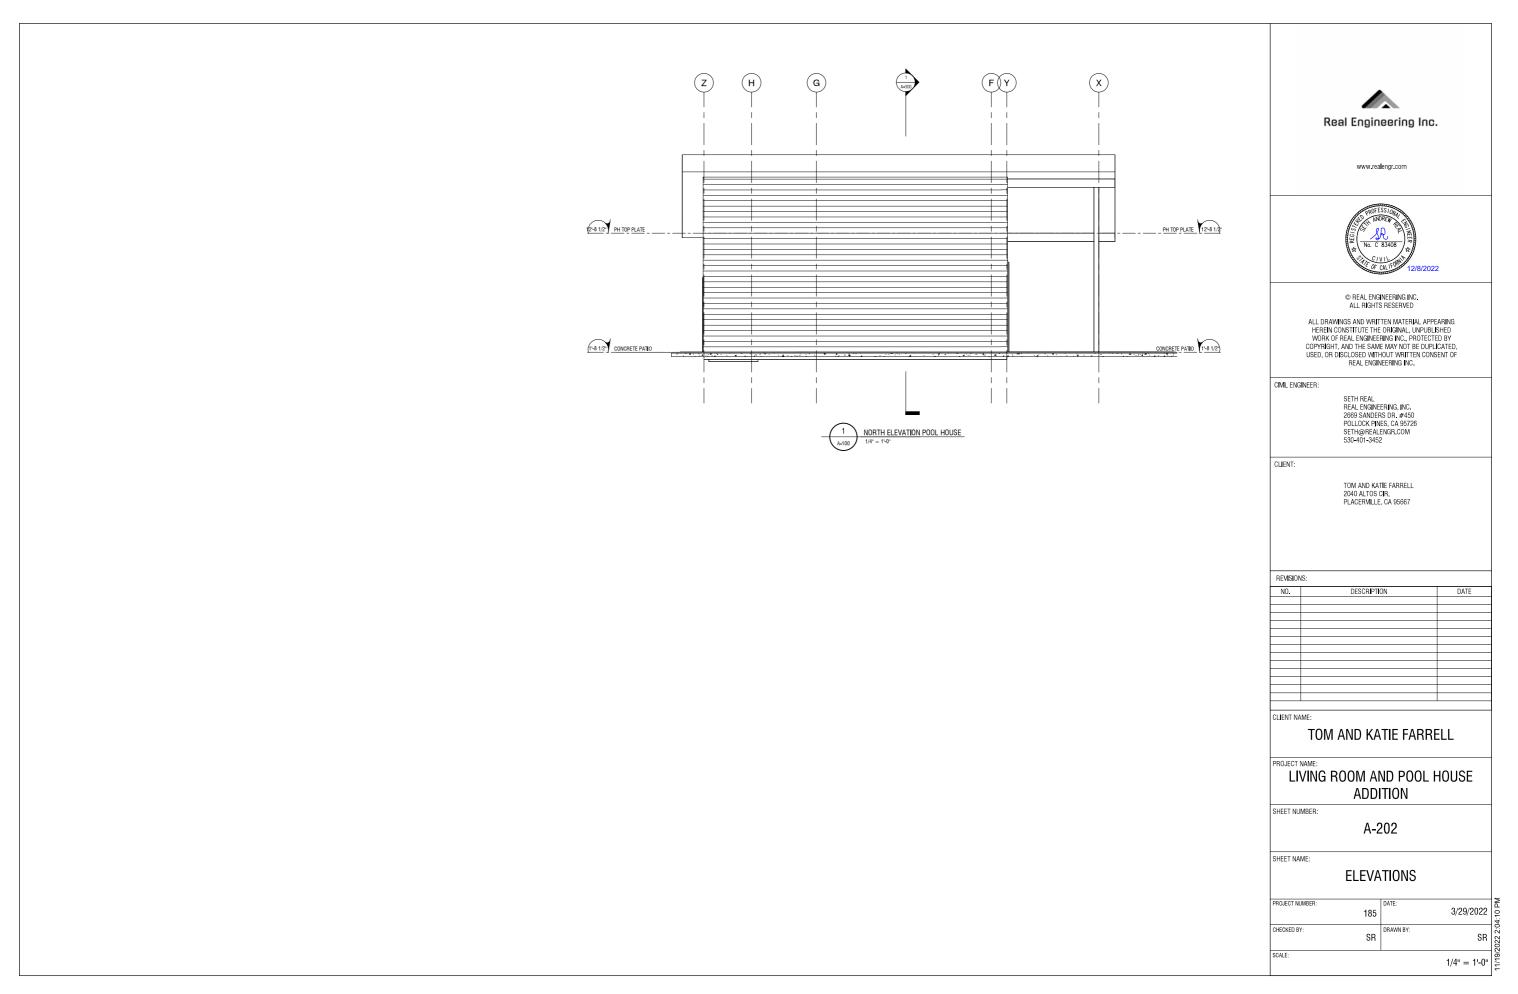




Exhibit E: Project Plan Sheets CUP22-0015/Farrell Nonconforming Use (New Build)





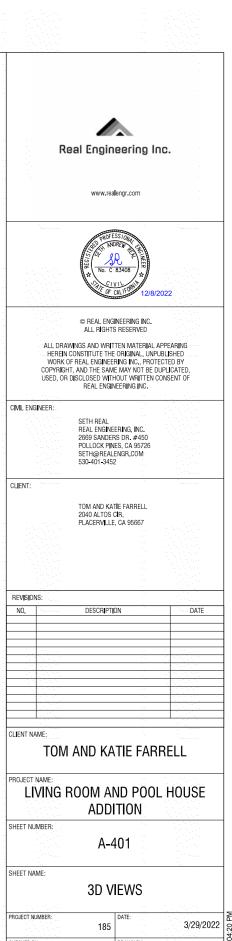


Exhibit E: Project Plan Sheets
CUP22-0015/Farrell Nonconforming Use (New Build)

SR