

NO.	DATE	REVISION




PREPARED UNDER THE SUPERVISION OF:
REGISTERED CIVIL ENGINEER

DATE: 04/20/10
PROJECT NO: 95178

EL DORADO COUNTY
DEPARTMENT OF TRANSPORTATION

RUBICON S EROSION CONTROL PROJECT
SURVEY ALIGNMENTS AND CONTROL POINT LISTING
SHEET NO. 4 OF 26
DATE: 09-20-09
BY: 95178


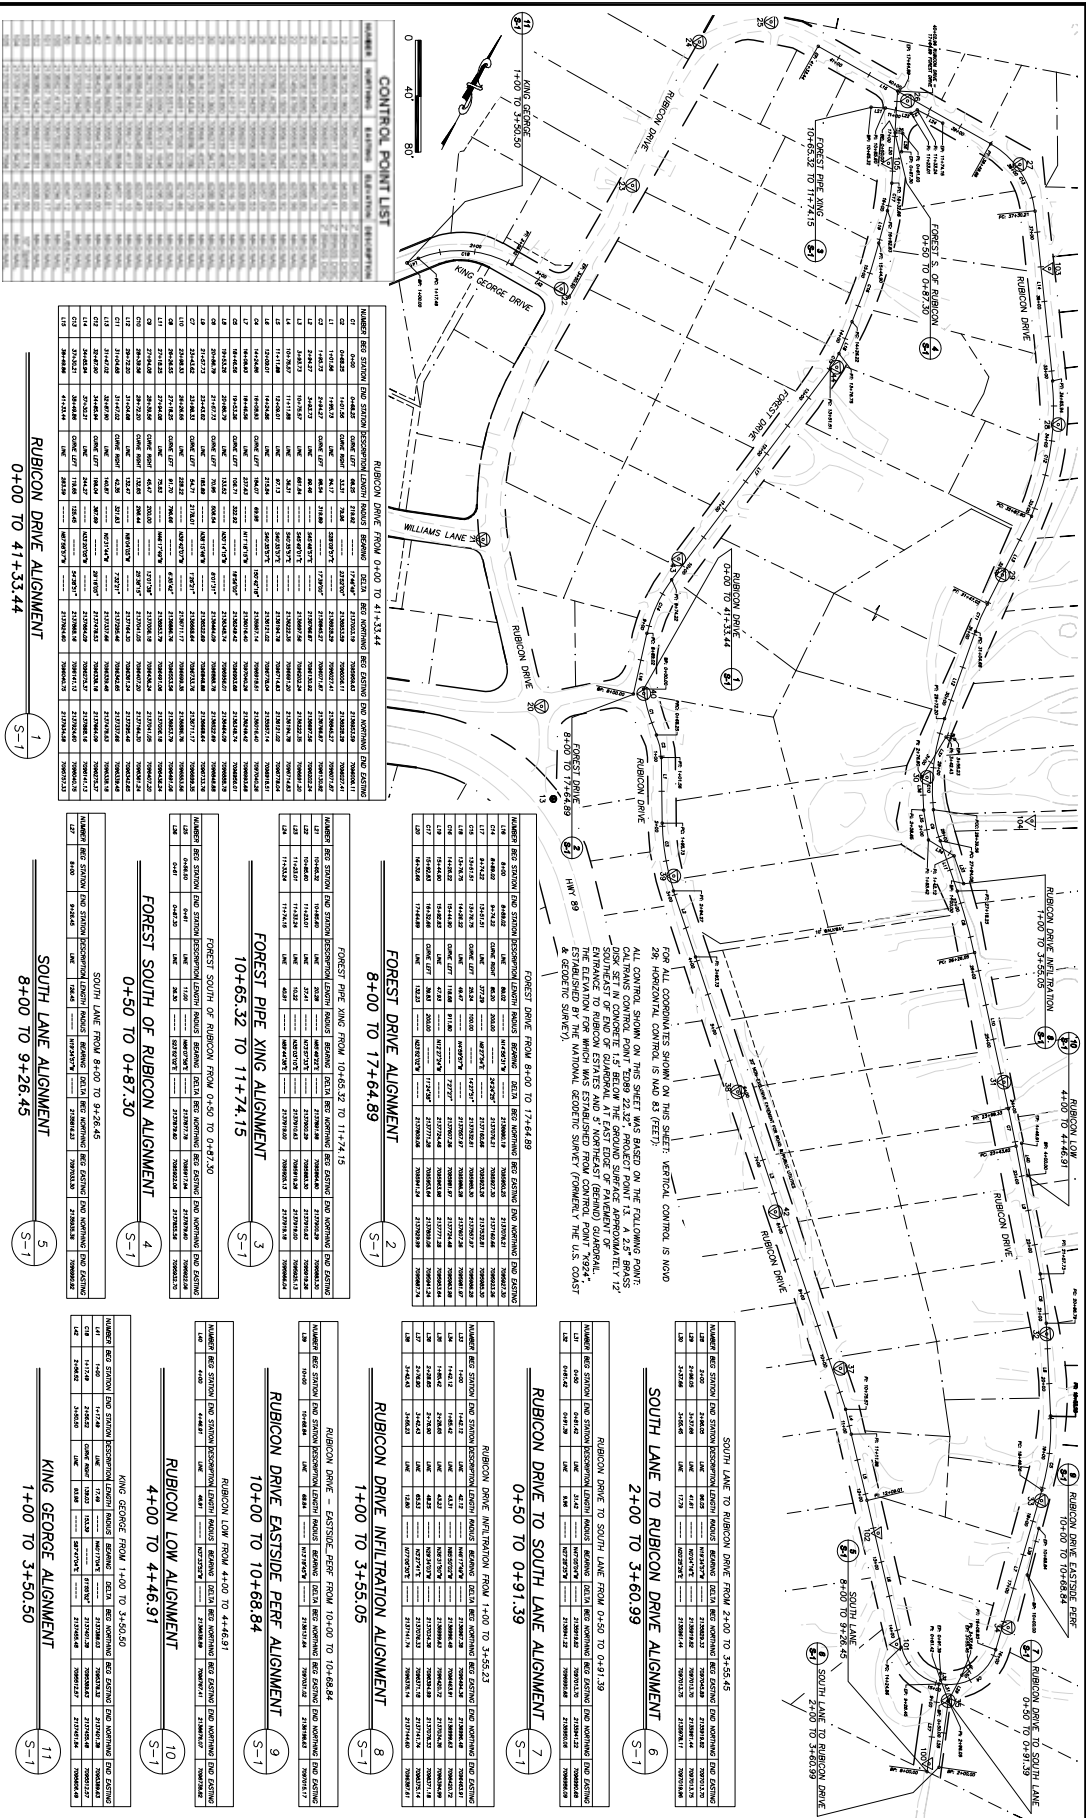


CONTROL POINT LIST

STATION	POINT NO.	ELEVATION	DESCRIPTION
0+00	1	1000.00	BM
0+00	2	1000.00	BM
0+00	3	1000.00	BM
0+00	4	1000.00	BM
0+00	5	1000.00	BM
0+00	6	1000.00	BM
0+00	7	1000.00	BM
0+00	8	1000.00	BM
0+00	9	1000.00	BM
0+00	10	1000.00	BM
0+00	11	1000.00	BM
0+00	12	1000.00	BM
0+00	13	1000.00	BM
0+00	14	1000.00	BM
0+00	15	1000.00	BM
0+00	16	1000.00	BM
0+00	17	1000.00	BM
0+00	18	1000.00	BM
0+00	19	1000.00	BM
0+00	20	1000.00	BM
0+00	21	1000.00	BM
0+00	22	1000.00	BM
0+00	23	1000.00	BM
0+00	24	1000.00	BM
0+00	25	1000.00	BM
0+00	26	1000.00	BM
0+00	27	1000.00	BM
0+00	28	1000.00	BM
0+00	29	1000.00	BM
0+00	30	1000.00	BM
0+00	31	1000.00	BM
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0+00	33	1000.00	BM
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0+00	36	1000.00	BM
0+00	37	1000.00	BM
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0+00	75	1000.00	BM
0+00	76	1000.00	BM
0+00	77	1000.00	BM
0+00	78	1000.00	BM
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0+00	85	1000.00	BM
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0+00	97	1000.00	BM
0+00	98	1000.00	BM
0+00	99	1000.00	BM
0+00	100	1000.00	BM

RUBICON DRIVE FROM 0+00 TO 41+33.44

STATION	POINT NO.	ELEVATION	DESCRIPTION
0+00	1	1000.00	BM
0+00	2	1000.00	BM
0+00	3	1000.00	BM
0+00	4	1000.00	BM
0+00	5	1000.00	BM
0+00	6	1000.00	BM
0+00	7	1000.00	BM
0+00	8	1000.00	BM
0+00	9	1000.00	BM
0+00	10	1000.00	BM
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0+00	94	1000.00	BM
0+00	95	1000.00	BM
0+00	96	1000.00	BM
0+00	97	1000.00	BM
0+00	98	1000.	

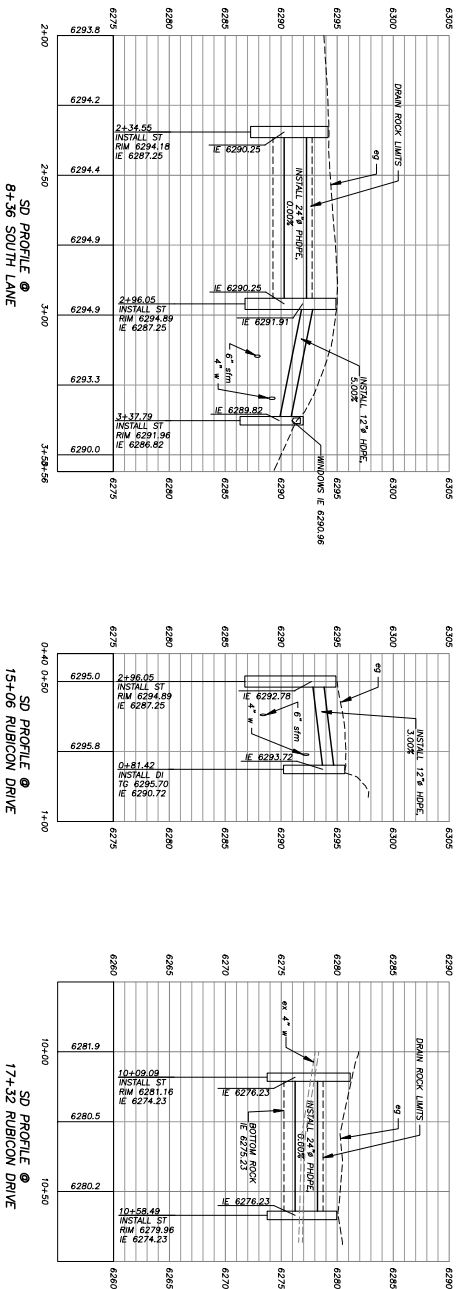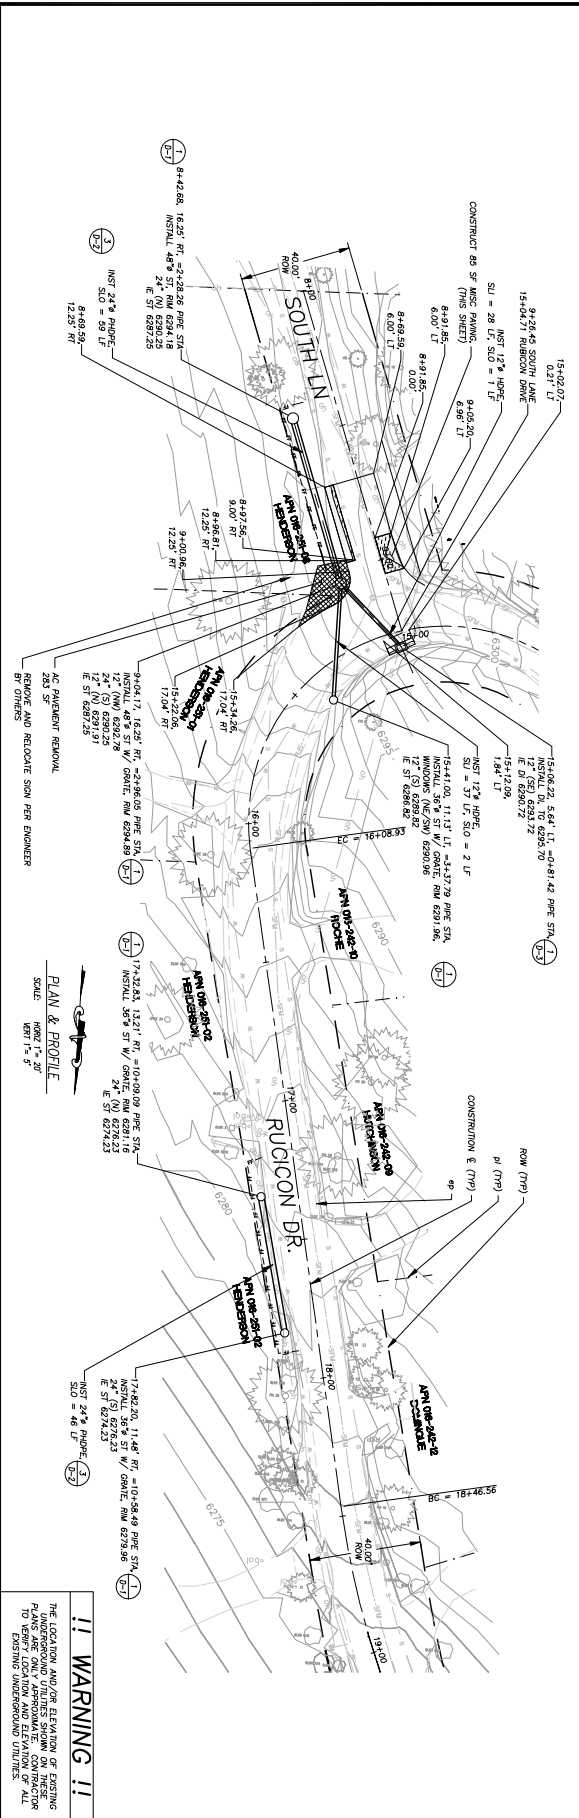

REVISION	
NO.	DATE

REGISTERED UNDER THE SUPERVISION OF:
 REGISTERED CIVIL ENGINEER

<p>EL DORADO COUNTY DEPARTMENT OF TRANSPORTATION</p>	<p>RUBICON S EROSION CONTROL PROJECT RUBICON DR/SOUTH LANE PLAN & PROFILE STA 15+00.00 TO STA 19+00.00</p>
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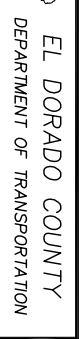
<p>DATE: 04/20/10</p>	<p>PROJECT NO: 09-30490</p>
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REVISION	NO.	DATE	DESCRIPTION





PREPARED UNDER THE SUPERVISION OF:
 REGISTERED CIVIL ENGINEER
 DATE: _____

PROJECT	DATE	ROAD NUMBER
RUBICON DRIVE	04/2010	4444



RUBICON 5 EROSION CONTROL PROJECT
 RUBICON DRIVE PLAN AND PROFILE
 STA 26+25.00 TO STA 30+25.00

DATE	BY	CHK'D BY	APP'D BY
P-4	8	26	09-30490
9/17/10	9/17/10	9/17/10	9/17/10

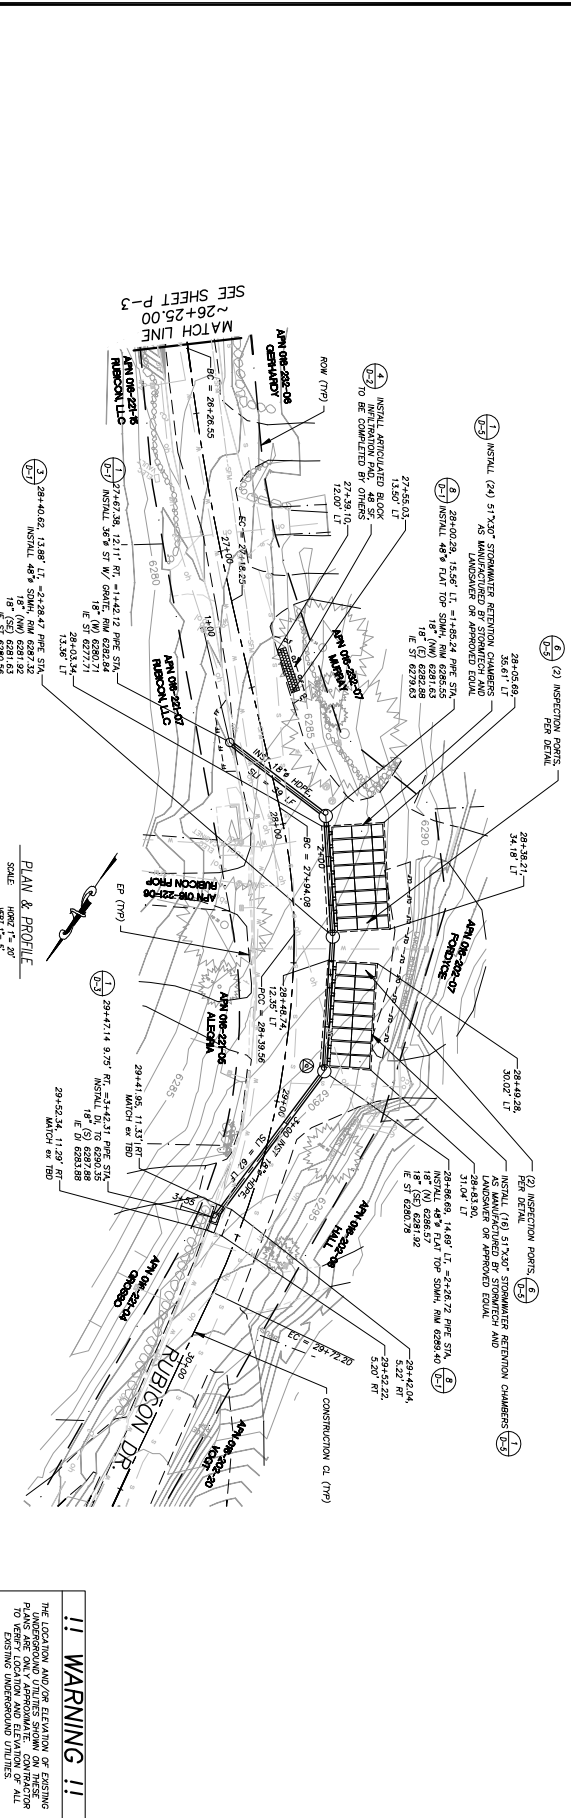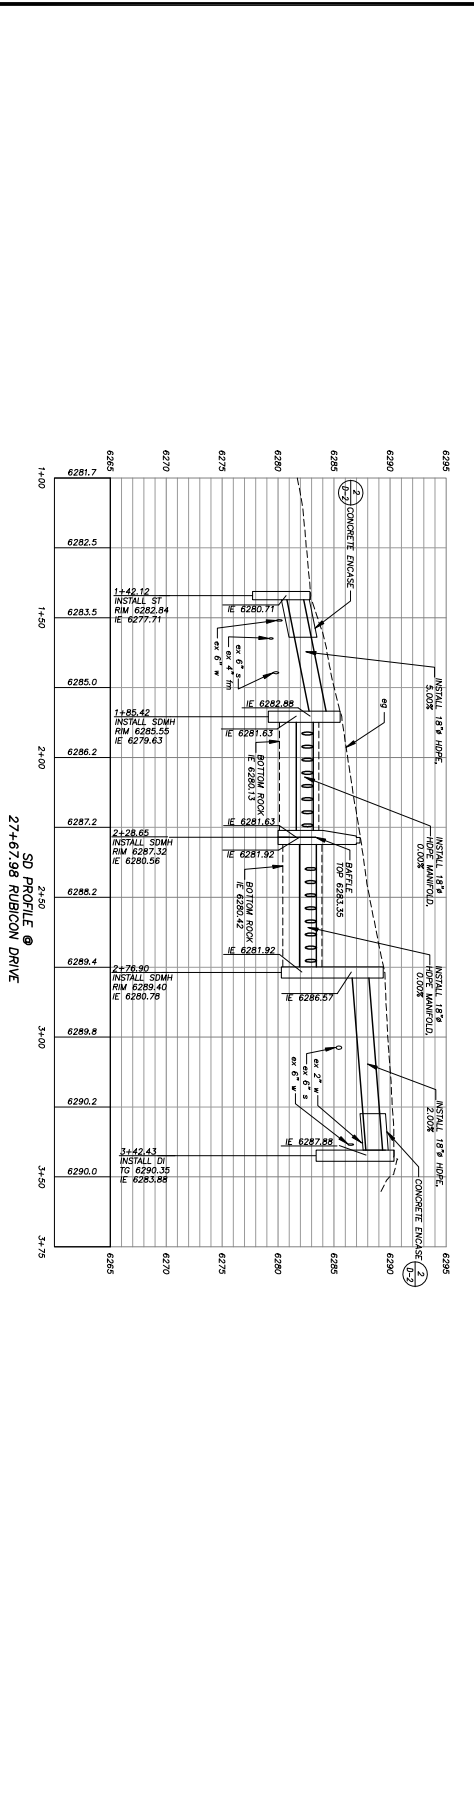

!! WARNING !!
 THE LOCATION AND/OR ELEVATION OF EXISTING UNDERGROUND UTILITIES SHOWN ON THESE PLANS IS BASED ON THE RECORD DRAWINGS TO WHICH THESE PLANS REFER. THE LOCATION AND ELEVATION OF ALL EXISTING UNDERGROUND UTILITIES

NO.	DATE	DESCRIPTION



PREPARED UNDER THE SUPERVISION OF:
 REGISTERED CIVIL ENGINEER
 DATE: _____




PROJECT: _____
 DRAWN: _____
 CHECKED: _____
 DATE: 04/20/10
 ROAD NUMBER: _____
 SHEET: _____



EL DORADO COUNTY
 DEPARTMENT OF TRANSPORTATION


RUBICON 5 EROSION CONTROL PROJECT
 FOREST DRIVE PLAN AND PROFILE
 STA 16+75.00 TO STA 17+64.89

SHEET: P-5 OF 26
 CONTRACT NO. 09-30490
 DATE: 04/20/10
 SHEET NO. 59178

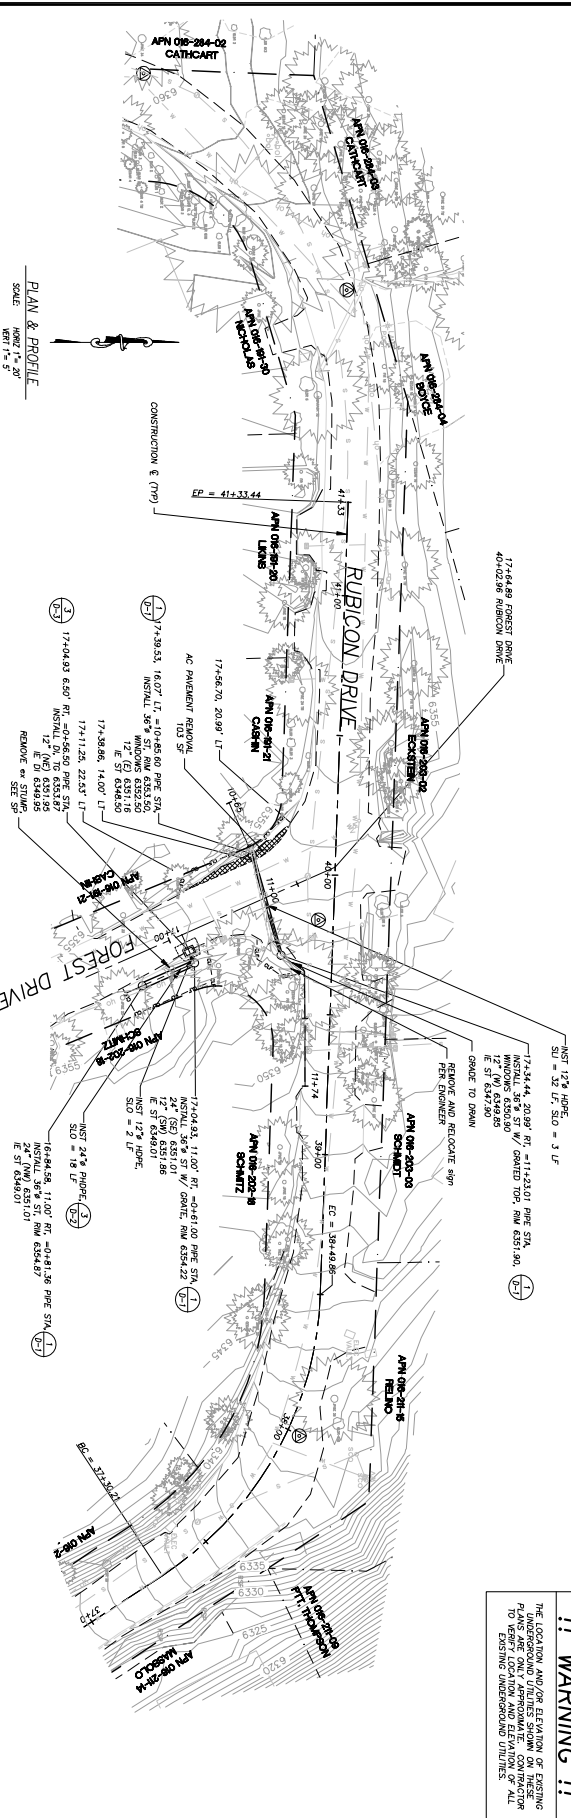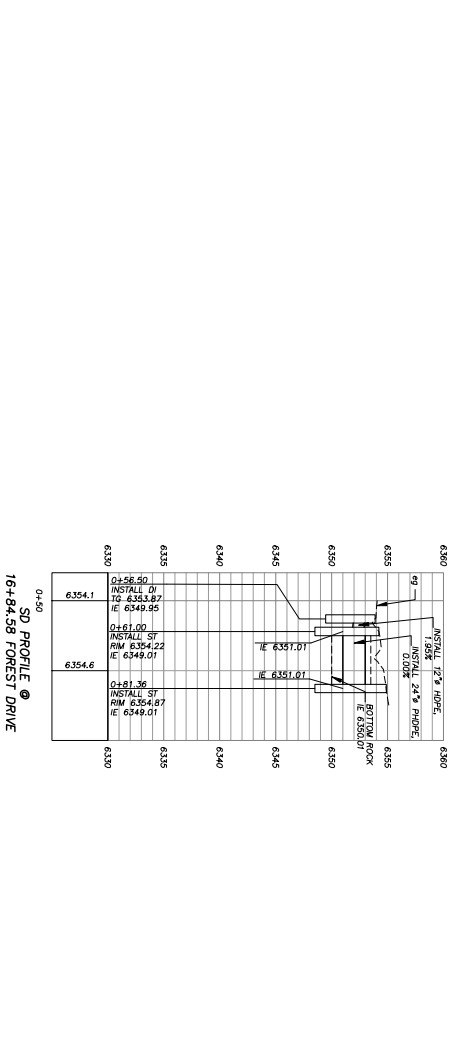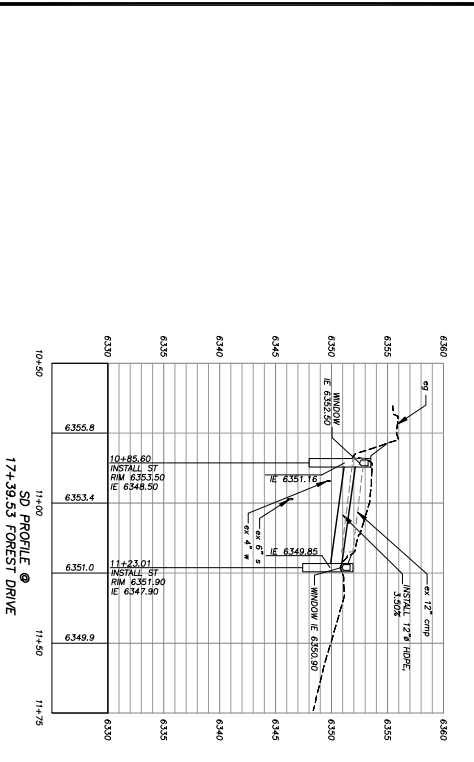


!! WARNING !!

THE LOCATION AND/OR ELEVATION OF EXISTING UNDERGROUND UTILITIES SHOWN ON THESE PLANS IS BASED ON RECORD DRAWINGS AND FIELD SURVEY. THE LOCATION AND ELEVATION OF ALL EXISTING UNDERGROUND UTILITIES

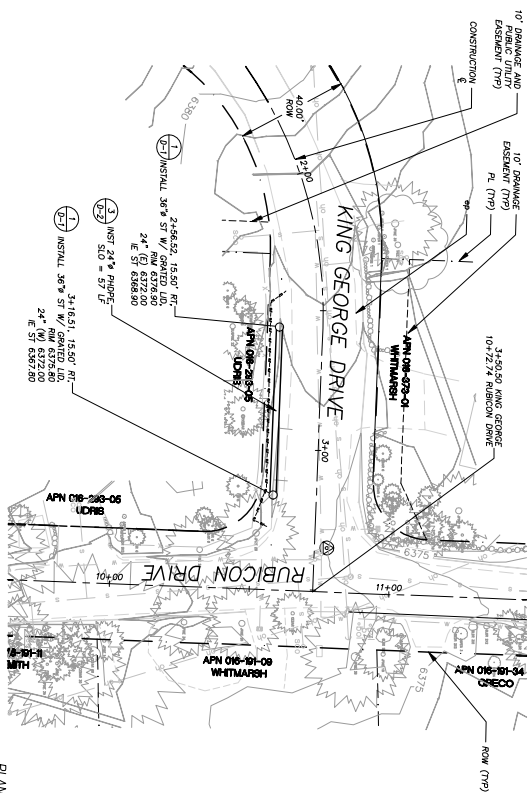

PLAN & PROFILE
SCALE: HORIZ 1" = 20'
VERT 1" = 5'

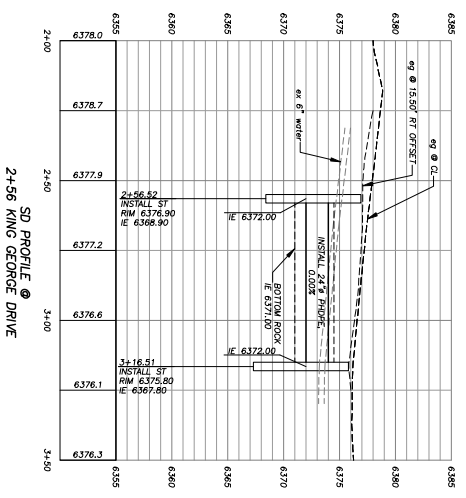

REVISION	NO.	DATE	DESCRIPTION

REGISTERED PROFESSIONAL ENGINEER
STATE OF CALIFORNIA
No. 57494
CIVIL ENGINEERING

PREPARED UNDER THE SUPERVISION OF
REGISTERED CIVIL ENGINEER


DATE: _____

EL DORADO COUNTY
DEPARTMENT OF TRANSPORTATION


RUBICON S EROSION CONTROL PROJECT
KING GEORGE DRIVE PLAN & PROFILE
STA 1+75.00 TO STA 3+50.50

DATE: P-7
11 of 26
CONTRACT NO. 09-30480
SHEET NO. 59178


!! WARNING !!
THE LOCATION AND/OR ELEVATION OF EXISTING UNDERGROUND UTILITIES SHOWN ON THESE PLANS IS BASED ON RECORD DRAWINGS AND FIELD SURVEY. THE LOCATION AND ELEVATION OF ALL EXISTING UNDERGROUND UTILITIES

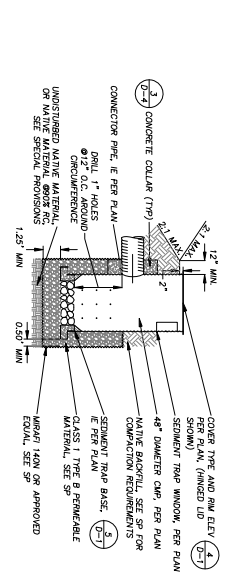


SEDMENT TRAP
NIS

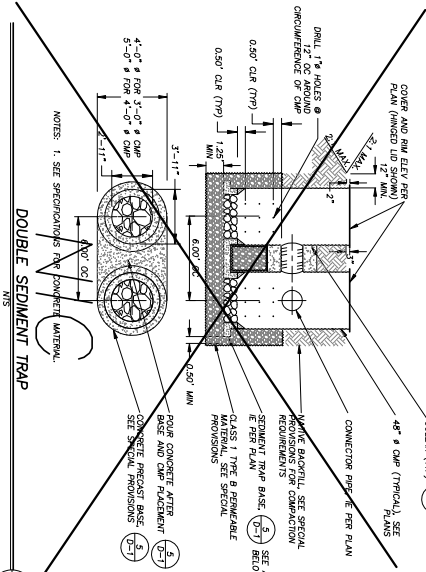


DOUBLE SEDIMENT TRAP
NIS

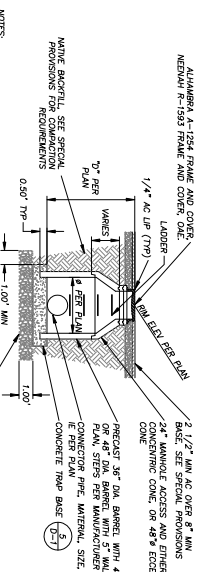

STORM DRAIN MANHOLE
NIS

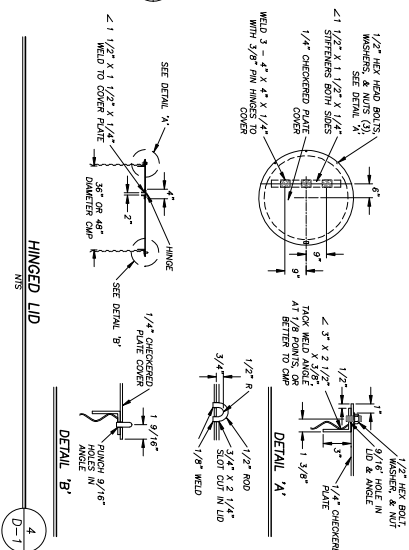

HINGED LID
NIS

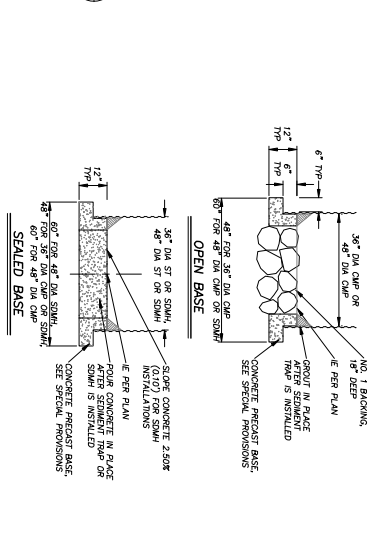


OPEN BASE
NIS

SCALED BASE
NIS




ST & STORM DRAIN MANHOLE BASES
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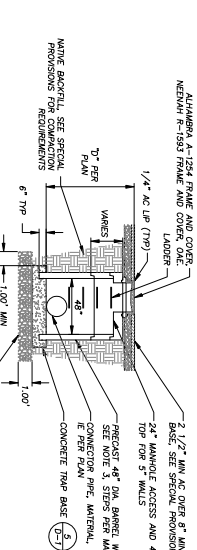


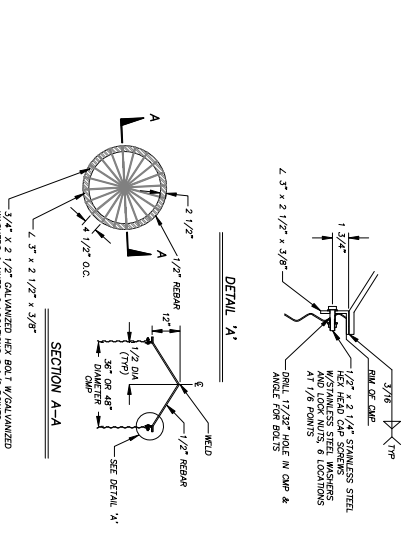SECTION A-A
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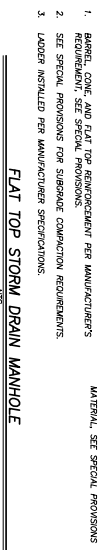
DETAIL A-A
NIS



ATRIDIUM LID
NIS

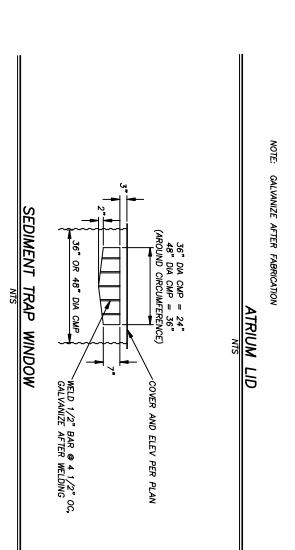

SEDIMENT TRAP WINDOW
NIS








FLAT TOP STORM DRAIN MANHOLE
NIS

REVISION	NO.	DATE	DESCRIPTION

	PREPARED UNDER THE SUPERVISION OF: REGISTERED CIVIL ENGINEER
PROJECT: 10178 DRAWING NO. S-21V1L DATE: 04/2010 ROAD NUMBER: 4444	DRAWN: JTC CHECKED: DMK DATE: 04/2010 ROAD NUMBER: 4444

EL DORADO COUNTY DEPARTMENT OF TRANSPORTATION	RUBICON 5 EROSION CONTROL PROJECT DETAILS
--	--

SHEET: D-1 TOTAL SHEETS: 14 OF 26 DRAWING NO. 09-30480 DATE: 05/17/08
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CONCRETE NOTES THIS SHEET
 1. CONCRETE FOR DETAIL 1/1-2 SHOWN ON THIS SHEET SHALL BE FINISHED BY BRUSHING WITH A SOFT BRUSH AND SPRAYED WITH A CONCRETE PROTECTANT. PROTECTANT COMPATIBLE WITH SECTION 607 OF THE AMENDMENTS TO JULY 2002 SPECIFICATIONS FOR CONCRETE.
 2. SEE SPECIAL PROVISIONS FOR SUBGRADE PREPARATION REQUIREMENTS.

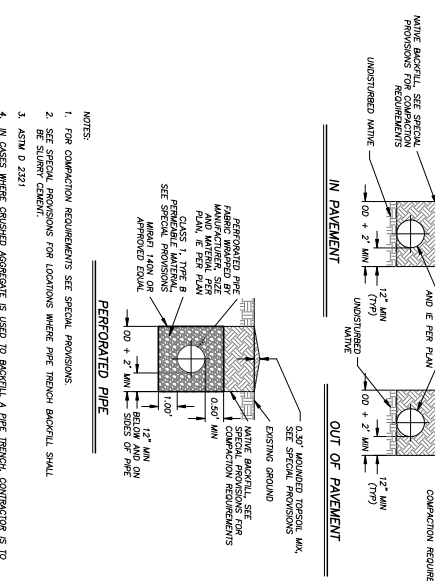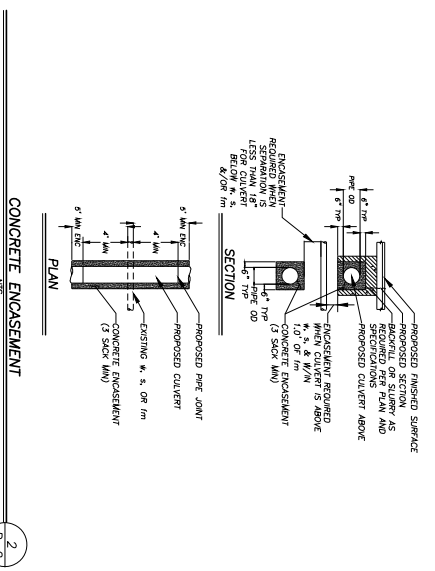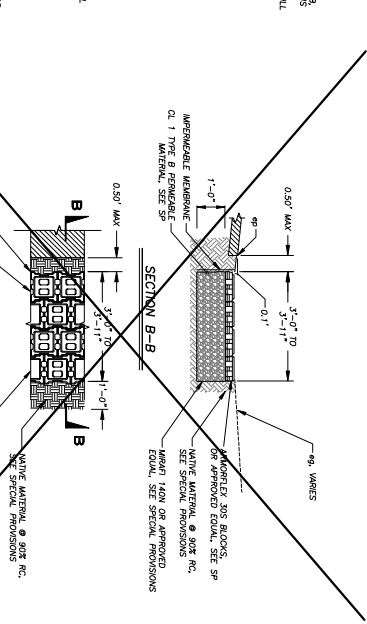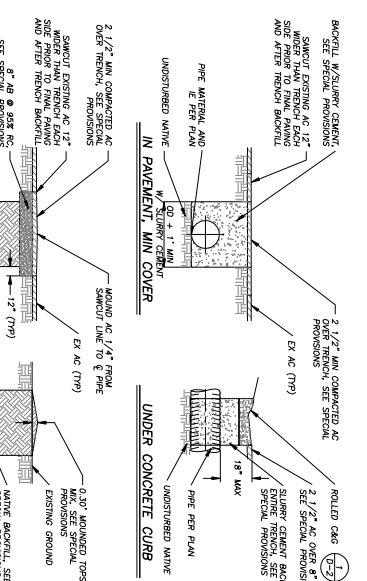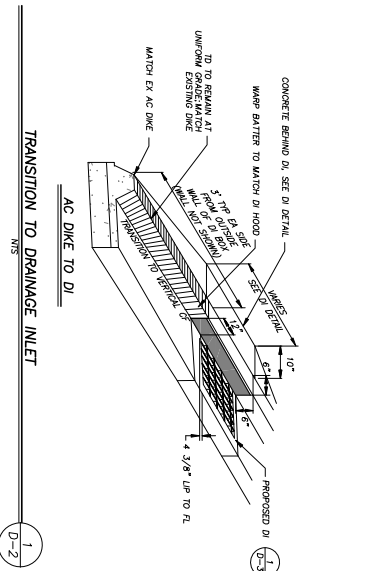NOTES:
 1. FOR COMPACTION REQUIREMENTS SEE SPECIAL PROVISIONS.
 2. SEE SPECIAL PROVISIONS FOR LOCATIONS WHERE PIPE TRENCH BACKFILL SHALL BE PERFORATED.
 3. ASH D 1221
 4. IN CASES WHERE CHANGED APPROXIMATE USED TO BACKFILL A PIPE TRENCH CONTRACTORS TO VERIFY THAT ALL PERFORATED SPECIAL PROVISIONS THE SAME SHOWN WITHIN THIS FILE.
 BEFORE PLACING WHITE FILL.


REVISION	NO.	DATE	DESCRIPTION

DESIGNED BY: JTC	DATE: 04/2010
CHECKED BY: DMK	DATE: 04/2010
DESIGNED UNDER THE SUPERVISION OF: [Signature]	REGISTERED CIVIL ENGINEER
DATE: [Date]	

EL DORADO COUNTY
 DEPARTMENT OF TRANSPORTATION


RUBICON 5 EROSION CONTROL PROJECT
 DETAILS

DATE: D-2
 DRAWING NO. 15 OF 26
 PROJECT NO. 09-30490
 SHEET NO. 51/78

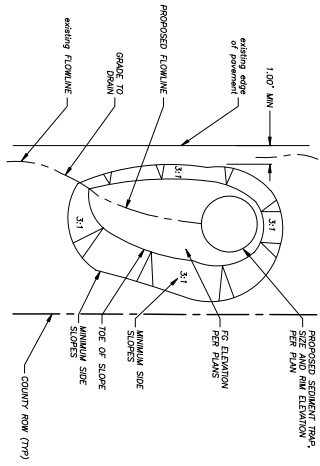


MISC GRADING - MICRO BASIN

1
D-4

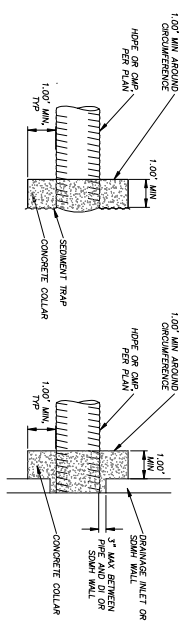

NOTE: SEE SPECIAL PROVISIONS FOR CONCRETE SPECIFICATIONS

3
D-4

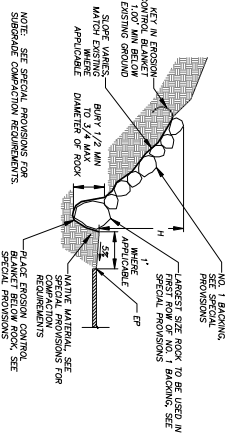

PLAN SHEET	STREET & STATION	SF	AVERAGE REVISION, H	MAXIMUM REVISION, H	SLOPE RATIO
2-1	RUBICON DRIVE 8+19.07 TO 8+41.07	75	3.0'	3.0'	1.25:1

ROCK SLOPE PROTECTION

2
D-4

REVISION	NO.	DATE	DESCRIPTION



PREPARED UNDER THE SUPERVISION OF:
REGISTERED CIVIL ENGINEER

DATE	DESIGNED BY	CHECKED BY	DATE	DATE	ROAD NUMBER



EL DORADO COUNTY
DEPARTMENT OF TRANSPORTATION

RUBICON 5 EROSION CONTROL PROJECT
DETAILS

SHEET
D-4
17 of 26
CONTRACT NO. 09-30490
DATE 09/20/10
BY 59172

