
## CUP23-0010/EDH VERIZON WIRELESS TELECOMMUNICATIONS FACILITY EXHIBIT A - LOCATION/VICINITY MAP

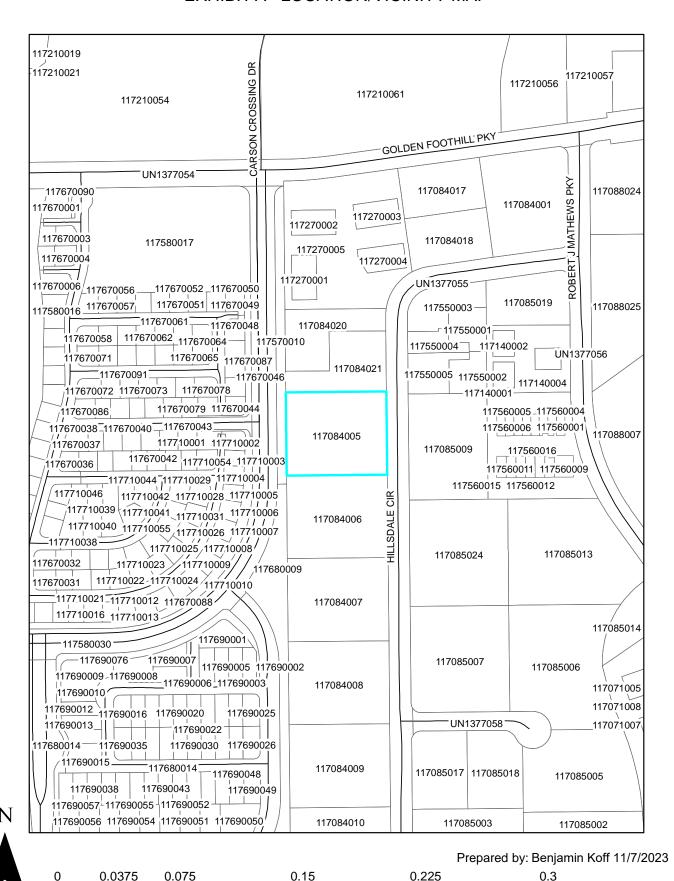

Miles

## CUP23-0010/EDH VERIZON WIRELESS TELECOMMUNICATIONS FACILITY EXHIBIT B - AERIAL MAP



0.11

0.165


0.0275

0.055

0.22 ■ Miles


#### 2023 MAR 31 PM 2: 12

## RECEIVED PLANNING DEPARTMENT

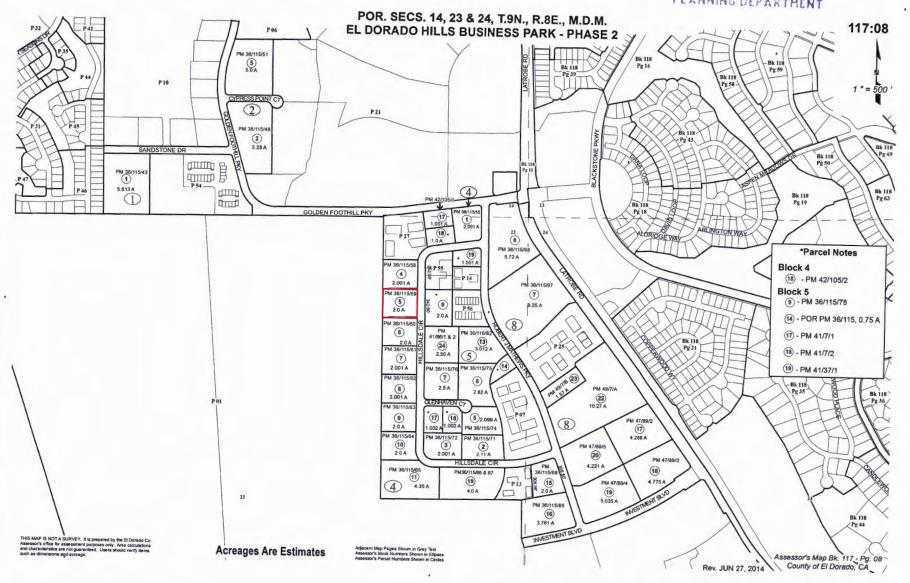


CUP23-0010

# CUP23-0010/EDH VERIZON WIRELESS TELECOMMUNICATIONS FACILITY EXHIBIT D - GENERAL PLAN LAND USE MAP

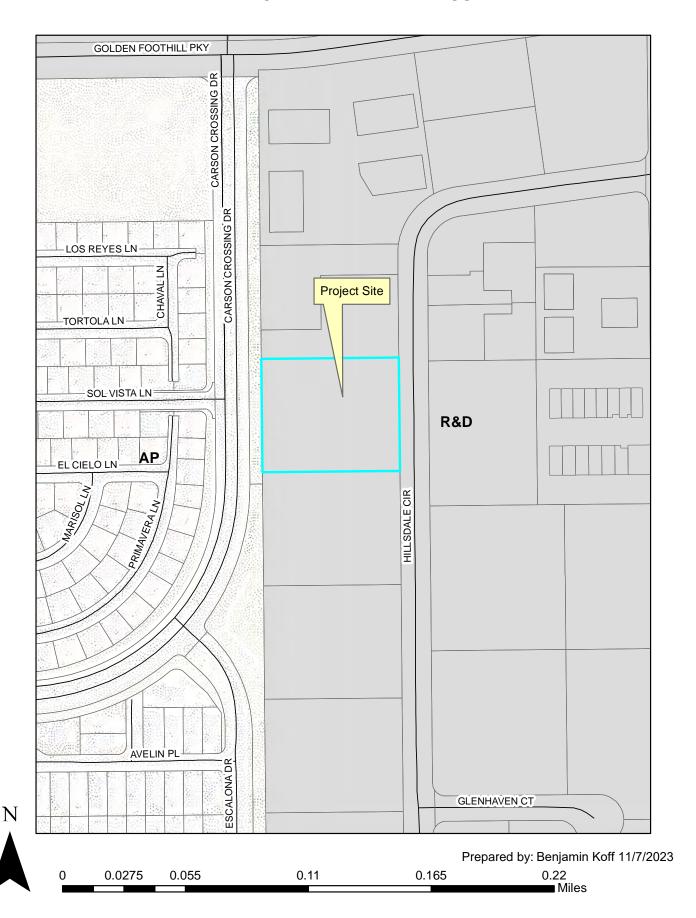

# CUP23-0010/EDH VERIZON WIRELESS TELECOMMUNICATIONS FACILITY EXHIBIT E - ZONING MAP

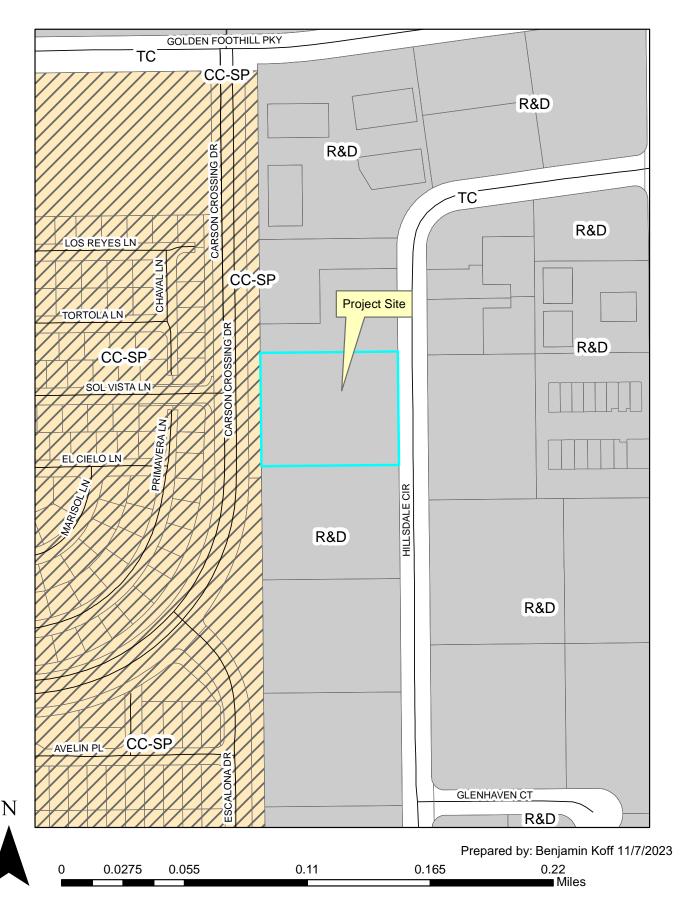

# Verizon<sup>V</sup>

# GOLDEN FOOTHILLS

4994 HILLSDALE CIRCLE, EL DORADO HILLS, CA 94585 LOCATION NUMBER: 295540

# PROJECT DESCRIPTION

EPIC WIRELESS GROUP INC - CONSTRUCTION

EPIC WIRELESS GROUP INC - LEASING

EPIC WIRELESS GROUP INC - ZONING

DATE

DATE

DATE

DATE

PROPERTY OWNER:

SIGNATURE

SIGNATURE

SIGNATURE

SIGNATURE

A (P) VERIZON WIRELESS UNMANNED TELECOMMUNICATION FACILITY CONSISTING OF INSTALLING:

- (P) VERIZON WIRELESS 32'-8"x40'-0" (1,305 SQ FT) LEASE AREA
- (P) MONOPINE

CONSTRUCTION TYPE:

OCCUPANCY TYPE:

GROUND ELEVATION:

PROPERTY OWNER:

POWER:

LATITUDE:

LONGITUDE:

APPLICANT:

SIGNATURE

SIGNATURE

SIGNATURE

SIGNATURE

- (9) (P) & (3) (F) ANTENNAS
- (6) (P) & (3) (F) RADIOS @ ANTENNAS

VERIZON WIRELESS EQUIPMENT ENGINEER:

VERIZON WIRELESS CONSTRUCTION:

VERIZON WIRELESS REAL ESTATE:

VERIZON WIRELESS RF ENGINEER:

DATE

DATE

DATE

• (4) (P) RAYCAP 6627 SURGE SUPPRESSORS, (2) @ EQUIPMENT & (2) @ ANTENNAS

U, (UNMANNED COMMUNICATIONS FACILITY)

N 38° 37′ 28.61″ NAD 83

W 121° 03' 47.05" NAD 83

GOLD RUSH HILL A CA LLC

EL DORADO HILLS, CA 95762

2785 MITCHELL DRIVE, BLDG 9 WALNUT CREEK, CA 94598

VERIZON WIRELESS

1261 HAWKS FLIGHT COURT, SUITE H

PG&E

533' AMSL


- (2) (P) 12X24 HYBRID CABLES
- (P) UTILITIES TO (P) SITE LOCATION

# PROJECT INFORMATION

SITE NAME: SITE ACQUISITION COMPANY: EPIC WIRELESS GROUP GOLDEN FOOTHILLS 605 COOLIDGE DRIVE, SUITE 100 SITE #: 295540 FOLSOM, CA 95630 EL DORADO LEASING CONTACT: ATTN: MELISSA VIOS COUNTY: (916) 755-2480 JURISDICTION: EL DORADO COUNTY MELISSA.VIOS@EPICWIRELESS.NET APN: 117-084-005-000 ZONING CONTACT: ATTN: MELISSA VIOS (916) 755-2480 SITE ADDRESS: 4994 HILLSDALE CIRCLE MELISSA. VIOS@EPICWIRELESS.NET EL DORADO HILLS, CA 94585 CONSTRUCTION CONTACT: ATTN: JOE ZAGAR **CURRENT ZONING:** VACANT/INDUSTRIAL

(916) 747-5758 JOE.ZAGAR@EPICWIRELESS.NET

# **VICINITY MAP**

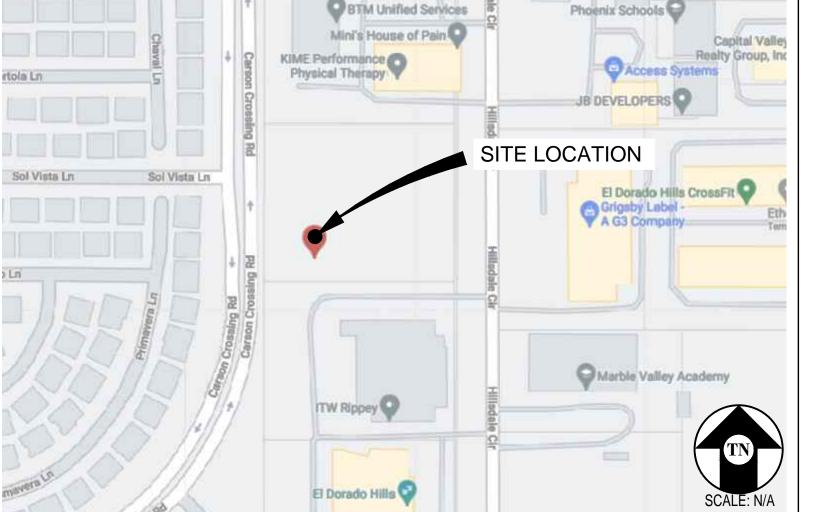

# DRIVING DIRECTIONS

FROM: 2785 MITCHELL DRIVE, BLDG 9, WALNUT CREEK, CA 94598 4994 HILLSDALE CIRCLE, EL DORADO HILLS, CA 94585

| 1.  | START OUT GOING NORTHEAST ON MITCHELL DR TOWARD OAK GROVE RD. | 0.12 MILES |
|-----|---|------------|
| 2.  | TURN LEFT ONTO OAK GROVE RD.                                  | 0.54 MILES |
| 3.  | TURN LEFT ONTO TREAT BLVD.                                    | 2.16 MILES |
| 4.  | TURN RIGHT ONTO BUSKIRK AVE.                                  | 0.21 MILES |
| 5.  | MERGE ONTO I-680 N (PORTIONS TOLL).                           | 7.98 MILES |
| 6.  | MERGE ONTO I-680 N (PORTIONS TOLL).                           | 14.20 MILE |
| 7.  | MERGE ONTO I-80 E VIA EXIT 71A TOWARD SACRAMENTO.             | 41.44 MILE |
| 8.  | MERGE ONTO US-50 E VIA EXIT 82 ON THE LEFT TOWARD SOUTH LAKE  |            |
|     | TAHOE/SACRAMENTO.   | 29.44 MILI |
| 9.  | MERGE ONTO LATROBE RD VIA EXIT 30A.                           | 2.17 MILES |
| 10. | TURN RIGHT ONTO GOLDEN FOOTHILL PKWY.                         | 0.07 MILES |
| 11. | TURN LEFT ONTO ROBERT J MATHEWS PKWY.                         | 0.08 MILES |
| 12. | TURN RIGHT ONTO HILLSDALE CIR.                                | 0.19 MILES |
|     |   |            |
|     |   |            |
| END | ) AT: 4994 HILLSDALE CIRCLE, EL DORADO HILLS, CA 94585        |            |
|     |   |            |
| EST | TMATED TIME: 1 HOUR 40 MINUTES ESTIMATED DISTANCE: 98.6 MILES |            |

# CODE COMPLIANCE

ALL WORK & MATERIALS SHALL BE PERFORMED & INSTALLED IN ACCORDANCE WITH THE CURRENT EDITIONS OF THE FOLLOWING CODES AS ADOPTED BY THE LOCAL GOVERNING AUTHORITIES. NOTHING IN THESE PLANS IS TO BE CONSTRUED TO PERMIT WORK NOT CONFORMING TO THESE CODES:

- 2019 CALIFORNIA ADMINISTRATIVE CODE, PART 1, TITLE 24 C.C.R.
- 2019 CALIFORNIA BUILDING CODE (CBC), PART 2, VOLUME 1&2, TITLE 24 C.C.R. (2018 INTERNATIONAL BUILDING CODE AND 2019 CALIFORNIA AMENDMENTS)
- 2019 CALIFORNIA ELECTRICAL CODE (CEC), PART 3, TITLE 24 C.C.R. (2017 NATIONAL ELECTRICAL CODE AND 2019 CALIFORNIA AMENDMENTS)
- 2019 CALIFORNIA MECHANICAL CODE (CMC) PART 4, TITLE 24 C.C.R.
- (2018 UNIFORM MECHANICAL CODE AND 2019 CALIFORNIA AMENDMENTS)
- 2019 CALIFORNIA PLUMBING CODE (CPC), PART 5, TITLE 24 C.C.R.
- (2018 UNIFORM PLUMBING CODE AND 2019 CALIFORNIA AMENDMENTS)
- 2019 CALIFORNIA ENERGY CODE (CEC), PART 6, TITLE 24 C.C.R. 2019 CALIFORNIA FIRE CODE, PART 9, TITLE 24 C.C.R.
- (2018 INTERNATIONAL FIRE CODE AND 2019 CALIFORNIA AMENDMENTS)
- 2019 CALIFORNIA GREEN BUILDING STANDARDS CODE, PART 11, TITLE 24 C.C.R. 2019 CALIFORNIA REFERENCED STANDARDS, PART 12. TITLE 24 C.C.R. ANSI/EIA-TIA-222-H
- ALONG WITH ANY OTHER APPLICABLE LOCAL & STATE LAWS AND REGULATIONS

## DISABLED ACCESS REQUIREMENTS

THIS FACILITY IS UNMANNED & NOT FOR HUMAN HABITATION. DISABLED ACCESS & REQUIREMENTS ARE NOT REQUIRED IN ACCORDANCE WITH CALIFORNIA STATE BUILDING CODE, TITLE 24 PART 2, SECTION 11B-203.5

# SHEET INDEX

| SHEET       | DESCRIPTION                            | REV |
|-------------|--|-----|
|             |  |     |
| T 4 4       |  |     |
| T-1.1       | TITLE SHEET                            | _   |
| C-1         | TOPOGRAPHIC SURVEY                     | _   |
| A - 1.1     | SITE PLAN                              | _   |
| A-1.2       | EQUIPMENT PLAN                         | _   |
| A-2.1       |  |     |
| · · · — · · |  |     |
| A - 3.1     |  | _   |
| A-4.1       | DETAILS                                | _   |
| E-1.1       | ELECTRICAL PLAN                        | _   |
|             |  |     |
| LANDSO      | CAPING PLAN BY OTHERS (DATED 12/15/22) |     |
| 1-1.0       | IRRIGATION PLAN                        |     |
|             |  | _   |
| L-1.1       | IRRIGATION NOTES & DETAILS             | _   |
| L-2.0       | PLANTING PLAN                          | _   |
| L-2.1       | PLANTING NOTES & DETAIL                | _   |
|             |  |     |
|             |  |     |

# GOLDEN FOOTHILLS

295540 4994 HILLSDALE CIRCLE EL DORADO HILLS. CA 94585



Streamline

PRELIMINARY: NOT FOR CONSTRUCTION

KEVIN R. SORENSEN

|                     | IJJUE    | SIAIU       | STATUS |  |  |
|---------------------|----------|-------------|--------|--|--|
| $\triangle$         | DATE     | DESCRIPTION | REV    |  |  |
|                     | 04/08/22 | ZD 90%      | _      |  |  |
|                     | 05/17/22 | CLIENT REV  | C.C    |  |  |
|                     | 08/18/22 | ZD 100%     | C.C    |  |  |
|                     | 08/31/22 | CLIENT REV  | C.C    |  |  |
|                     | 12/20/22 | CLIENT REV  | C.C    |  |  |
|                     | _        | _           | _      |  |  |
| DRAWN BY: C. CODY   |          |             |        |  |  |
| CHECKED BY: J. GRAY |          |             |        |  |  |
| APPROVED BY: -      |          |             |        |  |  |
| DA                  | TE:      | 12/20/22    |        |  |  |


TITLE SHEET


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T-1.1


# CUP23-0010/EDH VERIZON WIRELESS TELECOMMUNICATIONS FACILITY EXHIBIT F - SITE PLAN

#### LEASE AREA DESCRIPTION THESE DRAWINGS AND/OR THE ACCOMPANYING DATE OF SURVEY: 03-23-22 SPECIFICATION AS INSTRUMENTS OF SERVICE, ARE THE All that certain lease area being a portion of Parcel 59 as is shown on that certain Parcel Map recorded at Book 36 of Parcel Maps at Page 115, El Dorado County Records, State EXCLUSIVE PROPERTY OF GEIL ENGINEERING AND THEIR of California, and being a portion of the Section 23, Township 9 North, Range 8 East, M.D.B.& M, being more particularly described as follows: SURVEYED BY OR UNDER DIRECTION OF: KENNETH D. GEIL, USE AND PUBLICATION SHALL BE RESTRICTED TO THE ORIGINAL SITE AND CARRIER FOR WHICH THEY ARE Commencing at a survey spike and washer set for the Northerly terminus of that certain centerline tangent of Carson Crossing Drive labeled "N00'34'36"W 963.21" as is shown that PREPARED. REUSE, REPRODUCTION OR PUBLICATION BY certain Tract Map filed for record at Book "J" of Maps at Page 135, Official Records, from which a similar monument bears South 25'45'02" West 1632.40 feet; thence from said LOCATED IN THE COUNTY OF EL DORADO, STATE OF ANY METHOD, IN WHOLE OR IN PART, IS PROHIBITED point of commencement South 07°00'45" East 892.14 feet to the True Point of Beginning; thence from said point of beginning South 00°34'36" East 40.00 feet; thence North EXCEPT BY WRITTEN PERMISSION FROM GEIL 89°25'24" East 32.67 feet; thence North 00°34'36" West 40.00 feet; thence South 89°25'24" West 32.67 feet to the point of beginning. ENGINEERING TITLE TO THESE PLANS AND/OR BEARINGS SHOWN ARE BASED UPON MONUMENTS FOUND AND SPECIFICATIONS SHALL REMAIN WITH GEIL ENGINEERING RECORD INFORMATION. THIS IS NOT A BOUNDARY SURVEY. Together with a non-exclusive easement for access and utility purposes fifteen feet in width the centerline of which is described as follows: beginning at a point which bears North WITHOUT PREJUDICE AND VISUAL CONTACT WITH THEM 00°34'36" West 7.50 feet from the Northwest corner of the above described lease area and running thence North 89°25'24" East 40.17 feet to a point hereafter defined as Point SHALL CONSTITUTE PRIMA FACIE EVIDENCE OF ELEVATIONS SHOWN ON THIS PLAN ARE BASED UPON U.S.G.S. GOLDEN FOOTHILL PARKWAY "A"; thence North 00°19'57" West 159.42 feet; thence North 66°05'55" East 31.83 feet; thence North 89°37'57" East 62.31 feet to a point hereafter defined as Point "B": thence ACCEPTANCE OF THESE RESTRICTIONS. N.A.V.D. 88 DATUM. ABOVE MEAN SEA LEVEL. continuing North 89'37'57" East 162.7 feet more or less to the public right of way. ENGINEERING G \* SURVEYING \* PLANNING ES HIGH STREET N, CALIFORNIA 95603 (e: (530) 885-0426 (530) 823-1309 N.G.V.D. 1929 CORRECTION: SUBTRACT 2.56' FROM ELEVATIONS Also together with a non-exclusive easement for access and utility purposes fifteen feet in width the centerline of which is described as follows: beginning at Point "A" as previously BOUNDARY SHOWN IS BASED ON MONUMENTATION SHOWN. PROJECT : defined and running thence South 0019'57" East 31.90 feet; thence North 8916'44" East 255.0 feet more or less to the public right of way. FOUND AND RECORD INFORMATION. THIS IS NOT A BOUNDARY SURVEY. THIS IS A SPECIALIZED CONTOUR INTERVAL: 1' TOPOGRAPHIC MAP WITH PROPERTY LINES AND Also together with a non—exclusive easement for utility purposes ten feet in width the centerline of which is described as follows: beginning at Point "B"as previously defined and EASEMENTS BEING A GRAPHIC DEPICTION BASED ON running thence North 00°50'27" West 24.8 feet more or less to the existing transformer and also from said Point "B" and running thence South 00°50'27" East 18.6 feet more or CONTRACTOR IS RESPONSIBLE TO VERIFY LEASE AREA PRIOR INFORMATION GATHERED FROM VARIOUS SOURCES OF less to the existing utility room and electrical facilities. TO CONSTRUCTION. RECORD AND AVAILABLE MONUMENTATION FOUND DURING THE FIELD SURVEY. PROPERTY LINES AND Also together with a non—exclusive easement for utility purposes ten feet in width the centerline of which is described as follows: beginning at a point which bears North 00°34'36" ASSESSOR'S PARCEL NUMBER: 117-084-005-000 LINES OF TITLE WERE NOT INVESTIGATED NOR West 0.79 feet from the Southeast corner of the above described lease area and running thence North 89°15'35" East 262.4 feet more or less to the public right of way. SURVEYED EXCEPT AS SHOWN ON THIS PLAN. NO OWNER(S): GOLD RUSH HILL A CA LLC PROPERTY MONUMENTS WERE SET. 1261 HAWKS FLIGHT COURT #H Also together with a non—exclusive easement for utility purposes ten feet in width the centerline of which is described as follows: beginning at a point which bears South 89°25'24' EL DORADO HILLS, CA 95762 West 6.90 feet from the Northeast corner of the above described lease area and running thence North 001937" West 163.45 feet to a point hereafter defined as Point "C"; thence South 66°05'55" West 28.9 feet more or less to the existing electrical box. VICINITY MAP EL DORADO, CA Also together with a non-exclusive easement for utility purposes ten feet in width the centerline of which is described as follows: beginning at Point "C" as previously defined and running thence North 66°05'55" East 15.60 feet. Geil Engineering 15' DRAINAGE EASEMENT Engineering \* Surveying \* Planning & P.U.E. PER 36/PM/115 1226 High Street PROPERTY BOUNDARY Auburn, California 95603-5015 Phone: (530) 885-0426 \* Fax: (530) 823-1309 \_\_\_\_\_\_ Verizon Wireless Golden Foothills Project Name: 20' WATER EASEMENT 20' DRAINAGE AND P.U.E. PER 2021-47601 4994 Hillsdale Circle Project Site Location: PROPOSED 10' NON-EXCLUSIVE 20' SEWER EASEMENT PER 36/PM/115 El Dorado Hills, CA 95762 VERIZON WIRELESSUTILITY EASEMENT — PER 36/PM/115 El Dorado County & 2763/OR322 Date of Observation: 03-23-22 15' DRAINAGE EASEMENT Equipment/Procedure Used to Obtain Coordinates: Trimble Pathfinder <sup>−</sup>& P.U.E. PER 36/PM/115 Pro XL post processed with Pathfinder Office software. PROPOSED 10' NON-EXCLUSIVE Type of Antenna Mount: Proposed Monopine VERIZON WIRELESSUTILITY EASEMENT Coordinates (Tower) Latitude: N 38° 37' 28.61" (NAD83) N 38° 37' 28.95" (NAD27) Longitude: W 121° 03' 47.05" (NAD83) W 121° 03' 43.25" (NAD27) ELEVATION of Ground at Structure (NAVD88) 533' AMSL PROPOSED 15' NON-EXCLUSIVE VERIZON WIRELESS ACCESS CERTIFICATION: I, the undersigned, do hereby certify elevation listed 20' WATER EASEMENT & UTILITY EASEMENT above is based on a field survey done under my supervision and that PER 2021-47601 the accuracy of those elevations meet or exceed 1—A Standards as −BURIED CONDUIT PER OWNER± defined in the FAA ASAC Information Sheet 91:003, and that they are true and accurate to the best of my knowledge and belief. PROPOSED 15' NON-EXCLUSIVE Kenneth D. Geil California RCE 14803 --- VERIZON WIRELESS ACCESS & UTILITY EASEMENT CONCRETE CURB LINE-PROPOSED 10' NON-EXCLUSIVE VERIZON WIRELESS UTILITY EASEMENT DRAINAGE INLET APN: 117-058-017-000 APN: 117-084-005-000 BUILDING TOP=559.65' APN: 117-084-004-000 CLEAN DUT-TECH PARKING AREA LAMP POST IRRIGATION/BOX PROPOSED 15' NON-EXCLUSIVE VERIZON WIRELESS ACCESS & UTILITY EASEMENT APN: 117-084-005-000 ∕—PRÖÞOSED MONOPINE LOCATION -PROPOSED VERIZON WIRELESS SEE PROJECT ARE ENLARGEMENT END CONCRETE — DITCH APN: 117 084 006 000 PACBELL VAULT-PROPOSED 10' NON-EXCLUSIVE 16" DECIDUOUS VERIZON WIRELESS UTILITY EASEMENT 20' WATER EASEMENT TOP <del>45</del>80.93' SCALE 1" = 20 15' DRAINAGE EASEMENT PER 2021-47601 \_& P.U.E. PER 36/PM/115 -SEWER MANHOLE SCALE 1" = 100PROJECT AREA ENLARGEMENT OVERALL PROJECT AREA



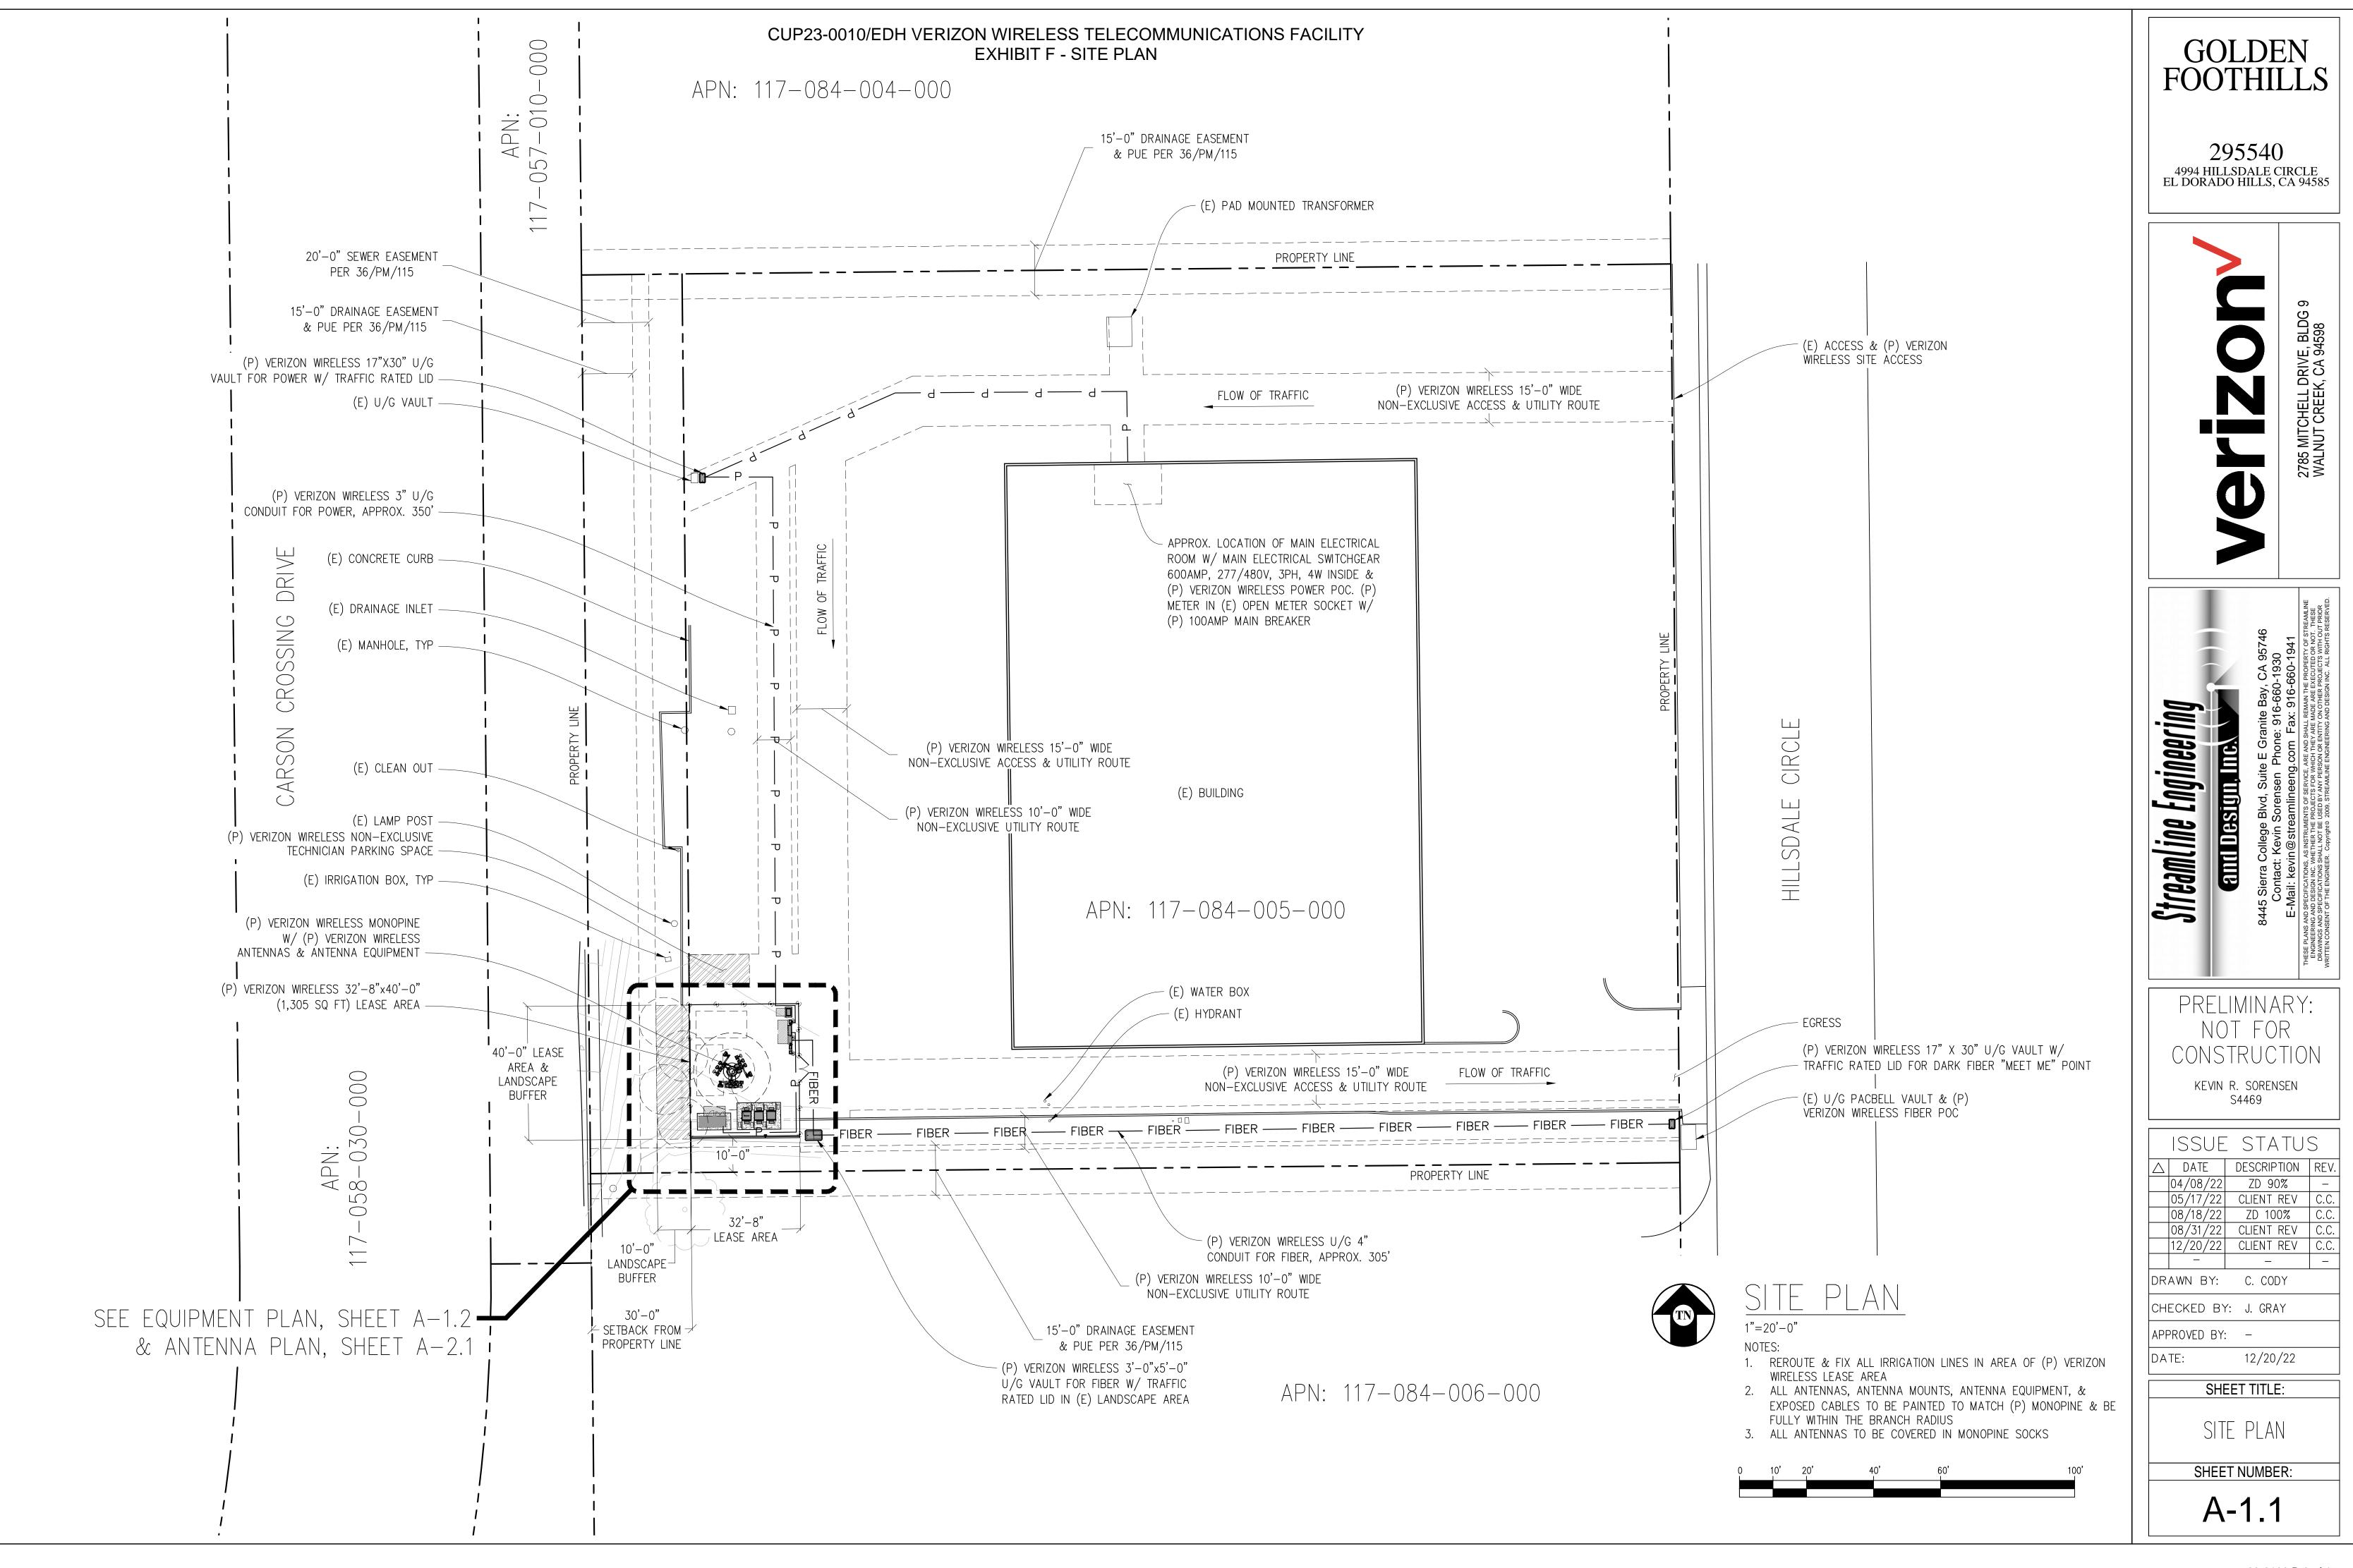
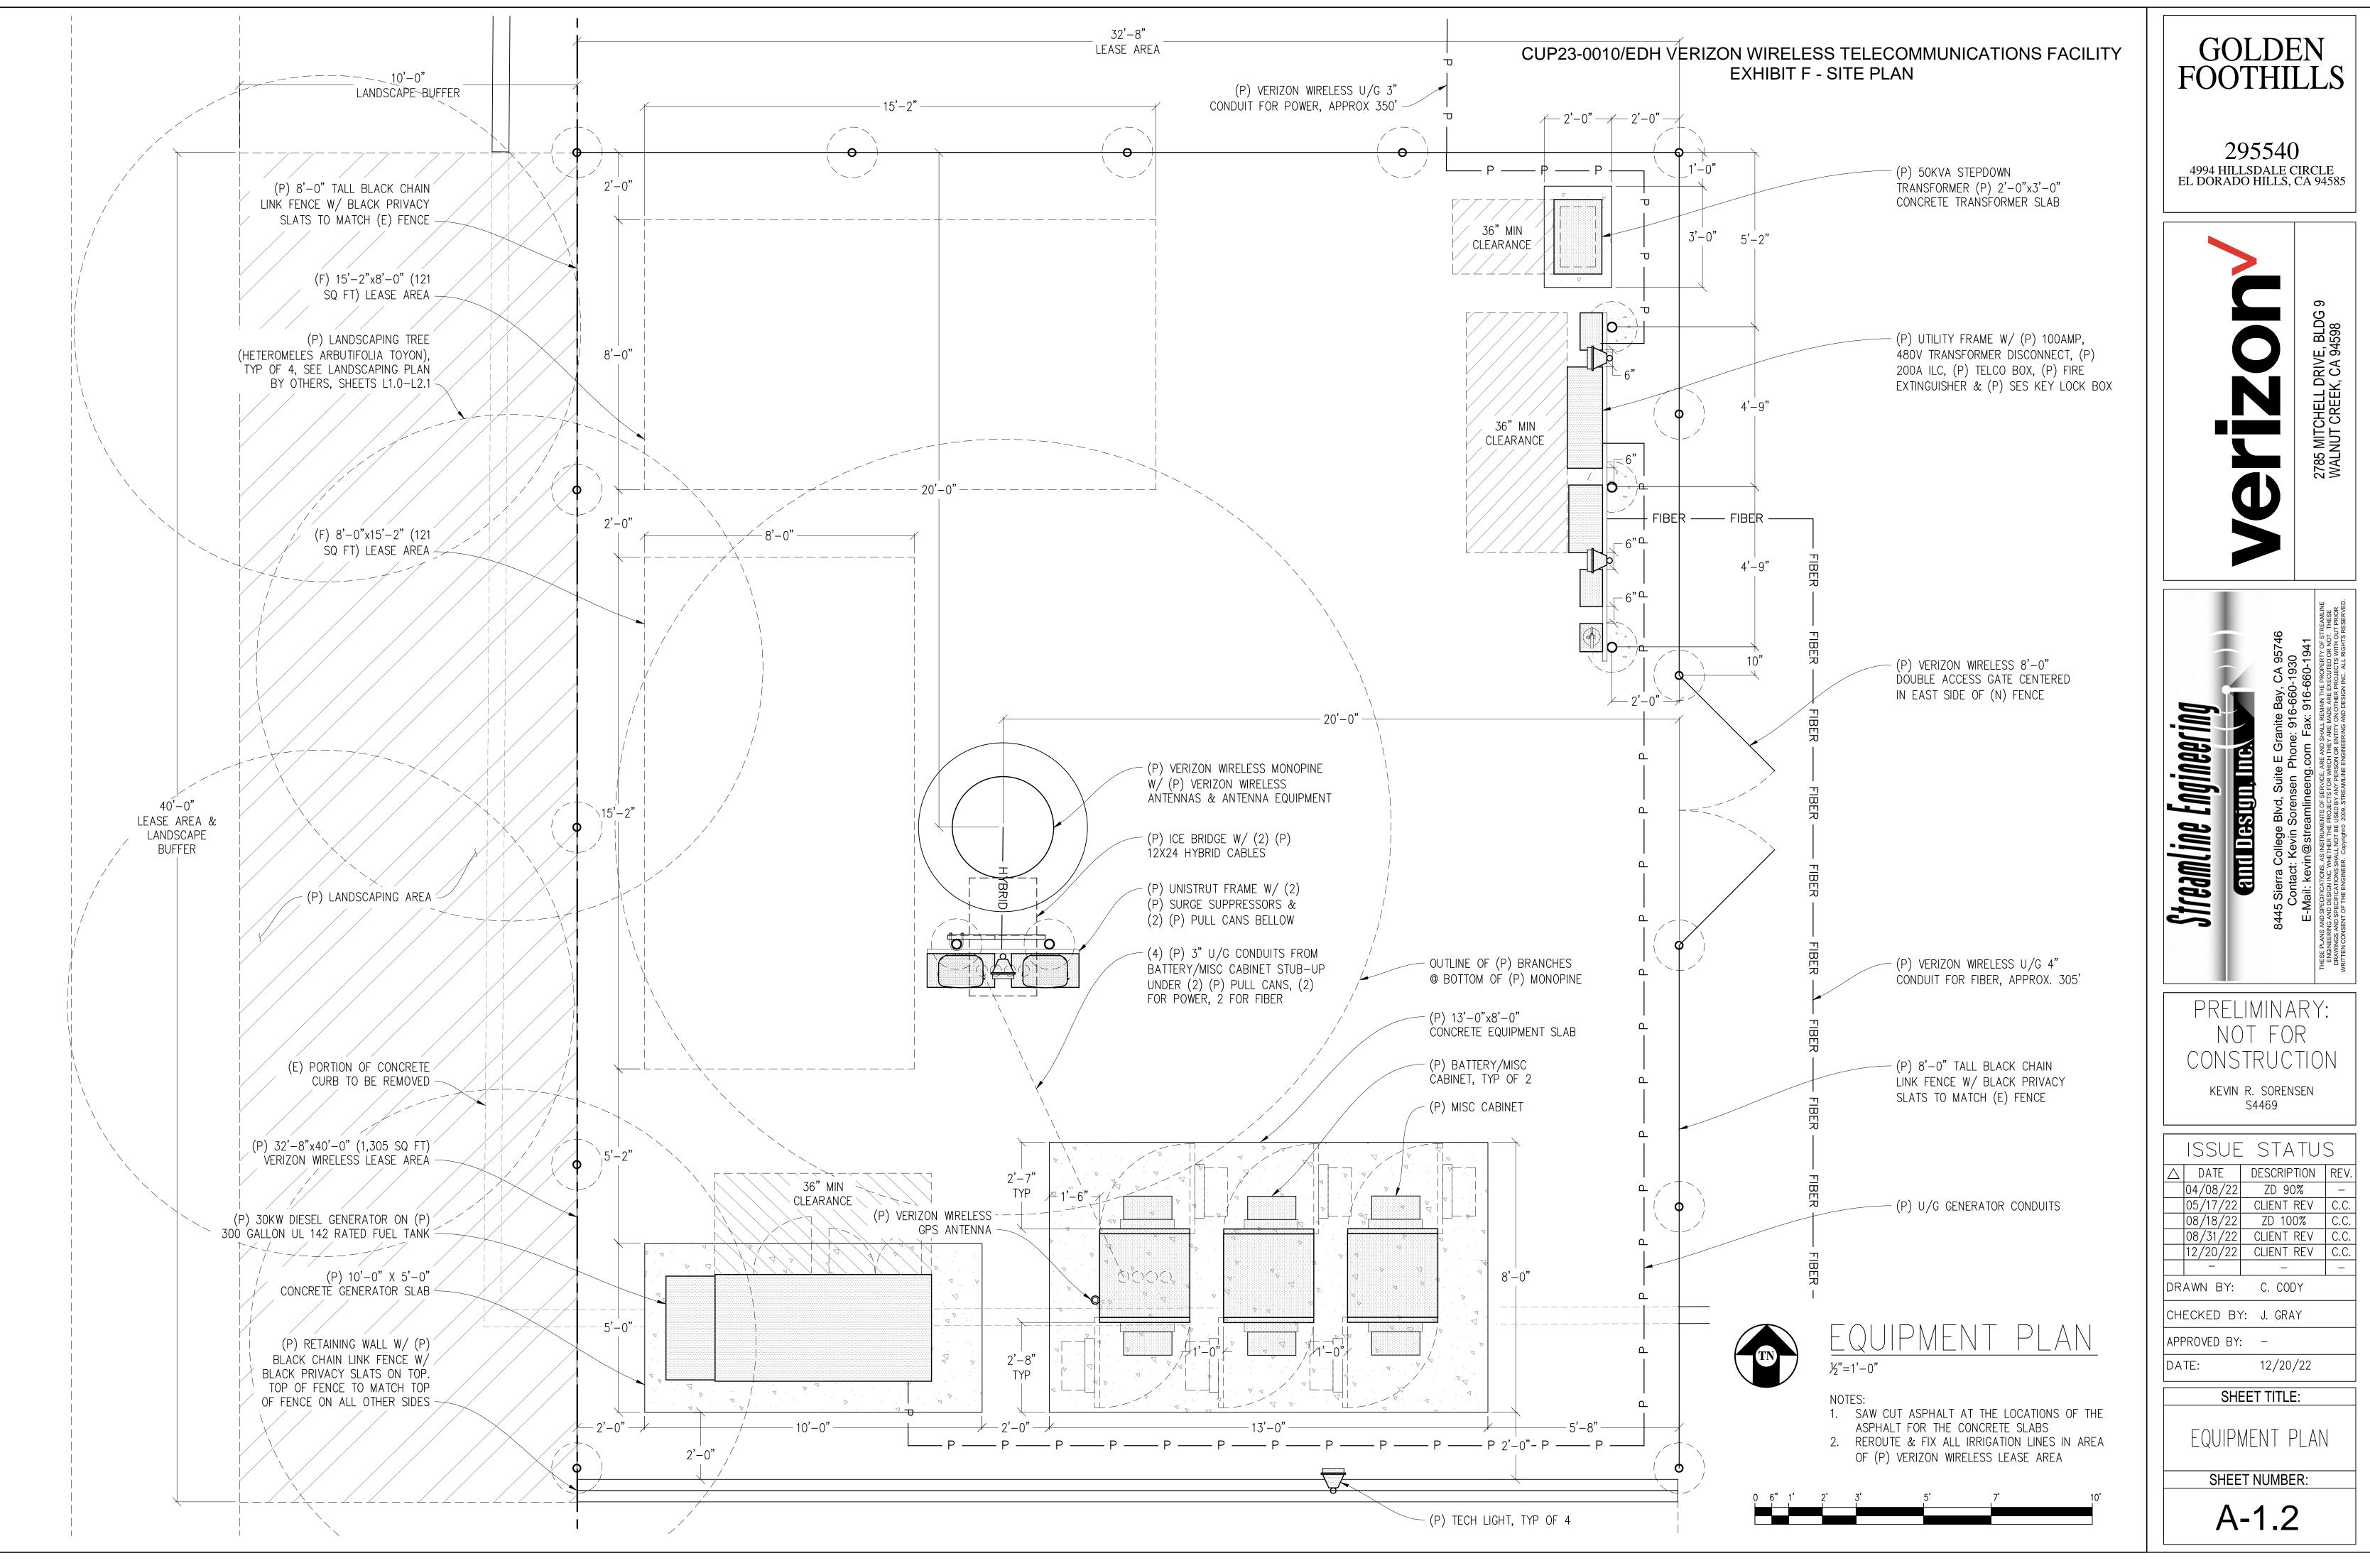
# CUP23-0010/EDH VERIZON WIRELESS TELECOMMUNICATIONS FACILITY EXHIBIT F - SITE PLAN

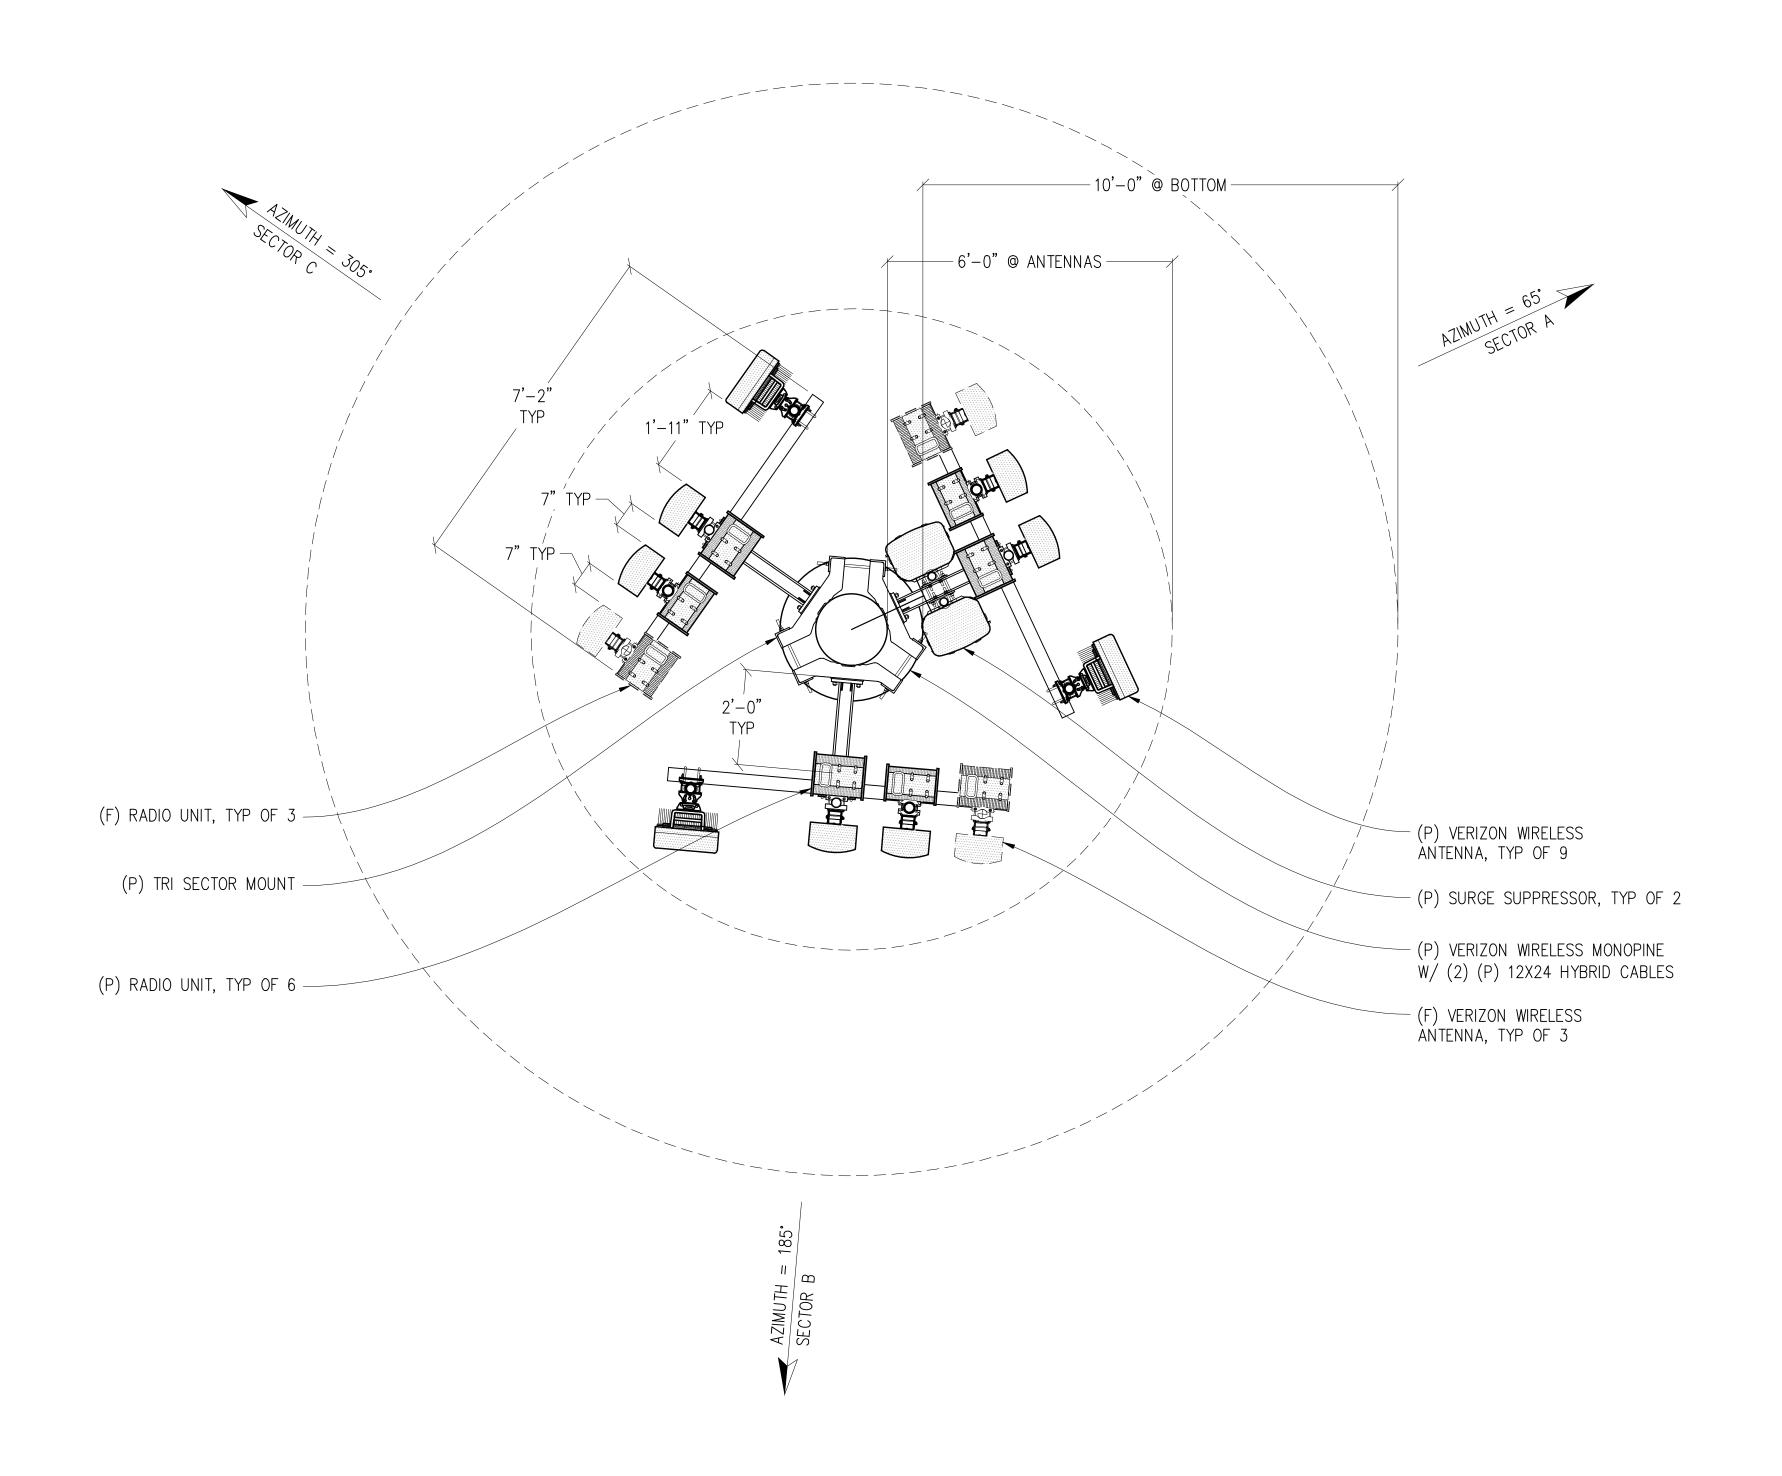




1. ALL ANTENNAS, ANTENNA MOUNTS, ANTENNA EQUIPMENT, & EXPOSED CABLES TO BE PAINTED TO MATCH (P) MONOPINE & BE FULLY WITHIN THE BRANCH RADIUS

2. ALL ANTENNAS TO BE COVERED IN MONOPINE SOCKS

# GOLDEN FOOTHILLS

295540
4994 HILLSDALE CIRCLE
EL DORADO HILLS, CA 94585

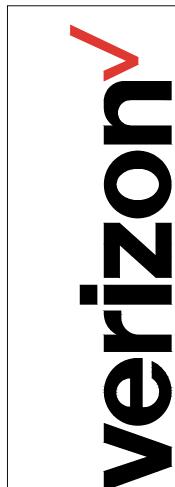



PRELIMINARY:
NOT FOR
CONSTRUCTION

KEVIN R. SORENSEN S4469

|  |   | ISSUE    | STATU:      | S    |
|--|---|----------|-------------|------|
|  | Δ | DATE     | DESCRIPTION | REV  |
|  |   | 04/08/22 | ZD 90%      | _    |
|  |   | 05/17/22 | CLIENT REV  | C.C. |
|  |   | 08/18/22 | ZD 100%     | C.C. |
|  |   | 08/31/22 | CLIENT REV  | C.C. |
|  |   | 12/20/22 | CLIENT REV  | C.C. |
|  |   | _        | _           | _    |
|  | ı |          |             |      |

DRAWN BY: C. CODY

CHECKED BY: J. GRAY

APPROVED BY: -


DATE: 12/20/22

ANTENNA PLAN

SHEET TITLE:

SHEET NUMBER:

A-2.1

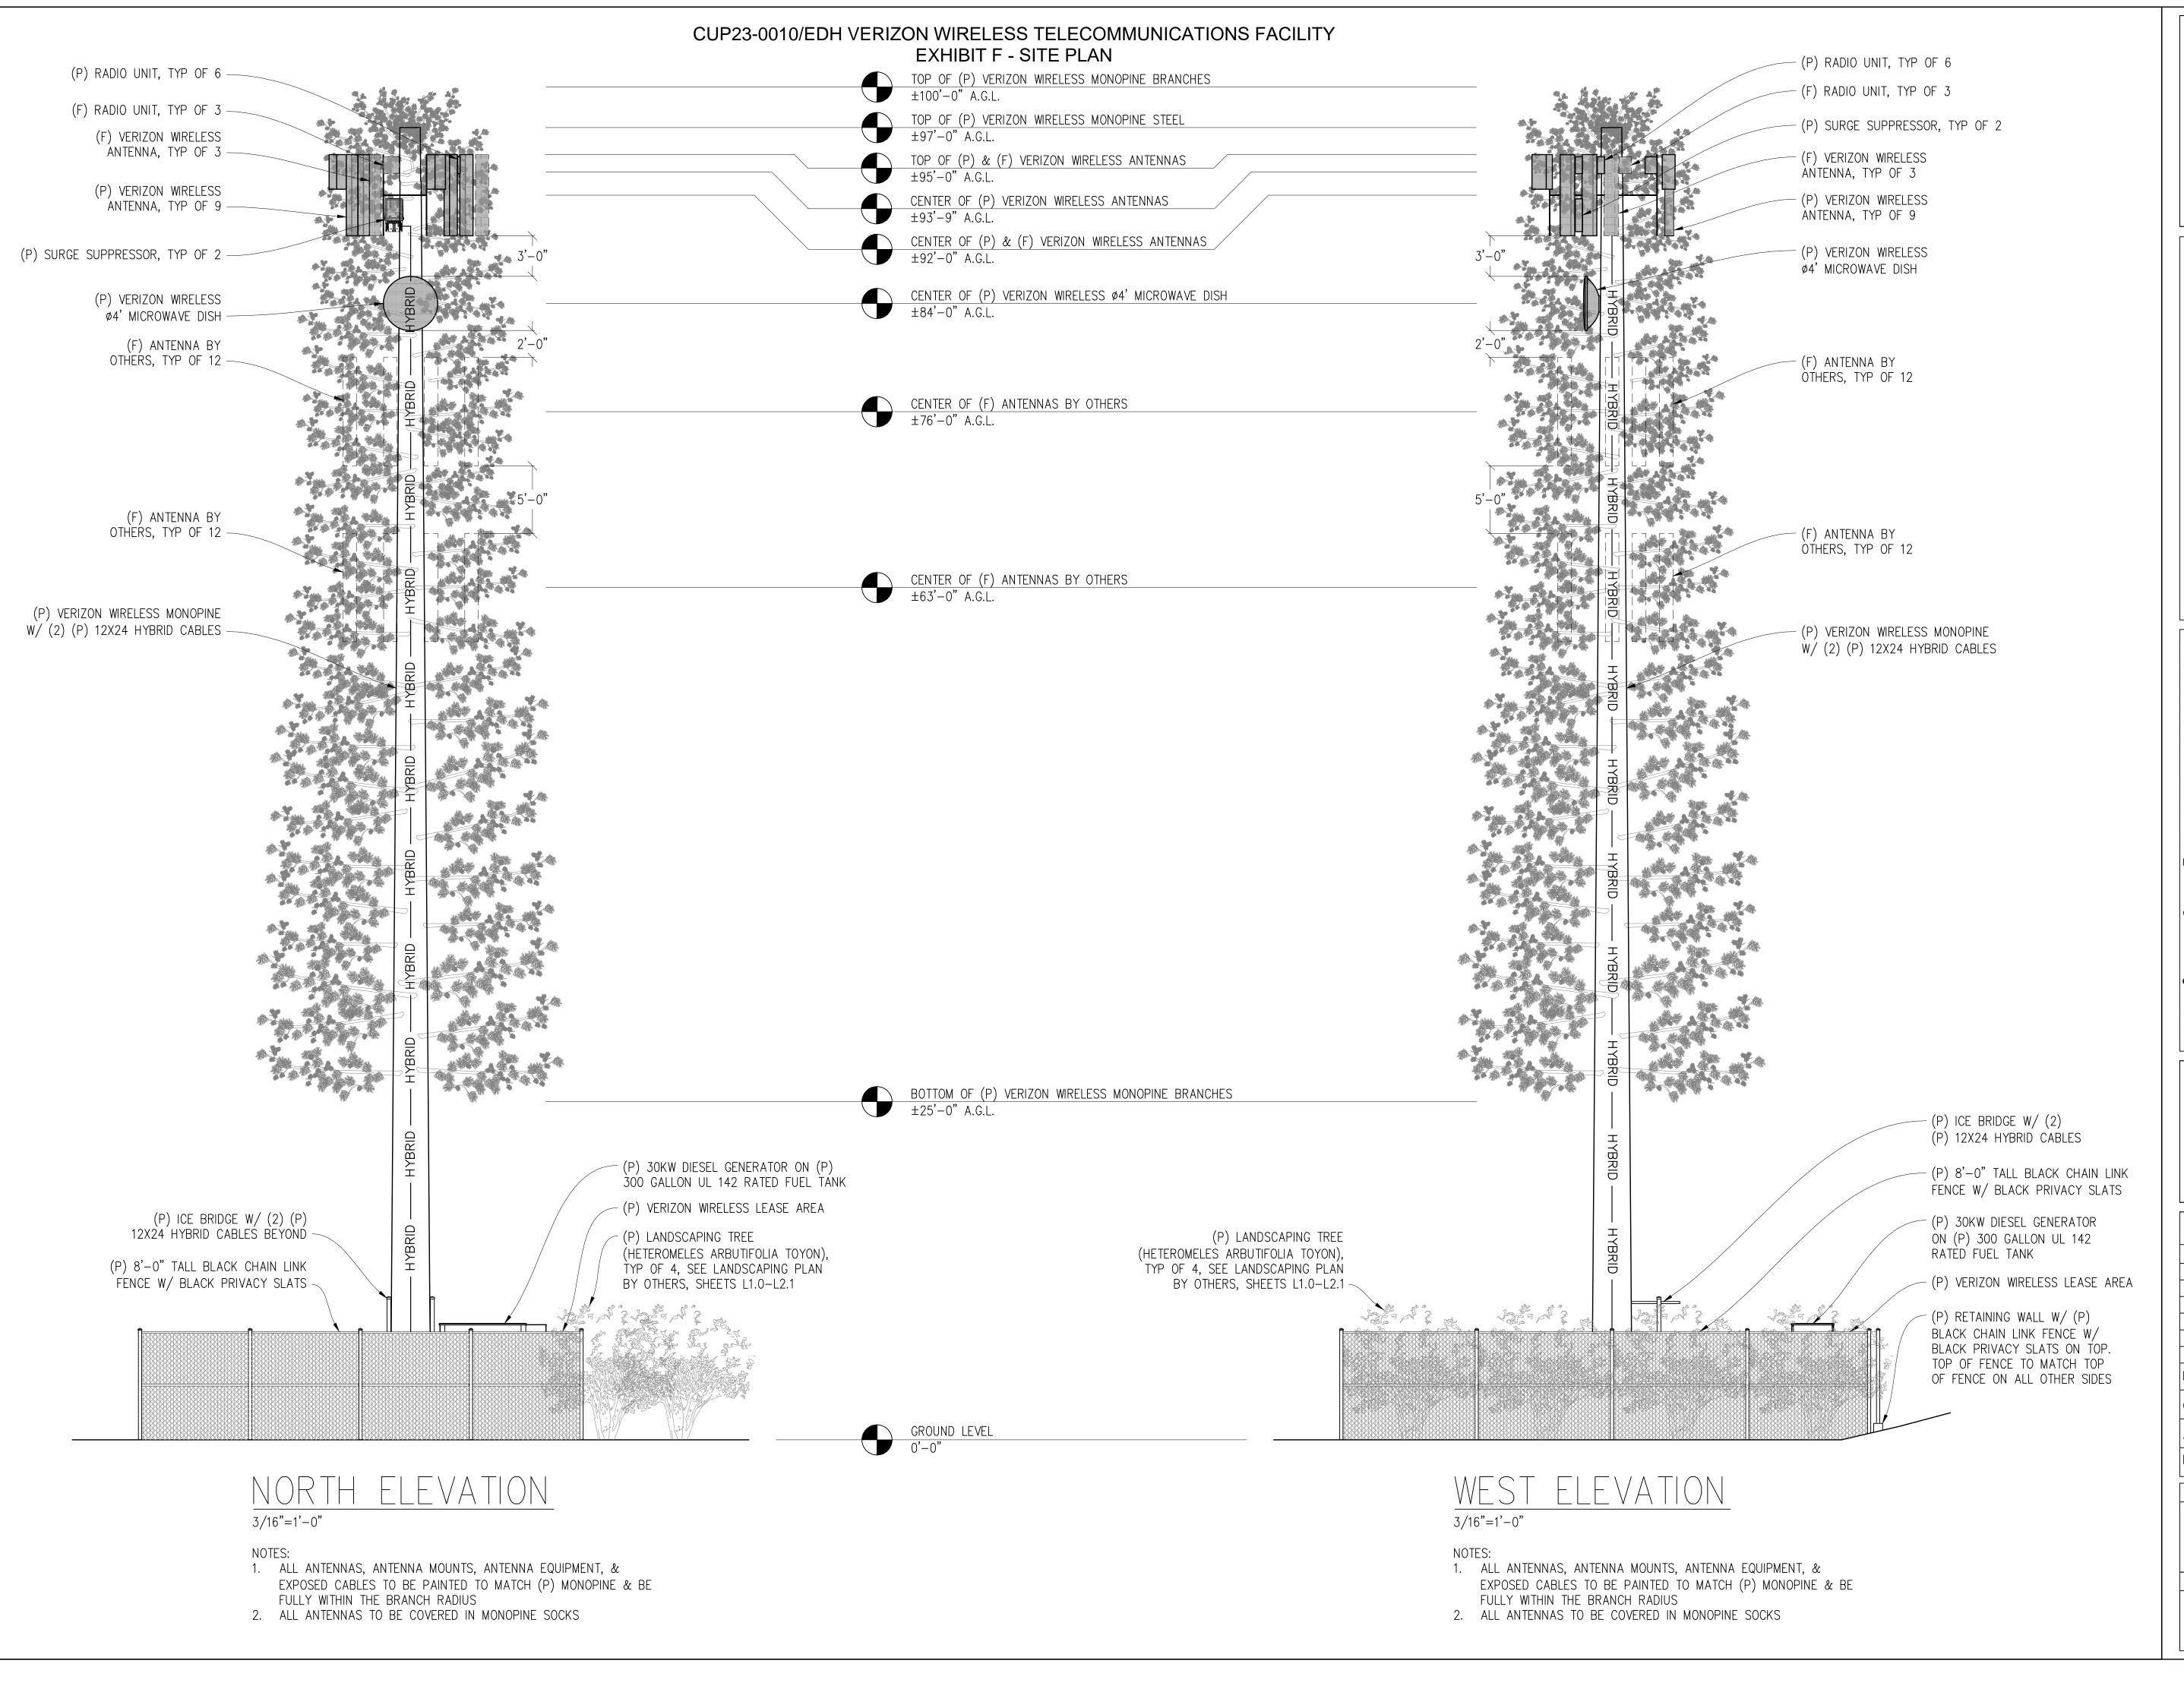

GOLDEN FOOTHILLS

295540
4994 HILLSDALE CIRCLE
EL DORADO HILLS, CA 94585

STEAM IN ESTIMATION SUITE E Granite Bay, CA 95746
Contact: Kevin Sorensen Phone: 916-660-1930
E-Mail: kevin @ streamlineeng.com Fax: 916-660-1941
THESE PLANS AND SPECIFICATIONS, AS INSTRUMENTS OF SERVICE, ARE AND SHALL REMAIN THE PROPERTY OF STREAMLINE ENGINEERING AND DESIGN INC. WHET THE PROJECTS FOR WHICH THEY ARE MADE ARE EXECUTED OR NOT. THESE DRAWINGS AND SPECIFICATIONS SHALL NOT BE USED BY ANY PERSON OR ENTITY ON OTHER PROJECTS WITH OUT PRIOR

PRELIMINARY:
NOT FOR
CONSTRUCTION

KEVIN R. SORENSEN S4469

|    | ISSUE    | STATU:      | S    |
|----|----------|-------------|------|
|    | DATE     | DESCRIPTION | REV. |
|    | 04/08/22 | ZD 90%      | _    |
|    | 05/17/22 | CLIENT REV  | C.C. |
|    | 08/18/22 | ZD 100%     | C.C. |
|    | 08/31/22 | CLIENT REV  | C.C. |
|    | 12/20/22 | CLIENT REV  | C.C. |
|    | _        | _           | _    |
| DR | AWN BY:  | C. CODY     |      |

CHECKED BY: J. GRAY

APPROVED BY: -


DATE: 12/20/22

ELEVATIONS

SHEET TITLE:

SHEET NUMBER:

A-3.1

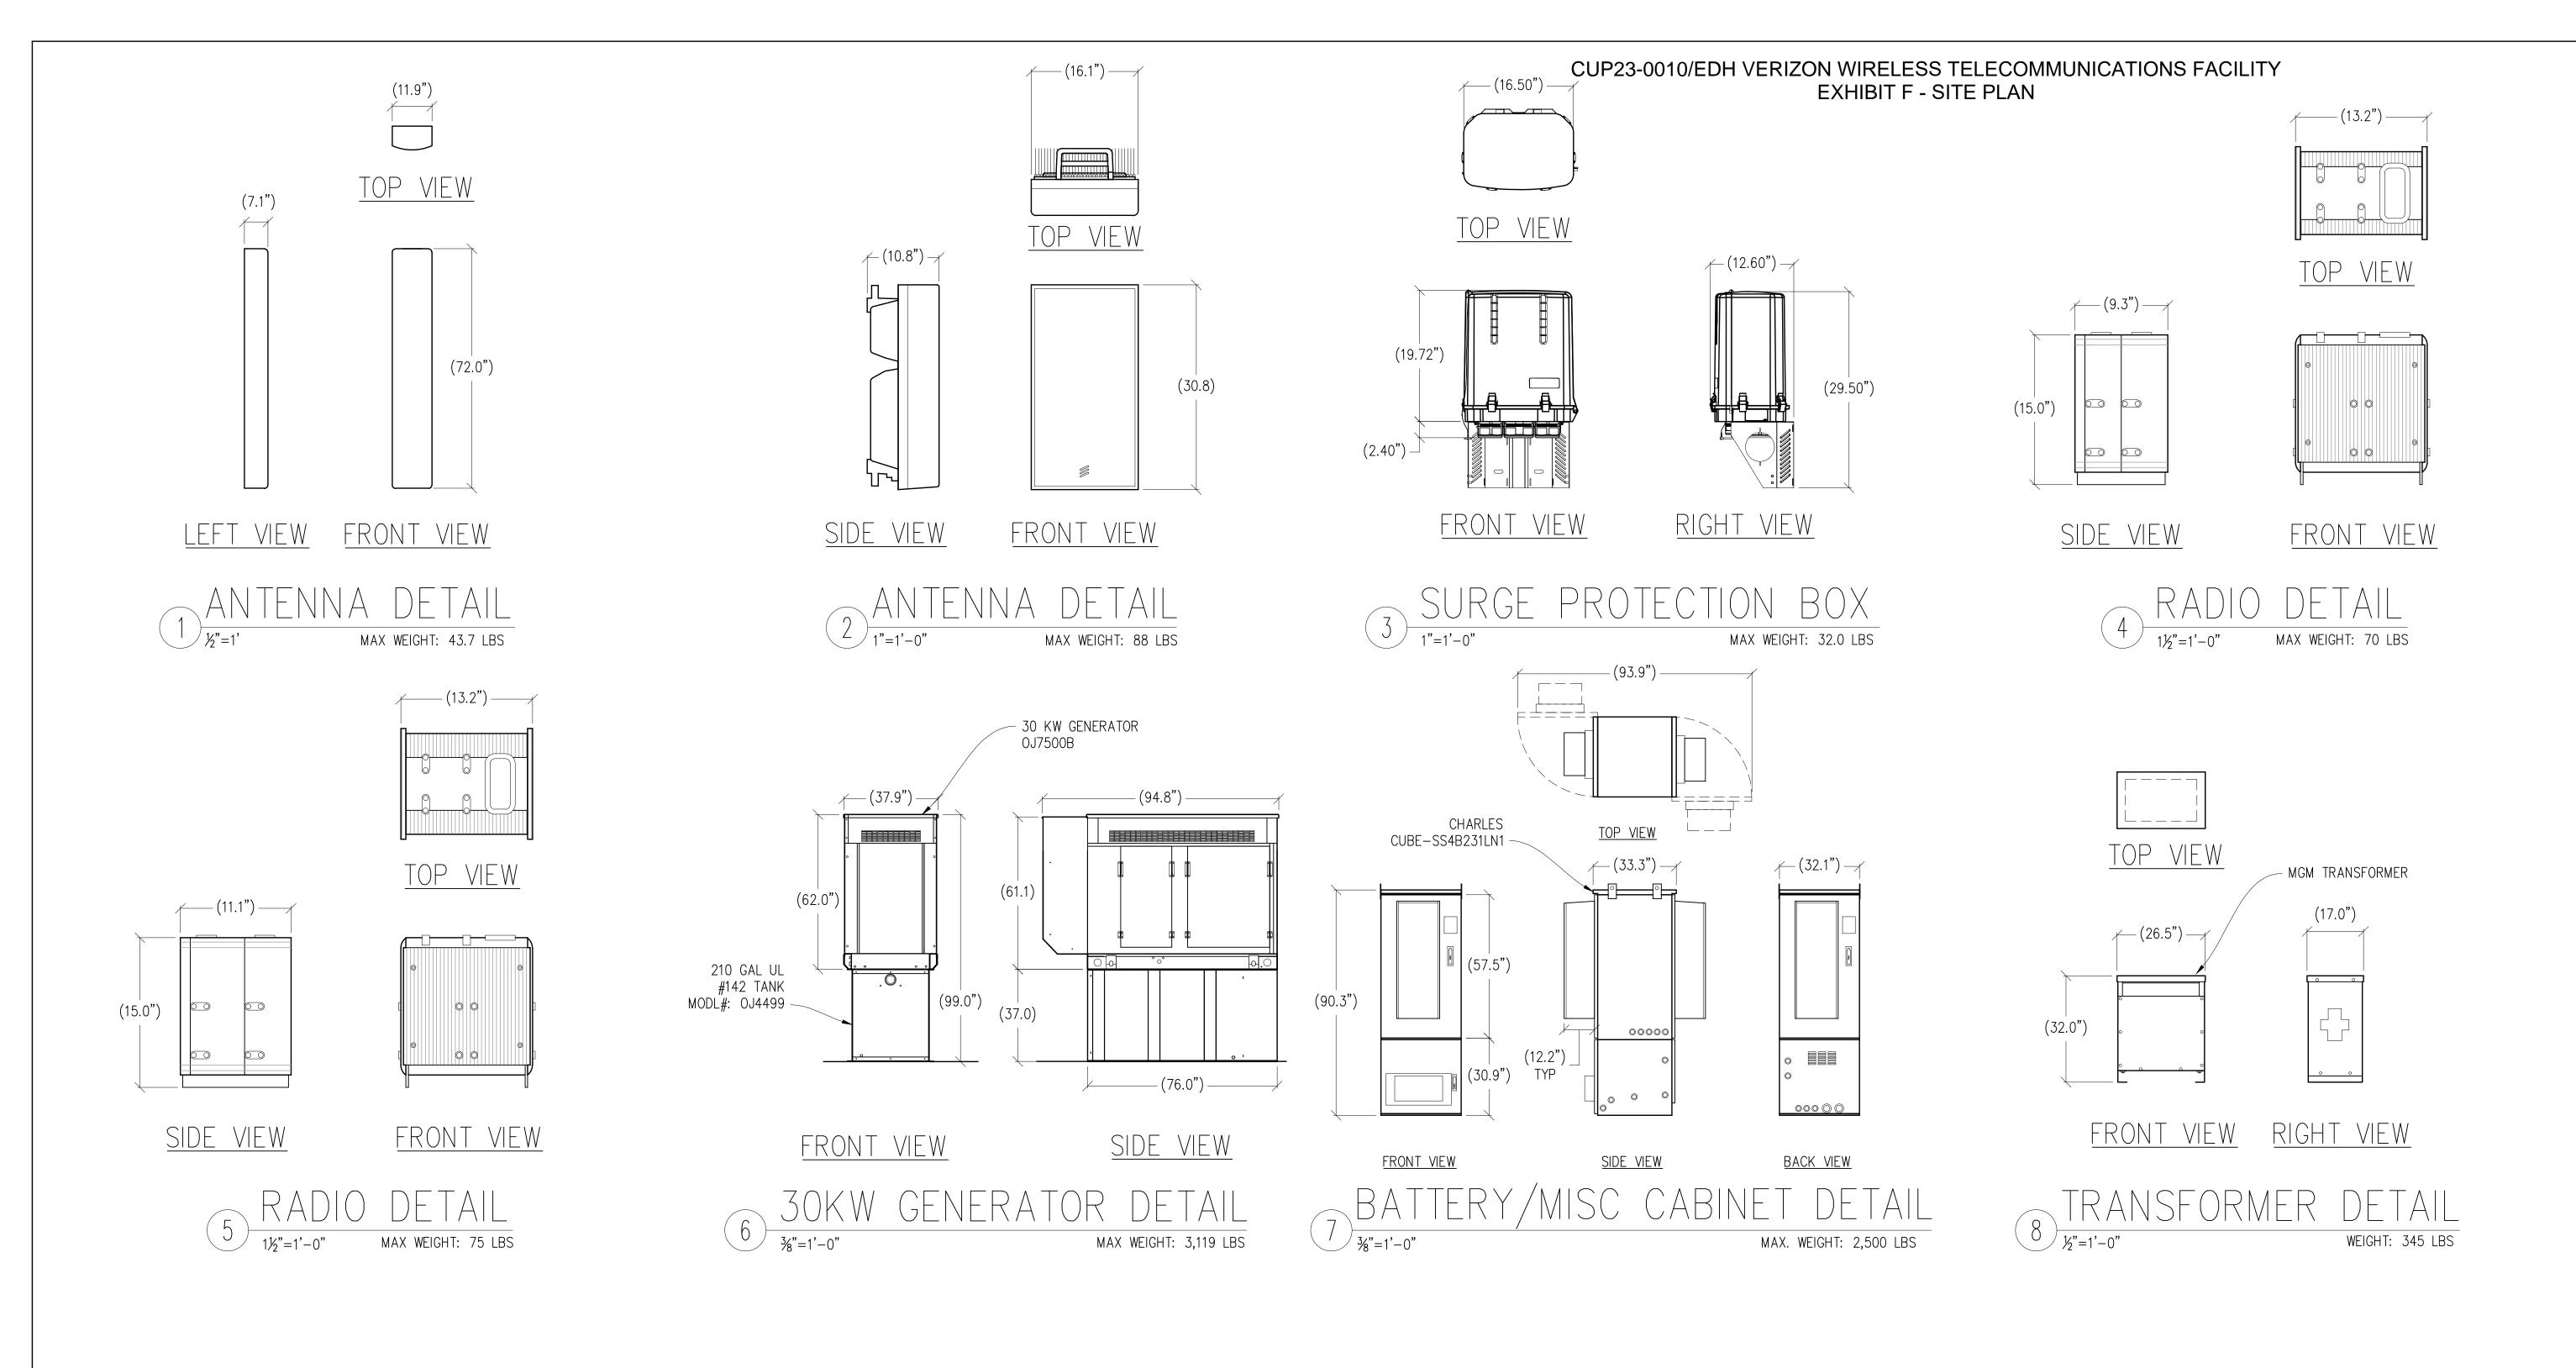



295540
4994 HILLSDALE CIRCLE
EL DORADO HILLS, CA 94585



2785 MITCHELL DRIVE, BLDG 9 WALNUT CREEK, CA 94598



PRELIMINARY:
NOT FOR
CONSTRUCTION

KEVIN R. SORENSEN S4469

|     | ISSUE    | STATUS      | <br>S |
|-----|----------|-------------|-------|
| Δ   | DATE     | DESCRIPTION | REV   |
|     | 04/08/22 | ZD 90%      | _     |
|     | 05/17/22 | CLIENT REV  | C.C   |
|     | 08/18/22 | ZD 100%     | C.C   |
|     | 08/31/22 | CLIENT REV  | C.C   |
|     | 12/20/22 | CLIENT REV  | C.C   |
|     | _        | _           | _     |
| DR. | AWN BY:  | C. CODY     |       |

CHECKED BY: J. GR


CHECKED BY: J. GRAY

APPROVED BY: DATE: 12/20/22

SHEET TITLE:
DETAILS

SHEET NUMBER:

A-4.1

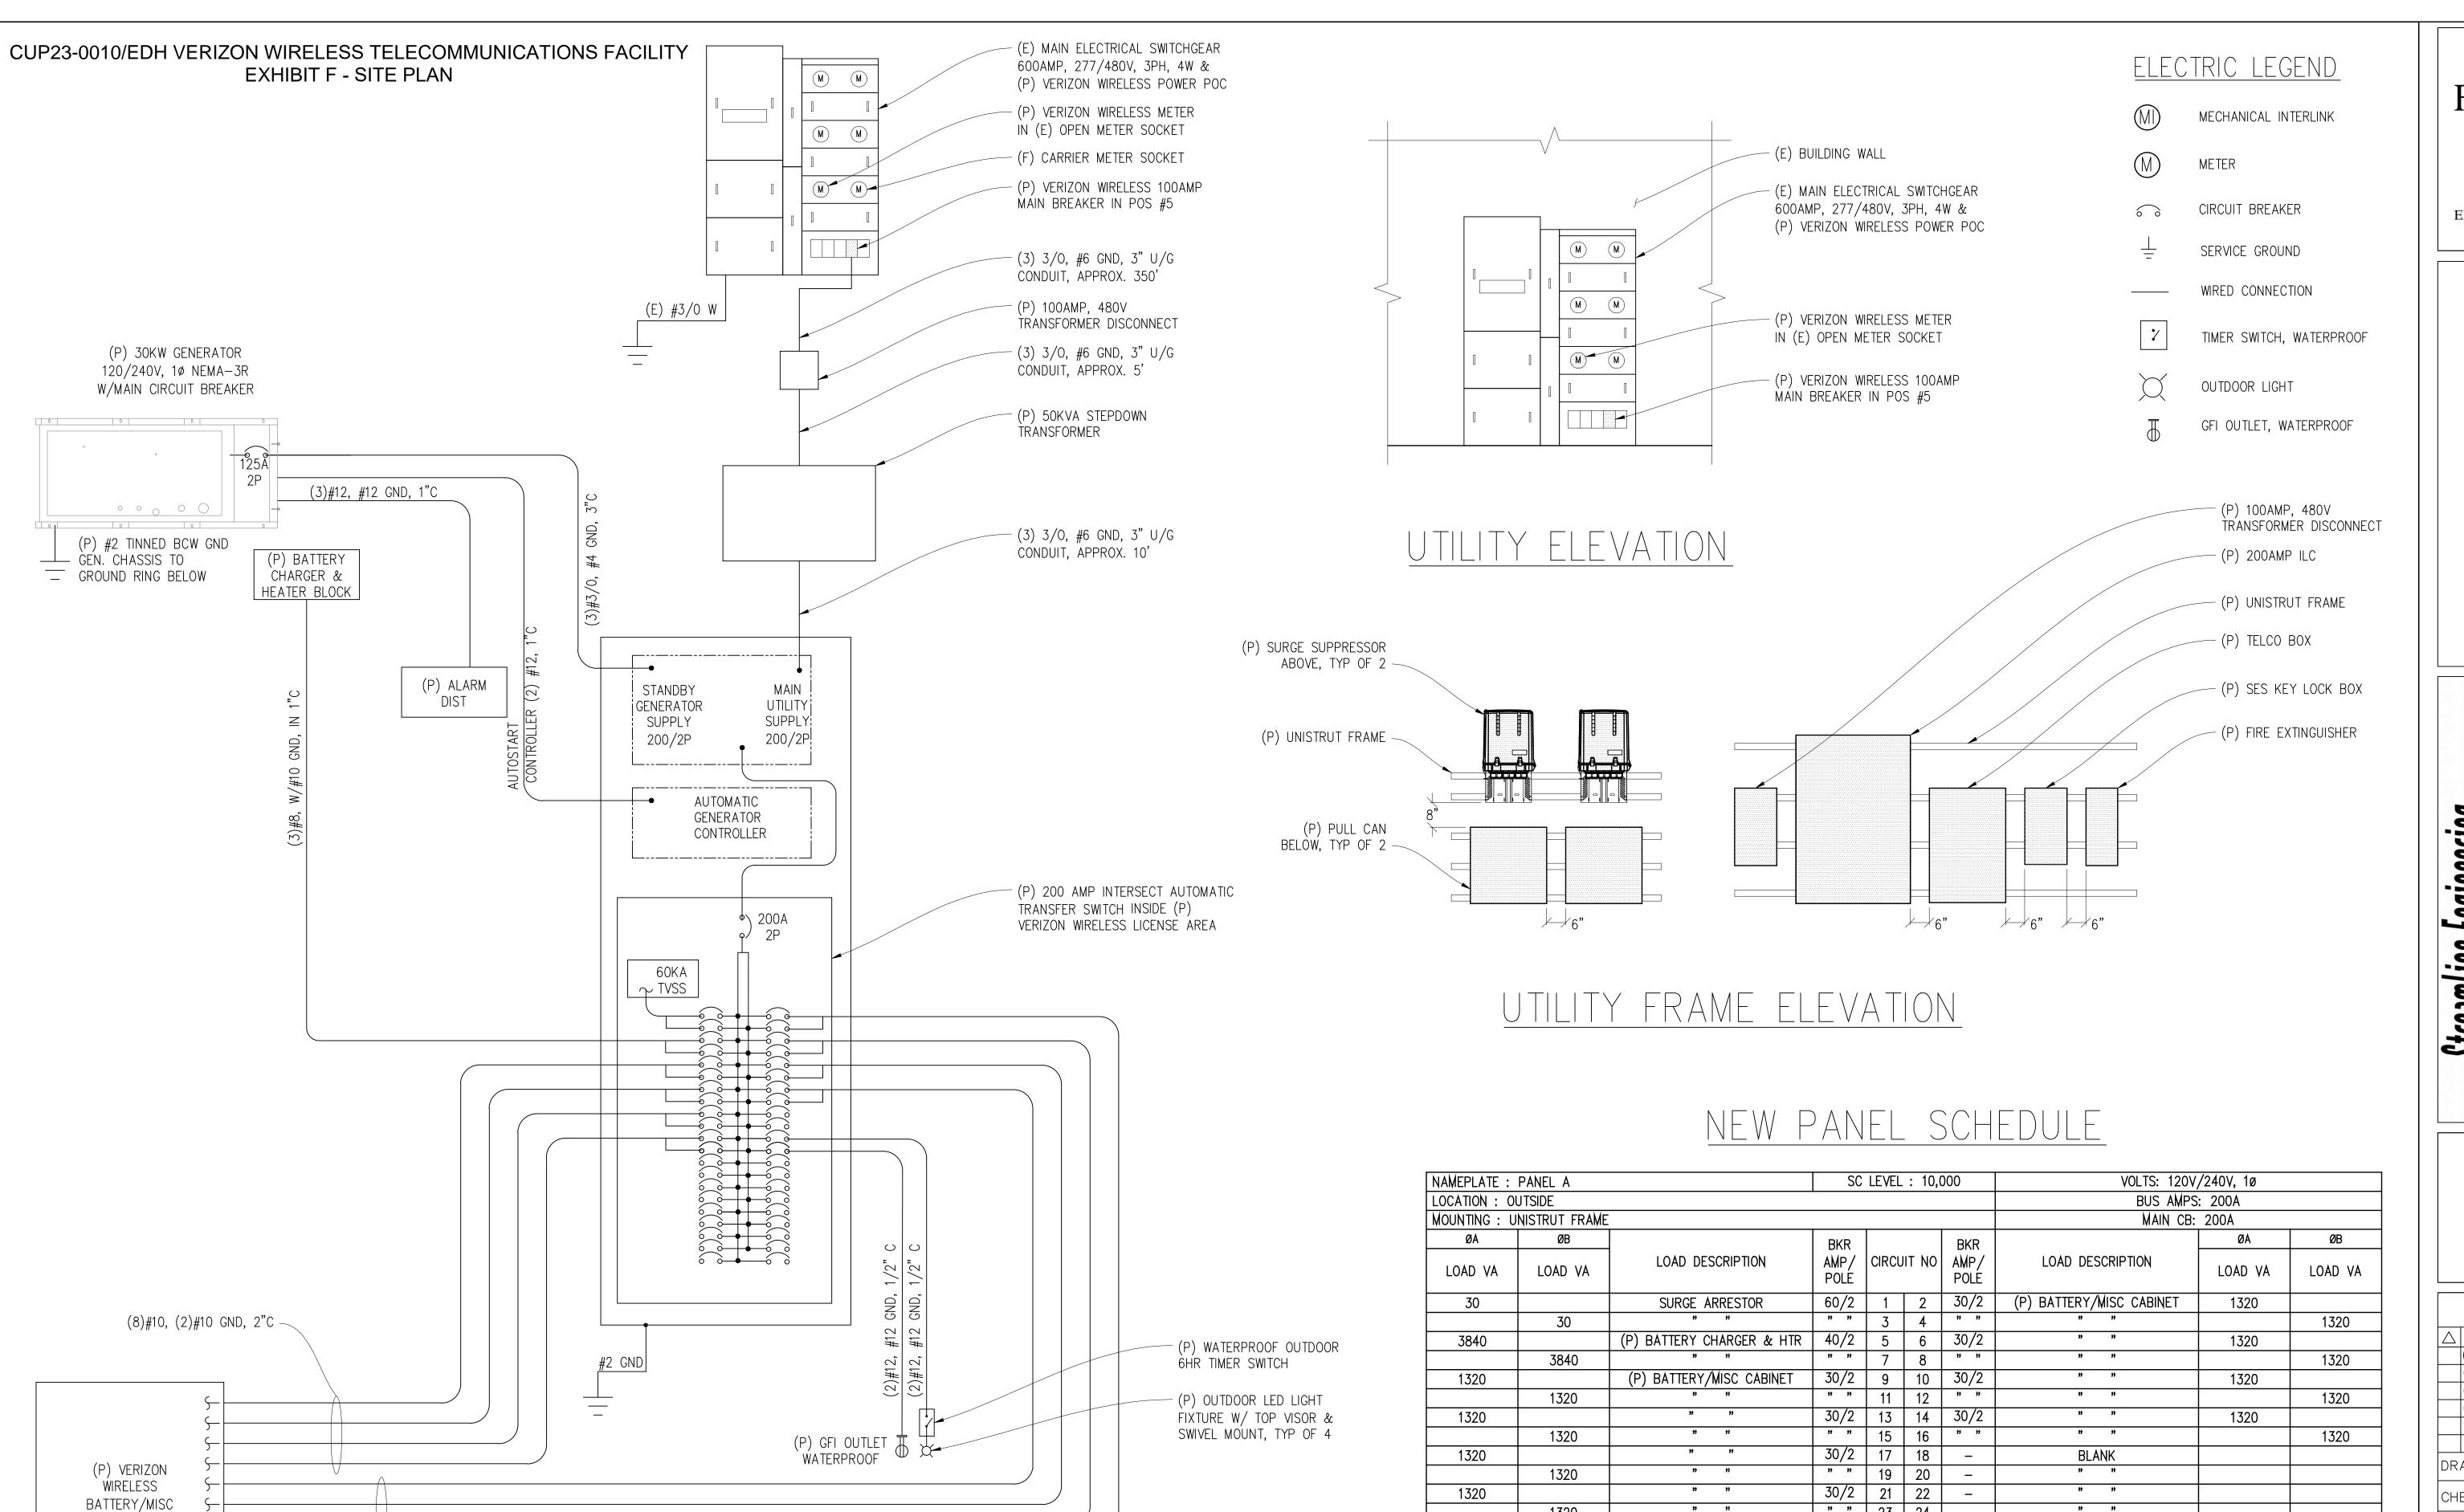

CABINET

- (8)#10, (2)#10 GND, 2°C

SINGLE LINE DIAGRAM

GOLDEN FOOTHILLS

> 295540 4994 HILLSDALE CIRCLE EL DORADO HILLS, CA 94585

2785 MITCHELL D WALNUT CREEK,

Engineering Streamline and De

> PRELIMINARY: NOT FOR CONSTRUCTION KEVIN R. SORENSEN

ISSUE STATUS △ DATE DESCRIPTION REV. ZD 90% CLIENT REV C.C. ZD 100% CLIENT REV C.C. CLIENT REV DRAWN BY: C. CODY CHECKED BY: J. GRAY

APPROVED BY: -

23 24

27 28

31 32

35 36 37 38

39 40 20/1

41 42 20/1

LIGHT

GFI RECEPTACLE

PHASE TOTALS

- 25 26

- 29 30

- 33 34

122

1320

9150

29340

9150

TOTAL VA =

BLANK

PHASE TOTALS

TOTAL AMPS

12/20/22 DATE:

SHEET TITLE:

SINGLE LINE DIAGRAM & PANEL SCHEDULE SHEET NUMBER:

E-1.1

300

5580

180

5460

## **ASSIGNMENT OF RESPONSIBILITY**

GENERAL: THE IRRIGATION SYSTEM IS DESIGNED TO PROVIDE FULL COVERAGE OF ALL PLANTING AREAS WITH MINIMUM OVERSPRAY ONTO PAVING, WALKS, WALLS AND EXISTING UTILITIES. THE IRRIGATION CONSULTANT DOES NOT ASSUME ANY MAINTENANCE OBLIGATIONS.


CONTRACTORS RESPONSIBILITIES: THE CONTRACTORS SHALL ASSUME THE SOLE RESPONSIBILITY FOR THE CORRECT ALIGNMENT OF THE SPRINKLER HEADS, PROPER SETTINGS OF CONTROLLER ENCLOSURES AND ALL OTHER IRRIGATION SYSTEM COMPONENTS. THE CONTRACTOR SHALL BE SOLELY RESPONSIBLE FOR ADJUSTING THE WATERING CYCLES TO SUIT THE SEASONAL REQUIREMENTS, ADJUST THE WATERING CYCLES TO THE SOILS INFILTRATION RATE. NO RUN OFF SHALL OCCUR AT ANY TIME. THE INSTALLATION CONTRACTOR SHALL INSTRUCT THE MAINTENANCE CONTRACTOR IN THE USE AND ADJUSTMENT OF THE IRRIGATION SYSTEM, PERFORM ALL REVIEWS AND AUDITS AS CALLED OUT IN THE IRRIGATION MAINTENANCE NOTES AND SUBMIT WRITTEN REPORTS TO THE

OWNERS RESPONSIBILITIES: THE OWNER SHALL BE SOLELY RESPONSIBLE FOR OBTAINING "AS BUILT" DRAWINGS AND CONTROLLER CHARTS FROM THE INSTALLATION CONTRACTOR. ANY DANGEROUS CONDITIONS THAT MAY OCCUR DURING THE CONSTRUCTION OR LATER MAINTENANCE PERIOD SHALL BE CORRECTED IMMEDIATELY.

SUBSTITUTIONS: NO SUBSTITUTIONS OF MATERIALS SHALL BE ALLOWED DURING THE CONSTRUCTION OR LATER MAINTENANCE WITHOUT THE WRITTEN CONSENT OF THE IRRIGATION CONSULTANT. ALL REPLACEMENT COMPONENTS SHALL BE AS CALLED OUT ON THE DRAWINGS AND IN THE SPECIFICATIONS. THE CONSULTANT CAN NOT BE HELD RESPONSIBLE FOR ALTERATIONS OF THE IRRIGATION SYSTEM THAT WERE DONE WITHOUT HIS WRITTEN PERMISSION.


## **OBSTRUCTIONS**

WHEN VERTICAL OBSTRUCTIONS (PROPS, STREET LIGHTS, TREES, ETC.) INTERFERE WITH THE SPRAY PATTERN OF THE SPRINKLER HEADS SO AS TO PREVENT PROPER COVERAGE, THE IRRIGATION CONTRACTOR SHALL FIELD ADJUST THE SPRINKLER SYSTEM BY INSTALLING A QUARTER CIRCLE OR HALF CIRCLE SPRINKLER HEAD ON EACH SIDE OF THE OBSTRUCTION SO AS TO PROVIDE PROPER COVERAGE. ALL ADJUSTMENTS SHALL BE MADE AT NO ADDITIONAL COST TO THE OWNER. (TYPICAL)

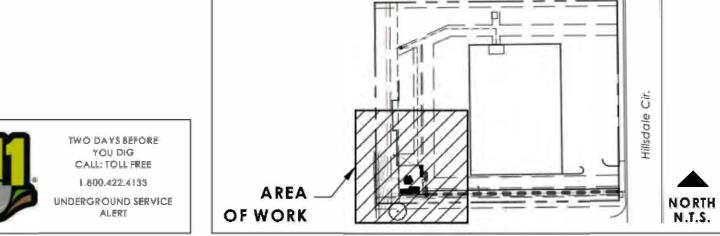

SITE MAP

I HAVE COMPLIED WITH THE CRITERIA OF THE 2015 UPDATE TO THE STATE DEPARTMENT OF WATER RESOURCES MODEL WATER EFFICIENT LANDSCAPE ORDINANCE, INCLUDING INCORPORATING RECOMMENDATIONS OF THE SOIL ANALYSIS REPORT, AND APPLIED THEM FOR THE EFFICIENT USE OF WATER IN THE LANDSCAPE DESIGN PLAN. 2022.12.15

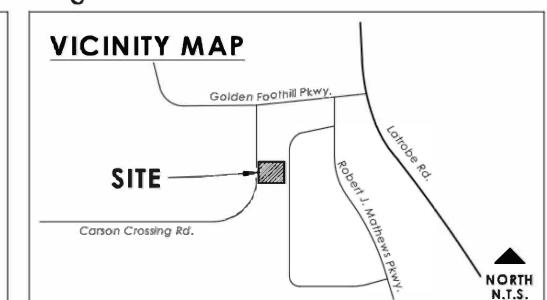

DESIGN GROUP 3203 Lightning St., Sec. 201 // Santa Maria, CA 93455 805.349,9695 // www.plelnairedg.com


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GPM PRECIP



REVISION DATE

SHEET TITLE

PLAN

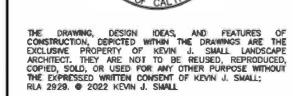IRRIGATION

Verizon Wireless 2785 Mitchell Drive, Bldg. 9 Walnut Creek, California 94598

DATE 2022.12.15 PROJECT NO. 22261 SHEET NO.

L-1.0

- 2. THE IRRIGATION SYSTEM SHALL BE INSTALLED IN ACCORDANCE WITH THE PLANS, IRRIGATION SYSTEM SPECIFICATIONS AND ALL CONTRACT DOCUMENTS. THE CONTRACTOR SHALL COMPLY WITH ALL CURRENT LOCAL CODES, ORDINANCES, AND REGULATIONS.
- 3. ALL IRRIGATION MAINLINE AND LATERAL LINES ARE TO NOT EXCEED A VELOCITY OF 5FPS.
- 4. THE CONTRACTOR SHALL NOT WILLFULLY INSTALL ANY ASPECT OF THE IRRIGATION SYSTEM AS SHOWN ON THE PLANS AND DRAWINGS, WHEN IT IS OBVIOUS IN THE FIELD THAT OBSTRUCTIONS, GRADE DIFFERENCES, OR DISCREPANCIES EXIST THAT MIGHT NOT HAVE BEEN KNOWN DURING THE DESIGN OF THE IRRIGATION SYSTEM. IN THE EVENT THAT NOTIFICATION OF THE CONFLICT IS NOT APPROVED BY THE OWNER'S REPRESENTATIVE, THE CONTRACTOR WILL ASSUME FULL RESPONSIBILITY FOR ALL REVISIONS.
- 5. REFER TO THE LANDSCAPE PLANS WHEN TRENCHING TO AVOID TREE ROOT BALLS WHEN INSTALLING IRRIGATION EQUIPMENT. CALL 811 AND REFER TO UTILITY PLANS PRIOR TO TRENCHING.
- 6. IRRIGATION CONTRACTOR SHALL VERIFY ALL SITE CONDITIONS, INCLUDING UTILITY LOCATIONS BEFORE INSTALLATION OF THE IRRIGATION SYSTEM, THE CONTRACTOR IS RESPONSIBLE FOR COORDINATING INSTALLATION WITH ALL OTHER CONSTRUCTION ON SITE, ESPECIALLY LANDSCAPE INSTALLATION, THE IRRIGATION SYSTEM SHALL BE RELOCATED AT NO ADDITIONAL COST FOR ANY CONFLICT WITH LANDSCAPE INSTALLATION OR ANY OTHER SITE CONSTRUCTION OR EXISTING CONDITIONS.
- 7. VERIFY THE REQUIRED MINIMUM STATIC WATER PRESSURE IS AVAILABLE AT THE PROJECT SITE PRIOR TO BEGINNING THE IRRIGATION INSTALLATION. NOTIFY THE IRRIGATION DESIGN CONSULTANT AND LANDSCAPE ARCHITECT IN WRITING IF THE MINIMUM STATIC WATER PRESSURE OR WATER VOLUME IS NOT AVAILABLE. SEE PLAN SHEET FOR REQUIREMENTS.
- 8. WHERE EXISTING OR NEW TREES, LIGHT FIXTURES, SIGNS, ELECTRONIC CONTROLLERS AND/OR OTHER OBJECTS ARE AN OBSTRUCTION TO AN IRRIGATION SPRINKLER'S PATTERN. THE COMPONENT AND PIPING SHALL BE RELOCATED AS NECESSARY TO OBTAIN PROPER COVERAGE OF AN IRRIGATION SPRINKLER'S PATTERN. THE COMPONENT AND PIPING SHALL BE RELOCATED AS NECESSARY TO OBTAIN THE PROPER COVERAGE WITHOUT DAMAGING THE OBSTRUCTION.
- 9. 100% HEAD TO HEAD COVERAGE IS REQUIRED, ASSURE THAT ANY MODIFIED SPACING DOES NOT EXCEED THE SPACING SHOWN IN THE PLANS.
- 10. IRRIGATION CONTRACTOR SHALL ADJUST ALL SPRINKLERS TO AVOID OVER SPRAY ONTO
- 11. ALL MATERIALS AND EQUIPMENT SHOWN SHALL BEINEW AND INSTALLED AS SHOWN ON THE PLANS. IF THE DRAWINGS DO NOT THOROUGHLY DESCRIBE THE TECHNIQUES TO BE USED, THE INSTALLER SHALL FOLLOW THE INSTALLATION METHODS AND INSTRUCTIONS RECOMMENDED BY THE PRODUCT MANUFACTURER.
- 12. THE LOCATION OF THE IRRIGATION MAINLINE SHALL BE IDENTIFIED IN THE FIELD AND APPROVED BY THE OWNER'S REPRESENTATIVE BEFORE INSTALLATION.
- 13. CONTRACTOR IS TO SUBMIT PRODUCT SPECIFICATION SHEETS FOR ALL IRRIGATION EQUIPMENT TO BE USED FOR APPROVAL BY THE LANDSCAPE ARCHITECT PRIOR TO INSTALLATION.
- 14. THE QUANTITIES SHOWN IN THE LEGEND SHEETS SHALL NOT BE USED FOR BIDDING PURPOSES. THE CONTRACTOR WILL BE RESPONSIBLE FOR CONDUCTING A COMPREHENSIVE MATERIALS TAKEOFF TO DETERMINE THE ACTUAL QUANTITIES OF MATERIAL NECESSARY TO EXECUTE THE WORK DESCRIBED IN THE DOCUMENTS.
- 15. ALL TRENCHES SHALL BE BACKFILLED WITH CLEAN DEBRIS-FREE MATERIALS.
- 16. IRRIGATION CONTRACTOR IS TO INSTALL CHRISTY ZONE TAGS WITH THE CORRESPONDING CONTROLLER ZONE NUMBER AT EACH CONTROL VALVE.
- 17. AS BULT DOCUMENTS ARE TO BE PROVIDED TO THE OWNER UPON COMPLETION OF THE PROJECT. THE MAINLINE, CONTROL VALVES, ISOLATION VALVES, GROUND RODS AND SPLICE BOXES SHALL BE LOCATED WITH A MEASUREMENT FROM TWO FIXED POINTS.
- 18. IRRIGATION CONTRACTOR SHALL SECURE ANY AND ALL NECESSARY PERMITS FOR THE WORK PRIOR TO COMMENCEMENT OF ON-SITE OPERATIONS.
- 19. A MAINLINE PRESSURE TEST IS TO BE CONDUCTED BEFORE BACKFILLING, ALL FINDINGS ARE TO BE REPORTED TO THE LANDSCAPE ARCHITECT WITHIN TWENTY FOUR HOURS POST TEST
- 20. ALL SLEEVES ARE TO BE TWO TIMES THE SIZE OF THE PIPE.
- 21. THE IRRIGATION SYSTEM IS TO BE INSPECTED AND APPROVED BY THE PROJECT OWNER PRIOR TO RECEIVING CERTIFICATION.
- 22. ANY PRODUCT SUBSTITUTIONS MADE BY THE IRRIGATION CONTRACTOR ARE TO BE REVIEWED AND APPROVED BY THE OWNER PRIOR TO INSTALLATION.
- 28. ALL DISTRIBUTION DRIP TUBING IS TO BE 1 PER MANUFACTURER SPECIFICATIONS AND DETAIL. ALL DISTRIBUTION TUBING FROM THE DRIP TUBING IS TO BE 1 PER MANUFACTURER SPECIFICATIONS AND THE DETAIL. SIZE ALL FEEDER LATERAL LINES PER THE PLANS.
- 24 THESE PLANS COMPLY WITH THE CRITERIA OF THE WATER EFFICIENT LANDSCAPE ORDINANCE AND APPLIED THEM FOR THE EFFICIENT USE OF WATER IN THE LANDSCAPE DESIGN PLAN.

## MWELO IRRIGATION NOTES

DESIGN & INSTALLATION REQUIREMENTS FOR THE MODEL WATER EFFICIENT LANDSCAPE ORDINANCE (MWELO) EFFECTIVE DECEMBER 1, 2015

- A.DESIGN AND INSTALLATION SHALL INCLUDE THE FOLLOWING:
- 1. AUTOMATIC IRRIGATION CONTROLLER USING ET OR SOIL MOISTURE SENSOR DATA AREA REQUIRED.
- a. LANDSCAPE WATER METERS (DEDICATED OR PRIVATE) SHALL BE INSTALLED FOR ALL NON-RESIDENTIAL LANDSCAPE OF 1,000 SQUARE FEET BUT NOT MORE THAN 5,000 SQUARE FEET OR GREATER.
- b. RESIDENTIAL OVER 5,000 SQUARE FEET.
- 2. RAIN, FREEZE AND WIND SENSORS ARE REQUIRED, AS NEEDED FOR LOCAL CLIMATE.
- 3. FLOW SENSORS THAT DETECT HIGH FLOW ARE REQUIRED FOR ALL NON-RESIDENTIAL LANDSCAPES AND RESIDENTIAL 5,000 SQUARE FEET.
- 4. PRESSURE REGULATING DEVICES ARE REQUIRED. LOW FLOW WILL NEED
- 5. CHECK VALVE AND ANTI-DRAIN VALVES ARE REQUIRED WHERE LOW HEAD DRAINAGE COULD OCCUR.
- 6. NO OVERHEAD IRRIGATION WITHIN 24 INCHES OF ANY NON-PERMEABLE SURFACE.
- 7. LOW VOLUME (DRIP) IRRIGATION IS REQUIRED ON MULCHED PLANTING AREAS.
- 8. AREAS LESS THAN 10 FEET IN WIDTH IN ANY DIRECTION MUST BE IRRIGATED WITH SUBSURFACE IRRIGATION OR ANOTHER MEANS THAT PRODUCES NO RUNOFF.
- 9. ALL SPRINKLER HEADS MUST DOCUMENT A LOWER QUARTER DISTRIBUTION UNIFORMITY (DULQ) OF 65% OR HIGHER.

10. EMISSION DEVICES MUST HAVE MATCHED PRECIPITATION RATES.


11. SOIL MANAGEMENT REPORT THAT INCLUDES SOIL ANALYSIS: TEXTURE, INFILTRATION RATE, PH, SOLUBLE SALTS, SODIUM, % ORGANIC, RECOMMENDATIONS.

#### B. SOIL PREPARATION;


- 1. PRIOR TO PLANTING COMPACTED SOIL SHALL BE TRANSFORMED TO A FRIABLE CONDITION.
- 2. INSTALLATION: COMPOST AT A MINIMUM RATE OF FOUR CUBIC YARDS PER 1.000 SQUARE FEET OF PERMEABLE AREA SHALL BE INCORPORATED TO A DEPTH OF 6 INCHES INTO SOIL.

#### CJRRIGATION AUDITS:

- 1. LANDSCAPE AUDITS SHALL NOT BE CONDUCTED BY THE PERSON WHO DESIGN OR INSTALLED THE LANDSCAPE AND CONDUCTED IN A MANNER CONSISTENT WITH THE IA LANDSCAPE IRRIGATION AUDIT OR "WATERSENSE" LABELING AUDIT BY USEPA.
- 2. CERTIFICATE OF COMPLETION SUBMITTED TO LOCAL AGENCY FOR APPROVAL.

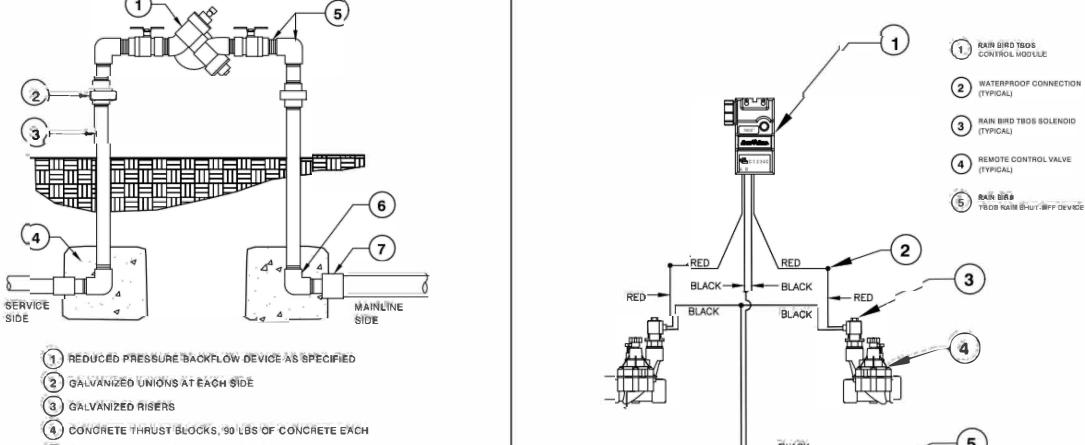


BATTERY-OPERATED CONTROLLER REDUCED PRESSURE BACKFLOW DEVICE FX-IR-FX-BACK-03

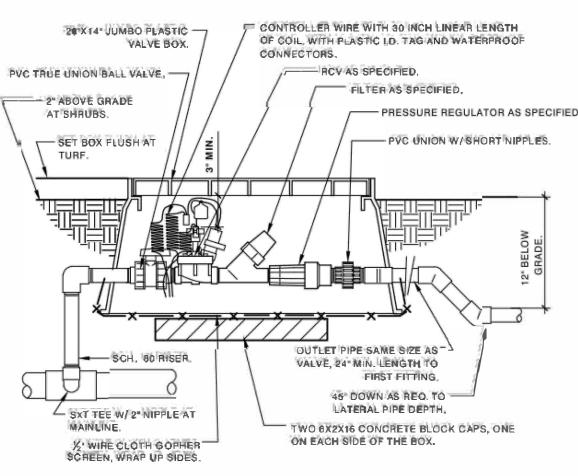


(5) GALVANIZED NIPPLES AND ELL AS REQUIRED

(6) GALVANIZED ELL AND NIPPLE, TYPICAL EACH SIDE

7 PVC COUPLER AND SCH. 80 TOE NIPPLE, TYPICAL EACH SIDE

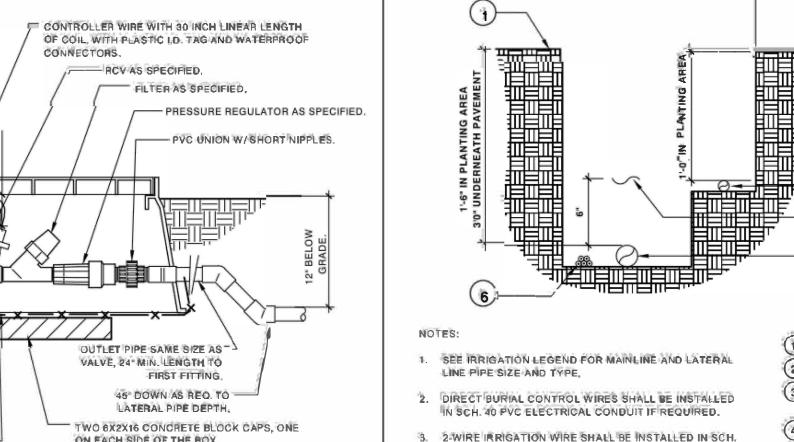


1" DRIP VALVE/FILTER/REGULATOR 1 1/2" = 1'-0" FX-IR-FX-DRIP-12

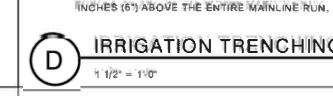

40 PVC ELECTRICAL CONDUIT.


4 DETECTABLE LOCATOR TAPE SHALL BE LOCATED SIX

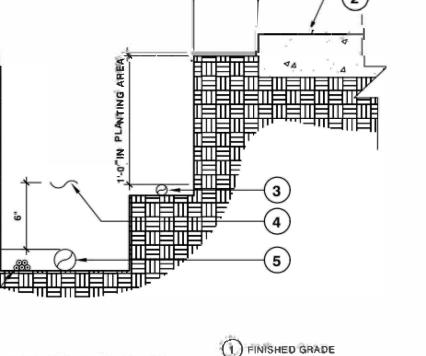

1 FINISHED GRADE 2 PAVEMENT (LATERAL LINE)

(4) DETECTABLE LOCATOR TAPE (5) PRESSURIZED LINE (MAINLINE) (6) DIRECT BURIAL LOW VOLTAGE CONTROL WIRES

IRRIGATION TRENCHING FX-IR-FX-AUXEQ-08

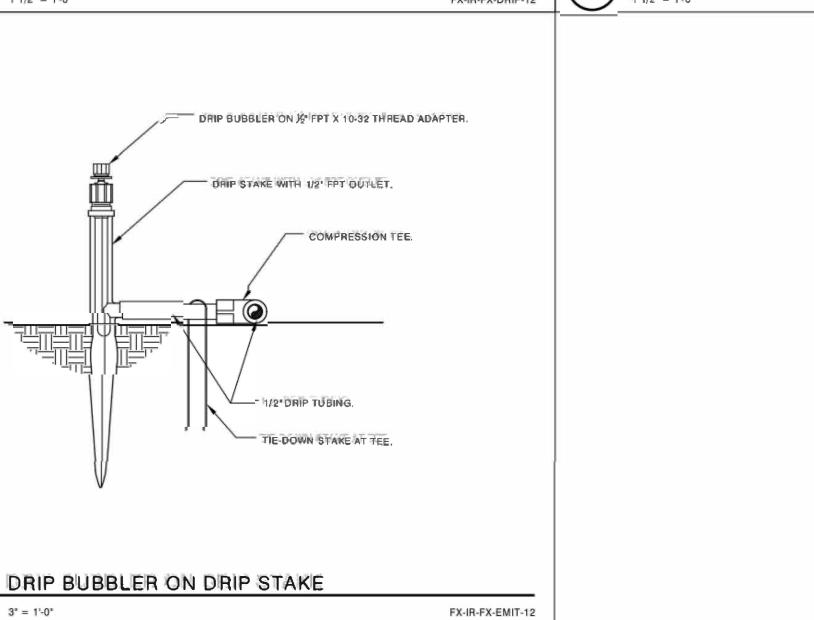

REVISION DATE

SHEET TITLE

SHEET NO.


IRRIGATION **NOTES & DETAILS** 


DESIGN GROUP

3203 Lightning St., Sec. 201 // Santa Maria, CA 93455

805.349.9695 // www.pleinsiredg.com

Verizon Wireless 2785 Mitchell Drive, Bldg. 9 Walnut Creek, California 94598 DATE 2022.12-15 PROJECT NO.

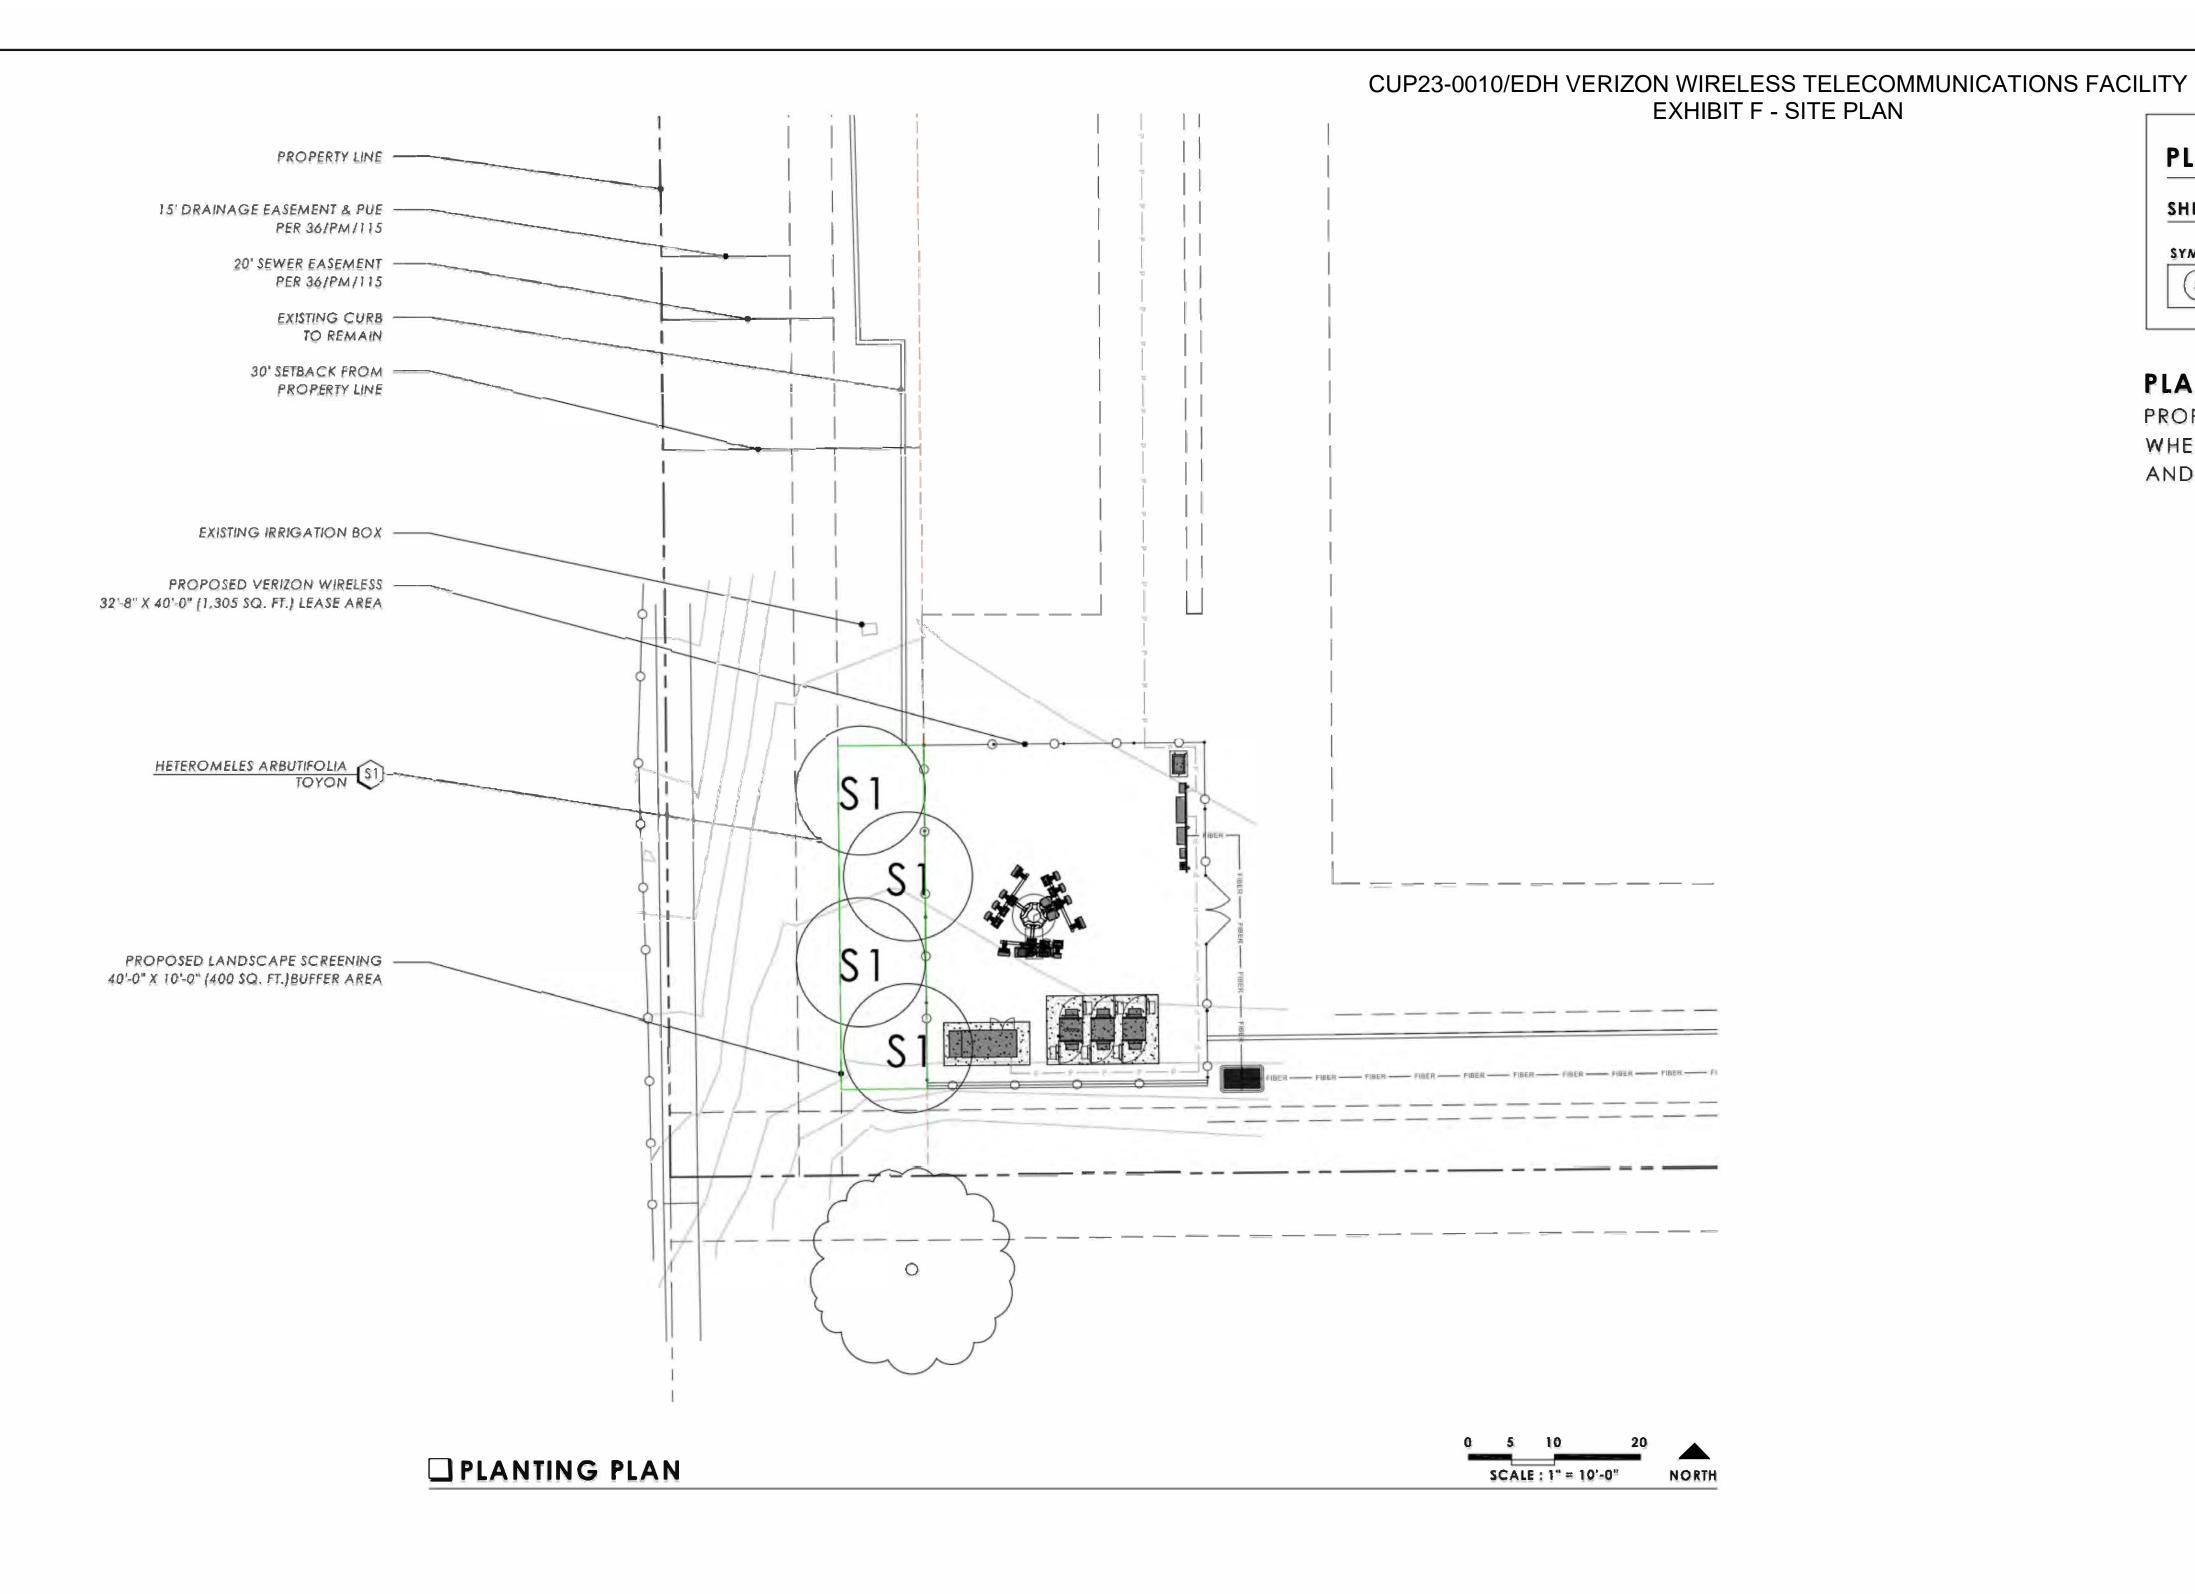

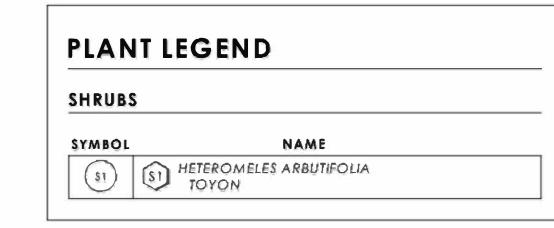


#### **PLANT NOTE:**

PROPOSED SHRUB, HETEROMELES ARBUTIFOLIA, WHEN FULL MATURE, MAY REACH 30' IN HEIGHT AND 15' IN WIDTH.



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NORTH N.T.S.

| VICINITY MAP  Golden Foothill Pkwy. |  |
|-------------------------------------|--|
| SITE Room Crossing Rd.              |  |
| NORT<br>N.T.S                       |  |
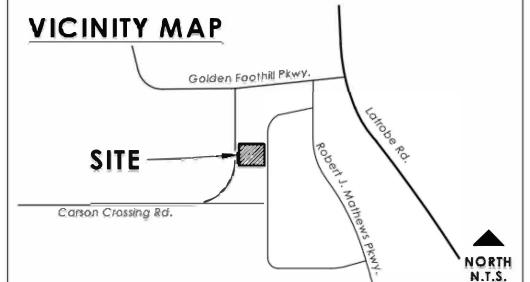
| OWNER      | Verizon Wireless             |
|------------|------------------------------|
|            | 2785 Mitchell Drive, Bldg. 9 |
| Walr       | nut Creek, California 94598  |
| DATE       | 2022,12,15                   |
| PROJECT NO | 22261                        |

REVISION DATE

SHEET TITLE

PLANTING

SITE MAP

|                  | 2000             | 19 9 10 10 1 | A CHEST   | Sec. 128 | N 175 W    | H44            |            |
|------------------|------------------|--------------|-----------|----------|------------|----------------|------------|
|                  | CERT             | IFICAT       | EOF       | COMP     | LETIC      | ON             |            |
| This certificate | is filled out by | the project  | applicant | upon ca  | mpletion o | of the landsca | pe project |

| Date                      |                |          |  |
|---------------------------|----------------|----------|--|
| Project Name              |                |          |  |
| Name of Project Applicant | Telephone No.  |          |  |
|                           | Fax No.        |          |  |
| Title                     | Email Address  |          |  |
| Company                   | Street Address | 100      |  |
| City                      | State          | Zlp Cade |  |

| Street Address |          | Parcel, tract or lot number, if available. |  |
|----------------|----------|--|--|
| City           |          | Latitude/Longitude (optional)              |  |
| State          | Zip Code |  |  |

| Property Owner or his/Name | Telephone No.  |                |  |  |
|----------------------------|----------------|----------------|--|--|
|                            | Fax No.        | Fax No.        |  |  |
| Title                      | Email Address  | Email Address  |  |  |
| Company                    | Street Address | Street Address |  |  |
| City                       | State          | Zip Code       |  |  |

**Property Owner** 

"I/we certify that I/we have received copies of all the documents within the Landscape Documentation Package and the Certificate of Completion and that it is our responsibility to see that the project is maintained in accordance with the Landscape and Irrigation Maintenance Schedule."

| )————————————————————————————————————— |      |
|--|------|
| Property Owner Signature               | Date |

Please answer the questions below:

- Date the Landscape Documentation Package was submitted to the local agency

  Date the Landscape Documentation Package was approved by the local agency

  Date that a copy of the Water Efficient Landscape Worksheet (including the Water Budget Calculation) was submitted to the local water purveyor \_\_\_\_\_\_

#### PART 2. CERTIFICATION OF INSTALLATION ACCORDING TO THE LANDSCAPE DOCUMENTATION PACKAGE

Ave certify that based upon periodic site observations, the work has been substantially completed in accordance with the ordinance and that the landscape planting and irrigation installation conform with the criteria and

| Signature*                     | Date           |          |  |
|--------------------------------|----------------|----------|--|
| Name (print)                   | Telephane No.  |          |  |
|                                | Fax No.        |          |  |
| Trle                           | Email Address  |          |  |
| License No or Certification No |                |          |  |
| Company                        | Street Address |          |  |
| City                           | State          | Zip Code |  |

"Signer of the landscape design plan, signer of the irrigation plan, or a licensed landscape contractor.

#### PART 3. IRRIGATION SCHEDULING

Attach parameters for setting the imigation schedule on controller per ordinance Section 492.10.

PART 4. SCHEDULE OF LANDSCAPE AND IRRIGATION MAINTENANCE Attach schedule of Landscape and Irrigation Maintenance per ordinance Section 492 11.

PART 5. LANDSCAPE IRRIGATION AUDIT REPORT Attach Landscape Irrigation Audit Report per ordinance Section 492.12.

#### PART 6. SOIL MANAGEMENT REPORT

Attach soil analysis report, if not previously submitted with the Landscape Documentation Package per ordinance Attach documentation verifying implementation of recommendations from soil analysis report per ordinance

#### CUP23-0010/EDH VERIZON WIRELESS TELECOMMUNICATIONS FACILITY EXHIBIT F - SITE PLAN

#### GENERAL PLANTING NOTES

- 1. REMOVE ALL DEBRIS, WEEDS. EXCESS MATERIAL AND ROCKS LARGER THAN 3" IN DIAMETER FROM PLANTING AREAS"
- 2. CROSS RIP ALL TURF AND PLANTING AREAS TO A DEPTH OF 12" AND BLEND THE FOLLOWING AMENDMENT INTO THE TILLED SOIL TO A DEPTH OF 6".
  - 2.1. PER 1000 SQUARE FEET:

MINIMUM FLOW IN ALL PLANTER AREAS,

- 2:1.1: 6 CUBIC YARDS NITROGEN AND IRON FORTIFIED ORGANIC SOIL AMENDMENT
- 2.1.2. 14 POUNDS 12-12-12 FERTILIZER
- 2.1.3. 15 POUNDS SOIL SULFUR EXCAVATE THE PLANTING PITS FOR TREES AND SHRUBS TWICE THE DIAMETER AND TWICE THE DEPTH OF THE ROOT BALL SCARIFY THE SIDES AND BOTTOM OF THE PIT. THE BACKFILL MIX FOR USE AROUND THE ROOT BALL SHALL CONSIST OF THE FOLLOWING:
- 3.1. PER CUBIC YARD OF SOIL:
  - 3.1.1. 1/3 CUBIC YARD NITROGEN STABILIZED FIR BARK
  - 3.1.2. 1 POUND 12-12-12 FERTILIZER
  - 3.1.3. 1 1/2 POUNDS IRON SULFATE (20% IRON)
- 3.1.4. 2/3 CUBIC YARD TOPSOIL
- PLANT TABS SHALL BE AGRIFORM OR APPROVED EQUAL USED AT MANUFACTURER'S RECOMMENDED RATE FOR EACH PLANT SIZE.
- SOIL AMENDMENT AND BACKFILL MIX ARE PROVIDED FOR BIDDING PURPOSES ONLY. THE CONTRACTOR SHALL PROVIDE FOR IN HIS BID FOR A SOIL AGRONOMY REPORT BY AN APPROVED SOIL AGRONOMIST UPON COMPLETION OF THE ROUGH GRADING. ACTUAL SOIL AMENDMENTS AND BACKFILL MIX SHALL BE AS PER SOIL AGRONOMISTS REPORT AND RECOMMENDATIONS.
- FINE PRUNE ALL SPECIMEN TREES AFTER PLANTING UNDER THE DIRECTION OF THE LANDSCAPE ARCHITECT.
- ALL SPECIMEN TREES SHALL BE SELECTED AT THE SOURCE BY THE LANDSCAPE ARCHITECT.
- UPON COMPLETION, REMOVE ALL EXTRANEOUS MATERIAL AND DEBRIS, BROOM AND WASH CLEAN AREA. ACTUAL SYMBOLS SHALL HAVE PRIORITY OVER WRITTEN QUANTITIES. CONTRACTOR SHALL VERIFY QUANTITIES AND NOTIFY LANDSCAPE ARCHITECT OF DISCREPANCIES.
- ALL PLANT MATERIAL, COLOR, SIZE AND QUANTITIES ARE TO BE VERIFIED WITH OWNER.
- 10. ALL SUBSTITUTIONS SHALL BE APPROVED BY LANDSCAPE ARCHITECT AND OWNER, PRIOR TO INSTALLATION. 11. ALL FLOW LINES ESTABLISHED BY GRADING PLAN SHALL BE MAINTAINED BY FINISH GRADING. MAINTAIN 1.5%

PLANT LEGEND

#### SHRUBS


| SYMBOL | NAME                    | COMMENTS                 | ŠIŽE    | WUCOLS | QTY. |
|--------|-------------------------|--------------------------|---------|--------|------|
| \$1    | HETEROMELES ARBUTIFOLIA | PLANT PER DETAIL A/L-2.1 | 15 GAL. | LOW    | 2    |


## PLANTING LEGEND NOTES

- ALL SHRUBS ARE TO BE PLANTED PER A/L-2,1.
- CONTRACTOR IS TO PROVIDE AN AUTOMATIC IRRIGATION SYSTEM WITH 100% COVERAGE AND SEPARATE SUN/SHADE AND TURF/GROUNDCOVER SYSTEMS. REFER TO IRRIGATION PLANS FOR SPECIFICS OF INSTALLATIONS.
- CONTRACTOR SHALL NOT DETOUR FROM ANY OF THE PLANT MATERIAL ON THE LIST UNLESS CONSULTING WITH THE LANDSCAPE
- ARCHITECT FIRST. CONTRACTOR SHALL INSTALL HEADER AT THE EDGE OF ALL TURF TO SHRUB AREAS. SEE DETAILS FOR MATERIAL.
- ALL SHRUBED AREAS SHALL RECEIVE A 3" LAYER OF MEDIUM SIZED FIR MULCH 1/2" TO 1" IN DIAMETER. TOP SURFACE OF MULCH SHALL BE A MINIMUM OF 1" BELOW ANY ADJACENT HARDSCAPE. "GORILLA HAIR" OR POST CONSTRUCTION WASTE WILL NOT BE
- ALL SLOPE AREAS 3:1 OR GREATER SHALL HAVE JUTE NETTING OR EQUIVALENT SLOPE STABILIZATION MATERIAL APPLIED ON TOP OF ANY APPLIED MULCH.
- 7. ALL PLANT MATERIAL, COLOR, SIZE AND QUANTITIES ARE TO BE VERIFIED WITH OWNER.





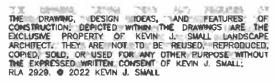

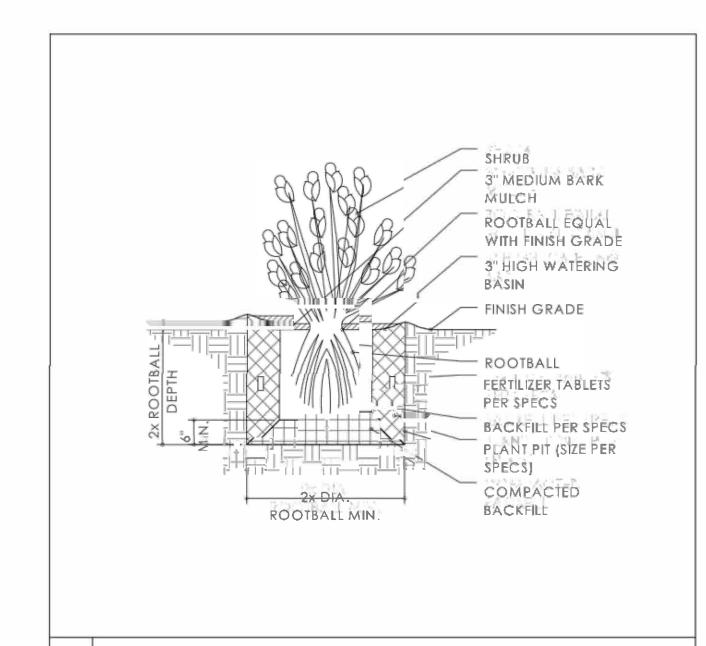

A SHRUB PLANTING

| Ĝ<br>BETAN   |
|--|
| DETAIL   |
| Verizon Wireless   |
| Verizon Wireless<br>Mitchell Drive, Blag. 9<br>eek, California 94598 |
|  |

L=2.1