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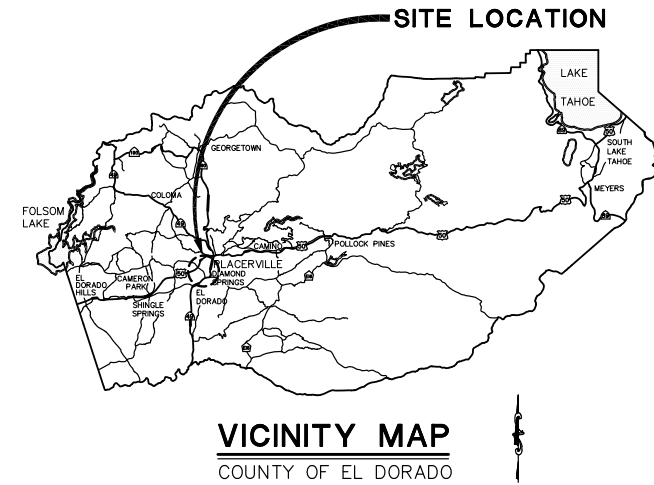
SHEET	PLAN SHEET	TITLE
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COUNTY OF EL DORADO, CA DEPARTMENT OF TRANSPORTATION

PROJECT PLANS FOR THE CONSTRUCTION OF EL DORADO TRAIL – MISSOURI FLAT ROAD BIKE/PEDESTRIAN OVERCROSSING PHASE 2

IN THE COUNTY OF EL DORADO, DISTRICT III

To be supplemented with Standard Plans and Specifications dated 2022, including the 2022 Revised Standard Specifications, of the California Department of Transportation, unless otherwise noted.



BOARD OF SUPERVISORS

I JOHN HIDAHL
II GEORGE TURNBOO
III WENDY THOMAS
IV LORI PARLIN
V BROOKE LAINE

**COUNTY OF EL DORADO
DEPARTMENT OF TRANSPORTATION**

(530) 621-5900
2850 FAIRLANE CT
PLACERVILLE, CA 95667

ADOPTED AND APPROVED BY:

WENDY THOMAS
CHAIR, EL DORADO COUNTY BOARD OF SUPERVISORS

APPROVED BY:

RAFAEL MARTINEZ, DIRECTOR
DEPARTMENT OF TRANSPORTATION

MATTHEW D. SMELTZER
DEPUTY DIRECTOR, ENGINEERING

CONTRACT NO. 8144 PROJECT NO. 97015

**EL DORADO TRAIL-
MISSOURI FLAT ROAD
BIKE/PEDESTRIAN OVERCROSSING
PHASE 2
TITLE SHEET**

SHEET **1** OF **42**



CONTRACTOR'S LICENSE CLASSIFICATION: Bidders shall be properly licensed to perform the Work pursuant to the State Contractor's License Act (Business and Professions Code section 7000 et seq.) and shall possess a CLASS A LICENSE or equivalent combination of Classes required by the categories and type of Work included in the Contract Documents and Plans. Failure of the successful Bidder to obtain proper and adequate licensing at the time bids are submitted shall constitute a failure to execute the Contract, and forfeiture as provided under that section.

REVISIONS		
MARK	DATE	BY




**FEDERAL AID PROJECT
CML 5925 (132)**



Dustin W. Harrington
SUBMITTED BY:
DUSTIN W. HARRINGTON
REGISTERED CIVIL ENGINEER No. 71517

4/9/2024
DATE

ORIGINAL SCALE IS IN INCHES
 Drawing name: Z:\Civil_3D_Projects\97015 El Dorado POC\CADD Files\Sheets\CD Sheets.dwg Layout Tab: CD-1 Jan 19, 2024 - 8:06pm Dharrington
 FOR REDUCED PLANS
 REVISION
 NUMBER DATE DESCRIPTION BY

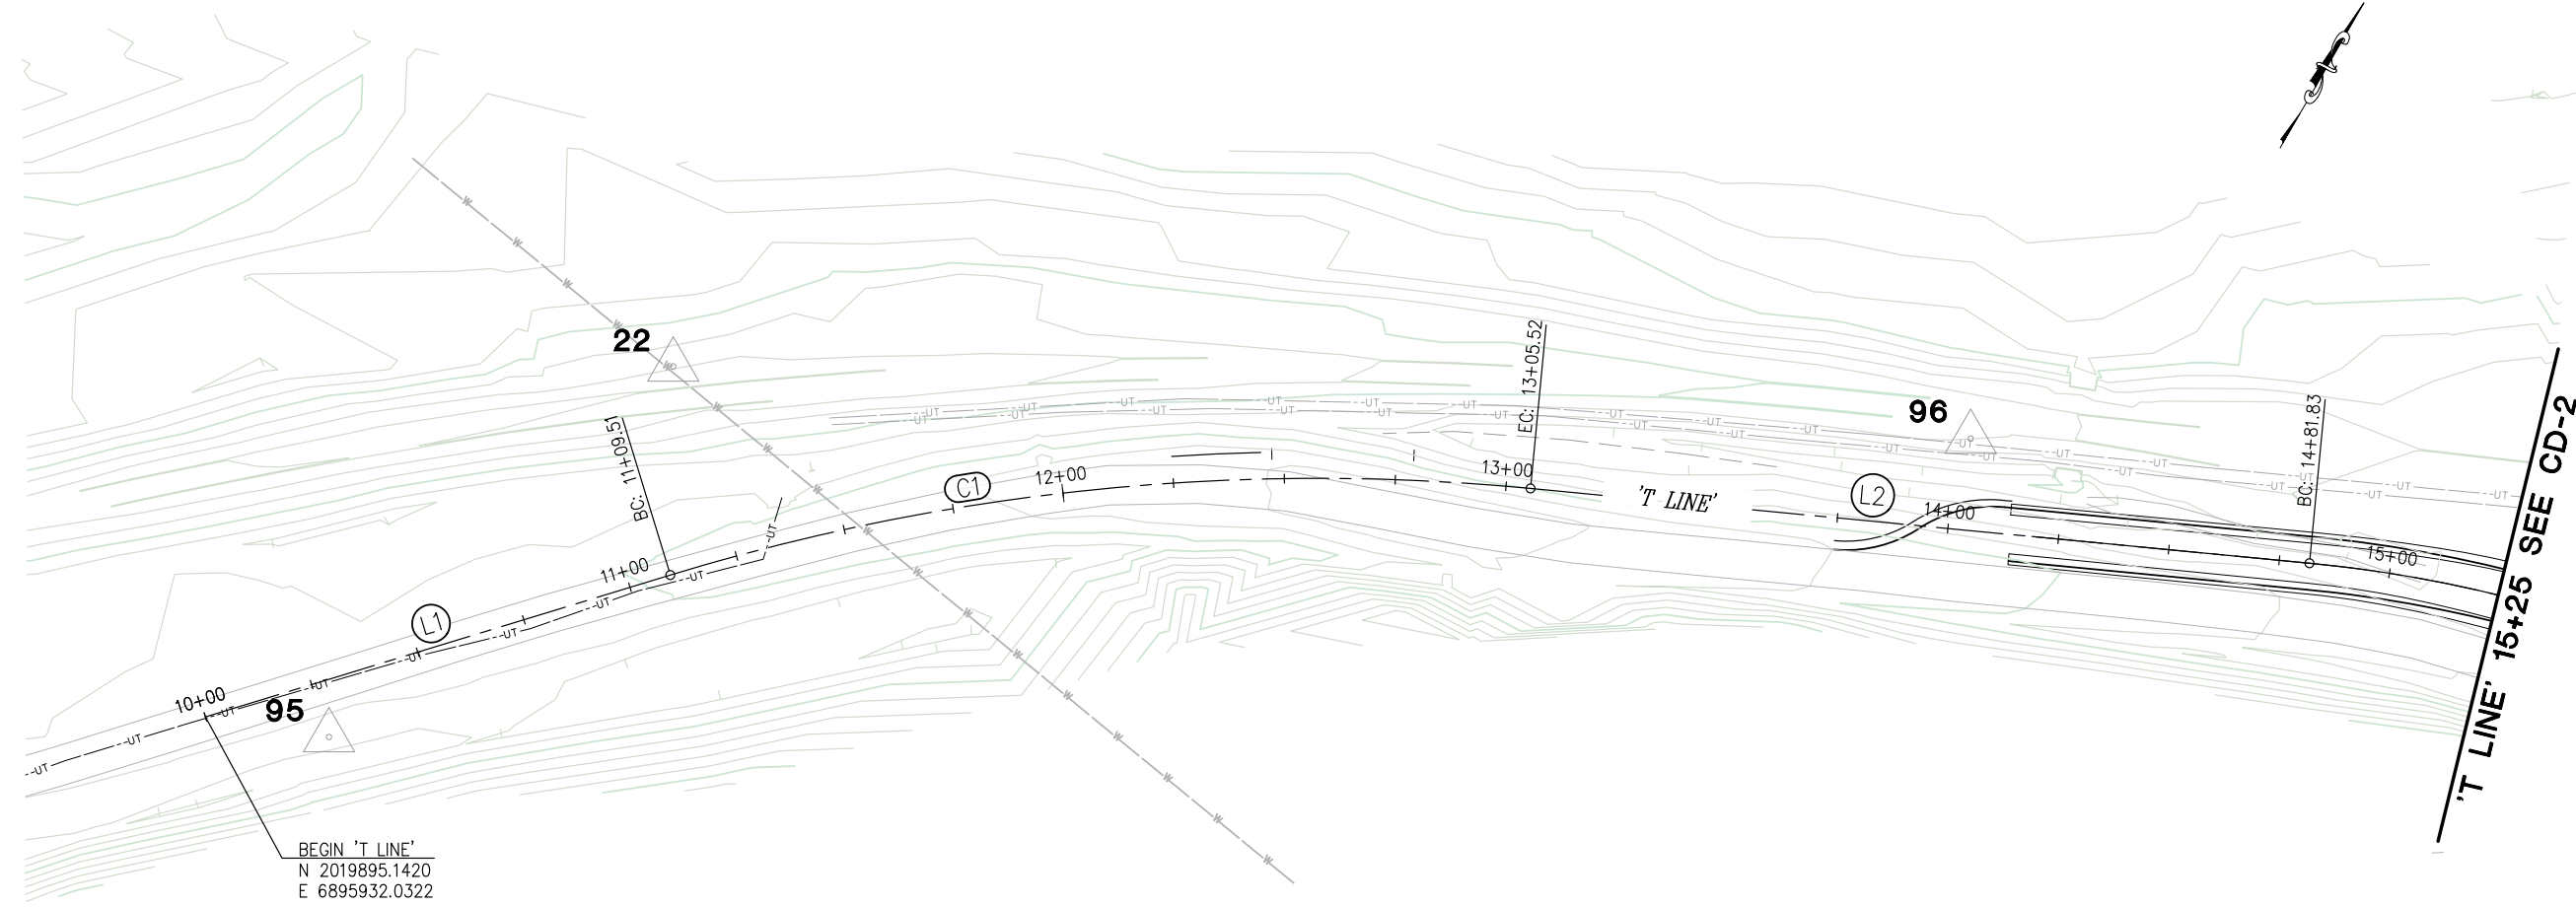

LEGEND:

X DENOTES CONTROL POINT AND NUMBER.

T LINE				
NUMBER	LENGTH	RADIUS	LINE / CHORD DIRECTION & LENGTH	DELTA
L1	109.51		N 43° 01' 09" E	
C1	196.01	500.00	N 54° 14' 59" E - 194.76	22° 27' 40"
L2	176.31		N 65° 28' 49" E	

SURVEY CONTROL DIAGRAM
SCALE : 1" = 20'

NUMBER	DATE	DESCRIPTION	BY



PREPARED UNDER THE SUPERVISION OF :

 REGISTERED CIVIL ENGINEER
 DATE: 1/23/2024

DESIGNED: AN
 DRAWN: AN
 CHECKED: DH
 DATE: 4/30/2021
 ROAD NUMBER: --



COUNTY OF EL DORADO
 DEPARTMENT OF TRANSPORTATION

EL DORADO TRAIL-
 MISSOURI FLAT ROAD
 BIKE/PEDESTRIAN OVERCROSSING
 PHASE 2

SHEET
 CD-1
 2 OF 42
 W.O. No. 97015


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'T LINE' 15+25 SEE CD-1

'T LINE' 20+75 SEE BELOW

SW				
NUMBER	LENGTH	RADIUS	LINE / CHORD DIRECTION & LENGTH	DELTA
L6	16.02		S 56° 06' 01" E	
C5	48.78	49.00	S 88° 26' 45" E - 46.79	57° 02' 13"
L7	6.38		N 63° 02' 08" E	
C6	12.06	41.00	N 71° 27' 56" E - 12.02	16° 51' 35"
L8	4.33		N 79° 56' 24" E	
C7	15.17	100.00	N 84° 17' 13" E - 15.16	8° 41' 39"
L9	16.67		N 88° 38' 03" E	
C8	18.04	300.00	N 86° 54' 41" E - 18.04	3° 26' 44"
L10	8.55		N 85° 11' 18" E	
C9	40.81	281.34	N 89° 18' 52" E - 40.78	8° 18' 43"
L11	126.15		S 85° 59' 05" E	
C10	173.71	627.50	S 77° 55' 25" E - 173.16	15° 51' 42"
C11	8.94	15.00	S 87° 03' 48" E - 8.81	34° 08' 28"
C12	28.86	45.00	S 85° 45' 32" E - 28.37	36° 44' 59"
L12	10.90		S 67° 23' 03" E	

T LINE				
NUMBER	LENGTH	RADIUS	LINE / CHORD DIRECTION & LENGTH	DELTA
C2	106.82	300.00	N 75° 40' 53" E - 106.25	20° 24' 01"
L3	394.06		N 85° 52' 53" E	
C3	42.55	295.00	S 89° 59' 11" E - 42.51	8° 15' 51"
L4	126.19		S 85° 51' 15" E	
C4	265.93	639.00	S 73° 55' 56" E - 264.01	23° 50' 39"
L5	107.62		S 62° 00' 36" E	

LEGEND:
 X  DENOTES CONTROL POINT AND NUMBER.


'T LINE' 20+75 SEE ABOVE

END 'T LINE'
 N 2020086.5487
 E 6897333.5849

SURVEY CONTROL DIAGRAM
 SCALE : 1" = 20'

REVISION	NUMBER	DATE	DESCRIPTION	BY



PREPARED UNDER THE SUPERVISION OF:

 REGISTERED CIVIL ENGINEER
 DATE: 1/23/2024

DESIGNED: AN
 DRAWN: AN
 CHECKED: DH
 DATE: 4/30/2021
 ROAD NUMBER: --




COUNTY OF EL DORADO
DEPARTMENT OF TRANSPORTATION


EL DORADO TRAIL-
MISSOURI FLAT ROAD
BIKE/PEDESTRIAN OVERCROSSING
PHASE 2

SHEET
CD-2
 3 OF 42
 W.O. No. **97015**


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 FOR REDUCED PLANS
 REVISION
 NUMBER DATE DESCRIPTION BY

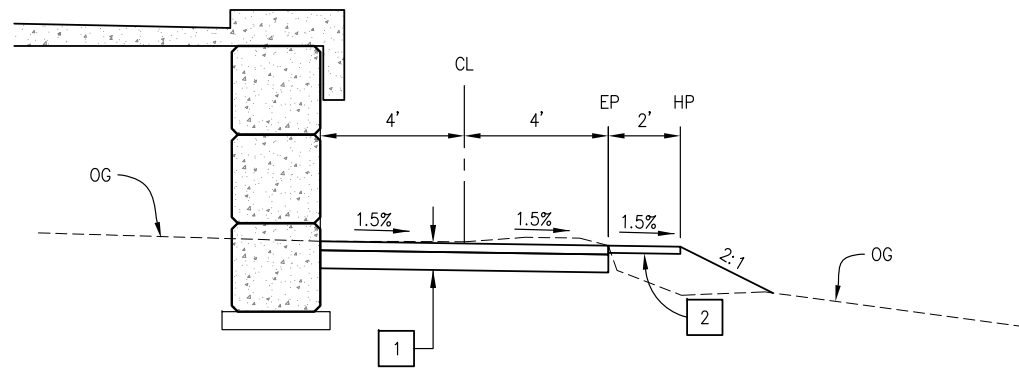


'SW' 10+96.22 TO 15+15.83

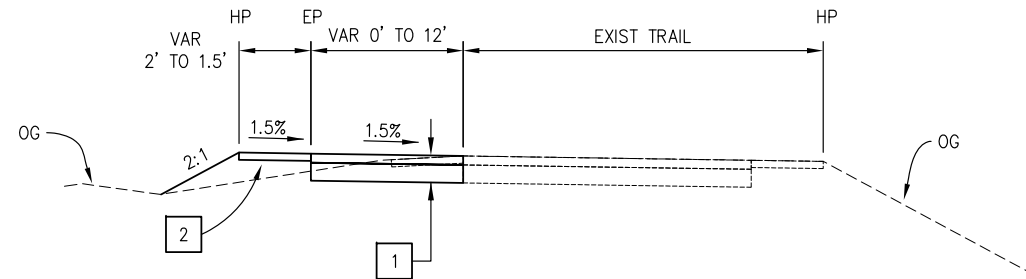

'T' 13+74.87 TO 14+14.25

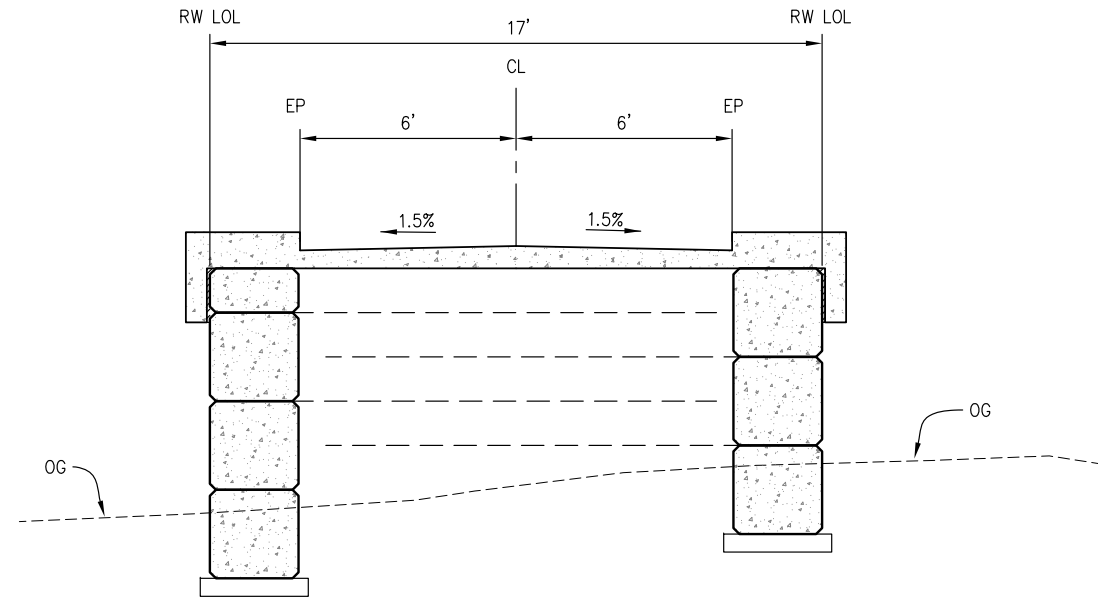

'T' 14+14.25 TO 15+91.21
'T' 19+65.62 TO 23+26.51

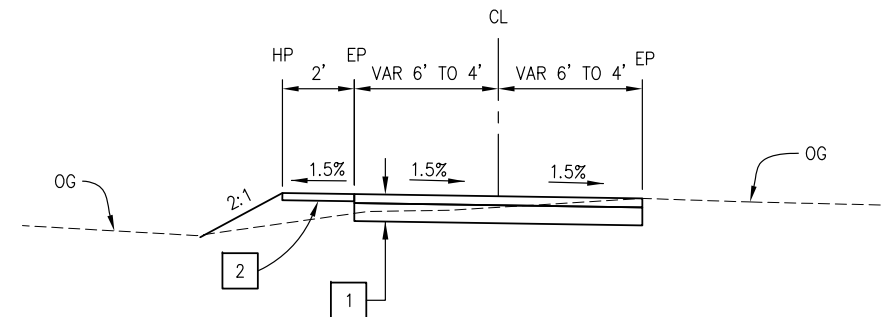

'T' 23+27.77 TO 23+55

CONSTRUCTION NOTES:

- 1 — 0.25' HMA (TYPE A)
0.50' AB (CLASS 2)
- 2 — 0.20' AB (CLASS 2) SHOULDER BACKING

TYPICAL SECTIONS
SCALE : NONE

NUMBER	DATE	DESCRIPTION	BY



PREPARED UNDER THE SUPERVISION OF:

 REGISTERED CIVIL ENGINEER
 DATE: 4/9/2024

DESIGNED: AN
 DRAWN: AN
 CHECKED: DH
 DATE: 3/5/2024
 ROAD NUMBER: --




COUNTY OF EL DORADO
 DEPARTMENT OF TRANSPORTATION

EL DORADO TRAIL-
 MISSOURI FLAT ROAD
 BIKE/PEDESTRIAN OVERCROSSING
 PHASE 2

SHEET
 X-1
 4 OF 42
 W.O. No. 97015


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- LEGEND:**
- OBLITERATE EXIST ASPHALT SURFACING
 - EXIST PAVED TRAIL (PROTECT IN PLACE)

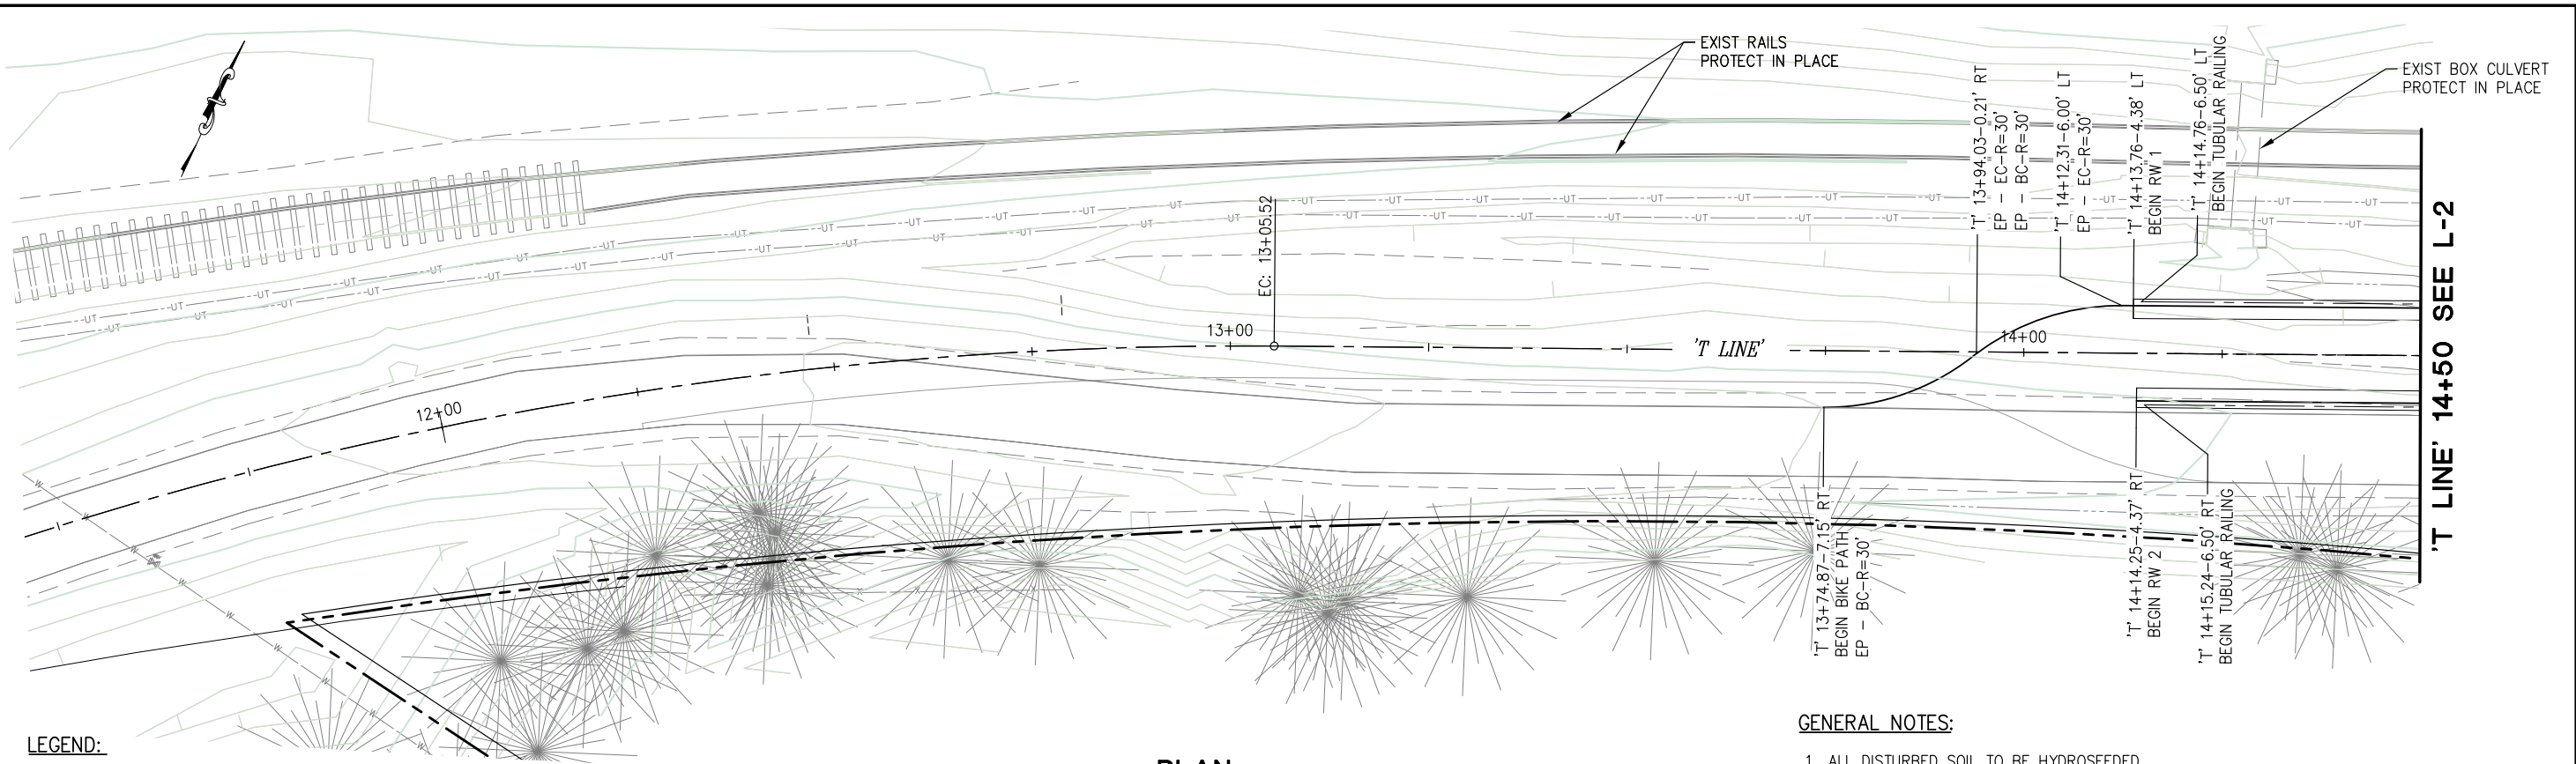- GENERAL NOTES:**
1. ALL DISTURBED SOIL TO BE HYDROSEEDDED.
 2. SEE SPD-SHEETS FOR SIGNING AND STRIPING PLANS.
 3. SEE S-SHEETS FOR STRUCTURE PLANS.

PLAN



PROFILE

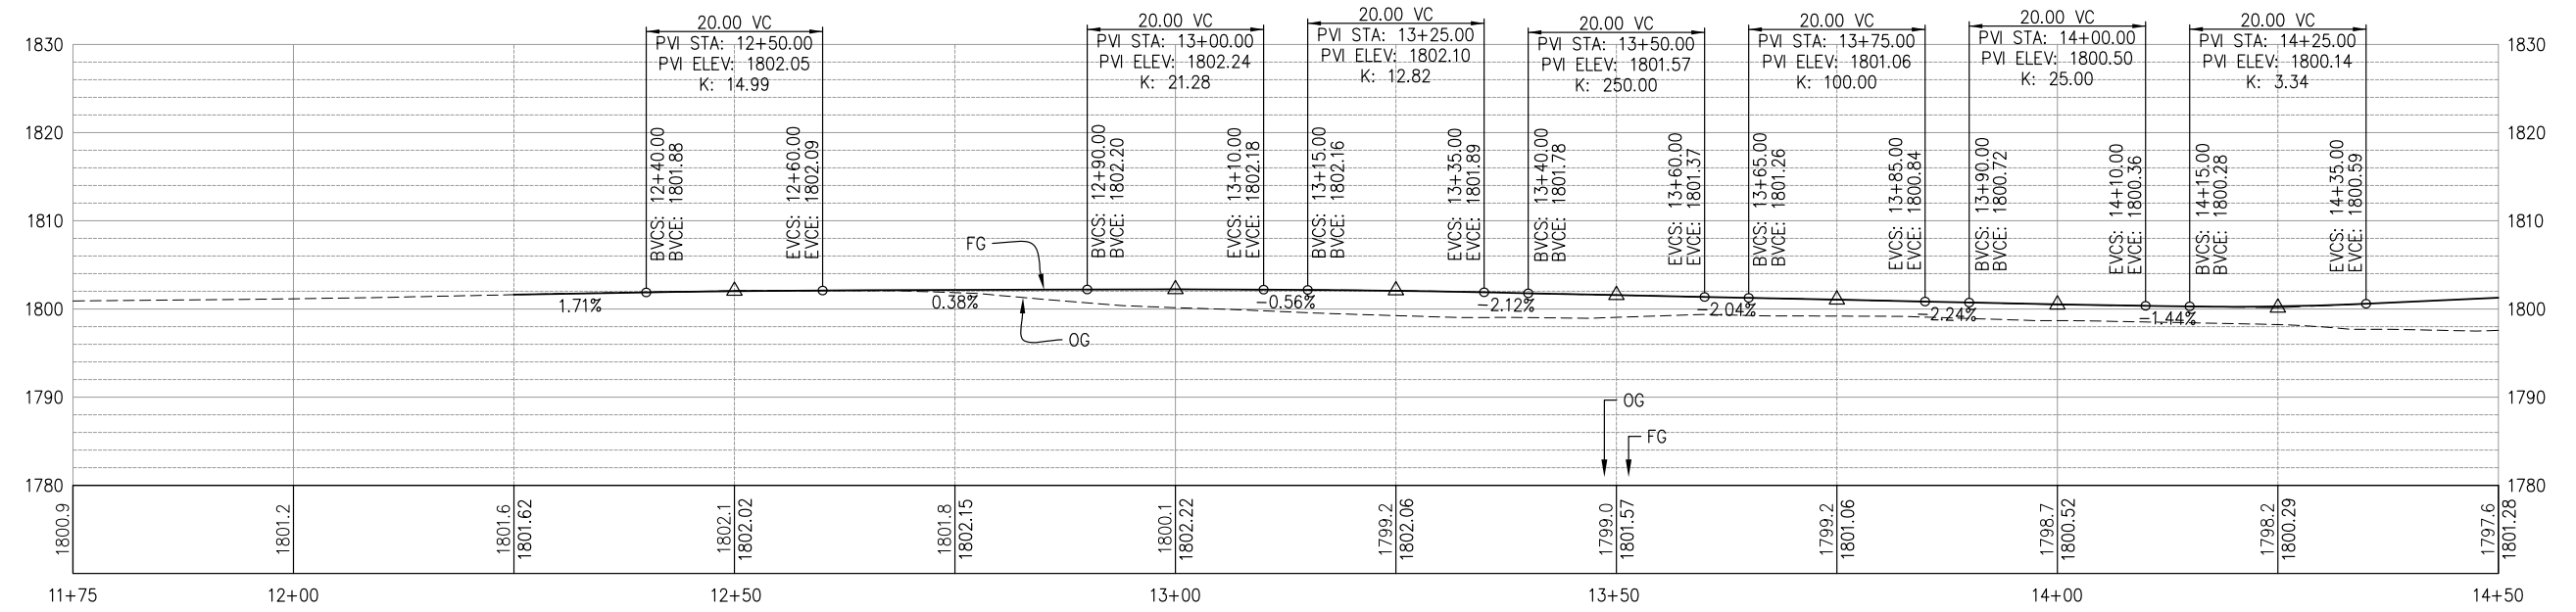LAYOUT PLAN AND PROFILE
SCALE : 1" = 10'

REVISION	NUMBER	DATE	DESCRIPTION	BY



PREPARED UNDER THE SUPERVISION OF:

 REGISTERED CIVIL ENGINEER
 DATE: 4/9/2024

DESIGNED: AN
 DRAWN: AN
 CHECKED: DH
 DATE: 3/5/2024
 ROAD NUMBER: --




COUNTY OF EL DORADO
 DEPARTMENT OF TRANSPORTATION

EL DORADO TRAIL-
 MISSOURI FLAT ROAD
 BIKE/PEDESTRIAN OVERCROSSING
 PHASE 2

SHEET
L-1
 5 OF 42
 W.O. No. **97015**

ORIGINAL SCALE IS IN INCHES
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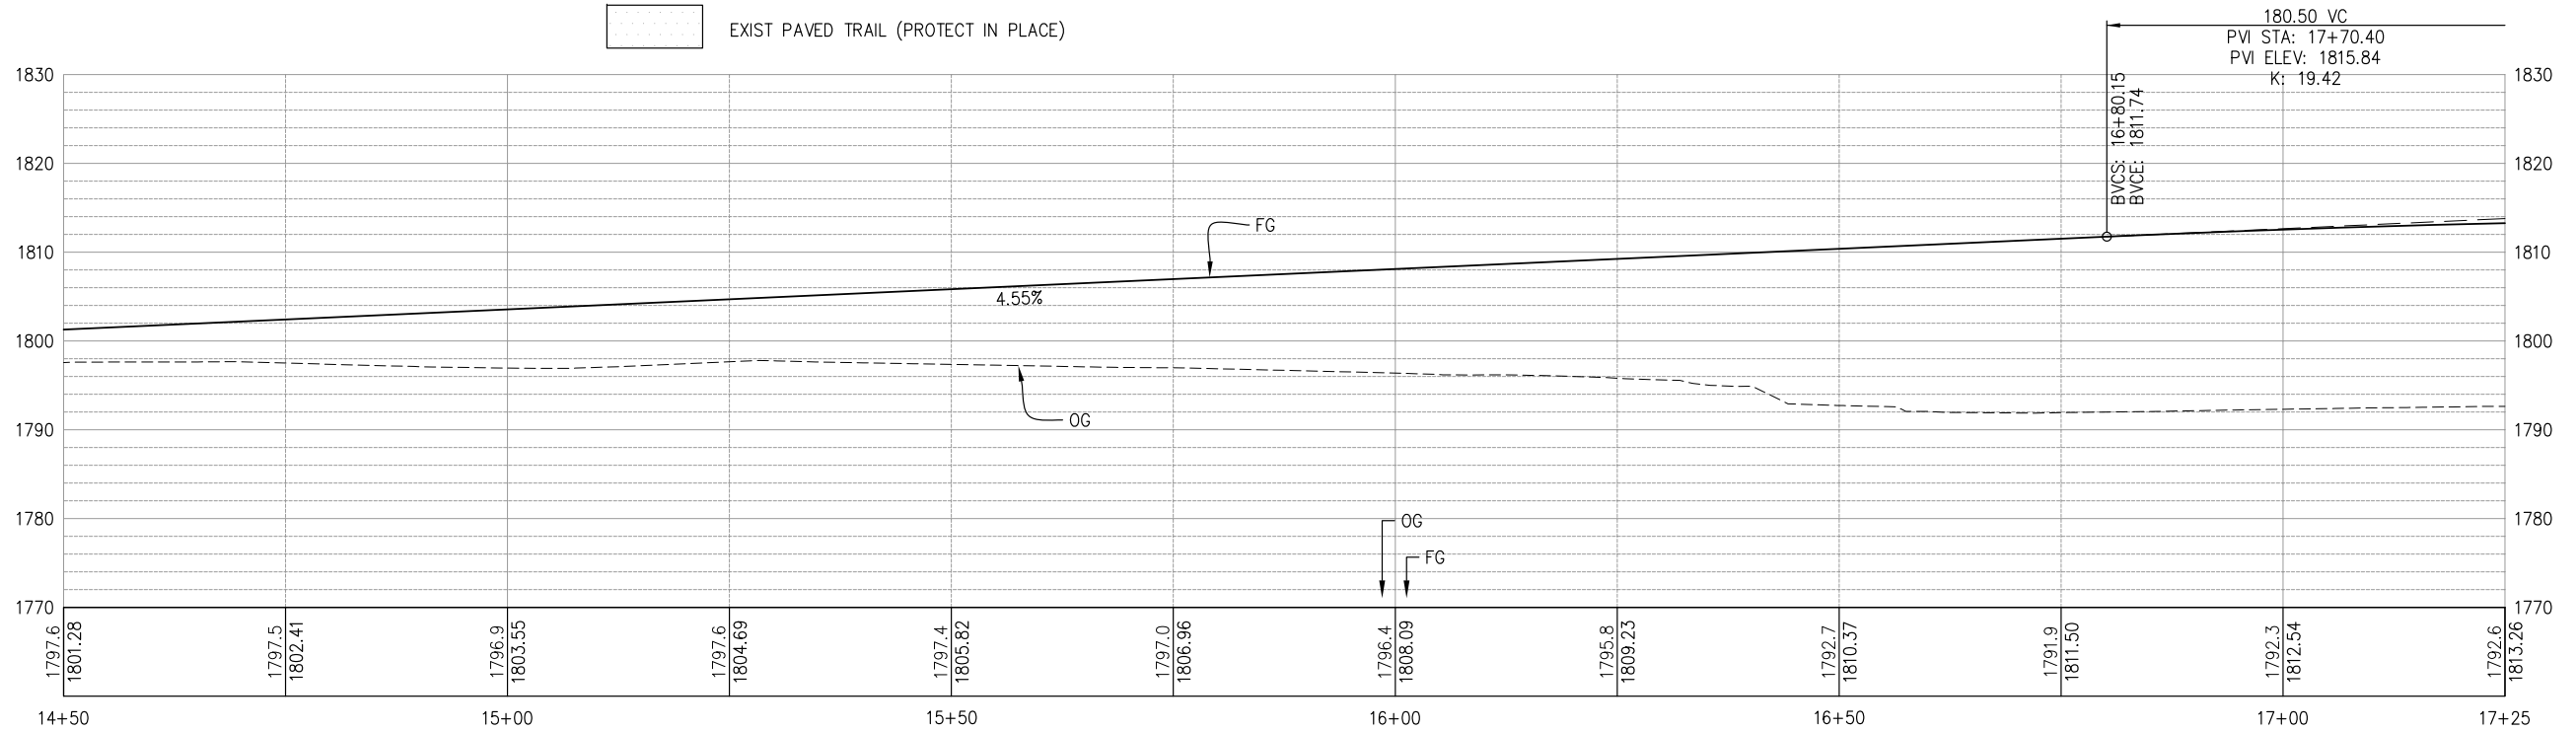


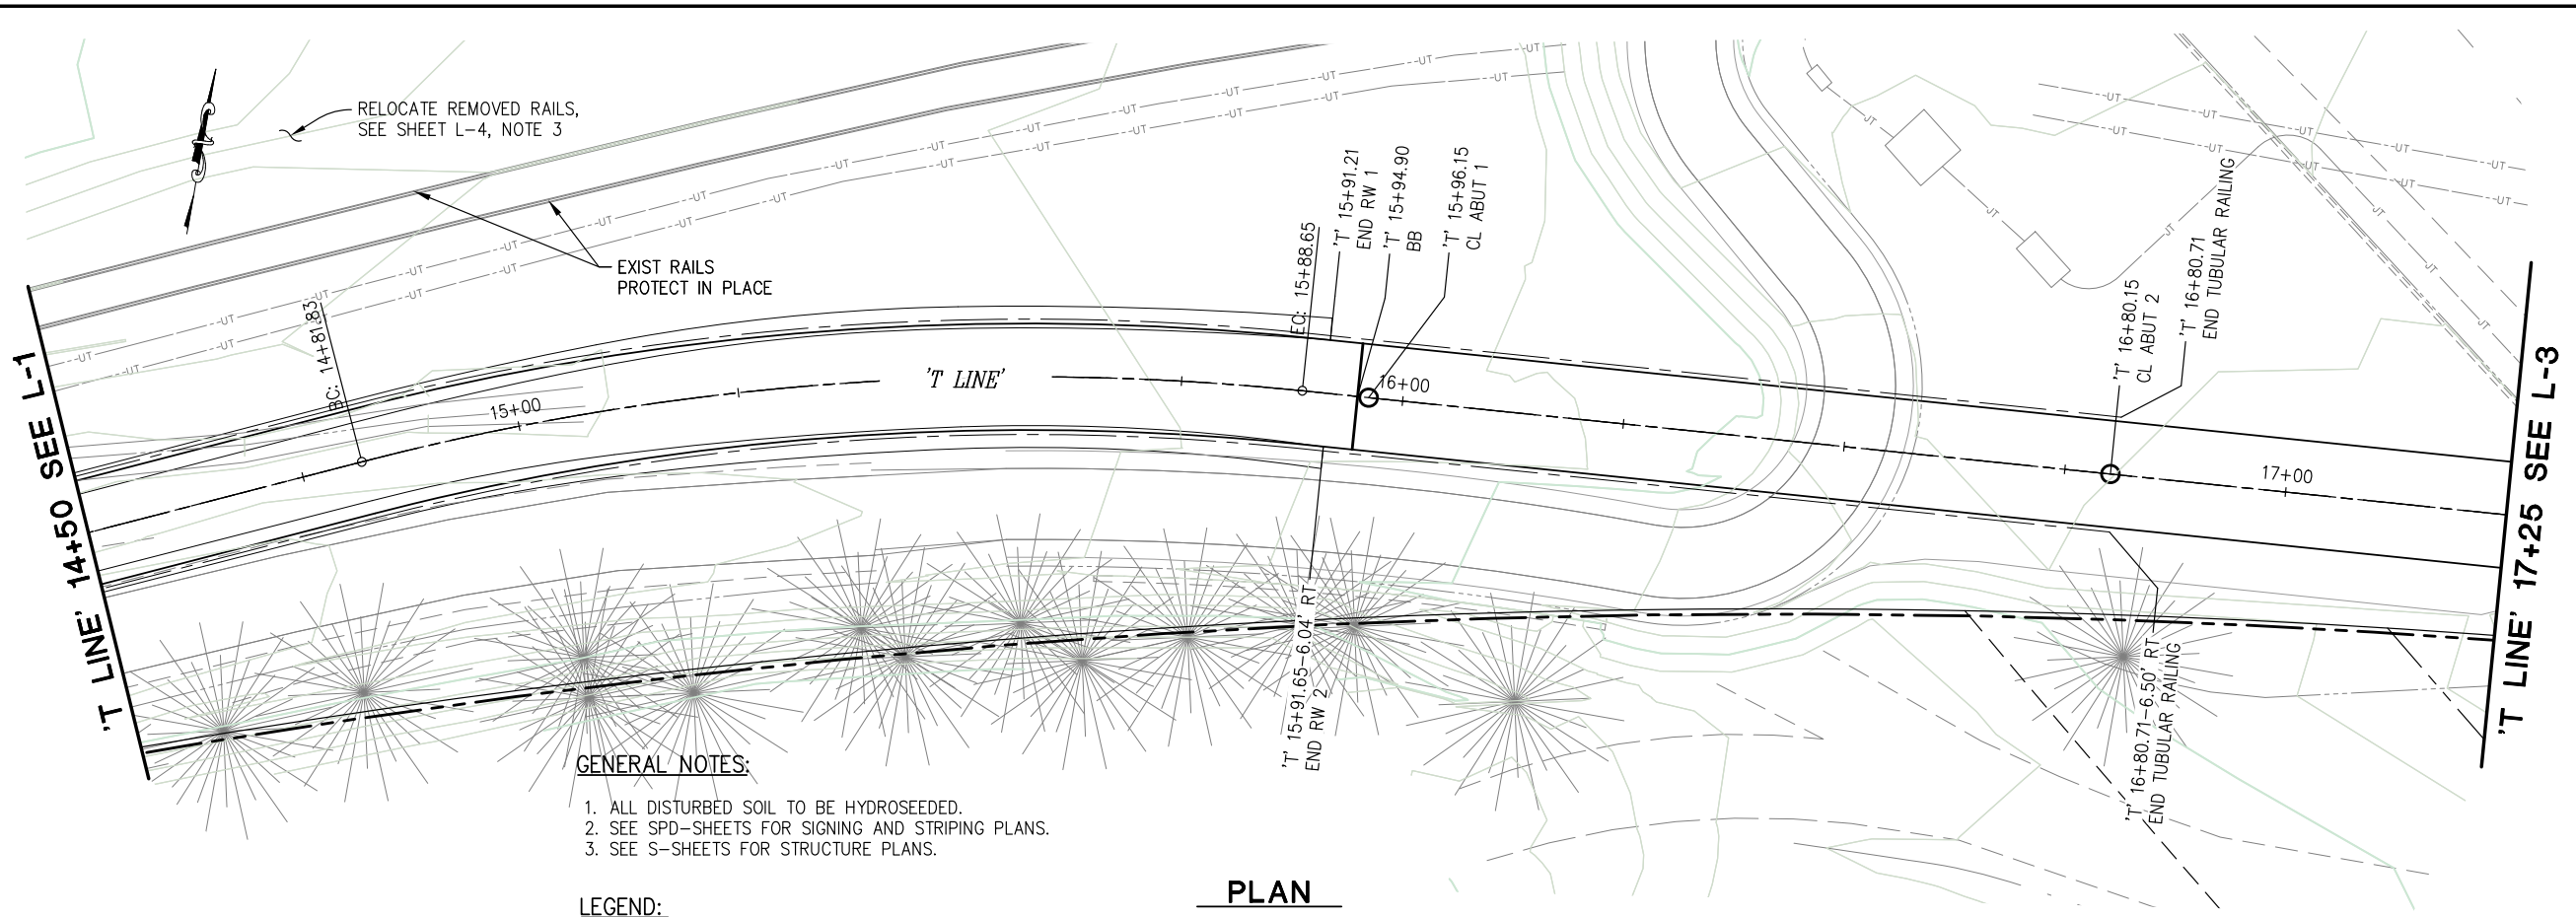- GENERAL NOTES:**
1. ALL DISTURBED SOIL TO BE HYDROSEEDDED.
 2. SEE SPD-SHEETS FOR SIGNING AND STRIPING PLANS.
 3. SEE S-SHEETS FOR STRUCTURE PLANS.

LEGEND:

EXIST PAVED TRAIL (PROTECT IN PLACE)

PLAN



PROFILE

LAYOUT PLAN AND PROFILE
SCALE: 1" = 10'

REVISION	NUMBER	DATE	DESCRIPTION	BY



PREPARED UNDER THE SUPERVISION OF:

 REGISTERED CIVIL ENGINEER
 DATE: 4/9/2024

DESIGNED: AN
 DRAWN: AN
 CHECKED: DH
 DATE: 3/5/2024
 ROAD NUMBER: --



COUNTY OF EL DORADO
DEPARTMENT OF TRANSPORTATION

EL DORADO TRAIL-
MISSOURI FLAT ROAD
BKE/PEDESTRIAN OVERCROSSING
PHASE 2

SHEET
L-2
6 OF 42
W.O. No. 97015

ORIGINAL SCALE IS IN INCHES
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GENERAL NOTES:




1. ALL DISTURBED SOIL TO BE HYDROSEEDED.
2. SEE SPD-SHEETS FOR SIGNING AND STRIPING PLANS.
3. SEE S-SHEETS FOR STRUCTURE PLANS.
4. REMOVE & SALVAGE EXIST PCC WHEEL STOPS AND ADA PARKING SIGNS w/ POSTS AT PARKING AREA.

LEGEND:

- LIMITS OF OBLITERATE EXIST ASPHALT SURFACING & ADJACENT CURB WHERE OCCURS (APPROX 9,545 SF TOTAL). REGRADE AREA TO MATCH ADJACENT SIDEWALK, HMA DIKE, AND PCC CURB AS APPLICABLE.
- EXIST SIDEWALK (PROTECT IN PLACE)

CONSTRUCTION NOTES:

- 1 — MAINTAIN ACCESS TO SIERRA DOOR & SUPPLY PARKING AREA.
- 2 — REMOVE & SALVAGE EXIST CONCRETE SPLIT RAIL FENCE (APPROX 150 LF TOTAL).
- 3 — PROTECT EXIST OAK TREE IN PLACE.
- 4 — REMOVE & SALVAGE PARKING LOT WHEEL STOPS.
- 5 — 46 LF CURB (TYPE A1-6)
- 6 — REMOVE EXISTING CURB AT JOINT
- 7 — EXISTING SPLIT RAIL FENCE (PROTECT IN PLACE)
- 8 — EXISTING PCC OSD (PROTECT IN PLACE)

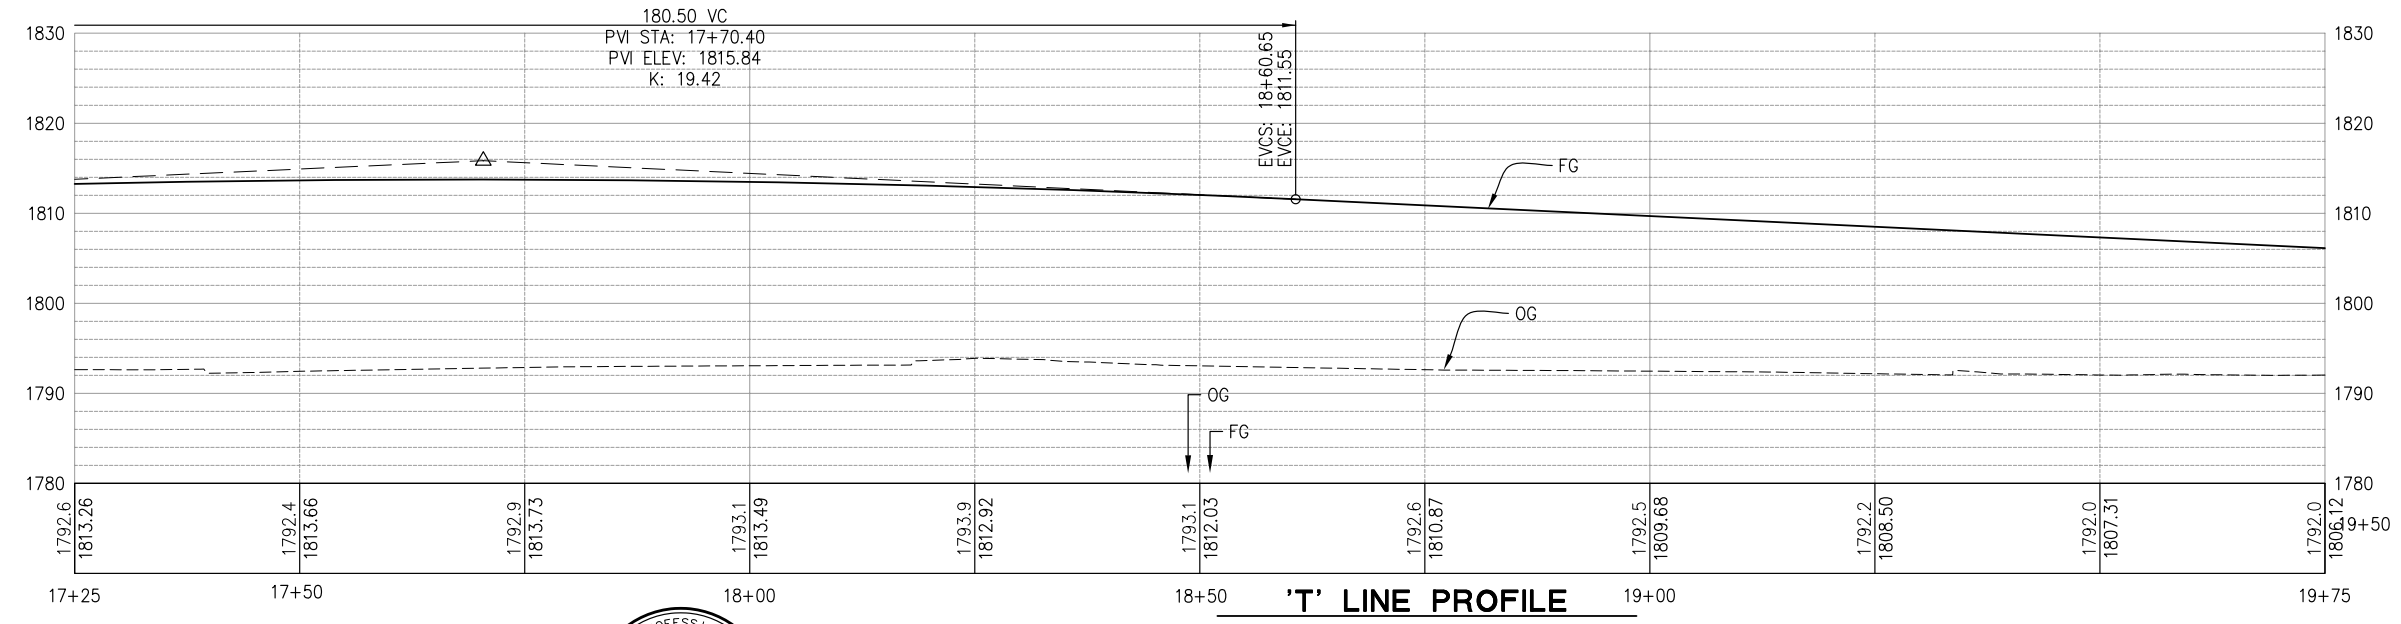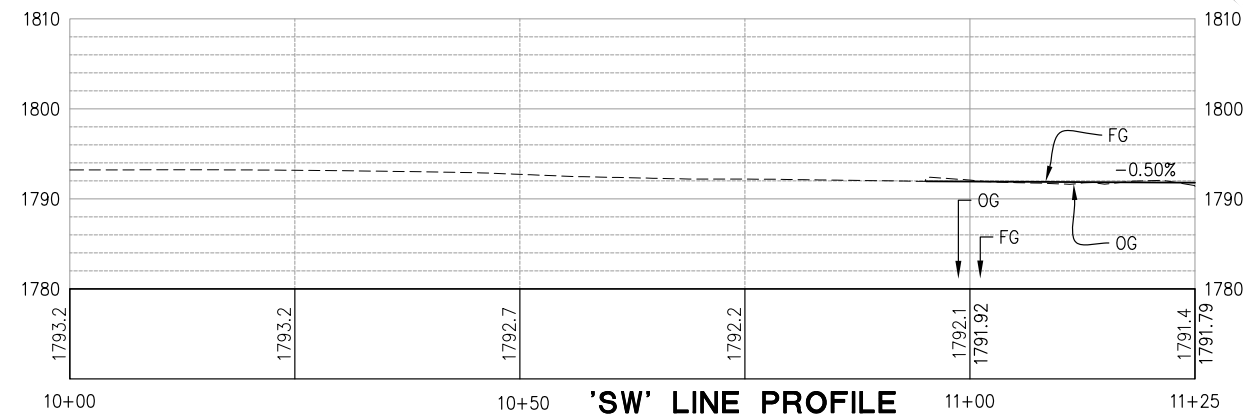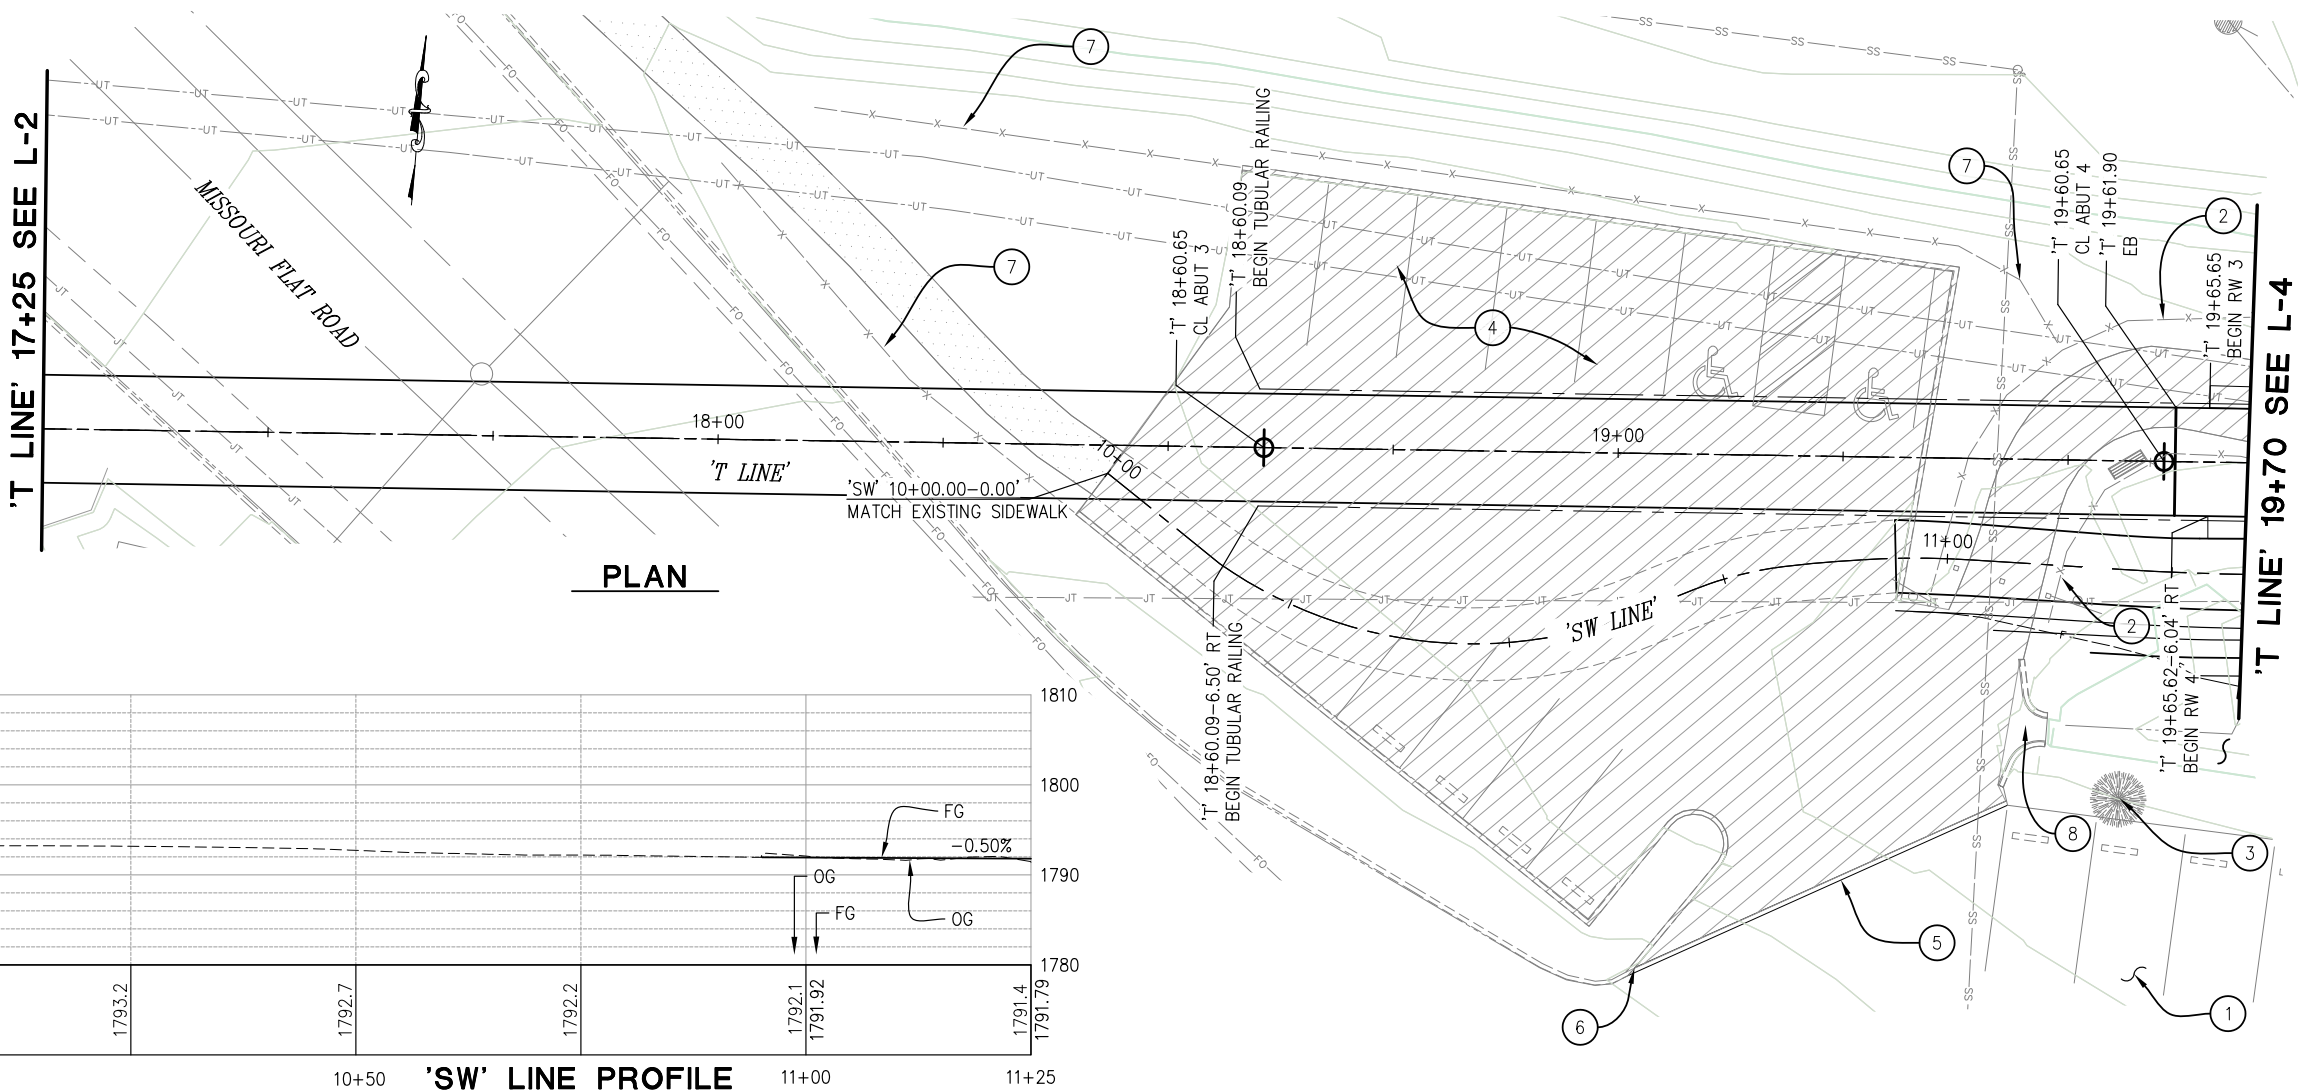

LAYOUT PLAN AND PROFILE
SCALE: 1" = 10'

REVISION	NUMBER	DATE	DESCRIPTION	BY



PREPARED UNDER THE SUPERVISION OF:

 REGISTERED CIVIL ENGINEER
 DATE: 4/9/2024

DESIGNED: AN
 DRAWN: AN
 CHECKED: DH
 DATE: 3/5/2024
 ROAD NUMBER: --




COUNTY OF EL DORADO
 DEPARTMENT OF TRANSPORTATION

EL DORADO TRAIL-
 MISSOURI FLAT ROAD
 BIKE/PEDESTRIAN OVERCROSSING
 PHASE 2

SHEET
L-3
 7 OF 42
 W.O. No. **97015**

ORIGINAL SCALE IS IN INCHES
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LEGEND:




 LIMITS OF OBLITERATE EXIST ASPHALT SURFACING

CONSTRUCTION NOTES:

- ① — EXISTING VINYL SPLIT RAIL FENCE (PROTECT IN PLACE)
- ② — REMOVE & SALVAGE EXIST RAILS TO AREA ON WEST SIDE OF MISSOURI FLAT ROAD, SEE SHEET L-2. DISPOSE OF RAIL TIES AS TREATED WOOD WASTE.
- ③ — REMOVE & SALVAGE EXIST CONCRETE SPLIT RAIL FENCE (APPROX 150 LF TOTAL).
- ④ — REMOVE TIMBER CULVERT & REPLACE WITH 24" RCP, SEE SHEET D-1
- ⑤ — REMOVE & RELOCATE EXIST KIOSK AS DIRECTED BY THE ENGINEER.
- ⑥ — REMOVE & RELOCATE EXIST GARBAGE/RECYCLE RECEPTACLES AS DIRECTED BY THE ENGINEER.

GENERAL NOTES:

- 1. ALL DISTURBED SOIL TO BE HYDROSEEDDED.
- 2. SEE SPD-SHEETS FOR SIGNING AND STRIPING PLANS.
- 3. SEE S-SHEETS FOR STRUCTURE PLANS.

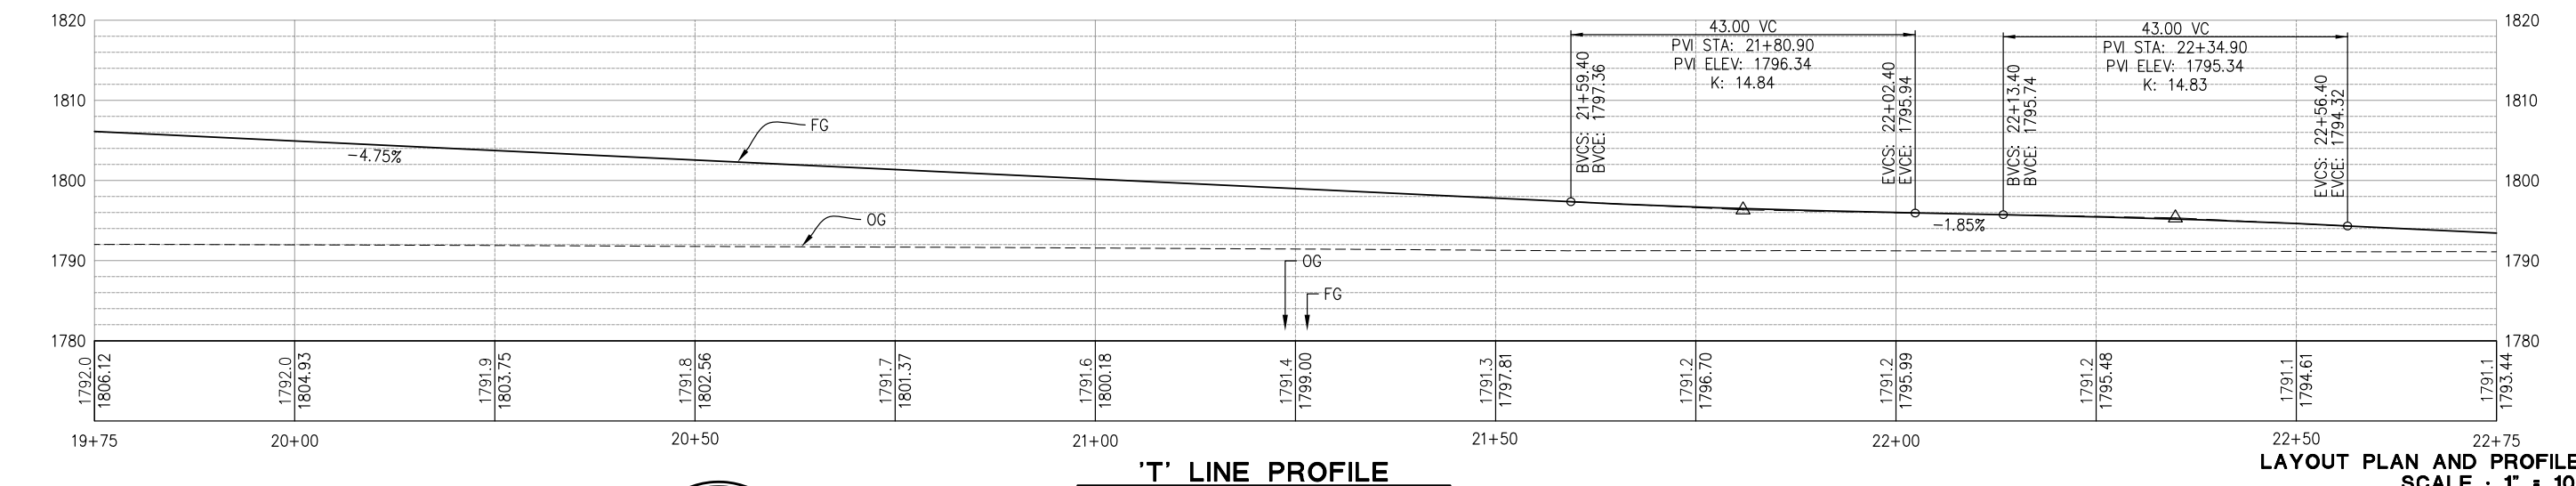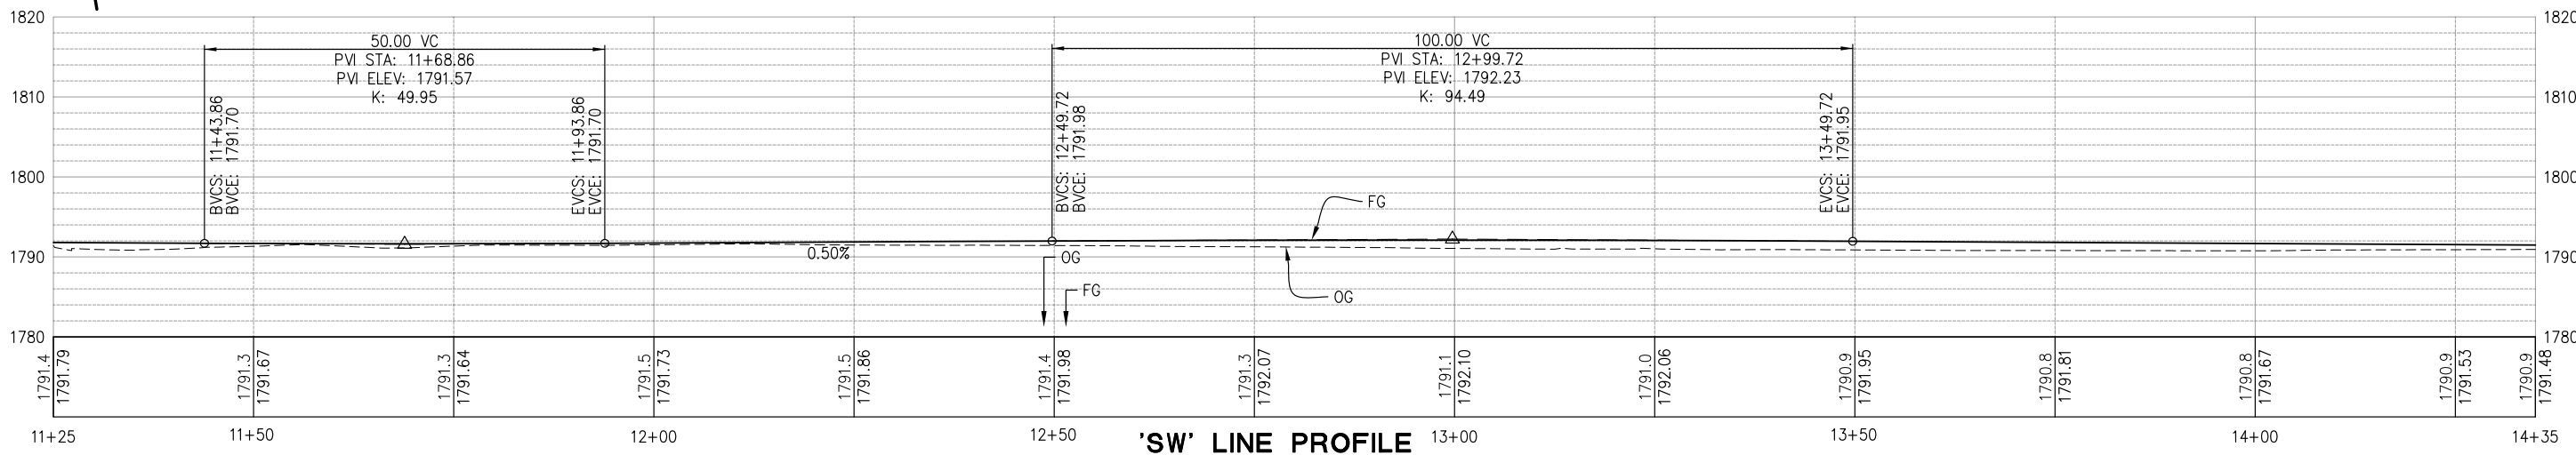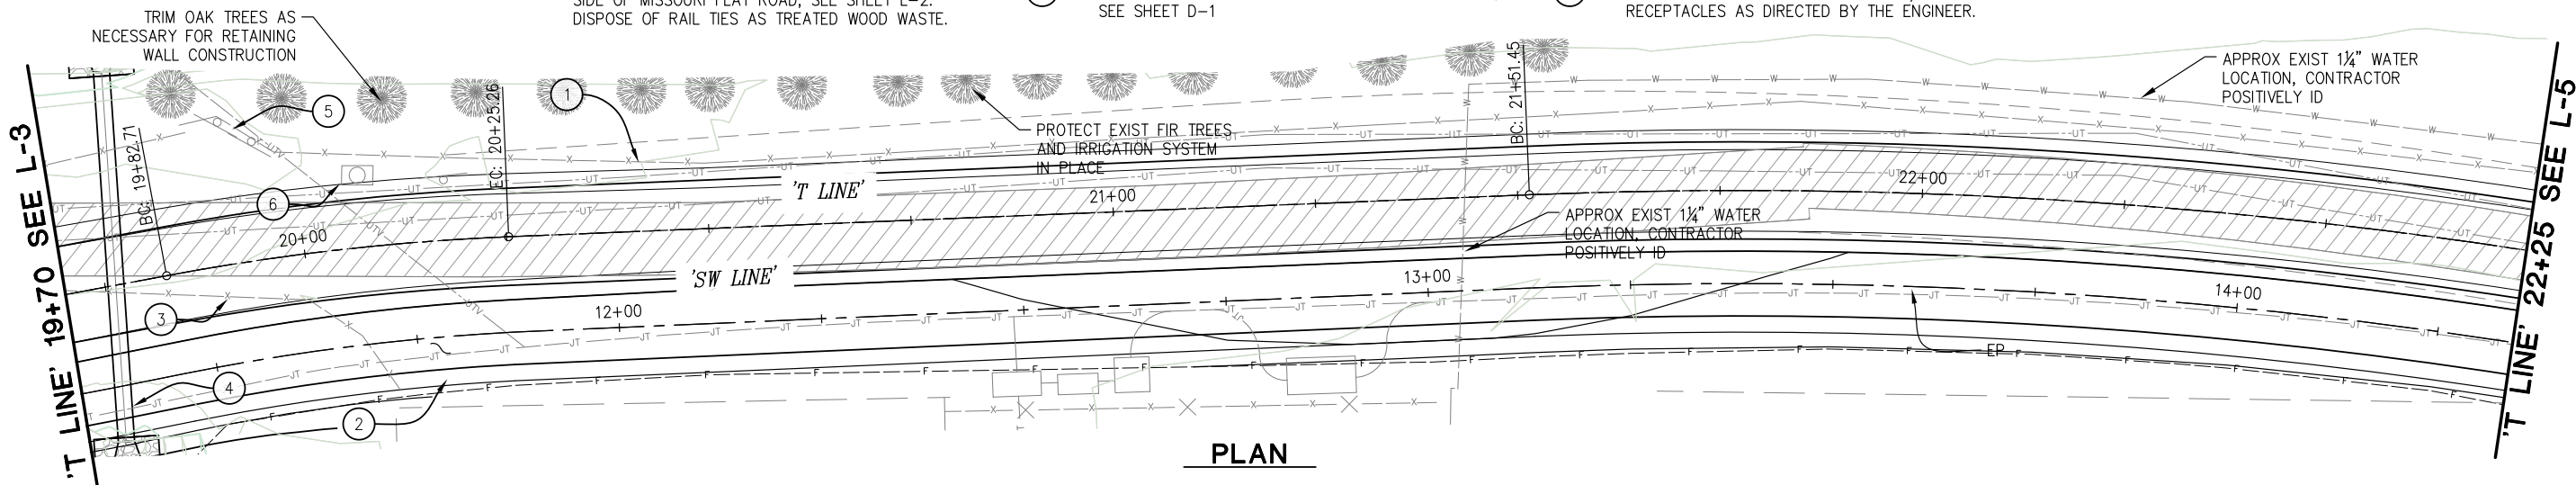


LAYOUT PLAN AND PROFILE
SCALE: 1" = 10'

FOR REDUCED PLANS

REVISION	NUMBER	DATE	DESCRIPTION	BY

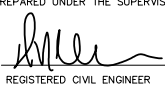

PREPARED UNDER THE SUPERVISION OF:

 REGISTERED CIVIL ENGINEER
 DATE: 1/23/2024

DESIGNED: AN
 DRAWN: AN
 CHECKED: DH
 DATE: 10/5/2023
 ROAD NUMBER: --



COUNTY OF EL DORADO
DEPARTMENT OF TRANSPORTATION

EL DORADO TRAIL-
MISSOURI FLAT ROAD
BIKE/PEDESTRIAN OVERCROSSING
PHASE 2

SHEET
L-4
8 OF 42
W.O. No. 97015

ORIGINAL SCALE IS IN INCHES
 Drawing name: Z:\Civil_3D_Projects\97015 El Dorado POC\CADD Files\Sheets\L_Sheets.dwg Layout Tab: L-5 Mar 25, 2024 - 1:49pm Dharrington


'T LINE' 22+75 SEE L-4

CONSTRUCTION NOTES:

- ① — EXIST VINYL SPLIT RAIL FENCE (PROTECT IN PLACE)

GENERAL NOTES:


1. ALL DISTURBED SOIL TO BE HYDROSEEDED.
2. SEE SPD-SHEETS FOR SIGNING AND STRIPING PLANS.
3. SEE S-SHEETS FOR STRUCTURE PLANS.

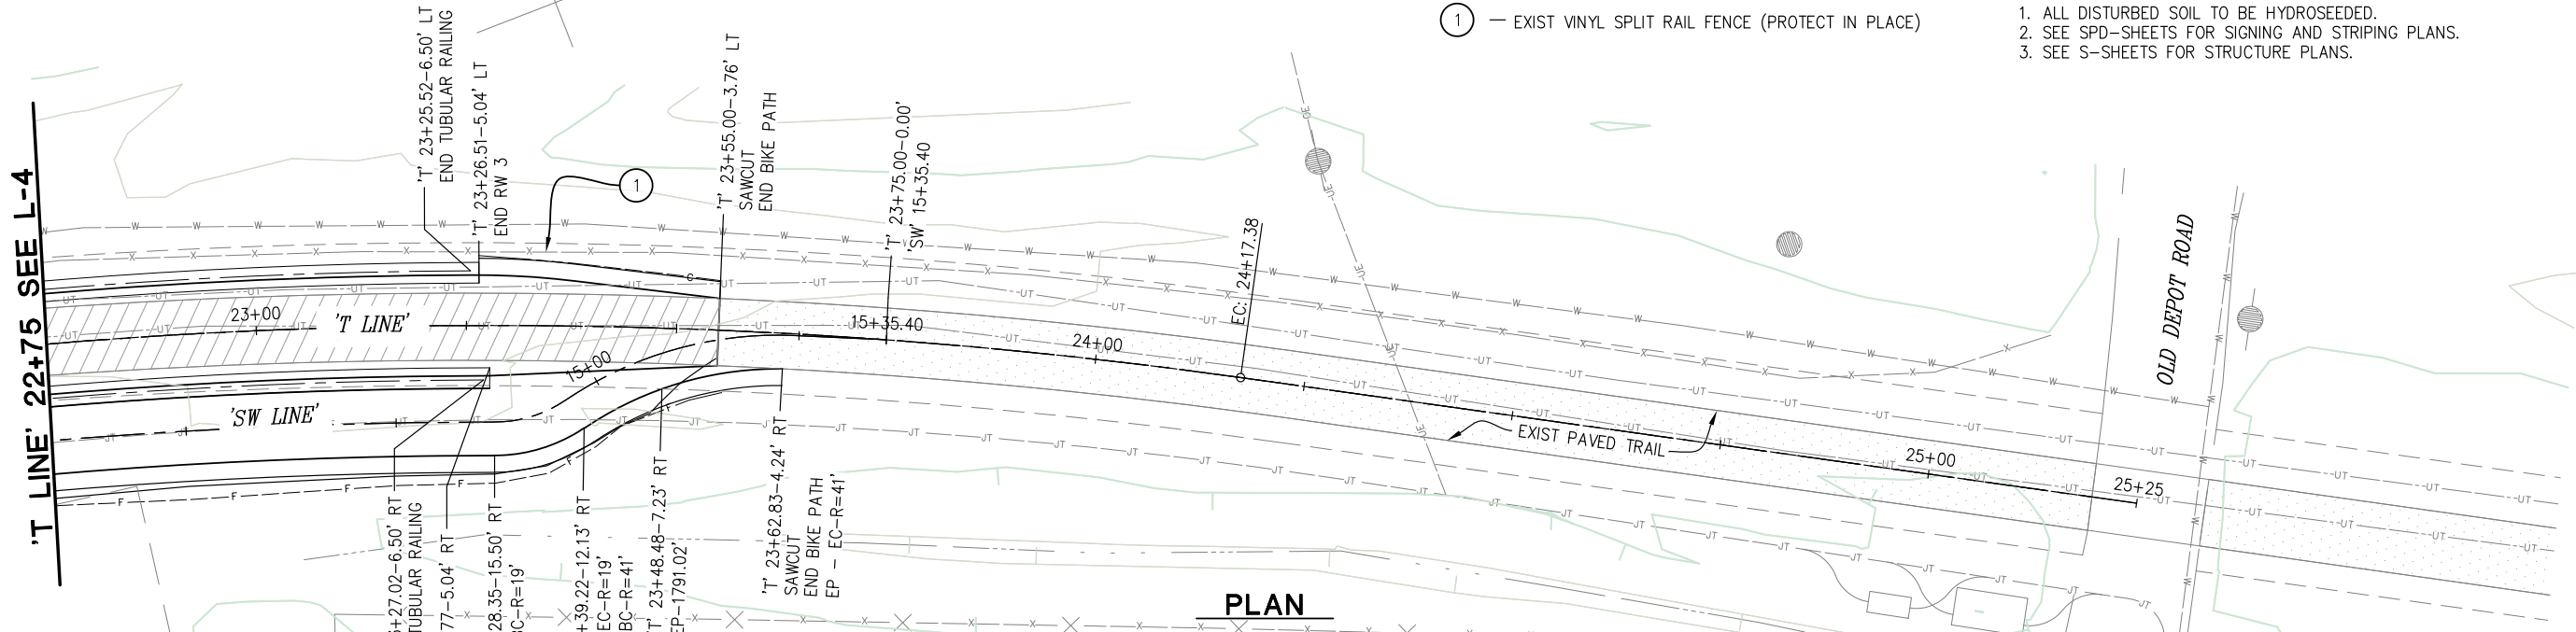


PLAN

LEGEND:

- OBLITERATE EXIST ASPHALT SURFACING
- EXIST PAVED TRAIL (PROTECT IN PLACE)

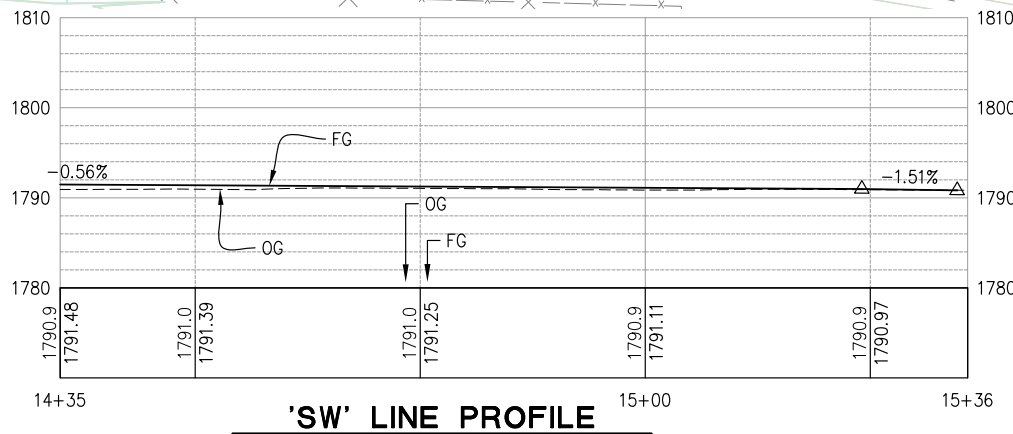

'SW' LINE PROFILE

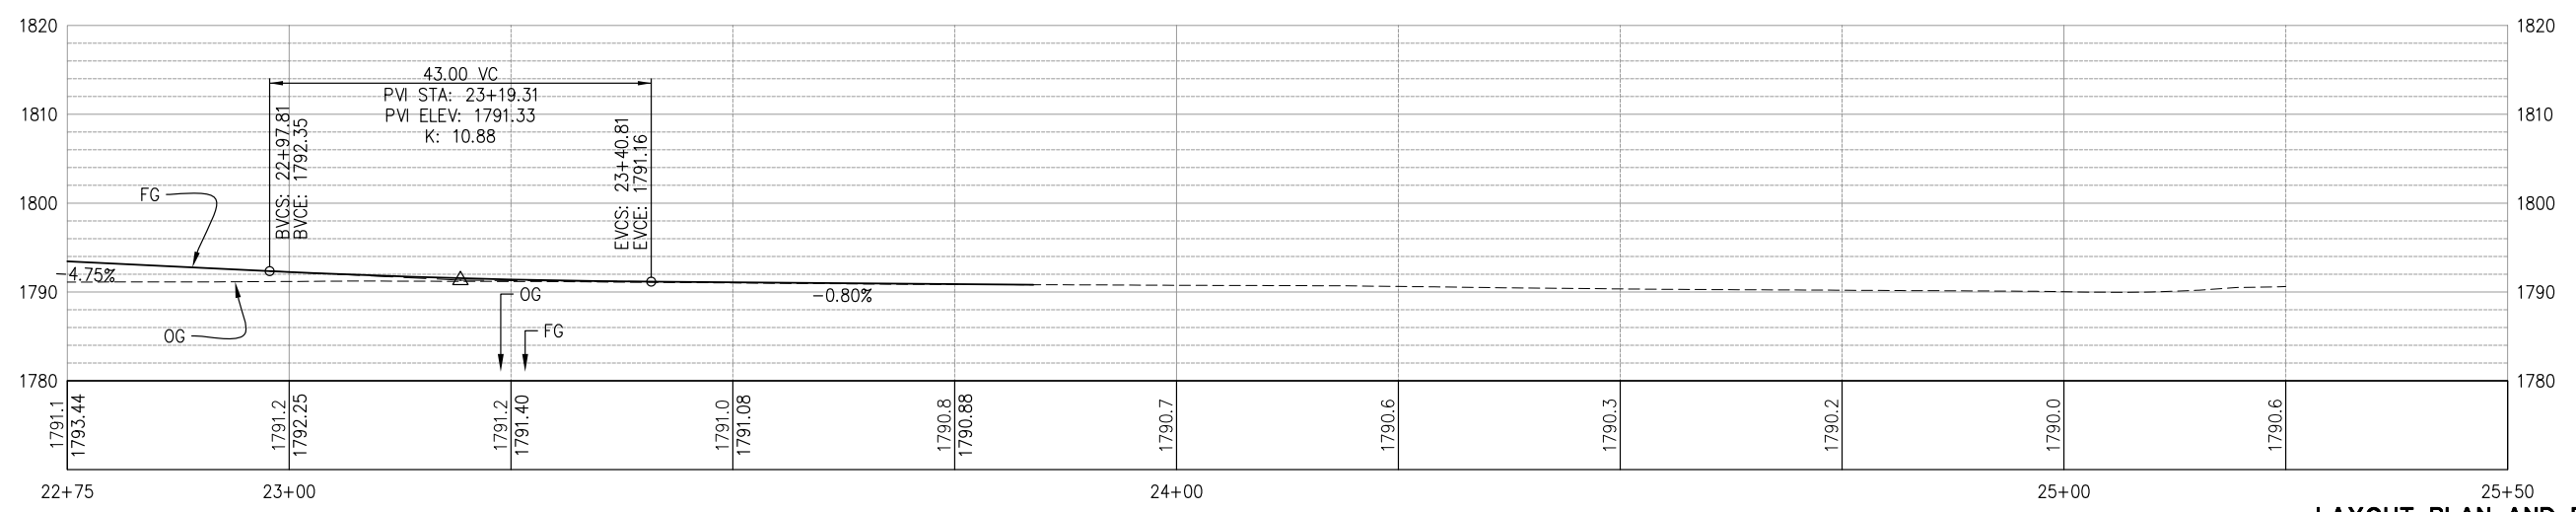

'T' LINE PROFILE

**LAYOUT PLAN AND PROFILE
SCALE: 1" = 10'**

REVISION	NUMBER	DATE	DESCRIPTION	BY



PREPARED UNDER THE SUPERVISION OF:

 REGISTERED CIVIL ENGINEER
 DATE: 4/9/2024

DESIGNED: AN
 DRAWN: AN
 CHECKED: DH
 DATE: 3/5/2024
 ROAD NUMBER: --




**COUNTY OF EL DORADO
 DEPARTMENT OF TRANSPORTATION**

**EL DORADO TRAIL-
 MISSOURI FLAT ROAD
 BIKE/PEDESTRIAN OVERCROSSING
 PHASE 2**

SHEET
L-5
 9 OF 42
 W.O. No. **97015**

ORIGINAL SCALE IS IN INCHES
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 FOR REDUCED PLANS
 REVISION

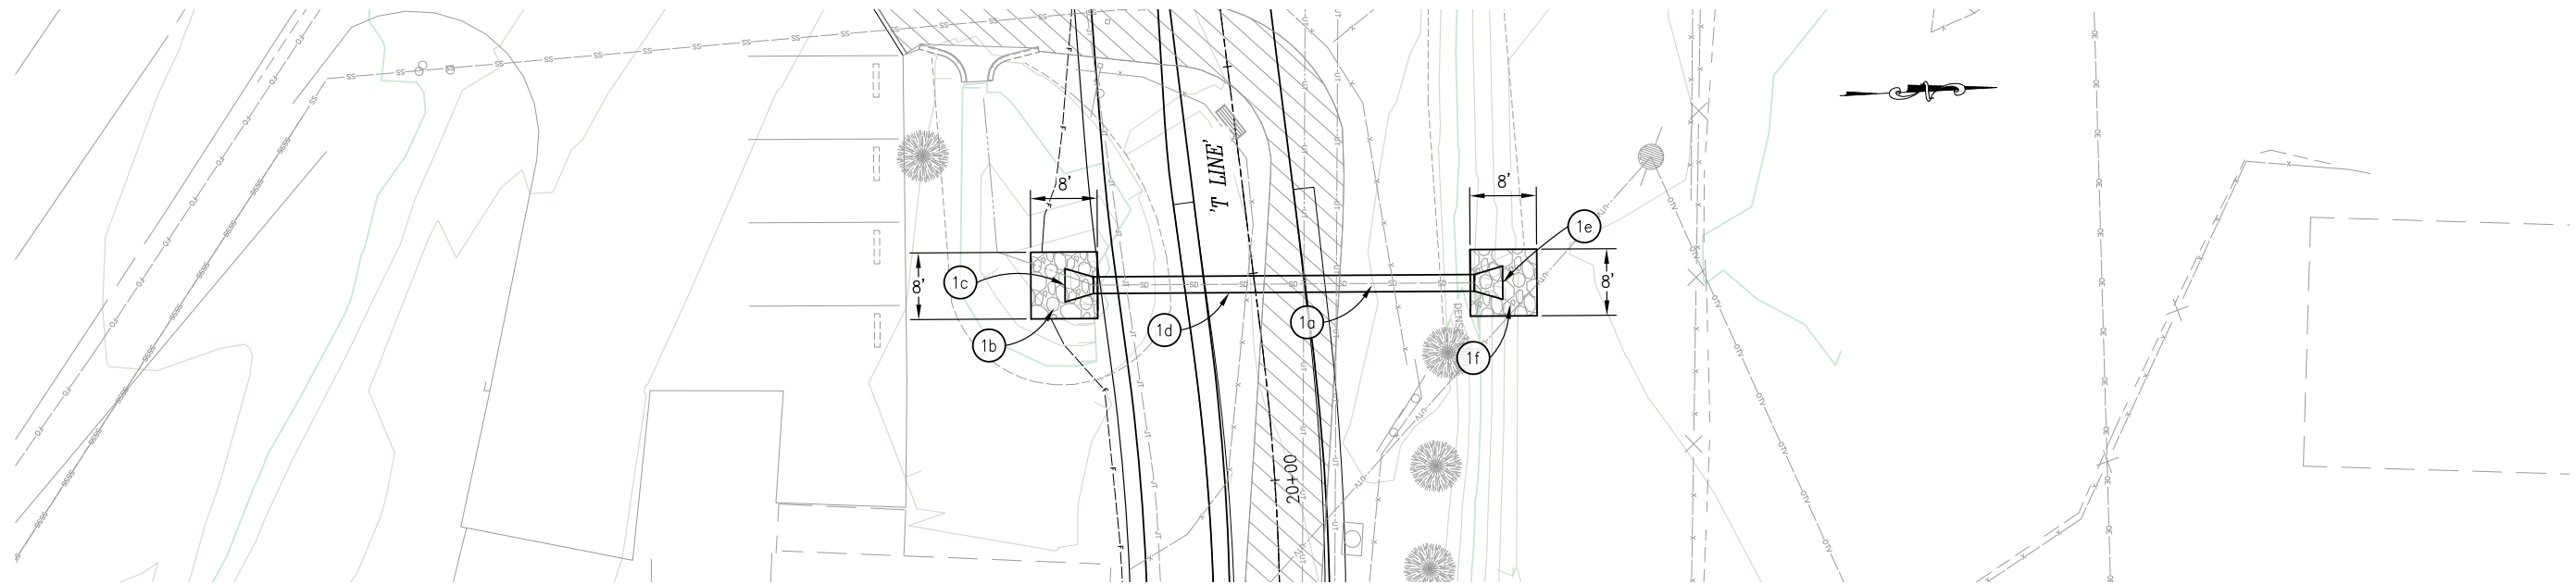


PLAN - SD SYSTEM 1

SCALE: 1" = 10'

CONSTRUCTION NOTES:

- 1a REMOVE EXIST TIMBER CULVERT (APPROX 46 LF)
- 1b ROCK SLOPE PROTECTION (CLASS II, 60 LB, METHOD B) w/ ROCK SLOPE PROTECTION FABRIC (CLASS 8)
- 1c 24" CONCRETE FLARED END SECTION (TYPE B)
- 1d 24" RCP = 46 LF
 'T Line' 19+74.05-19.23' Rt
 'T Line' 19+79.39-26.13' Lt
 INVERT IN ELEV = 1786.65
 INVERT OUT ELEV = 1785.99
 S = 1.44%
- 1e 24" CONCRETE FLARED END SECTION (TYPE B)
- 1f ROCK SLOPE PROTECTION (CLASS II, 60 LB, METHOD B) w/ ROCK SLOPE PROTECTION FABRIC (CLASS 8)

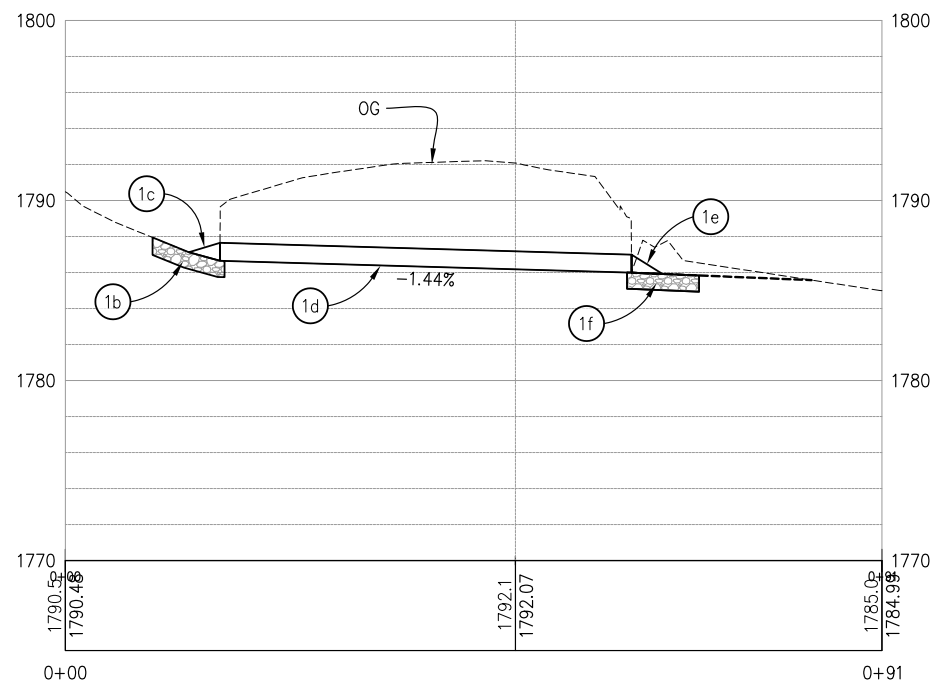

PROFILE - SD SYSTEM 1


SCALE: 1" = 10' H,V

THIS SHEET ACCURATE FOR DRAINAGE WORK ONLY

DRAINAGE PLAN & PROFILE
 SCALE : AS SHOWN

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NUMBER	DATE	DESCRIPTION	BY											

ORIGINAL SCALE IS IN INCHES
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 FOR REDUCED PLANS
 REVISION

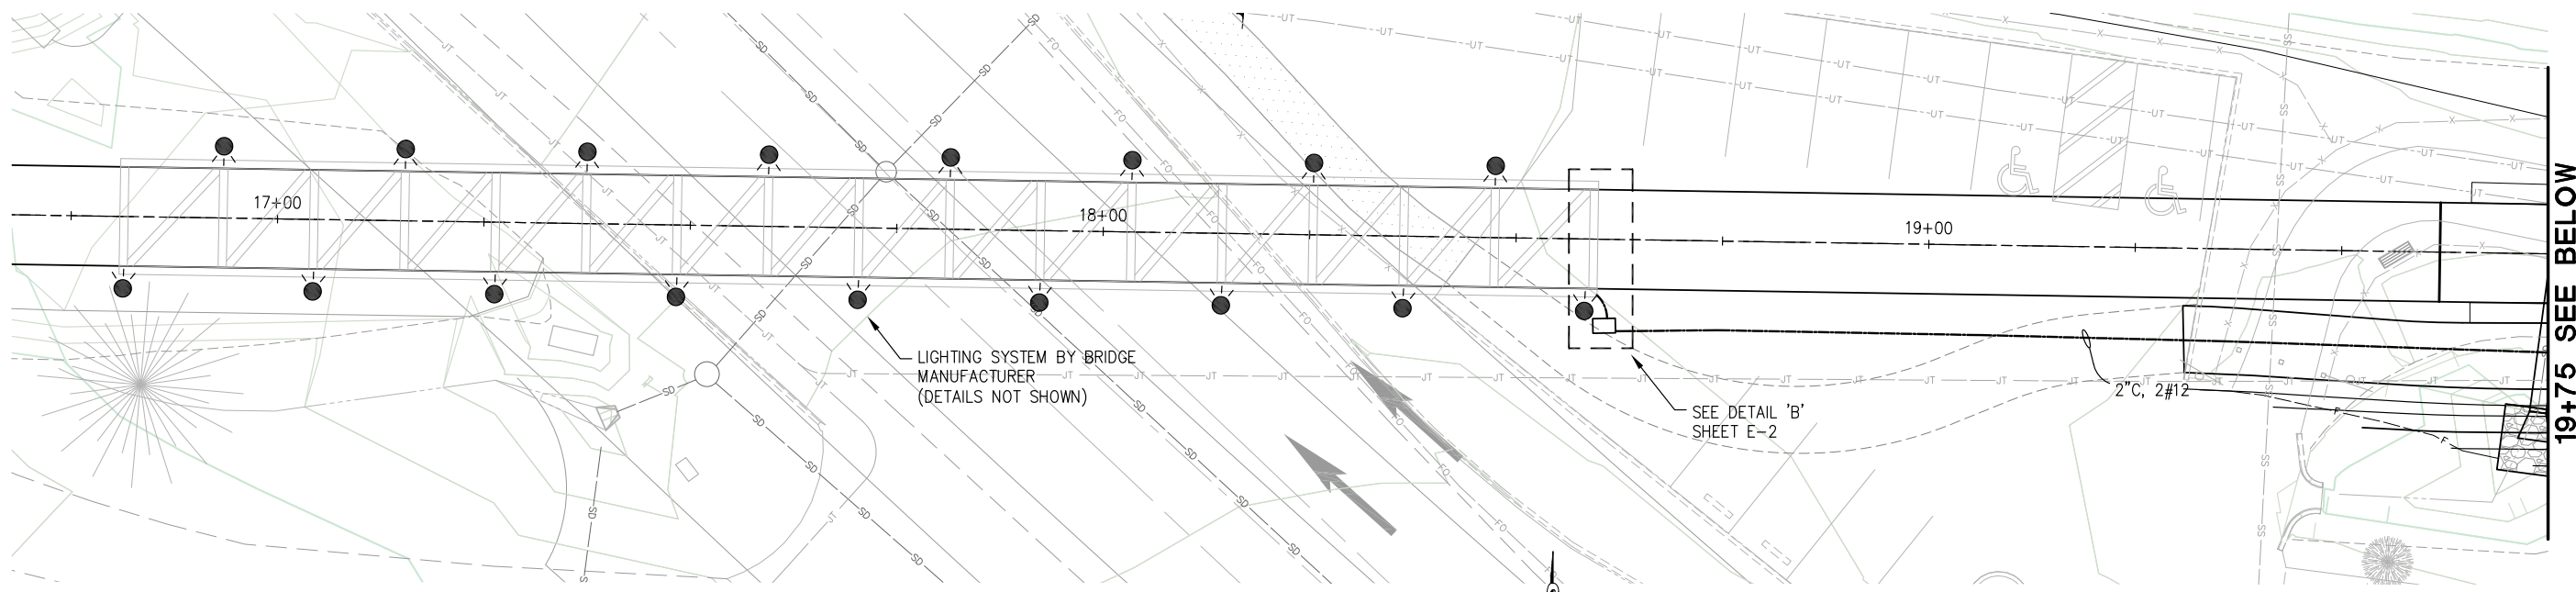

LIGHTING PLAN


SCALE: 1"=10'

LEGEND:

- RECESSED LED LIGHT FIXTURE
ESTIMATE 17 EA, STAGGERED AS SHOWN
LOW LIGHT ILLUMINANCE
10 WATT MAX/FIXTURE
3000K COLOR TEMPERATURE

NOTES:

1. LIGHTING SYSTEM SHALL PROVIDE AN APPROXIMATE AVERAGE ILLUMINANCE ON THE BRIDGE DECK OF APPROXIMATELY 3-5 FOOTCANDLES.
2. LIGHT FIXTURES TO BE RECESSED WITHIN VERTICAL BRIDGE MEMBERS AT THE APPROXIMATE LOCATIONS SHOWN ON THE PLAN. EXACT HEIGHT OF FIXTURE AND MAKE/MODEL TO BE DETERMINED DURING SUBMITTAL REVIEW.
3. LIGHTING CONDUIT ATTACHED TO THE BRIDGE MAY BE A COMBINATION OF RIGID AND FLEXIBLE TYPE.
4. LIGHTING SYSTEM LAYOUT TO BE SHOWN ON BRIDGE SHOP DRAWINGS AND BE SUBJECT TO REVIEW BY COUNTY.

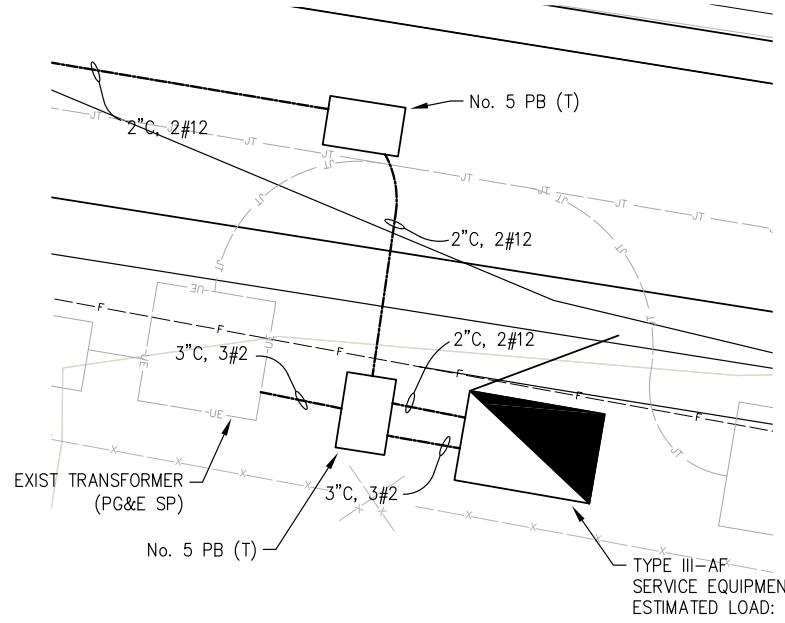


DETAIL 'A'

NO SCALE

TYPE III-AF SERVICE EQUIPMENT ENCLOSURE
ESTIMATED LOAD: 17-10 W LTG

SERVICE PEDESTAL INSTALLATION
REQUIRES A 30"W x 36"D CLEAR AND
LEVEL WORKSPACE IN FRONT OF METER

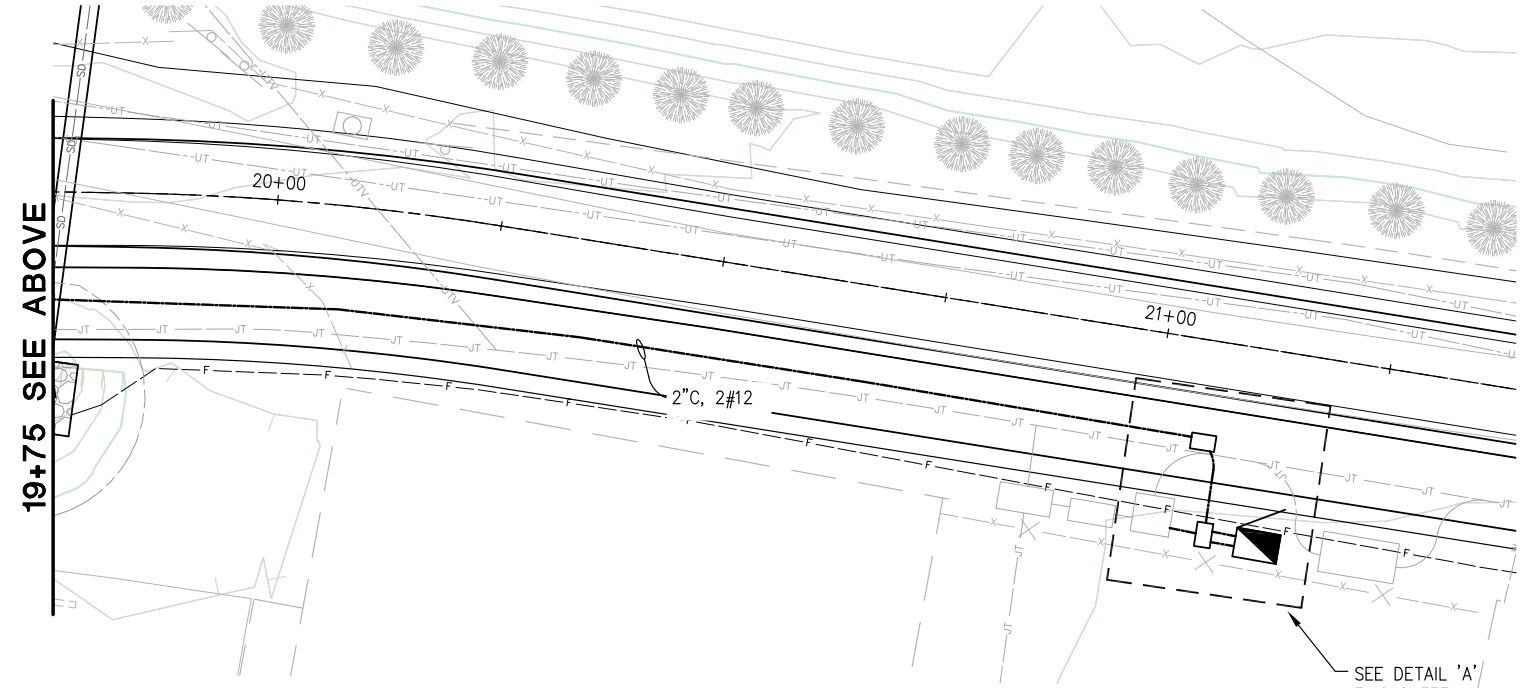

LIGHTING PLAN

SCALE: 1"=10'

LIGHTING PLAN (BRIDGE)
SCALE : AS SHOWN

THIS SHEET ACCURATE FOR ELECTRICAL WORK ONLY

REVISION	NUMBER	DATE	DESCRIPTION	BY



PREPARED UNDER THE SUPERVISION OF:

 REGISTERED CIVIL ENGINEER
 DATE: 4/9/2024

DESIGNED: DH
 DRAWN: AN
 CHECKED: DH
 DATE: 3/26/2024
 ROAD NUMBER: --





COUNTY OF EL DORADO
DEPARTMENT OF TRANSPORTATION


**EL DORADO TRAIL-
MISSOURI FLAT ROAD
BIKE/PEDESTRIAN OVERCROSSING
PHASE 2**

SHEET
E-1
11 OF 42
W.O. No. **97015**

ORIGINAL SCALE IS IN INCHES
 Drawing name: Z:\Civil_3D\Projects\97015 El Dorado POC\CADD Files\Sheets\E_Sheets.dwg Layout Tab: E-2 Mar 26 2024 - 7:32pm Dharrington
 FOR REDUCED PLANS

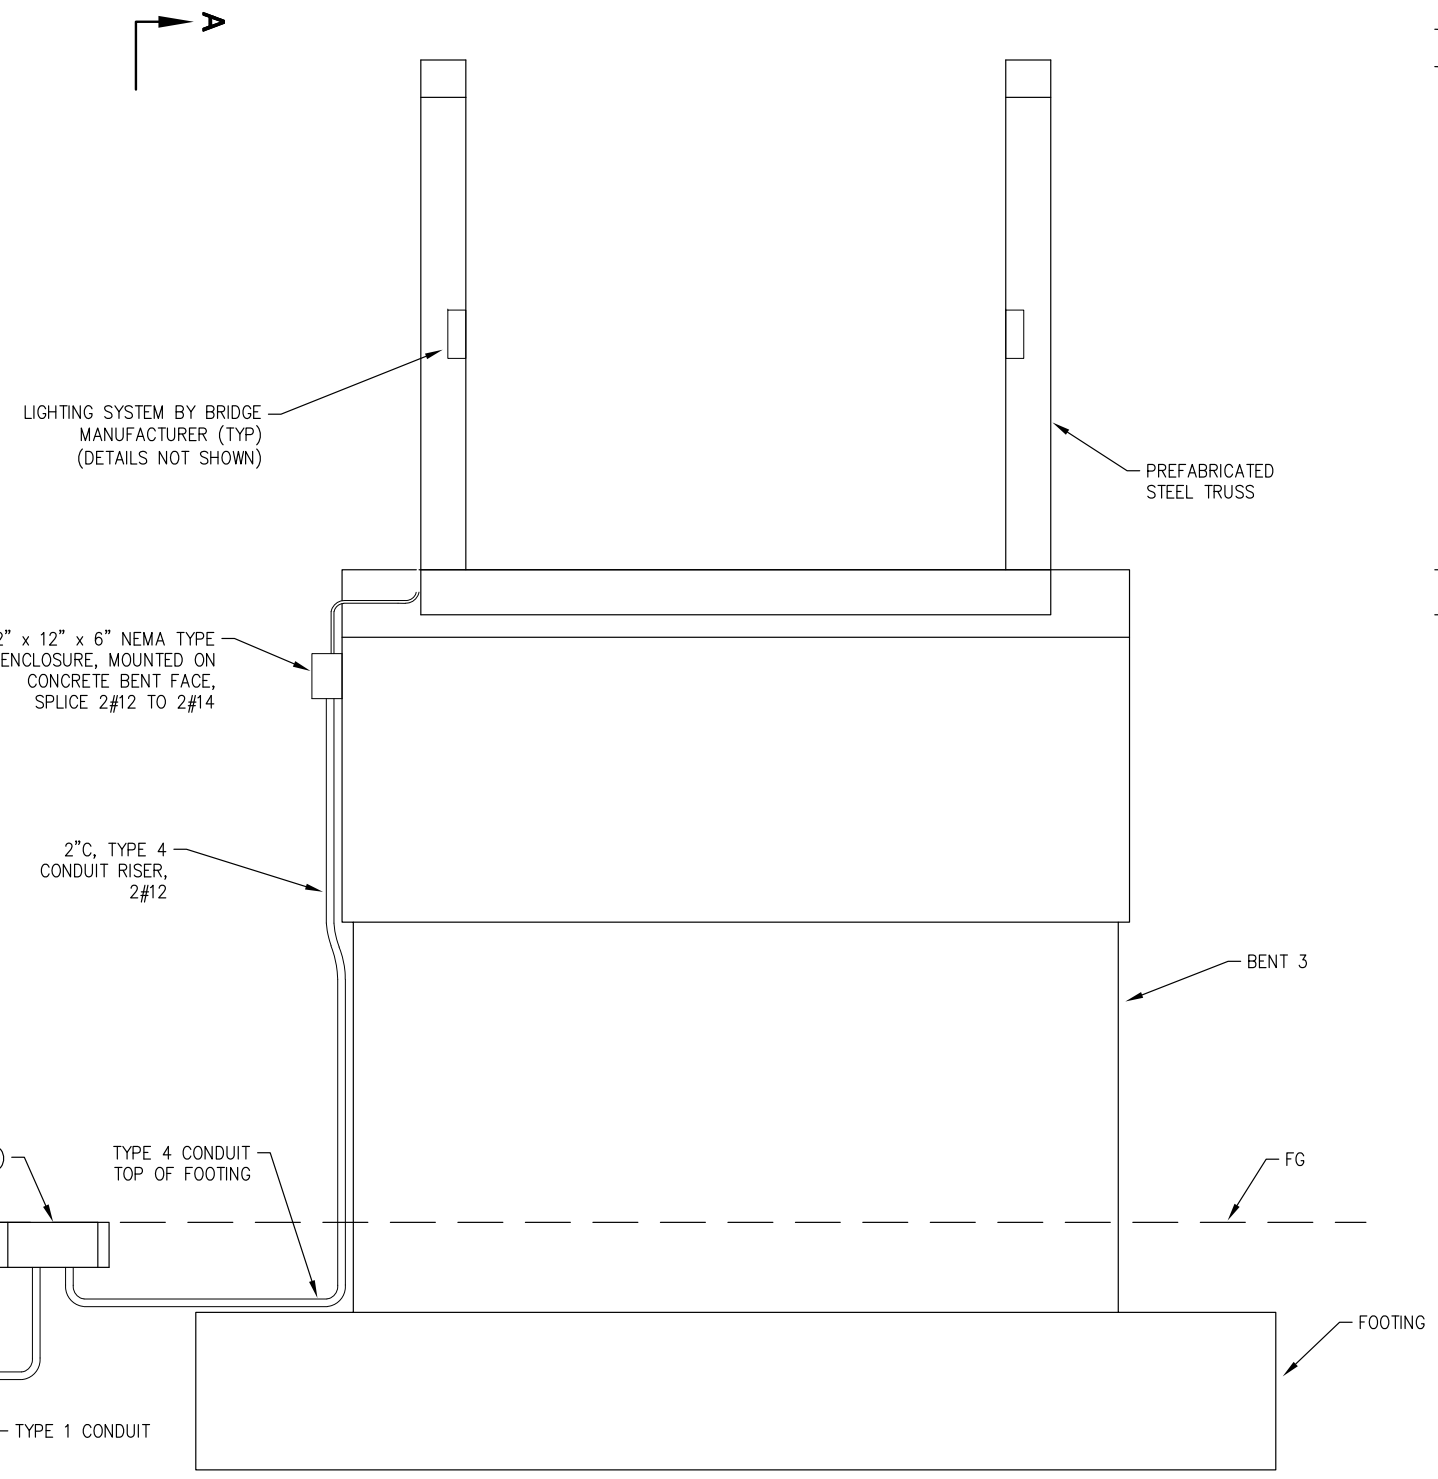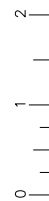

DETAIL 'B'
NO SCALE

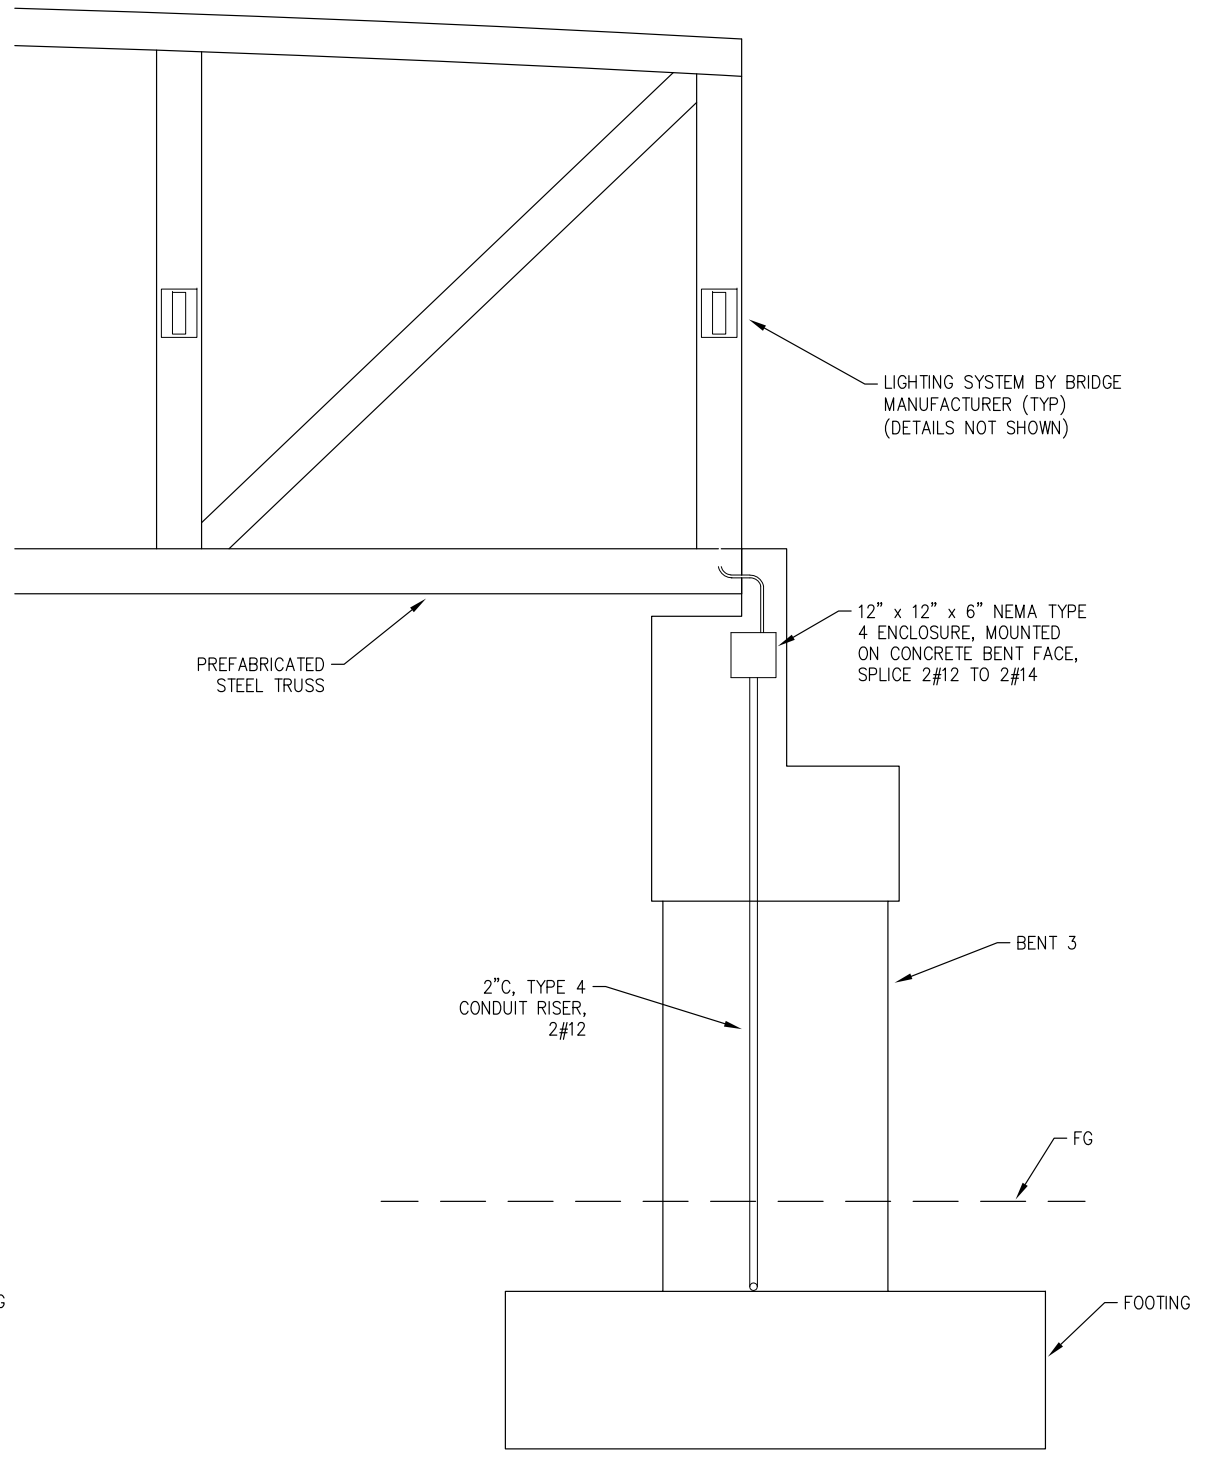

SECTION A-A
NO SCALE

THIS SHEET ACCURATE FOR ELECTRICAL WORK ONLY

LIGHTING PLAN (BRIDGE)
SCALE : 1" = 20'

REVISION	NUMBER	DATE	DESCRIPTION	BY



PREPARED UNDER THE SUPERVISION OF:

 REGISTERED CIVIL ENGINEER
 DATE: 4/9/2024

DESIGNED: DH
 DRAWN: AN
 CHECKED: DH
 DATE: 3/26/2024
 ROAD NUMBER: --




COUNTY OF EL DORADO
DEPARTMENT OF TRANSPORTATION

**EL DORADO TRAIL-
 MISSOURI FLAT ROAD
 BIKE/PEDESTRIAN OVERCROSSING
 PHASE 2**

SHEET
E-2
 12 OF 42
 W.O. No. **97015**

ORIGINAL SCALE IS IN INCHES
 Drawing name: Z:\Civil_3D\Projects\97015 El Dorado POC\CADD Files\Sheets\E_Sheets.dwg Layout Tab: E-3 Jan 08,2024 - 12:13pm Dharrington
 FOR REDUCED PLANS
 2
 1
 0

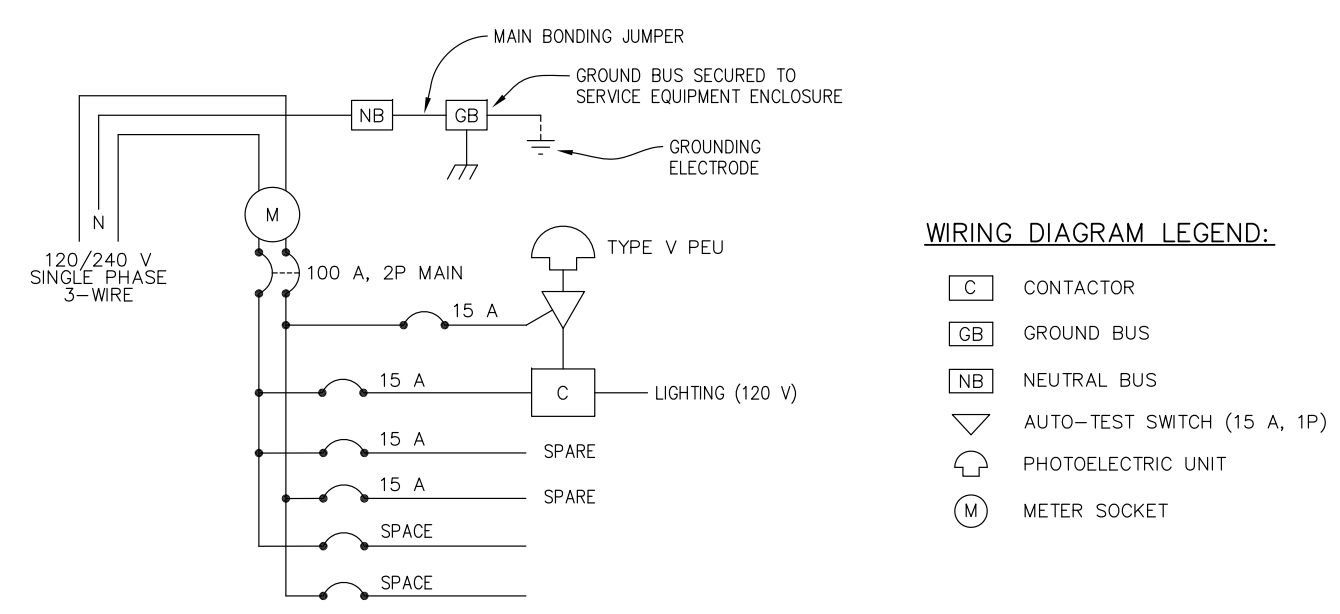

WIRING DIAGRAM LEGEND:

- C CONTACTOR
- GB GROUND BUS
- NB NEUTRAL BUS
- AUTO-TEST SWITCH (15 A, 1P)
- PHOTOELECTRIC UNIT
- M METER SOCKET


SERVICE EQUIPMENT WIRING DIAGRAM

NO SCALE

THIS SHEET ACCURATE FOR ELECTRICAL WORK ONLY

LIGHTING PLAN (BRIDGE)
SCALE : 1" = 20'

REVISION NUMBER DATE DESCRIPTION BY						 COUNTY OF EL DORADO DEPARTMENT OF TRANSPORTATION	EL DORADO TRAIL- MISSOURI FLAT ROAD BIKE/PEDESTRIAN OVERCROSSING PHASE 2	SHEET
								E-3 13 OF 42 W.O. No. 97015

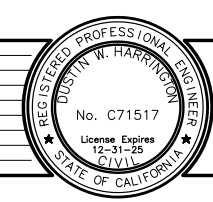

PREPARED UNDER THE SUPERVISION OF :

 REGISTERED CIVIL ENGINEER
 DATE: 1/23/2024

DESIGNED: DH DRAWN: AN
 CHECKED: DH DATE: 11/27/2023
 ROAD NUMBER: --



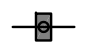


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 FOR REDUCED PLANS
 2
 1
 0


GENERAL NOTES:

1. LOCATIONS OF CONSTRUCTION AREA SIGNS ARE APPROXIMATE. FINAL LOCATIONS WILL BE DETERMINED BY THE ENGINEER.
2. SUBMIT TRAFFIC CONTROL PLANS TO THE ENGINEER FOR REVIEW AND APPROVAL IN ACCORDANCE WITH THE SPECIAL PROVISIONS PRIOR TO THE START OF WORK REQUIRING TRAFFIC CONTROL.
3. CONSTRUCTION AREA SIGNS (EXCLUDING FUNDING SIGNS) MUST HAVE BLACK LETTERING AND BORDER OVER ORANGE BACKGROUND.

LEGEND:

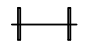-  — TYPE III BARRICADE
-  — CONSTRUCTION AREA SIGN
-  — PORTABLE CHANGEABLE MESSAGE SIGN (PCMS)

PORTABLE CHANGEABLE MESSAGE SIGN	
FIRST FLASH	SECOND FLASH
SHOULDER WORK AHEAD	MON - FRI (WORK HOURS)

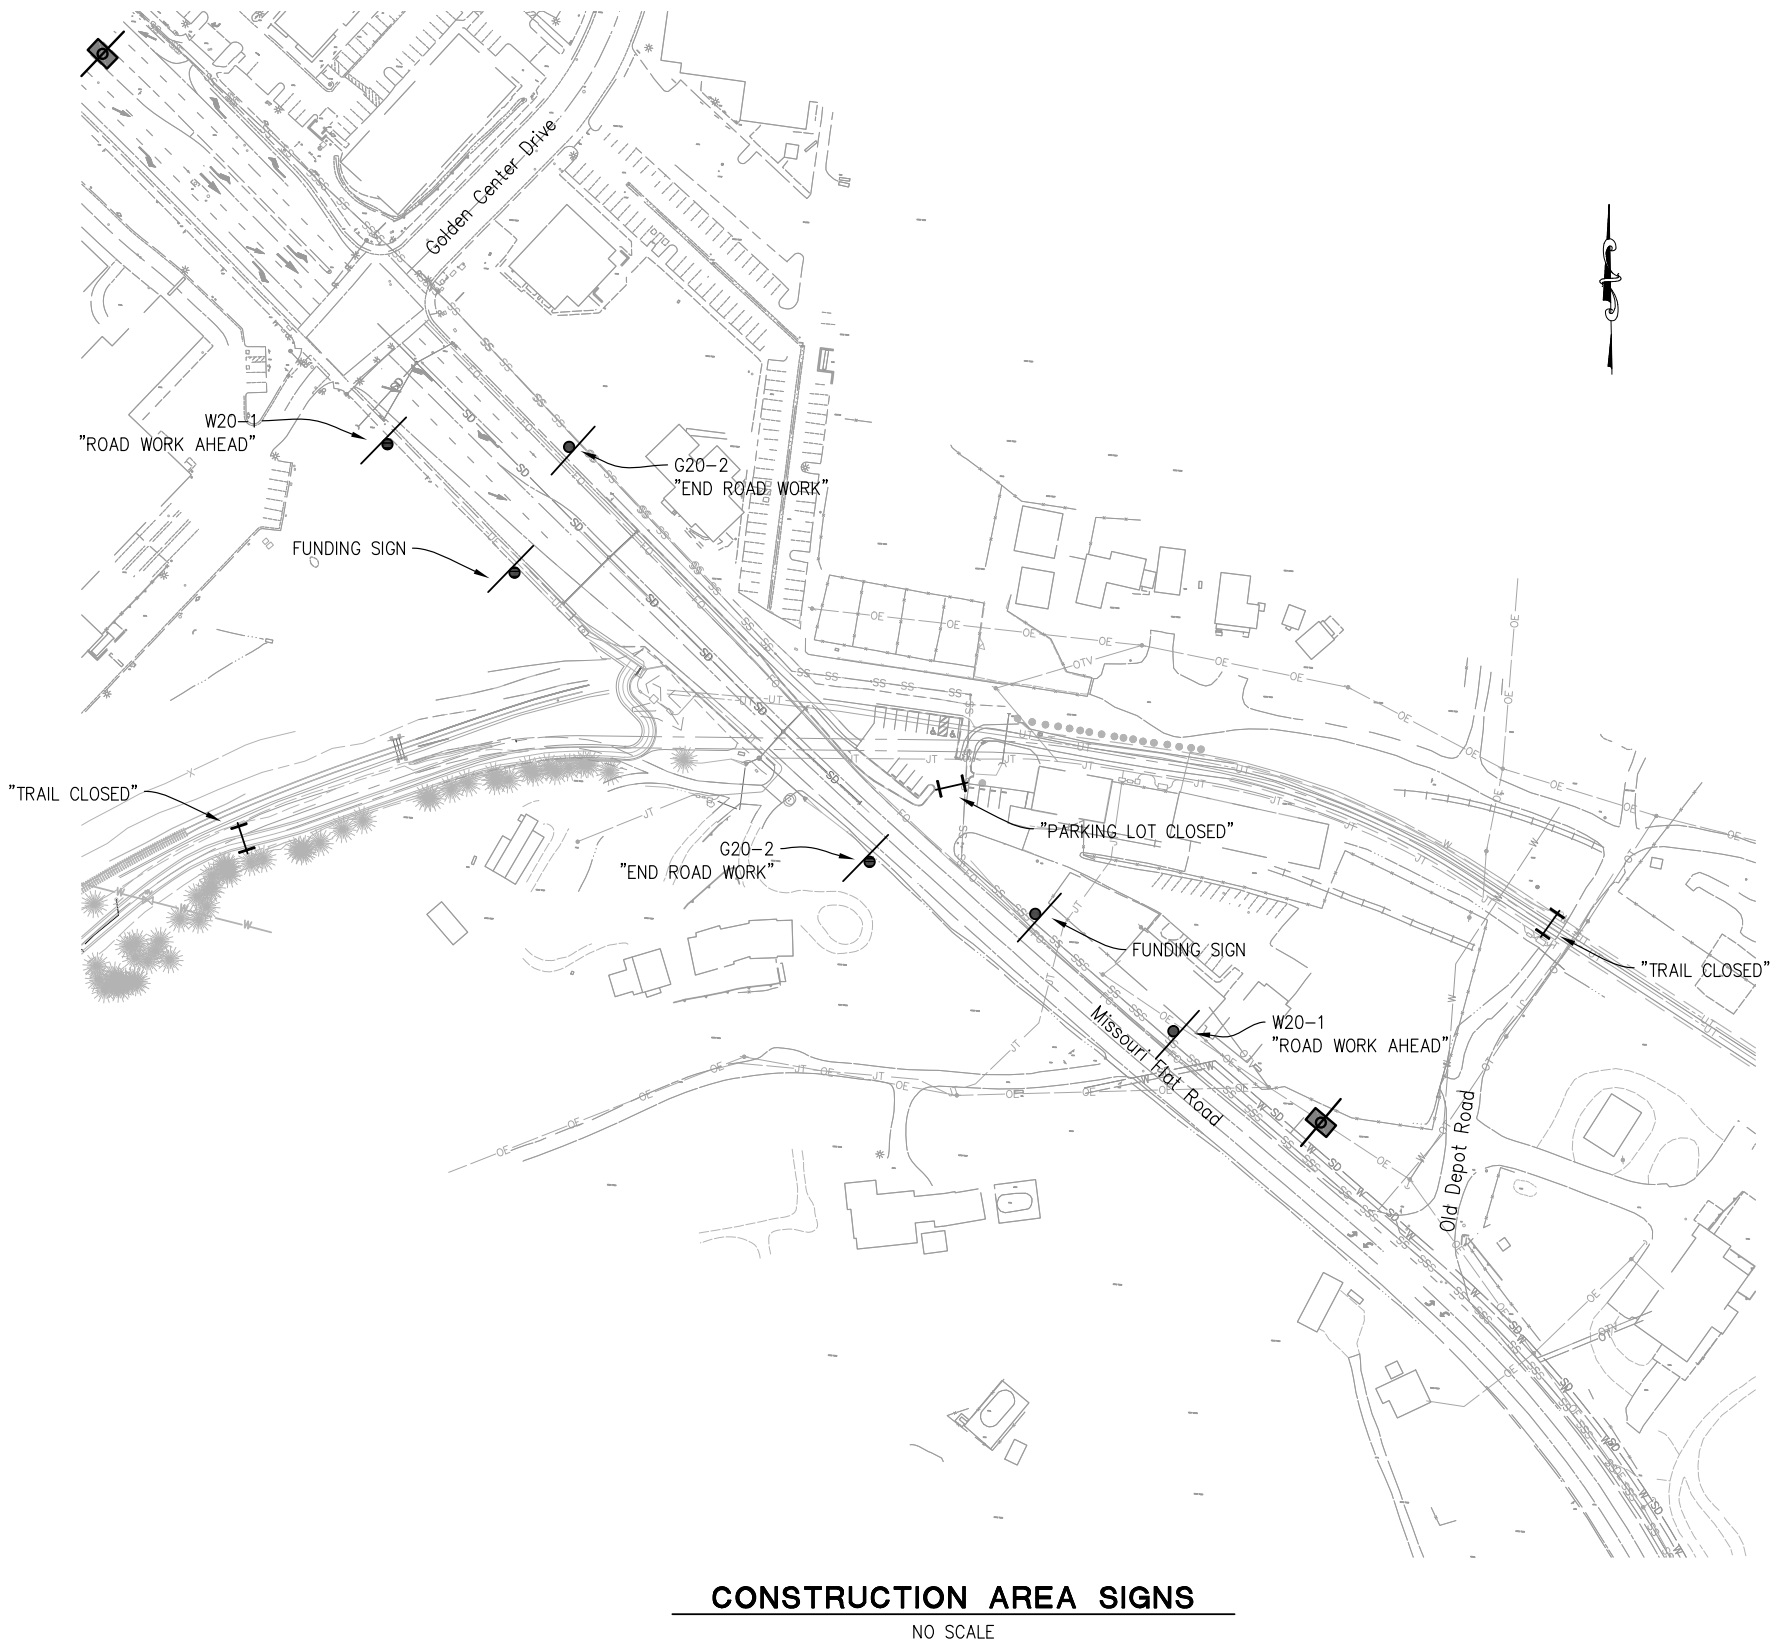


CONSTRUCTION AREA SIGNS
NO SCALE

THIS SHEET ACCURATE FOR SIGNING WORK ONLY

CONSTRUCTION AREA SIGNS
SCALE : 1" = 20'

REVISION	NUMBER	DATE	DESCRIPTION	BY

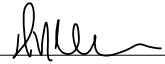

PREPARED UNDER THE SUPERVISION OF:

 REGISTERED CIVIL ENGINEER
 DATE: 1/23/2024

DESIGNED: DH
 DRAWN: AN
 CHECKED: DH
 DATE: 6/4/2020
 ROAD NUMBER: --




COUNTY OF EL DORADO
DEPARTMENT OF TRANSPORTATION

**EL DORADO TRAIL-
MISSOURI FLAT ROAD
BIKE/PEDESTRIAN OVERCROSSING
PHASE 2**


SHEET
CS-1
14 OF 42
W.O. No. **97015**

ORIGINAL SCALE IS IN INCHES
 Drawing name: Z:\Civil_3D\Projects\97015 El Dorado_POC\CADD_Files\Sheets\SPD_Sheets.dwg Layout Tab: SPD-1 Mar 26, 2024 - 7:50pm Dharrington

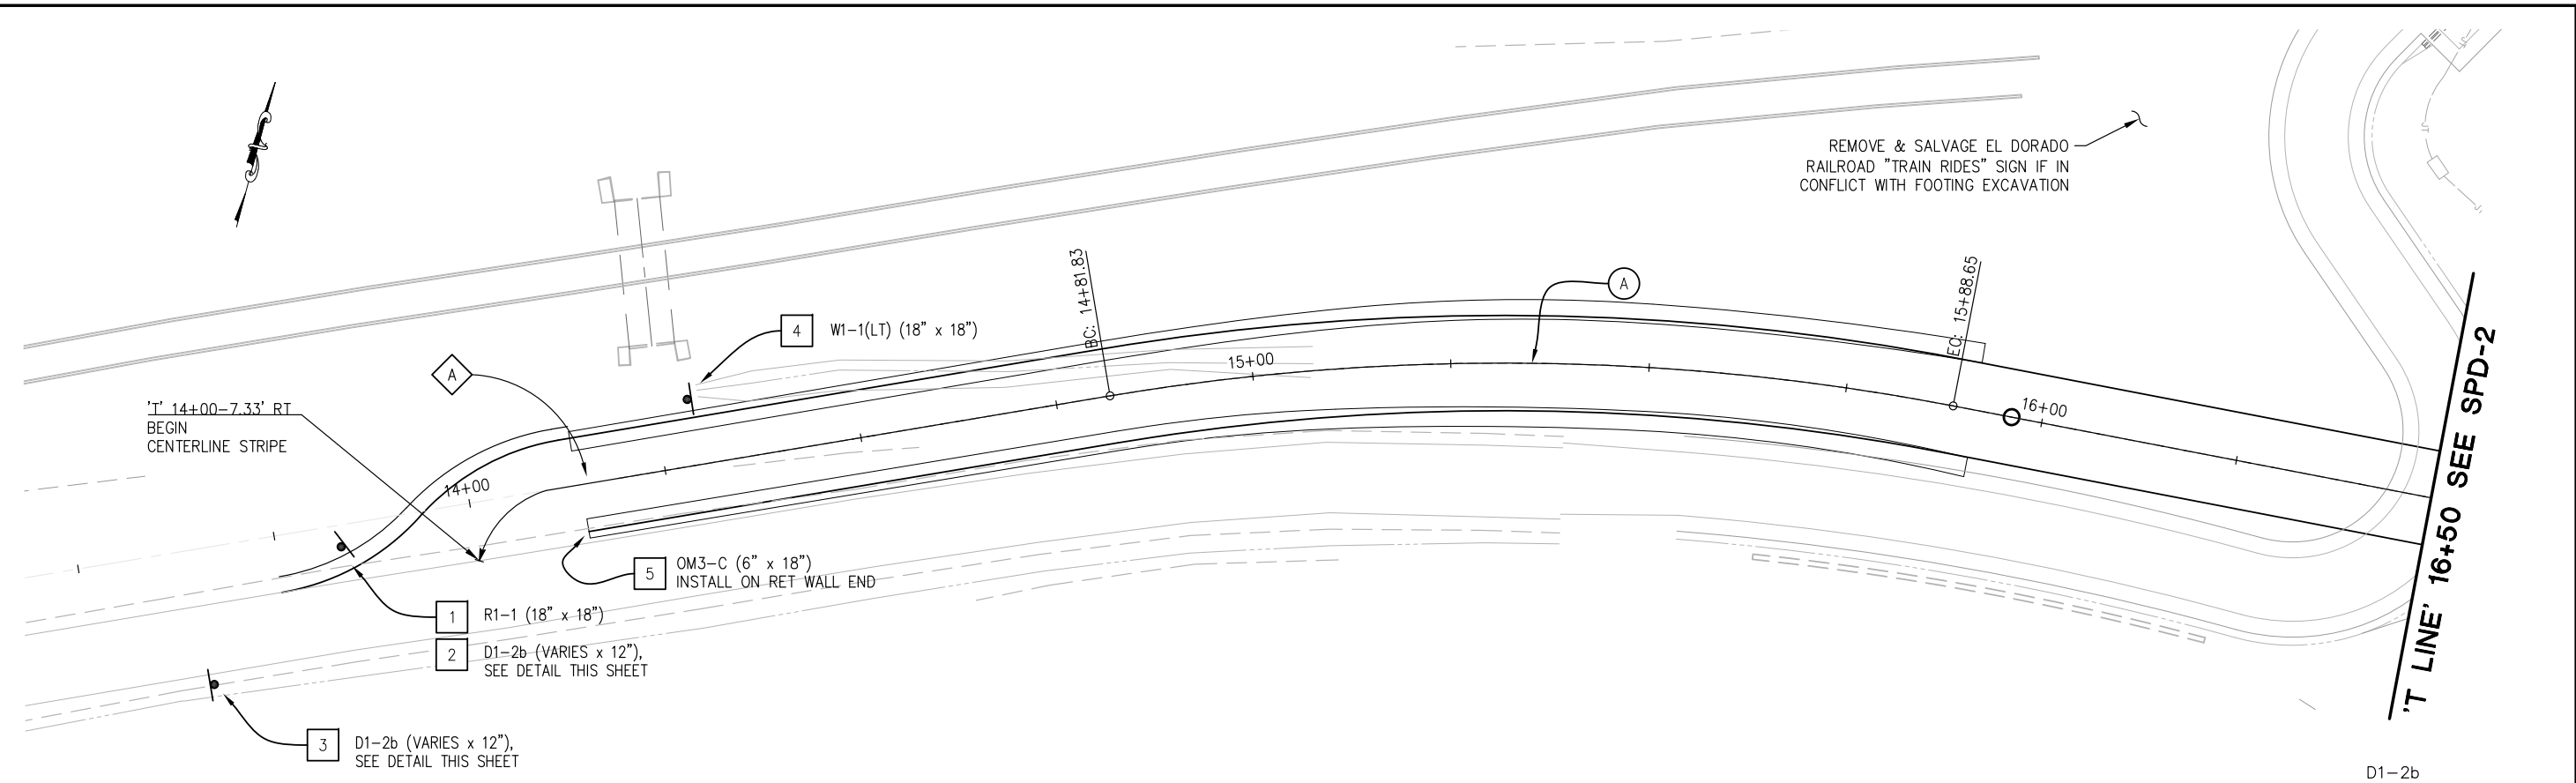


LEGEND:

- XX - SIGN NUMBER
- EXIST SIGN
- INSTALL SIGN SINGLE POST PER DETAIL 'B' ON SHEET SPD-4
- A - DASHED CENTERLINE STRIPE PER DETAIL 'A' ON SHEET SPD-4
- LIMITS OF DESIGNATED STRIPES AND DETAILS

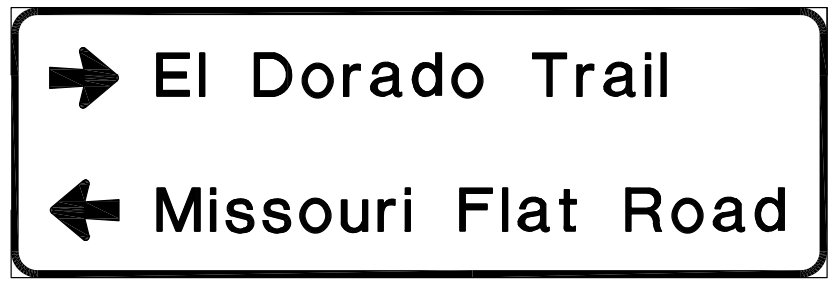

SIGN DETAIL 2
NO SCALE

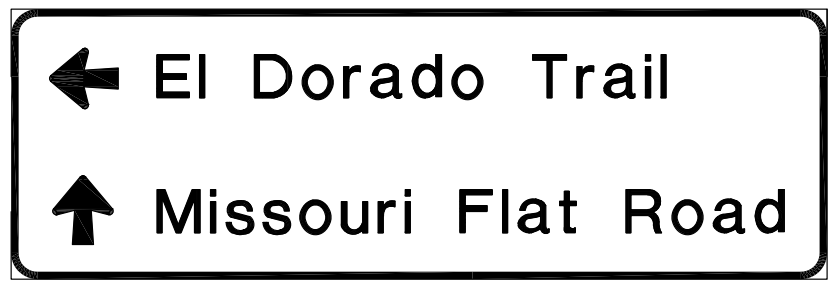

SIGN DETAIL 3
NO SCALE

THIS SHEET ACCURATE FOR SIGNING AND PAVEMENT DELINEATION WORK ONLY

PAVEMENT & SIGN DELINEATION
SCALE : 1" = 20'

<table border="1" style="width: 100%; border-collapse: collapse;"> <tr> <th style="width: 5%;">REVISION</th> <th style="width: 5%;">NUMBER</th> <th style="width: 10%;">DATE</th> <th style="width: 80%;">DESCRIPTION</th> </tr> <tr> <td> </td> <td> </td> <td> </td> <td> </td> </tr> </table>	REVISION	NUMBER	DATE	DESCRIPTION						PREPARED UNDER THE SUPERVISION OF: REGISTERED CIVIL ENGINEER DATE: 4/9/2024	DESIGNED: AN DRAWN: AN CHECKED: DH DATE: 3/26/2024 ROAD NUMBER: --	<p>COUNTY OF EL DORADO DEPARTMENT OF TRANSPORTATION</p>	<p>EL DORADO TRAIL- MISSOURI FLAT ROAD BIKE/PEDESTRIAN OVERCROSSING PHASE 2</p>	SHEET SPD-1 15 OF 42 W.O. No. 97015
REVISION	NUMBER	DATE	DESCRIPTION											

ORIGINAL SCALE IS IN INCHES
 Drawing name: Z:\Civil_3D\Projects\97015 El Dorado POC\CADD Files\Sheets\SPD_Sheets.dwg Layout Tab: SPD-2 Jan 21, 2024 - 7:47pm Dharrington

'T LINE' 16+50 SEE SPD-1

'T LINE' 19+25 SEE BELOW

REMOVE & SALVAGE
 EXIST ADA PARKING SIGN
 POST w/ PANELS

6

MISSOURI FLAT ROAD

'T LINE'

'T LINE' 19+25 SEE ABOVE

'T LINE' 22+25 SEE SPD-3

REMOVE & SALVAGE
 EXIST ADA PARKING SIGN
 POST w/ PANELS

7

'SW' 11+00.00
 BEGIN
 CENTERLINE
 STRIPE

REMOVE & SALVAGE EXIST SIGN POST w/ PANEL

10

RELOCATE EXIST SIGN POST w/ PANELS

9

RELOCATE EXIST SIGN POST w/ PANELS

8

THIS SHEET ACCURATE FOR SIGNING AND PAVEMENT DELINEATION WORK ONLY

PAVEMENT & SIGN DELINEATION
 SCALE : 1" = 20'

REVISION	NUMBER	DATE	DESCRIPTION	BY



PREPARED UNDER THE SUPERVISION OF :

 REGISTERED CIVIL ENGINEER
 DATE: 1/23/2024

DESIGNED: AN
 DRAWN: AN
 CHECKED: DH
 DATE: 8/31/2020
 ROAD NUMBER: --





COUNTY OF EL DORADO
 DEPARTMENT OF TRANSPORTATION

EL DORADO TRAIL-
 MISSOURI FLAT ROAD
 BIKE/PEDESTRIAN OVERCROSSING
 PHASE 2

SHEET
 SPD-2
 16 OF 42
 W.O. No. 97015

ORIGINAL SCALE IS IN INCHES
 Drawing name: Z:\Civil_3D\Projects\97015 El Dorado POC\CADD Files\Sheets\SPD_Sheets.dwg Layout Tab: SPD-3 Mar 26, 2024 - 7:49pm Dharrington
 FOR REDUCED PLANS
 REVISION
 NUMBER DATE DESCRIPTION BY

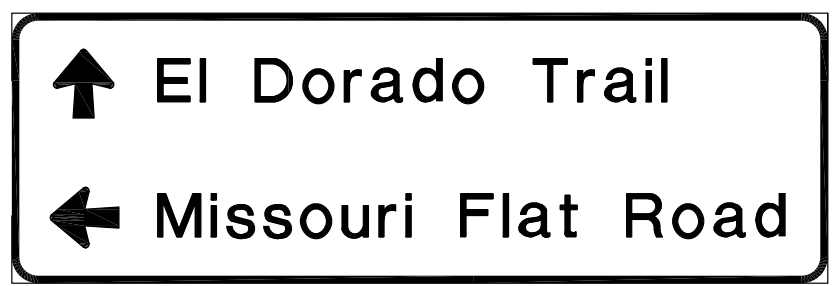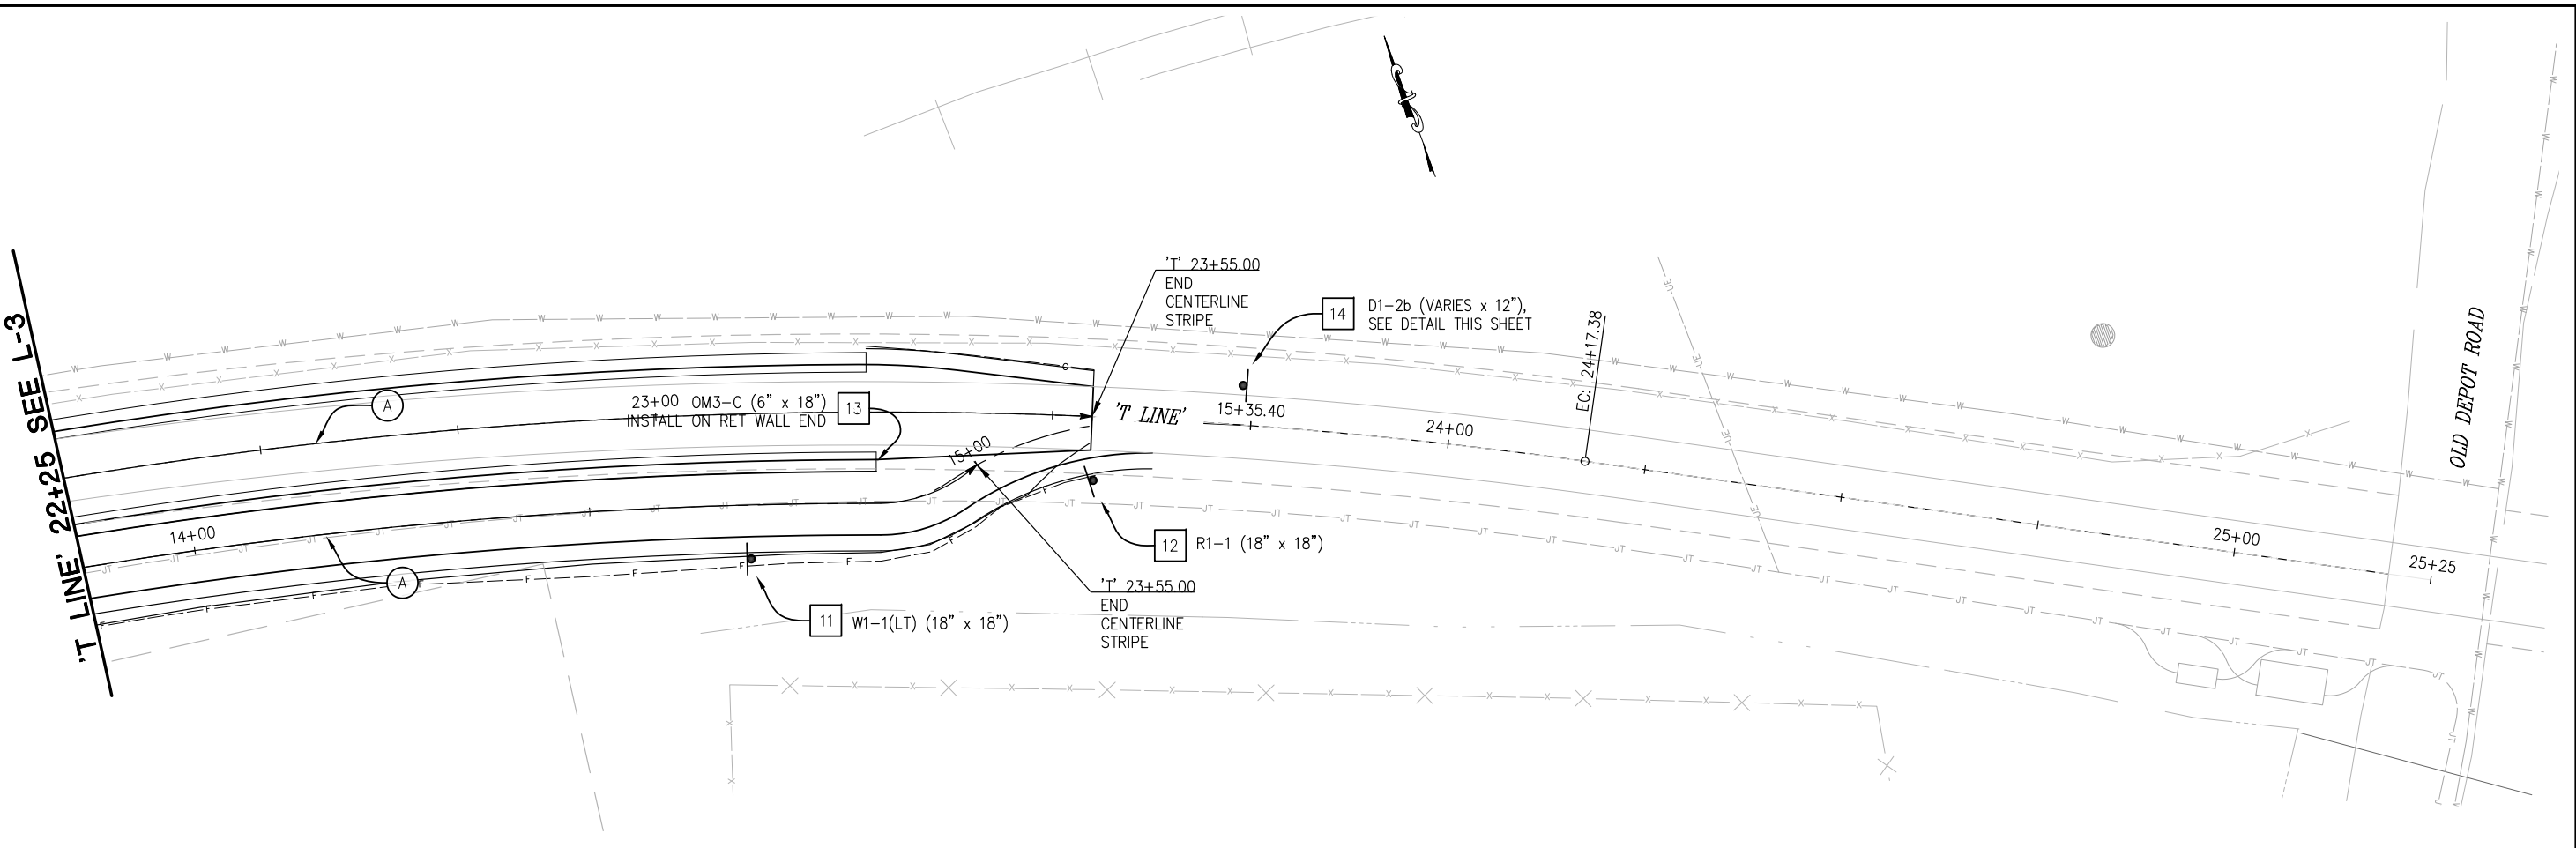

SIGN DETAIL 14
NO SCALE

THIS SHEET ACCURATE FOR SIGNING AND PAVEMENT DELINEATION WORK ONLY

PAVEMENT & SIGN DELINEATION
SCALE : 1" = 20'

NUMBER	DATE	DESCRIPTION	BY



PREPARED UNDER THE SUPERVISION OF:

 REGISTERED CIVIL ENGINEER
 DATE: 4/9/2024

DESIGNED: AN
 DRAWN: AN
 CHECKED: DH
 DATE: 3/26/2024
 ROAD NUMBER: --




COUNTY OF EL DORADO
DEPARTMENT OF TRANSPORTATION


EL DORADO TRAIL
MISSOURI FLAT ROAD
PEDESTRIAN OVERCROSSING

SHEET
SPD-3
17 OF 42
W.O. No. 97015

ORIGINAL SCALE IS IN INCHES
 Drawing name: Z:\Civil_3D\Projects\97015 El Dorado POC\CADD Files\Sheets\SPD_Sheets.dwg Layout Tab: SPD-4 Jan 08, 2024 - 12:18pm Dharrington

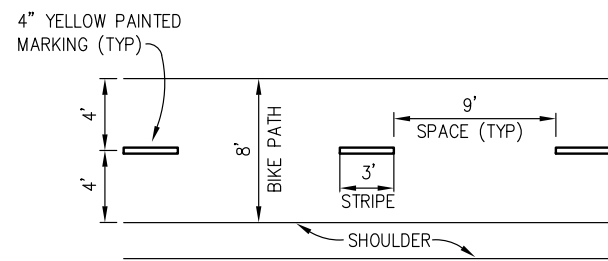

A **DASHED CENTERLINE STRIPING DETAIL**
NO SCALE

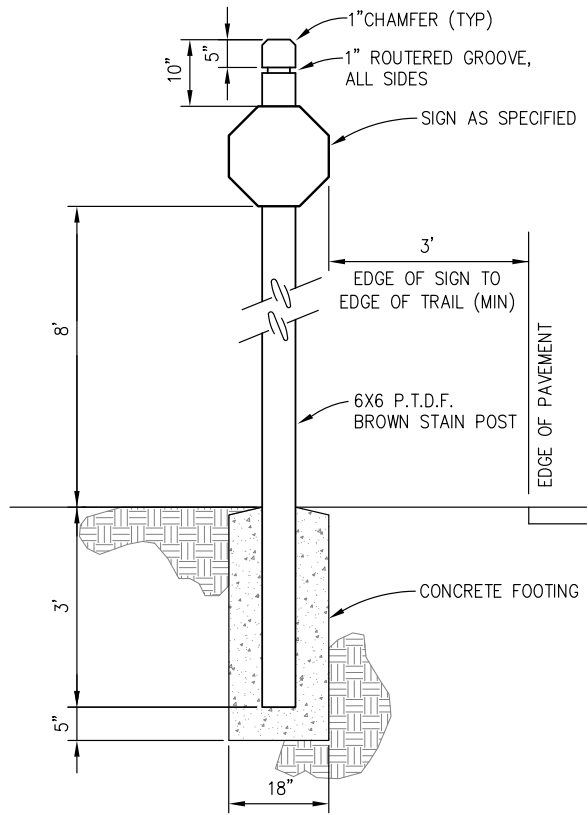

B **SIGN POST DETAIL**
NO SCALE


NOTE:
 1. COUNTY WILL FURNISH (4) 16' 6x6 SIGN POSTS FOR CONTRACTOR'S USE

THIS SHEET ACCURATE FOR SIGNING AND PAVEMENT DELINEATION WORK ONLY

PAVEMENT & SIGN DELINEATION
SCALE : 1" = 20'



REVISION NUMBER DATE DESCRIPTION BY	PREPARED UNDER THE SUPERVISION OF :  REGISTERED CIVIL ENGINEER <i>Justin W. Harrington</i> DATE: 1/23/2024		DESIGNED: AN CHECKED: DH ROAD NUMBER: --	DRAWN: AN DATE: 8/31/2020	 COUNTY OF EL DORADO DEPARTMENT OF TRANSPORTATION	EL DORADO TRAIL MISSOURI FLAT ROAD PEDESTRIAN OVERCROSSING	SHEET SPD-4 18 OF 42 W.O. No. 97015
	DESIGNER'S SIGNATURE: <i>Justin W. Harrington</i> DATE: 1/23/2024		COUNTY OF EL DORADO DEPARTMENT OF TRANSPORTATION				SHEET SPD-4 18 OF 42 W.O. No. 97015

ORIGINAL SCALE IS IN INCHES
 Drawing name: Z:\Civil_3D\Projects\97015 El Dorado_POC\CADD_Files\Sheets\RW-Sheets.dwg Layout_Tab_RW-1 Feb 05 2024 - 8:47am Dharrington
 FOR REDUCED PLANS

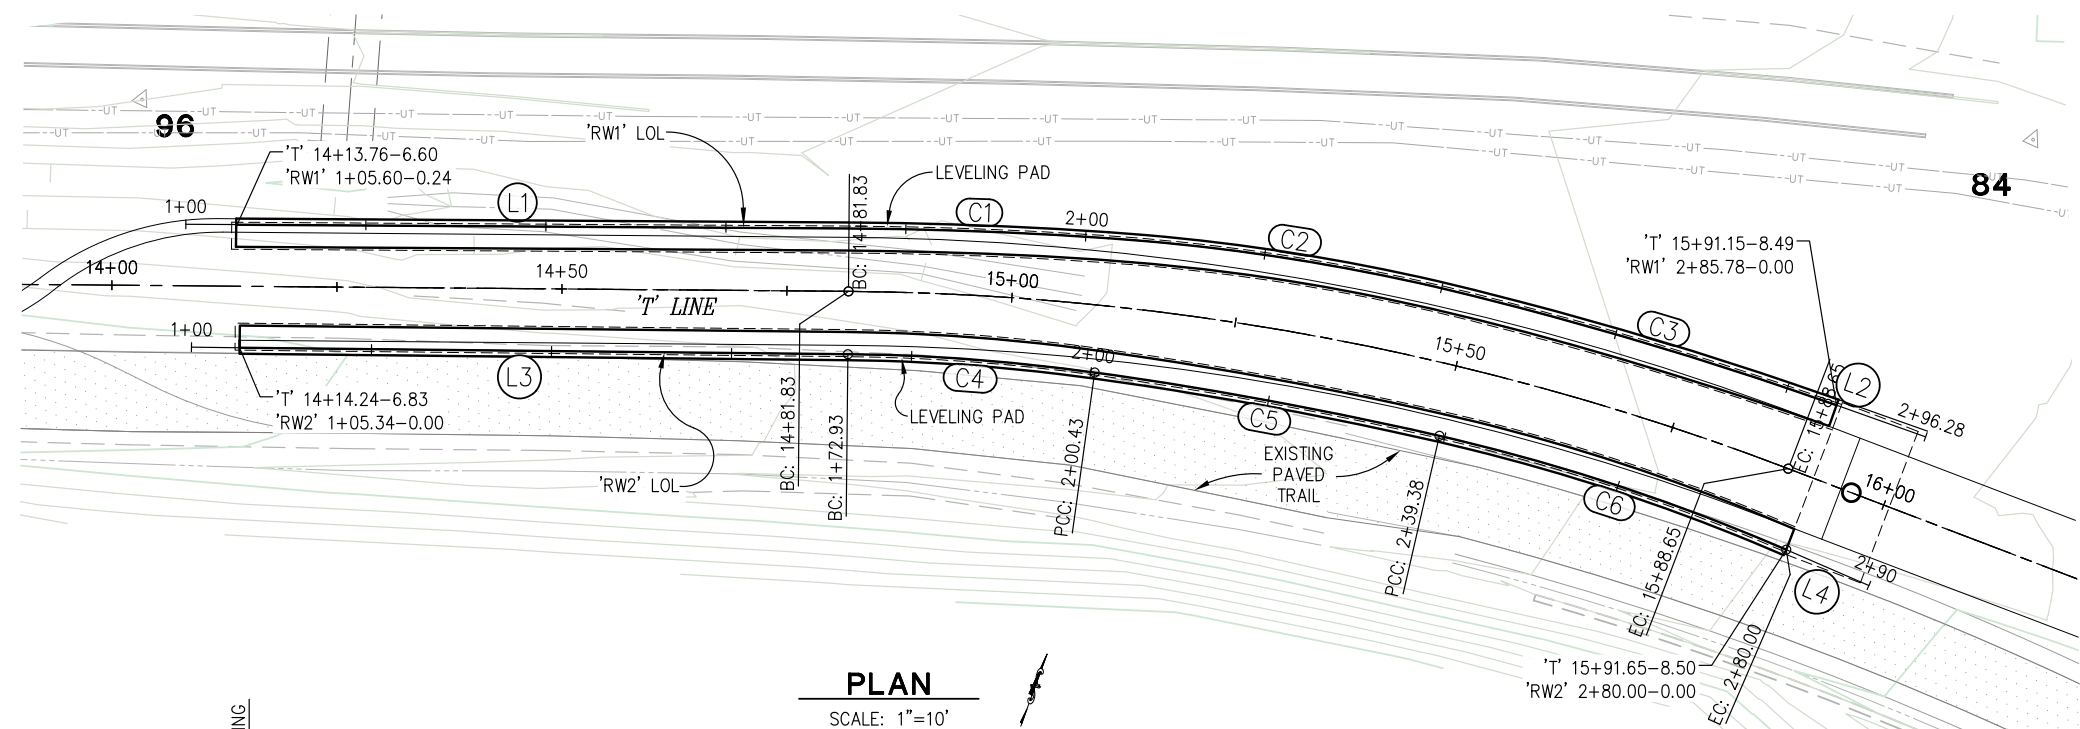

'RW1' LOL				
NUMBER	LENGTH	RADIUS	LINE / CHORD DIRECTION & LENGTH	DELTA
L1	73.67		N 65° 21' 54" E	
C1	28.85	461.18	N 67° 08' 43" E - 28.84	3' 35" 02"
C2	41.06	233.08	N 73° 59' 02" E - 41.01	10' 05' 35"
C3	42.70	444.72	N 81° 46' 51" E - 42.68	5' 30' 03"
L2	10.00		N 84° 31' 52" E	

'RW2' LOL				
NUMBER	LENGTH	RADIUS	LINE / CHORD DIRECTION & LENGTH	DELTA
L3	72.93		N 65° 36' 25" E	
C4	27.50	216.40	N 69° 14' 52" E - 27.48	7' 16' 54"
C5	38.95	441.74	N 75° 24' 54" E - 38.94	5' 03' 09"
C6	40.62	222.58	N 83° 10' 08" E - 40.56	10' 27' 20"
L4	10.00		N 88° 23' 49" E	

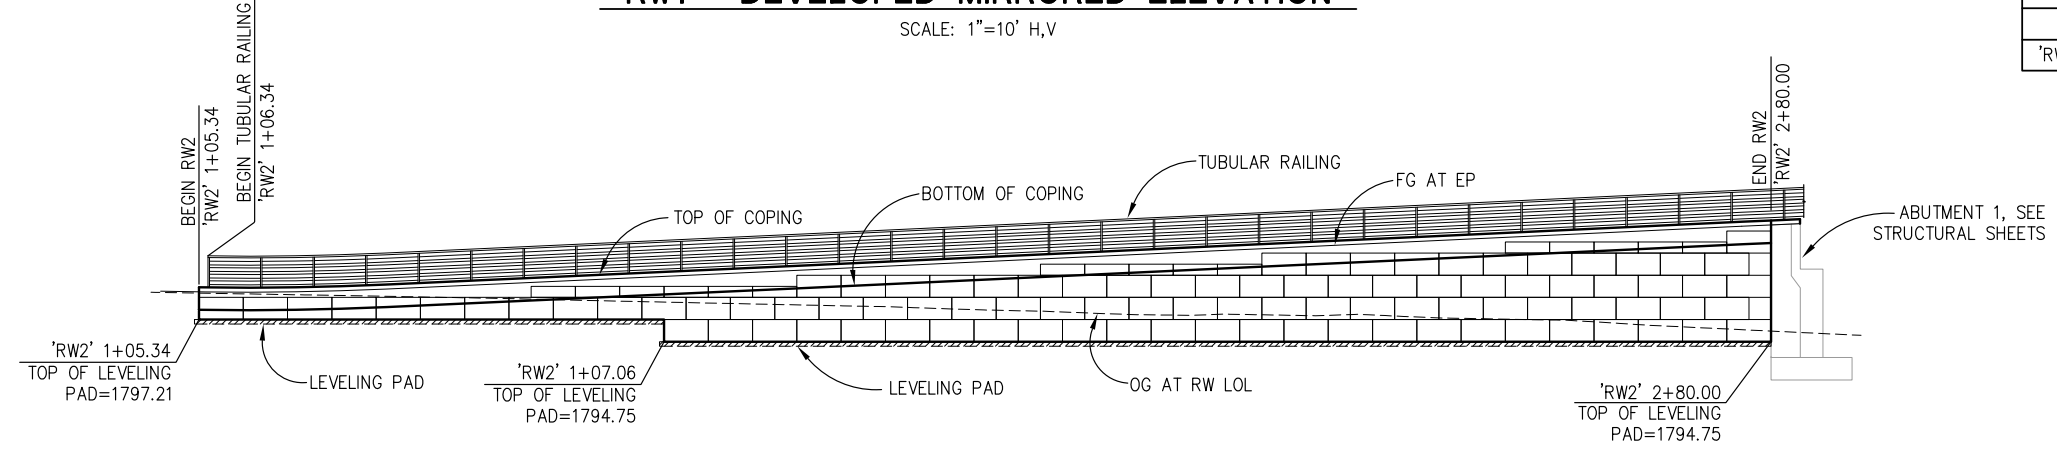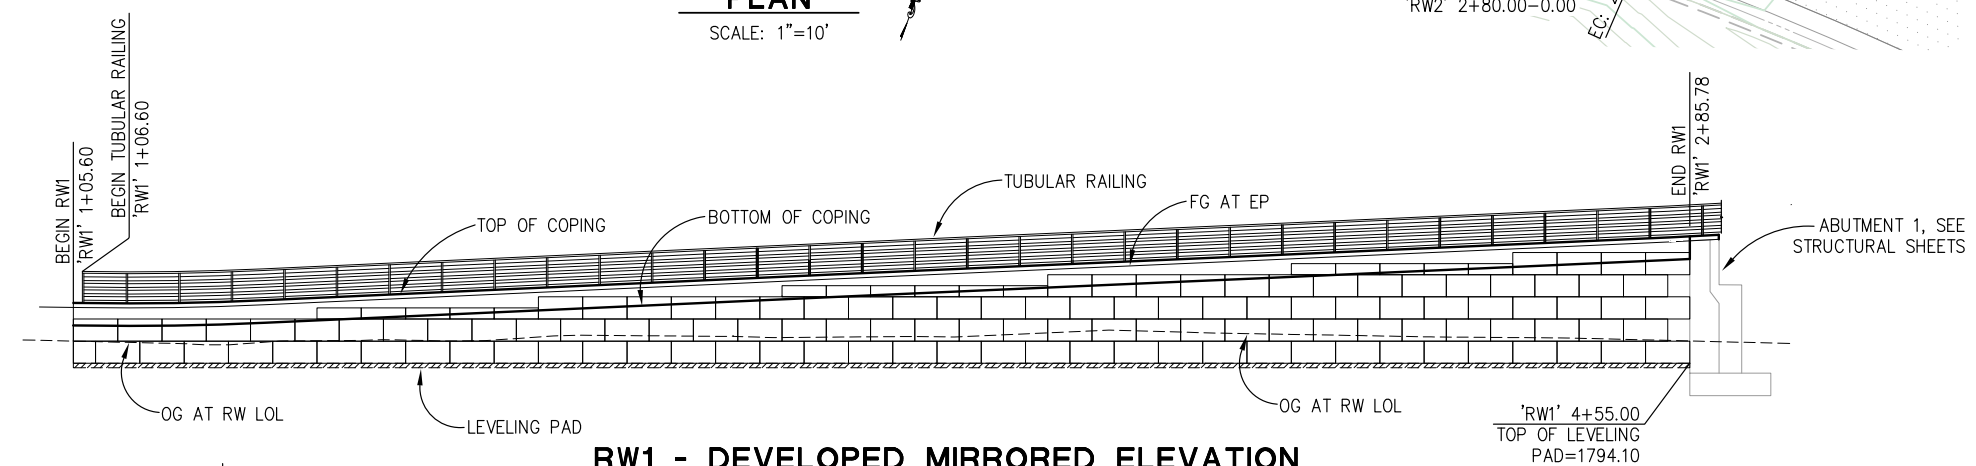

TOP OF COPING ELEVATION TABLE RETAINING WALL 'RW1' & 'RW2'			
'RW1' LINE STATION	TOP OF COPING ELEVATION	'RW2' LINE STATION	TOP OF COPING ELEVATION
'RW1' 1+05.60 (BEGIN)	1800.80	'RW2' 1+05.34 (BEGIN)	1800.79
'RW1' 1+20	1800.86	'RW2' 1+20	1800.88
'RW1' 1+40	1801.69	'RW2' 1+40	1801.73
'RW1' 1+60	1802.60	'RW2' 1+60	1802.64
'RW1' 1+80	1803.51	'RW2' 1+80	1803.56
'RW1' 2+00	1804.40	'RW2' 2+00	1804.49
'RW1' 2+20	1805.28	'RW2' 2+20	1805.42
'RW1' 2+40	1806.16	'RW2' 2+40	1806.35
'RW1' 2+60	1807.05	'RW2' 2+60	1807.29
'RW1' 2+80	1807.94	'RW2' 2+80 (END)	1808.21
'RW1' 2+85.78 (END)	1808.19		

- ELEVATION LEGEND:**
- FULL CAP BLOCK (1.25' x 2.5' x 5')
 - FULL BLOCK (2.5' x 2.5' x 5')
 - HALF BLOCK (2.5' x 2.5' x 2.5')
 - CONCRETE LEVELING PAD (0.5' x 3')

RETAINING WALLS 1 & 2
SCALE : AS SHOWN

REVISION	NUMBER	DATE	DESCRIPTION	BY

PREPARED UNDER THE SUPERVISION OF:

 REGISTERED CIVIL ENGINEER
 DATE: 1/23/2024


DESIGNED: DH	DRAWN: SM
CHECKED: DH	DATE: 10/27/23
ROAD NUMBER: --	

COUNTY OF EL DORADO
DEPARTMENT OF TRANSPORTATION

**EL DORADO TRAIL-
 MISSOURI FLAT ROAD
 BIKE/PEDESTRIAN OVERCROSSING
 PHASE 2**

SHEET	RW-1
19 OF 42	
W.O. No.	97015



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 Drawing name: Z:\Civil_3D\Projects\97015 El Dorado POC\CADD Files\Sheets\RW-Sheets.dwg Layout Tab: RW-2 Feb 05 2024 - 8:47am Dharrington
 FOR REDUCED PLANS
 REVISION
 NUMBER DATE DESCRIPTION BY

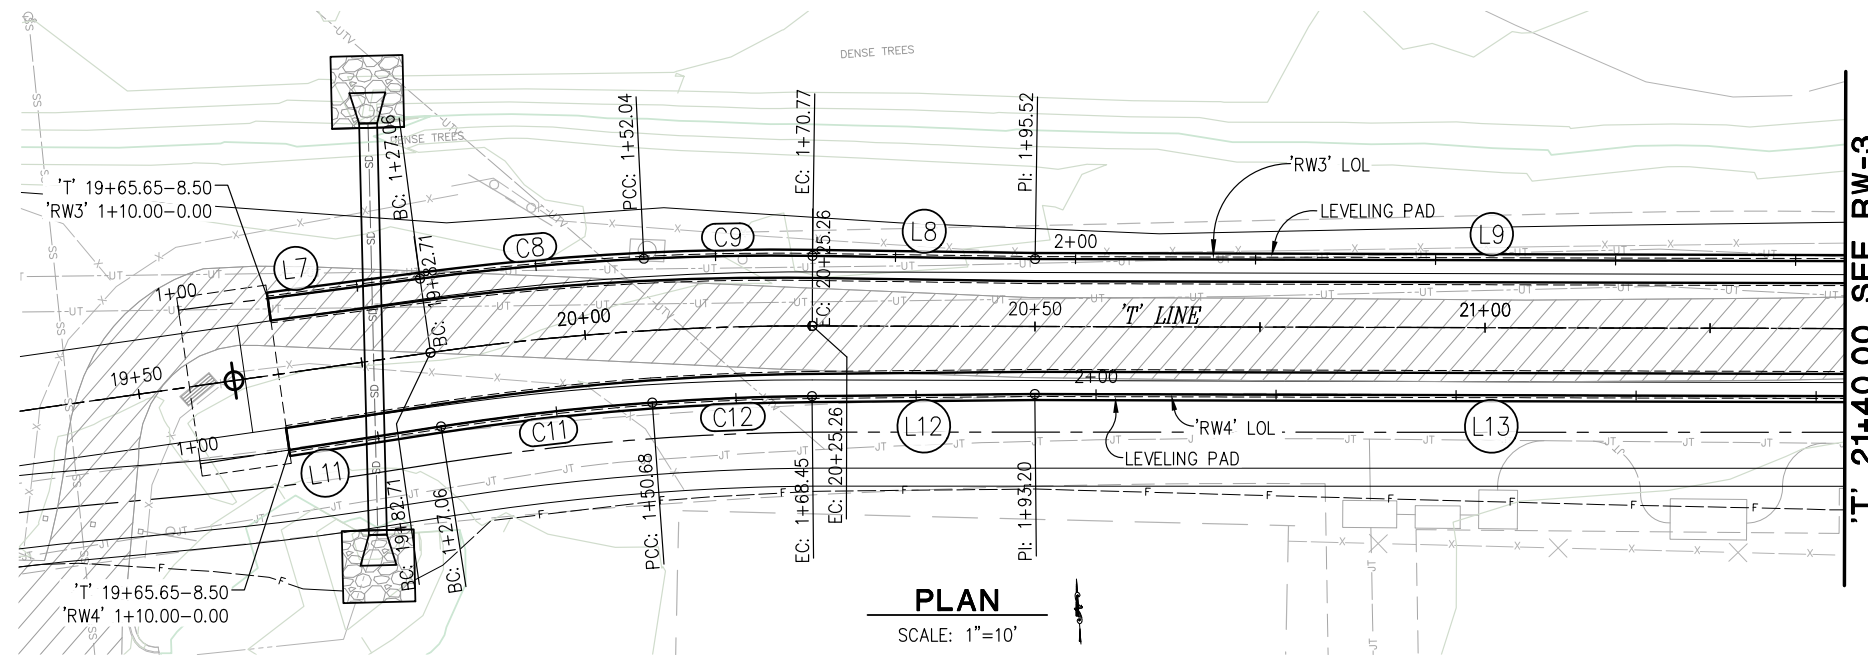

'RW3' LOL				
NUMBER	LENGTH	RADIUS	LINE / CHORD DIRECTION & LENGTH	DELTA
L7	27.06		N 86° 34' 27" E	
C8	24.97	308.60	N 88° 54' 57" E - 24.97	4' 38' 12"
C9	18.73	300.02	S 86° 58' 37" E - 18.73	3' 34' 40"
L8	24.74		S 85° 11' 17" E	
L9	101.45		S 85° 51' 15" E	

'RW4' LOL				
NUMBER	LENGTH	RADIUS	LINE / CHORD DIRECTION & LENGTH	DELTA
L11	27.06		N 85° 11' 19" E	
C11	23.62	285.73	N 87° 31' 43" E - 23.62	4' 44' 14"
C12	17.77	284.22	S 88° 18' 42" E - 17.77	3' 34' 56"
L12	24.74		S 86° 31' 14" E	
L13	101.45		S 85° 51' 15" E	

TOP OF COPING ELEVATION TABLE RETAINING WALL 'RW3' & 'RW4'			
'RW3' LINE STATION	TOP OF COPING ELEVATION	'RW4' LINE STATION	TOP OF COPING ELEVATION
'RW3' 1+10.00 (BEGIN)	1807.06	'RW4' 1+10.00 (BEGIN)	1807.06
'RW3' 1+20	1806.59	'RW4' 1+20	1806.59
'RW3' 1+40	1805.66	'RW4' 1+40	1805.63
'RW3' 1+60	1804.74	'RW4' 1+60	1804.65
'RW3' 1+80	1803.80	'RW4' 1+80	1803.69
'RW3' 2+00	1802.85	'RW4' 2+00	1802.74
'RW3' 2+20	1801.90	'RW4' 2+20	1801.79
'RW3' 2+40	1800.95	'RW4' 2+40	1800.84
'RW3' 2+60	1800.00	'RW4' 2+60	1800.00
'RW3' 2+80	1799.05	'RW4' 2+80	1798.94

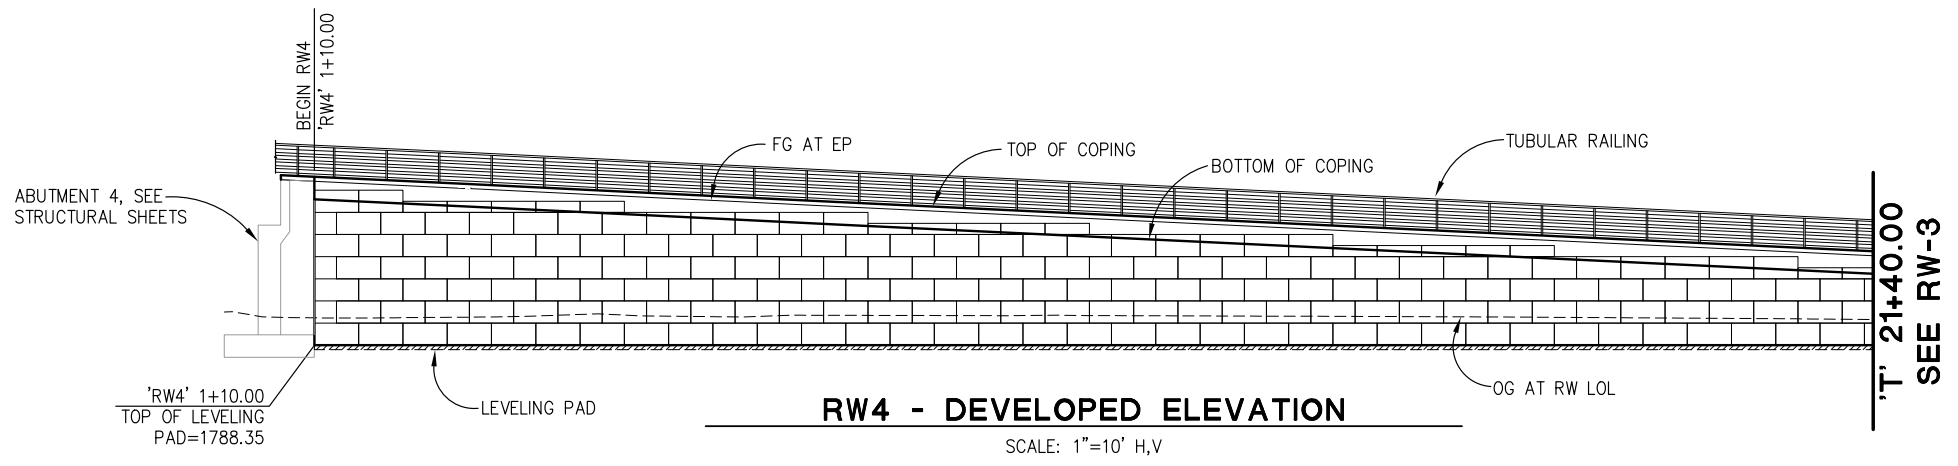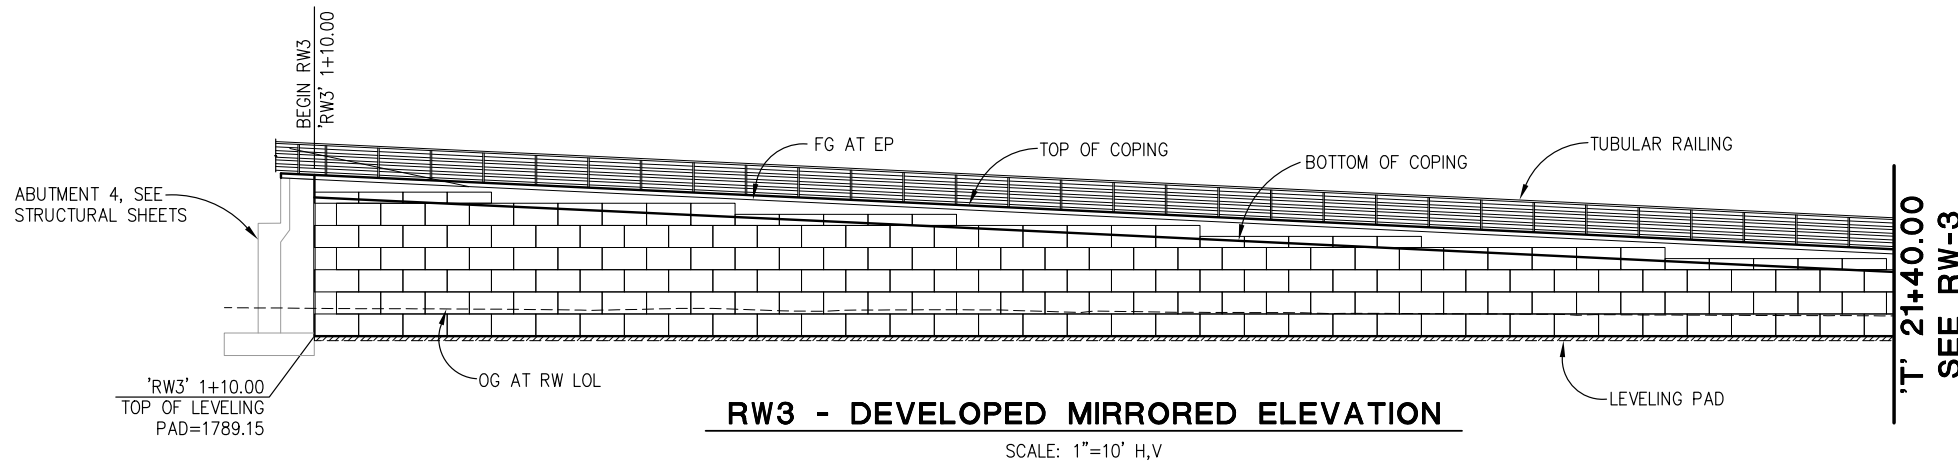


- ELEVATION LEGEND:**
- FULL CAP BLOCK (1.25' x 2.5' x 5')
 - FULL BLOCK (2.5' x 2.5' x 5')
 - HALF BLOCK (2.5' x 2.5' x 2.5')
 - CONCRETE LEVELING PAD (0.5' x 3')

RETAINING WALLS 3 & 4
SCALE : AS SHOWN


	PREPARED UNDER THE SUPERVISION OF: REGISTERED CIVIL ENGINEER DATE: 1/23/2024	DESIGNED: DH DRAWN: SM CHECKED: DH DATE: 06/07/21 ROAD NUMBER: --	 COUNTY OF EL DORADO DEPARTMENT OF TRANSPORTATION	EL DORADO TRAIL- MISSOURI FLAT ROAD BIKE/PEDESTRIAN OVERCROSSING PHASE 2	SHEET RW-2 20 OF 42 W.O. No. 97015
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ORIGINAL SCALE IS IN INCHES
 Drawing name: Z:\Civil_3D\Projects\97015 El Dorado POC\CADD Files\Sheets\RW-Sheets.dwg Layout Tab: RW-3 Feb 05 2024 - 8:47am Dharrington

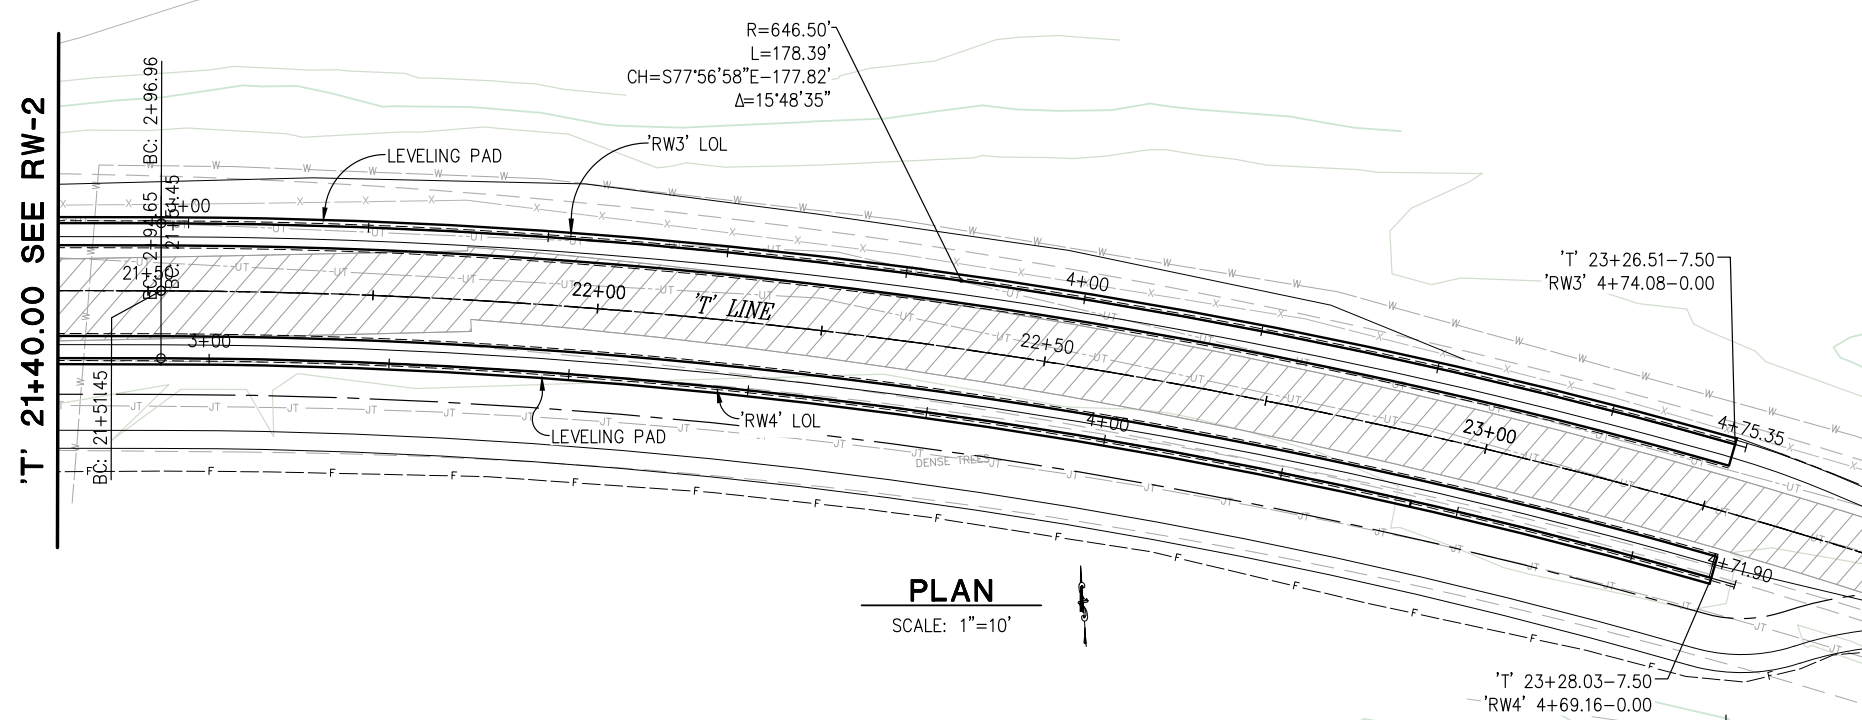


PLAN
SCALE: 1"=10'

TOP OF COPING ELEVATION TABLE RETAINING WALL 'RW3' & 'RW4'			
'RW3' LINE STATION	TOP OF COPING ELEVATION	'RW4' LINE STATION	TOP OF COPING ELEVATION
'RW3' 3+00	1798.10	'RW4' 3+00	1797.99
'RW3' 3+20	1797.27	'RW4' 3+20	1797.16
'RW3' 3+40	1796.62	'RW4' 3+40	1796.55
'RW3' 3+48.51 (BEGIN LANDING)	1796.44	'RW4' 3+45 (BEGIN LANDING)	1796.45
'RW3' 3+59.64 (END LANDING)	1796.24	'RW4' 3+55.87 (END LANDING)	1796.24
'RW3' 3+60	1796.23	'RW4' 3+60	1796.15
'RW3' 3+80	1795.72	'RW4' 3+80	1795.58
'RW3' 4+00	1794.96	'RW4' 4+00	1794.74
'RW3' 4+20	1794.03	'RW4' 4+20	1793.78
'RW3' 4+40	1793.90	'RW4' 4+40	1792.82
'RW3' 4+60	1792.26	'RW4' 4+60	1792.06
'RW3' 4+74.08 (END)	1791.84	'RW4' 4+69.16 (END)	1791.84

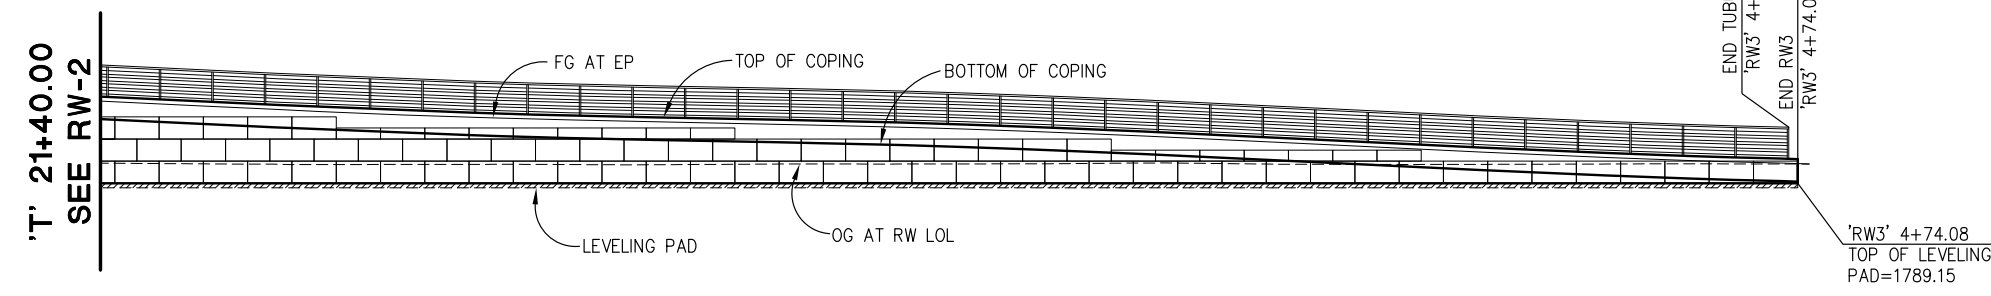

RW3 - DEVELOPED MIRRORED ELEVATION
SCALE: 1"=10' H,V

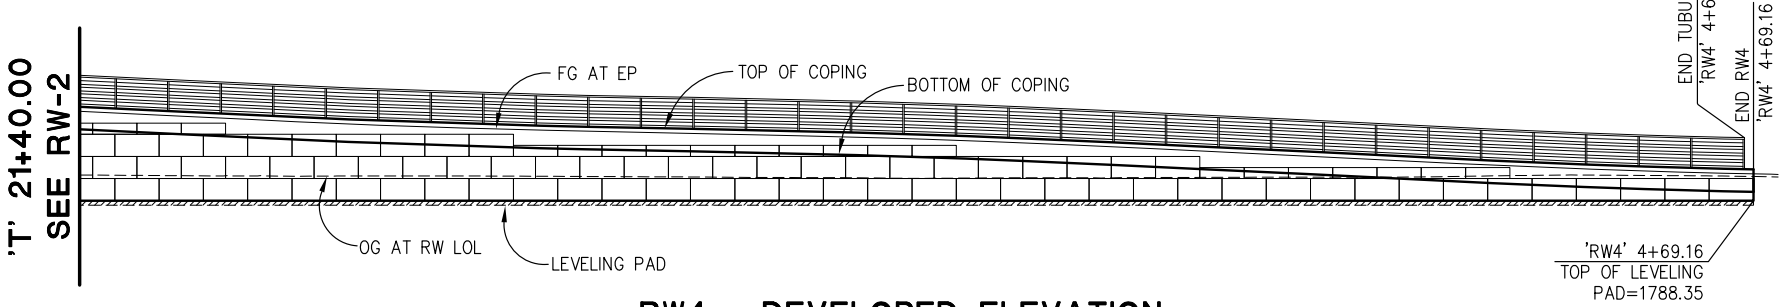


RW4 - DEVELOPED ELEVATION
SCALE: 1"=10' H,V

- ELEVATION LEGEND:**
- FULL CAP BLOCK (1.25' x 2.5' x 5')
 - FULL BLOCK (2.5' x 2.5' x 5')
 - HALF BLOCK (2.5' x 2.5' x 2.5')
 - CONCRETE LEVELING PAD (0.5' x 3')

RETAINING WALLS 3 & 4
SCALE : AS SHOWN

REVISION	NUMBER	DATE	DESCRIPTION	BY

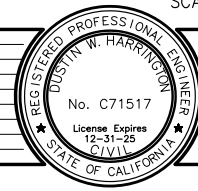

PREPARED UNDER THE SUPERVISION OF:

 REGISTERED CIVIL ENGINEER
 DATE: 1/23/2024

DESIGNED: DH
 DRAWN: SM
 CHECKED: DH
 DATE: 10/27/23
 ROAD NUMBER: --





COUNTY OF EL DORADO
DEPARTMENT OF TRANSPORTATION

EL DORADO TRAIL-
MISSOURI FLAT ROAD
BIKE/PEDESTRIAN OVERCROSSING
PHASE 2

SHEET
RW-3
21 OF 42
W.O. No. **97015**

ORIGINAL SCALE IS IN INCHES
 Drawing name: Z:\Civil_3D\Projects\97015 El Dorado POC\CADD Files\Sheets\RW-Sheets.dwg Layout_Tab_RW-4 - 5:02pm Dharrington
 FOR REDUCED PLANS
 REVISION
 NUMBER DATE DESCRIPTION BY

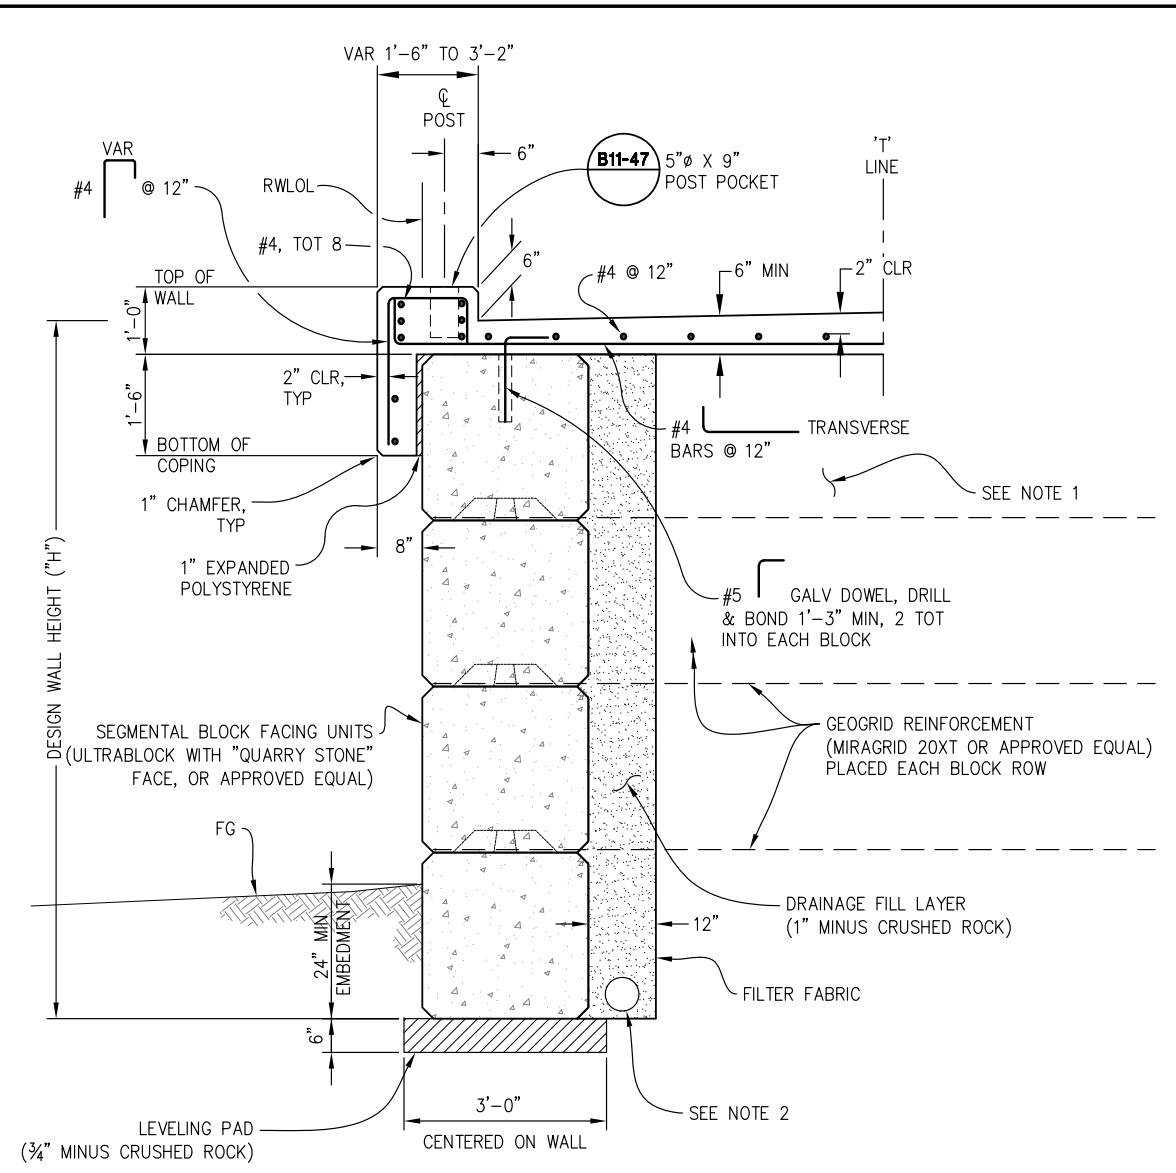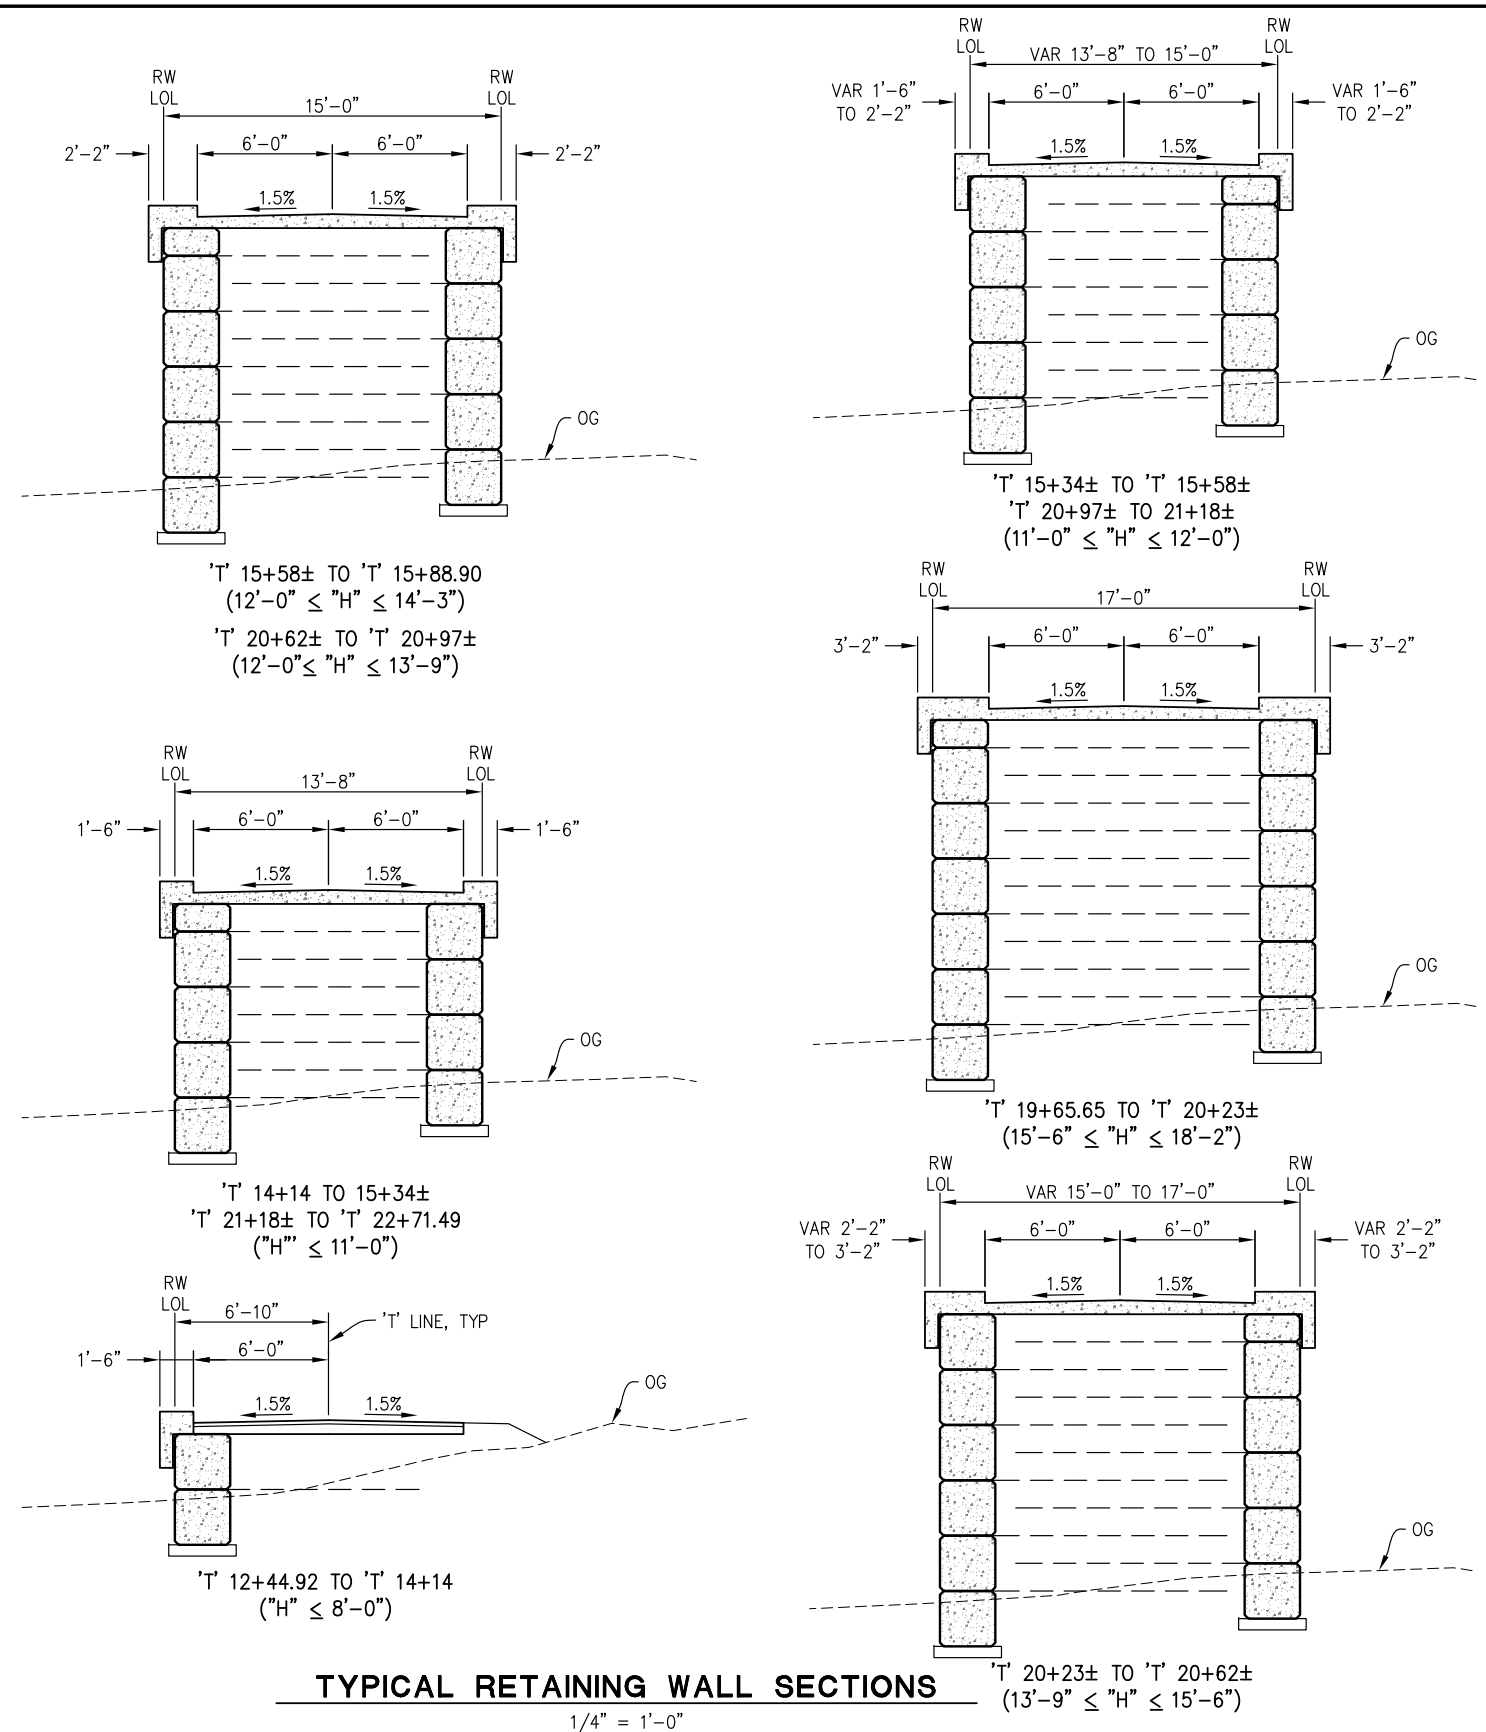

- NOTES:**
- SLURRY CEMENT BACKFILL MAY BE USED BETWEEN SLAB AND STRUCTURE BACKFILL ZONE. MAINTAIN MINIMUM 15" STRUCTURE BACKFILL (GRANULAR) MATERIAL ABOVE TOP GEOGRID REINFORCEMENT.
 - PERFORATED PLASTIC PIPE TO BE 8" DIA CORRUGATED HDPE OR 4" DIA SMOOTH WALL PVC.
 - TUBULAR RAILING NOT SHOWN FOR CLARITY.

REVISION	NUMBER	DATE	DESCRIPTION	BY



PREPARED UNDER THE SUPERVISION OF:
 [Signature]
 REGISTERED CIVIL ENGINEER
 DATE: 4/9/2024

DESIGNED: DH
 DRAWN: SM
 CHECKED: DH
 DATE: 3/5/2024
 ROAD NUMBER: --




COUNTY OF EL DORADO
 DEPARTMENT OF TRANSPORTATION


EL DORADO TRAIL-
 MISSOURI FLAT ROAD
 BIKE/PEDESTRIAN OVERCROSSING
 PHASE 2

SHEET
RW-4
 22 OF 42
 W.O. No. 97015

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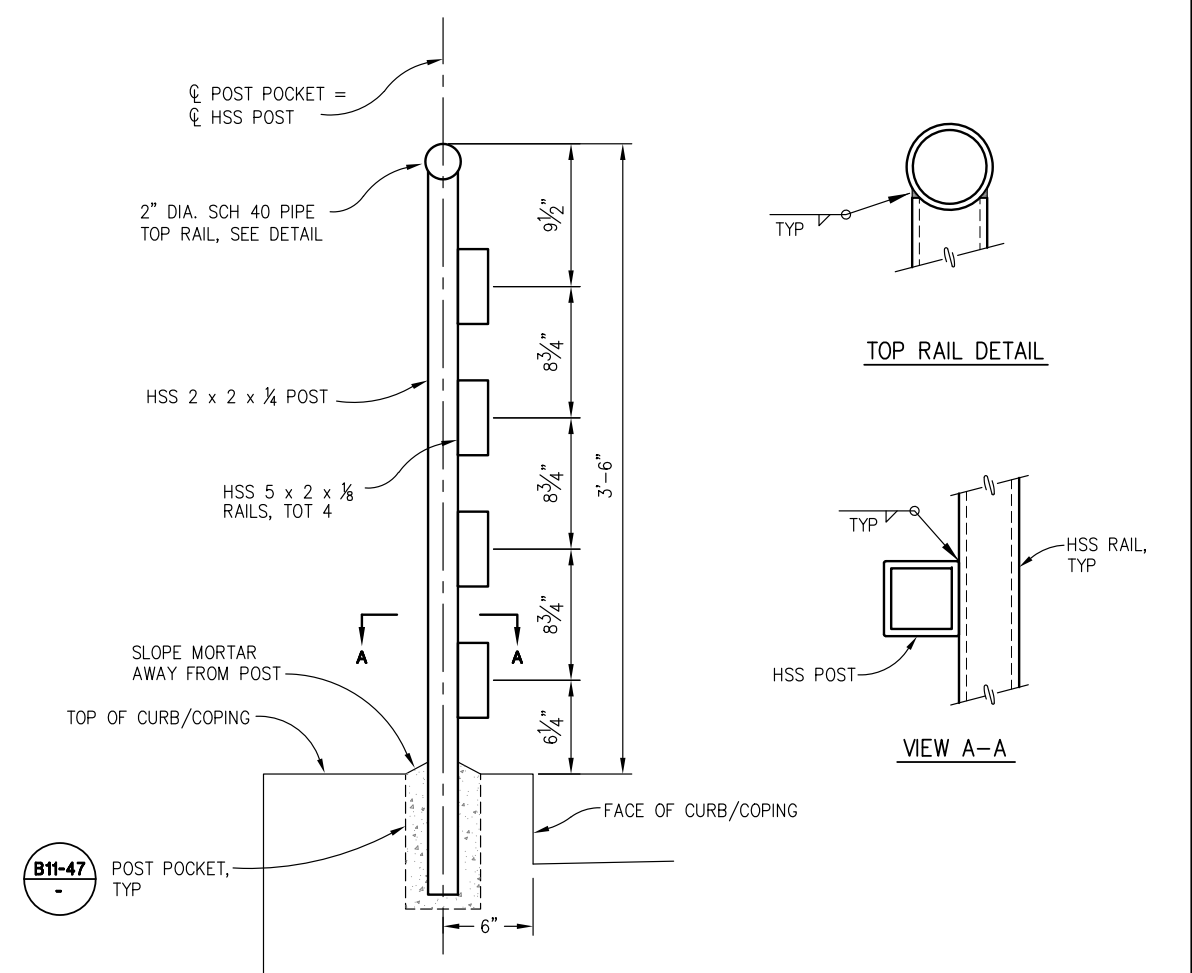


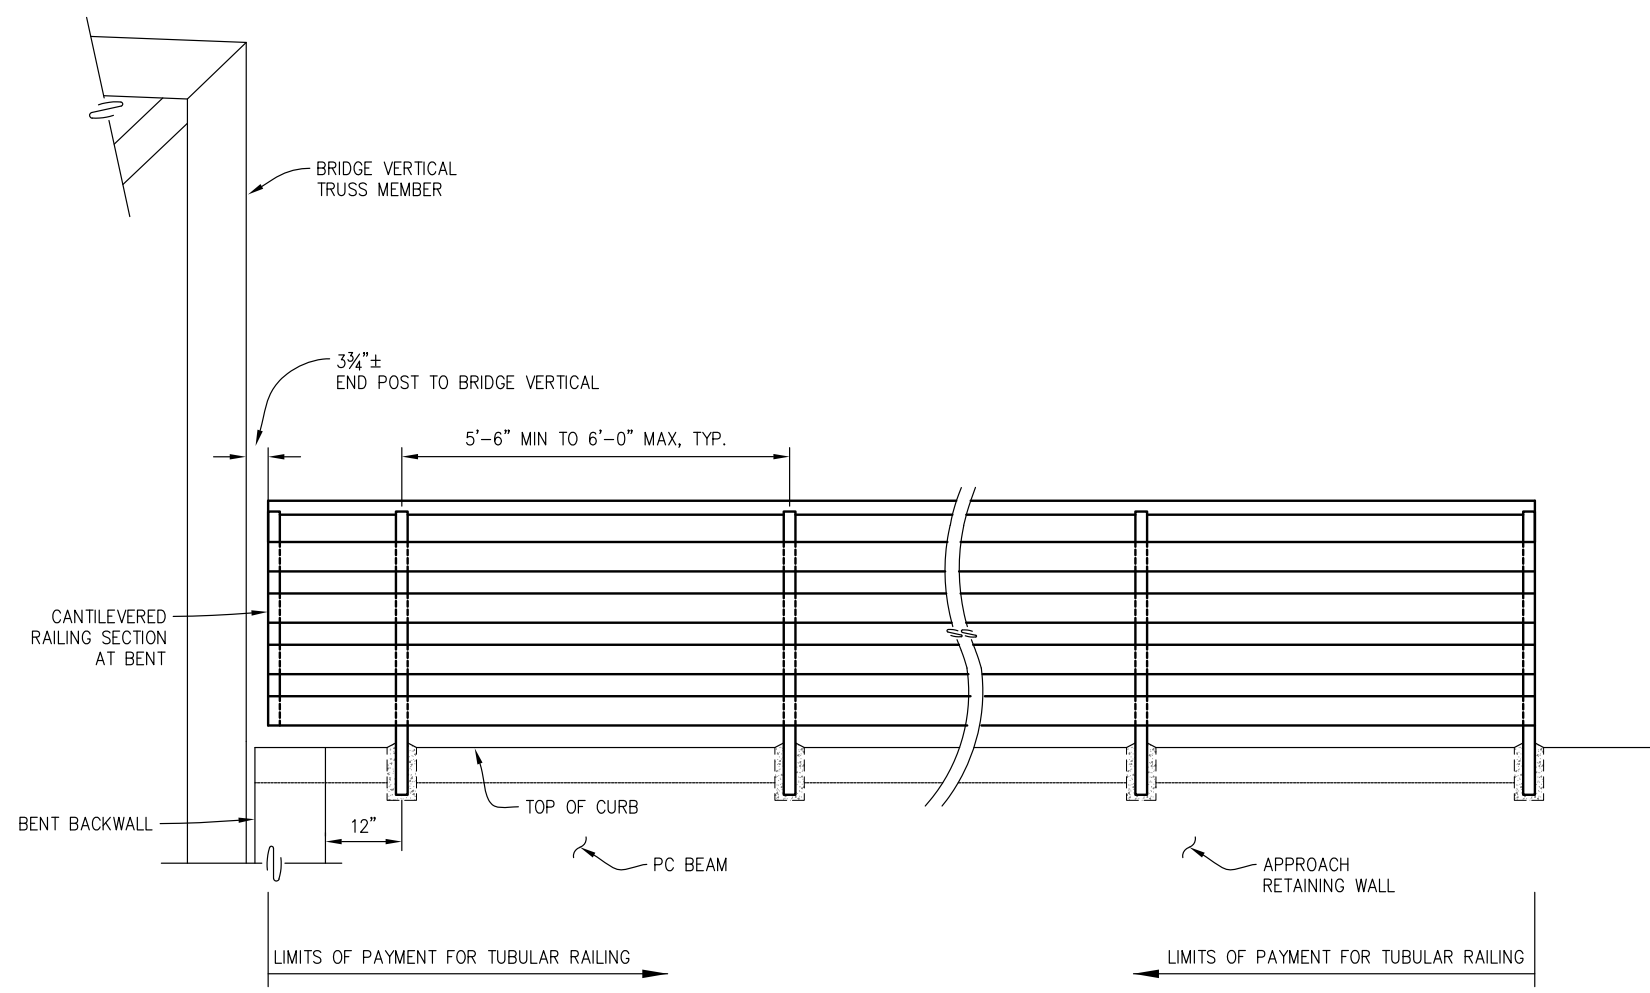ELEVATION
NO SCALE

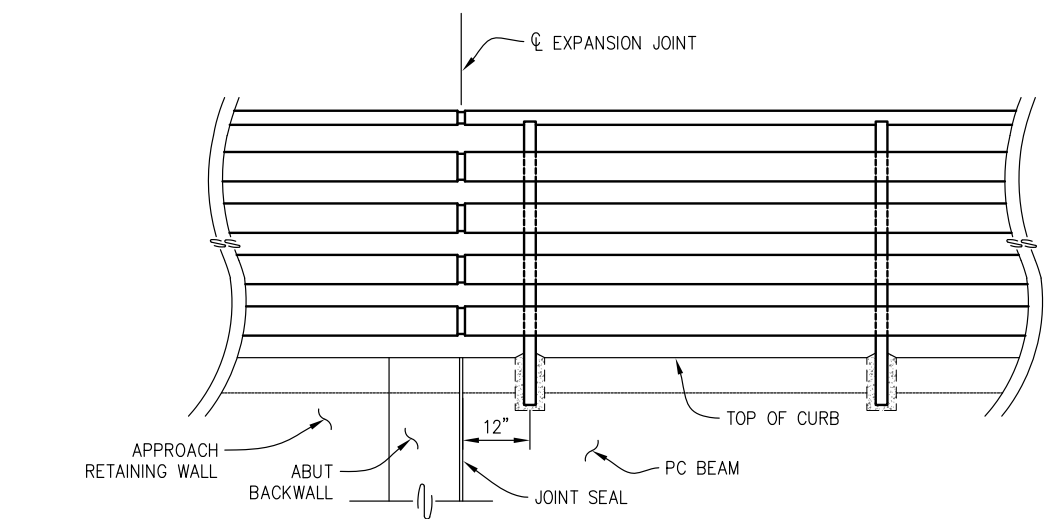


EXPANSION JOINT LOCATION
NO SCALE

- GENERAL NOTES:**
1. ALL HSS POSTS AND RAILS SHALL BE A847 WEATHERING STEEL.
 2. RAIL TUBES SHALL BE SHOP BENT OR FABRICATED TO FIT HORIZONTAL AND VERTICAL CURVES.
 3. POSTS SHALL BE VERTICAL.
 4. HORIZONTAL RAILING MEMBERS SHALL NOT HAVE OPENINGS WHICH ALLOW PASSAGE OF A SPHERE 4 INCHES IN DIAMETER.



RAILING DETAILS

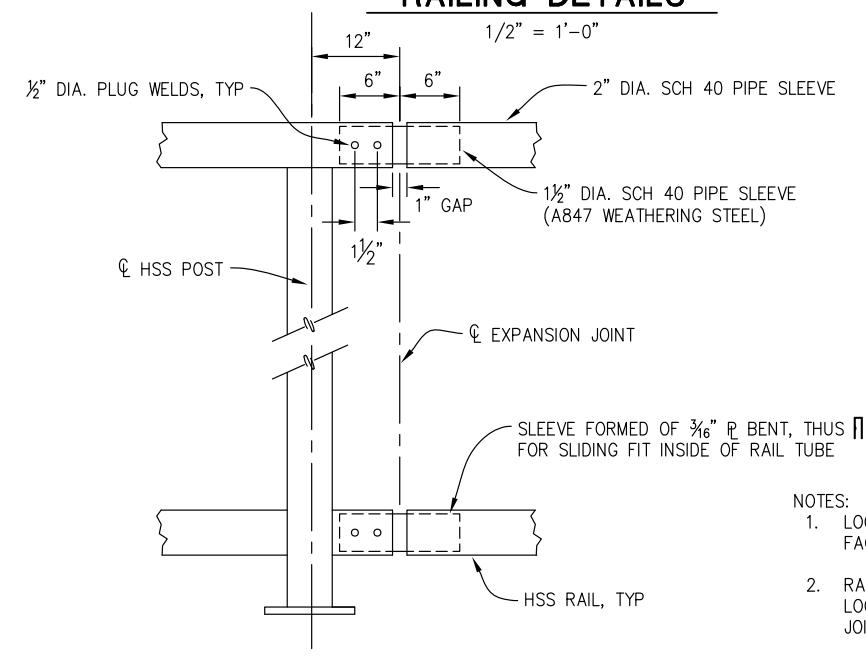

EXPANSION JOINT DETAIL
NO SCALE

- NOTES:**
1. LOCATE PLUG WELDS ON OUTSIDE FACE OF RAILING.
 2. RAILING EXPANSION JOINTS TO BE LOCATED AT ABUT 1 & ABUT 4 JOINT SEALS.
 3. ALL RAILS NOT SHOWN FOR CLARITY.

TUBULAR RAILING DETAILS
SCALE : AS SHOWN

REVISION	NUMBER	DATE	DESCRIPTION	BY



PREPARED UNDER THE SUPERVISION OF :

Dustin W. Harrington

REGISTERED CIVIL ENGINEER

4/9/2024

DESIGNED: DH
DRAWN: SM
CHECKED: DH
DATE: 3/5/2024
ROAD NUMBER: --




COUNTY OF EL DORADO
DEPARTMENT OF TRANSPORTATION


**EL DORADO TRAIL-
MISSOURI FLAT ROAD
BIKE/PEDESTRIAN OVERCROSSING
PHASE 2**

SHEET
RW-5
23 OF 42
W.O. No. **97015**


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 FOR REDUCED PLANS REVISION NUMBER DATE DESCRIPTION BY

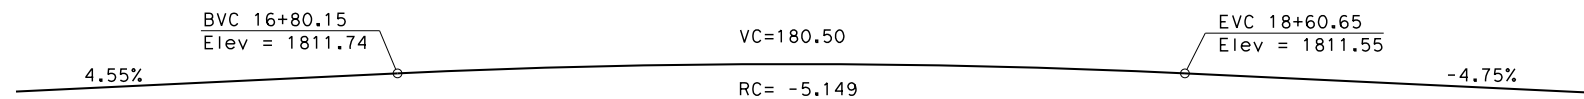


PROFILE GRADE
NO SCALE

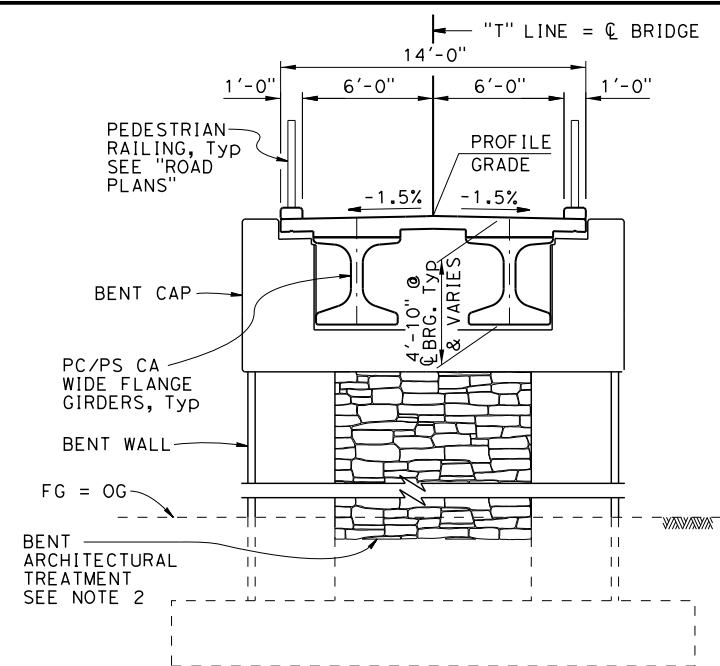


SECTION A-A
1/4"=1'-0"

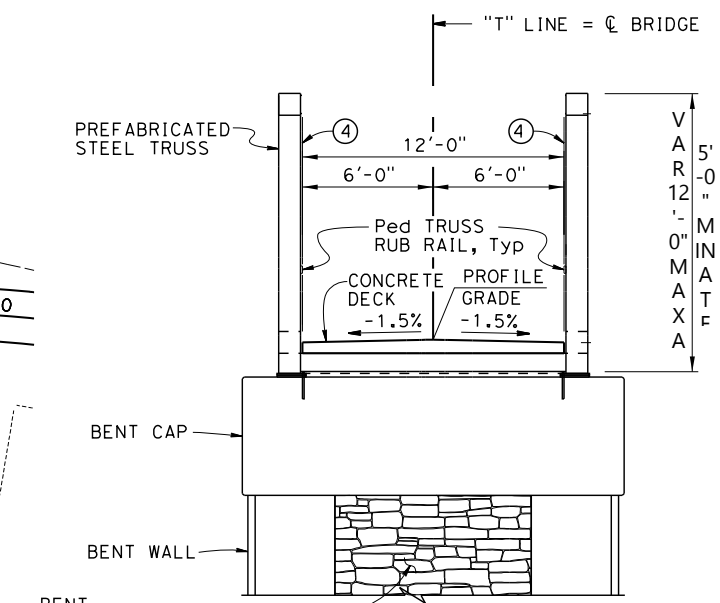

SECTION B-B
1/4"=1'-0"

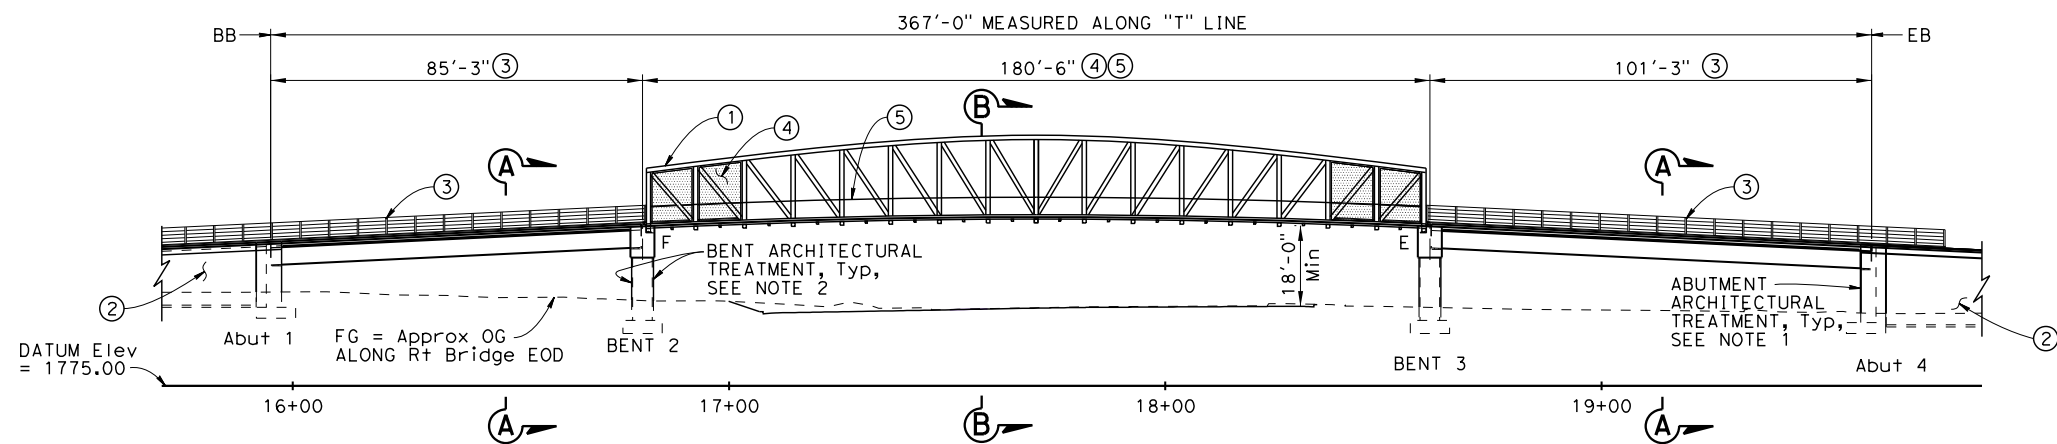

ELEVATION
1"=20'

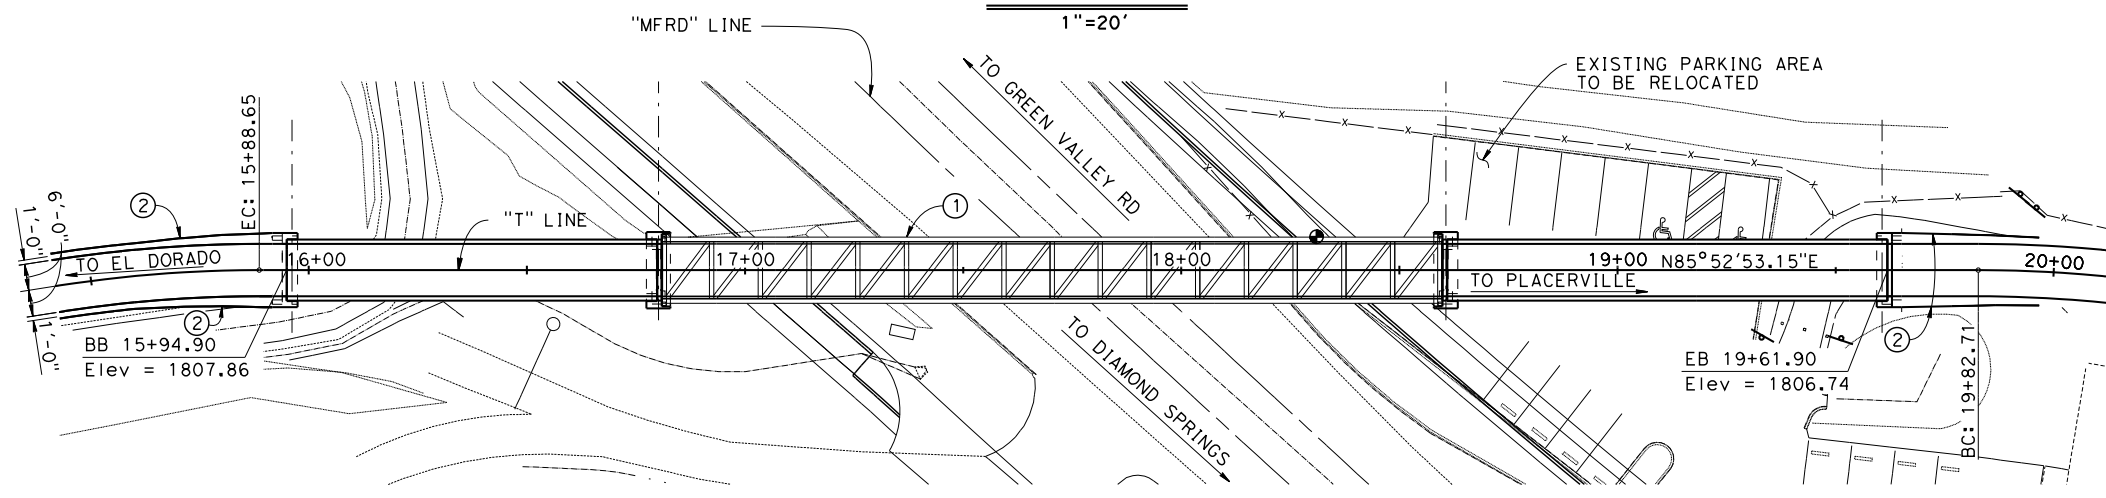

PLAN
1"=20'


- LEGEND:**
- ① Prefabricated Weathering Steel Truss
 - ② Approach Wall see "ROAD PLANS"
 - ③ Pedestrian Railing see "ROAD PLANS"
 - ④ Wire mesh panel, typical each bay
 - ⑤ Pedestrian Truss Railing
 - Indicates Point of Minimum Vertical Clearance

- NOTES:**
1. See "ABUTMENT 1 LAYOUT", "ABUTMENT 2 LAYOUT" and "ABUTMENT DETAILS NO. 3" sheets for limits of abutment architectural treatment.
 2. See "BENT DETAILS NO. 3" sheet for limits of bent architectural treatment.

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Michael M. Wolohan
REGISTERED CIVIL ENGINEER
DATE: 1/23/2024

DESIGNED: M. W. H.H.
DRAWN: H.H.
CHECKED: DATE: 3/6/2020
P. B.
ROAD NUMBER:

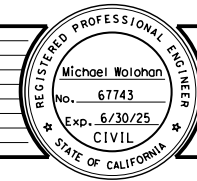

COUNTY OF EL DORADO
DEPARTMENT OF TRANSPORTATION

EL DORADO TRAIL
MISSOURI FLAT ROAD
PEDESTRIAN OVERCROSSING

GENERAL PLAN
SCALE AS SHOWN

SHEET
S-1
24 OF 42
W.D. No.


**GENERAL NOTES
LOAD AND RESISTANCE FACTOR DESIGN**

DESIGN: AASHTO LRFD Bridge Design Specifications, 6th Edition and the Caltrans Amendments, preface dated January 2014
AASHTO LRFD Guide Specification for the Design of Pedestrian Bridges, December 2009 with 2015 Interims

SEISMIC DESIGN: Caltrans Seismic Design Criteria (SDC) Version 2.0 April 2019

LIVE LOADING: H-10, 90 psf Pedestrian Live Load
Live load deflection shall not exceed L/360.

SEISMIC LOADING: Soil Profile: Vs30 = 2493 ft/sec
Moment Magnitude: Mmax = 6.3±0.25
Peak Ground Acceleration 0.20g

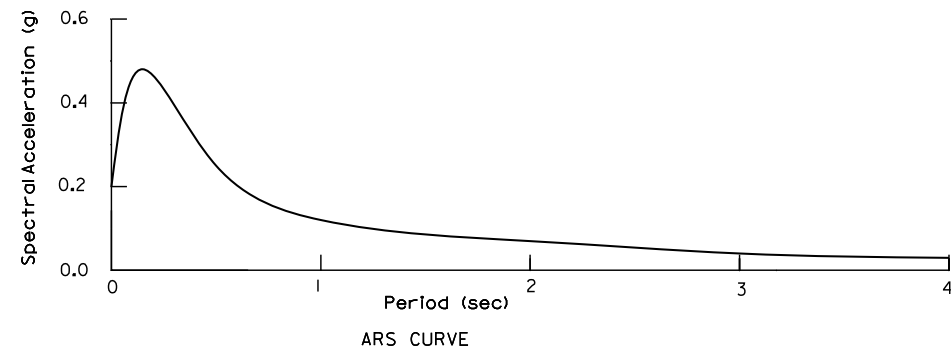

REINFORCED CONCRETE: fy = 60 ksi
f'c = 3.6 ksi, (EXCEPT AS SHOWN ON "CONCRETE STRENGTHS AND TYPE LIMITS")
n = 8

PRESTRESSED CONCRETE: See prestressing notes on "GIRDER LAYOUT NO. 1" sheet.

STRUCTURAL STEEL: TUBULAR SECTIONS - ASTM A847; fy = 50 ksi
PLATES & STRUCTURAL SHAPES - ASTM A709 GRADE 50W; fy = 50 ksi




- STRUCTURAL CONCRETE, BRIDGE (POLYMER FIBER, 4.0 KSI @ 28 DAYS)
- STRUCTURAL CONCRETE, BRIDGE (4.0 KSI @ 28 DAYS)
- PC/PS CONCRETE GIRDER, SEE "GIRDER DETAILS"
- STRUCTURAL CONCRETE, BRIDGE FOOTING (3.6 KSI @ 28 DAYS)

CONCRETE STRENGTHS AND TYPE LIMITS

No Scale

STANDARD PLANS DATED, 2022

DETAIL	DESCRIPTION
A3A	Abbreviations (sheet 1 of 3)
A3B	Abbreviations (sheet 2 of 3)
A3C	Abbreviations (sheet 3 of 3)
A10A	Legend-Lines and Symbols (sheet 1 of 5)
A10B	Legend-Lines and Symbols (sheet 2 of 5)
A10C	Legend-Lines and Symbols (sheet 3 of 5)
A10D	Legend-Lines and Symbols (sheet 4 of 5)
A10E	Legend-Lines and Symbols (sheet 5 of 5)
A62C	Limits of Payment for Excavation and Backfill - Bridge
RSP B0-1	Bridge Details
RSP B0-3	Bridge Details
B0-5	Bridge Details
B0-13	Bridge Details
B6-21	Joint Seals (Maximum Movement Rating = 2")
RSP B11-47	Cable Railing

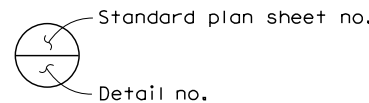


INDEX TO BRIDGE PLANS

SHEET NO.	TITLE
24	GENERAL PLAN
25	INDEX TO PLANS
26	DECK CONTOURS
27	FOUNDATION PLAN
28	ABUTMENT 1 LAYOUT
29	ABUTMENT 4 LAYOUT
30	ABUTMENT DETAILS NO. 1
31	ABUTMENT DETAILS NO. 2
32	ABUTMENT DETAILS NO. 3
33	BENT DETAILS NO. 1
34	BENT DETAILS NO. 2
35	BENT DETAILS NO. 3
36	TYPICAL SECTION
37	PRECAST GIRDER LAYOUT
38	PRECAST GIRDER DETAILS NO. 1
39	PRECAST GIRDER DETAILS NO. 2
40	PRECAST GIRDER DETAILS NO. 3
41	LOG OF TEST BORINGS 1 OF 2
42	LOG OF TEST BORINGS 2 OF 2

QUANTITIES

STRUCTURE EXCAVATION (BRIDGE)	320	CY
STRUCTURE BACKFILL (BRIDGE)	128	CY
FURNISH PRECAST PRESTRESSED CONCRETE GIRDER (80'-90')	2	EA
FURNISH PRECAST PRESTRESSED CONCRETE GIRDER (100'-110')	2	EA
ERECT PRECAST PRESTRESSED CONCRETE GIRDER	4	EA
STRUCTURAL CONCRETE, BRIDGE FOOTING	108	CY
STRUCTURAL CONCRETE, BRIDGE	218	CY
STRUCTURAL CONCRETE, BRIDGE (POLYMER FIBER)	183	CY
JOINT SEAL (MR 1/2")	60	LF
BAR REINFORCING STEEL (BRIDGE)	77,580	LB
MINOR CONCRETE (BRIDGE CURB)	7	CY
TUBULAR RAILING	1,888	LF
FURNISH & INSTALL PREFABRICATED STEEL TRUSS (VARIABLE DEPTH)	1	LS
ARCHITECTURAL TREATMENT	10,000	SF

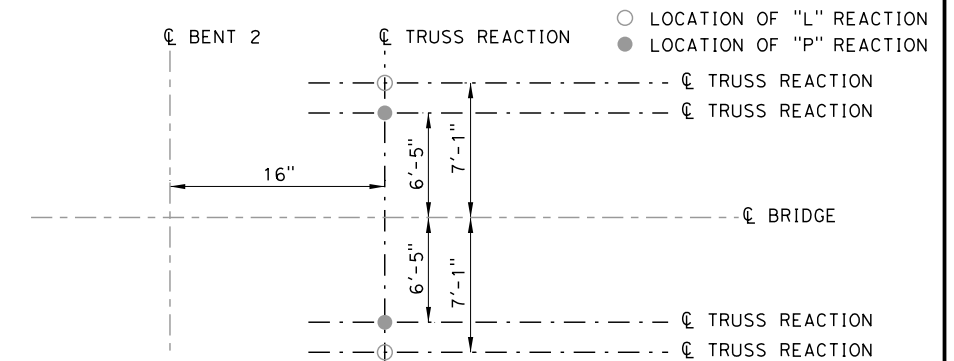

PREFABRICATED STEEL TRUSS REACTION LOCATIONS

(BENT 2 SHOWN, BENT 3 SIMILAR)

INDEX TO PLANS
SCALE AS SHOWN


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Michael M. Wolohan
REGISTERED CIVIL ENGINEER
DATE: 1/23/2024

DESIGNED: M. W.
DRAWN: H. H.
CHECKED: DATE:
P. B. 3/6/2020
ROAD NUMBER:




COUNTY OF EL DORADO
DEPARTMENT OF TRANSPORTATION

EL DORADO TRAIL
MISSOURI FLAT ROAD
PEDESTRIAN OVERCROSSING

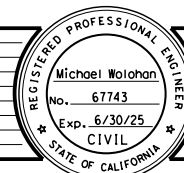SHEET
S-2
25 OF 42
W.D. No.

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 FOR REDUCED PLANS REVISION NUMBER DATE DESCRIPTION BY

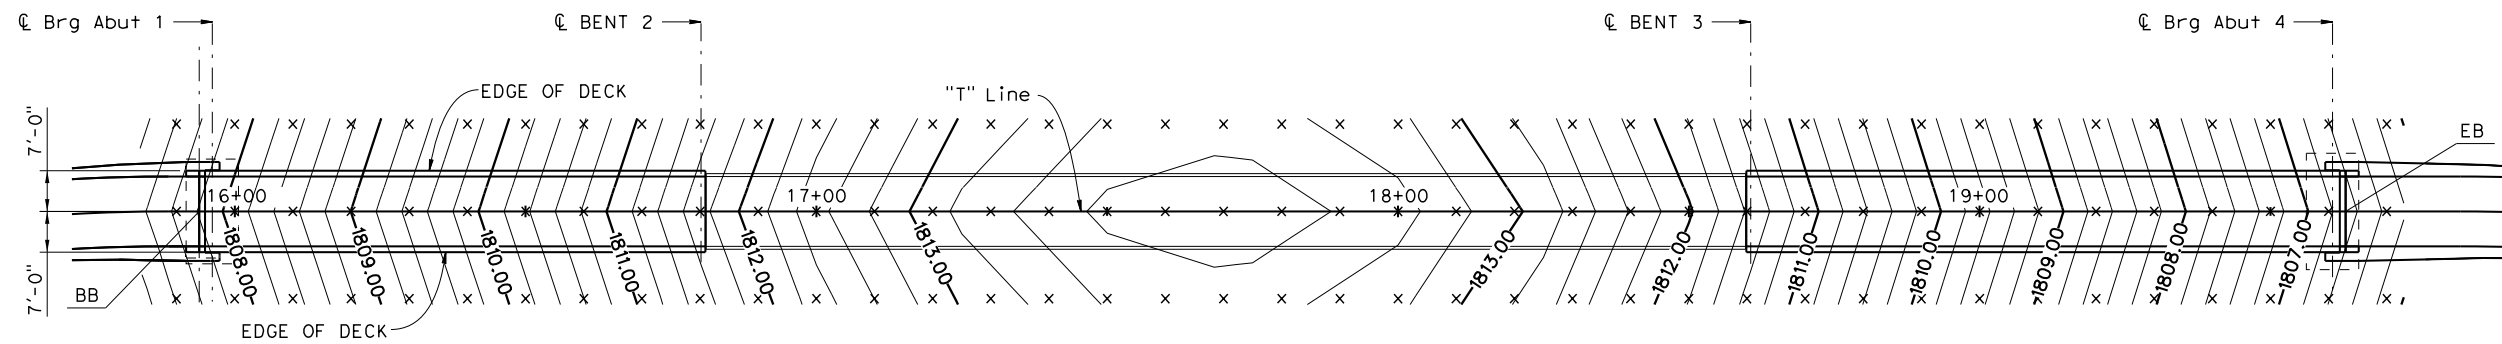

Notes:

1. Contour Intervals = 0.20 feet.
2. Contours do not include camber.
3. x - Indicates 10' interval measured along station line.



DECK CONTOURS


1"=15'

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CHECKED: P. B.	DATE: 3/6/2020
ROAD NUMBER:	



COUNTY OF EL DORADO
DEPARTMENT OF TRANSPORTATION

EL DORADO TRAIL
MISSOURI FLAT ROAD
PEDESTRIAN OVERCROSSING

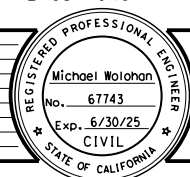DECK CONTOURS
SCALE AS SHOWN


SHEET S-3
26 OF 42
W.D. No.

SPREAD FOOTING DATA TABLE

Location	SERVICE ² PERMISSIBLE NET CONTACT STRESS (ksf)	STRENGTH/CONSTRUCTION ³ FACTORED GROSS NOMINAL BEARING RESISTANCE $\phi_b = 0.45$ (ksf)	EXTREME EVENT ³ FACTORED GROSS NOMINAL BEARING RESISTANCE $\phi_b = 1.00$ (ksf)
Abut 1	22.5	9.5	N/A
BENT 2	20.0	21.9	19.0
BENT 3	22.0	22.9	21.1
Abut 4	10.5	7.4	N/A

Notes:

1. Stresses and resistances were calculated for controlling load combinations.
2. Controlling load combination for Service Limit State is the one resulting in the highest ratio of $q_{n,u} / q_{pn}$ for foundations on soil.
3. For Strength, Construction, and Extreme Event limit States, controlling load combination is the one resulting in the highest ratio of $q_{g,u} / q_R$ for foundations on soil.

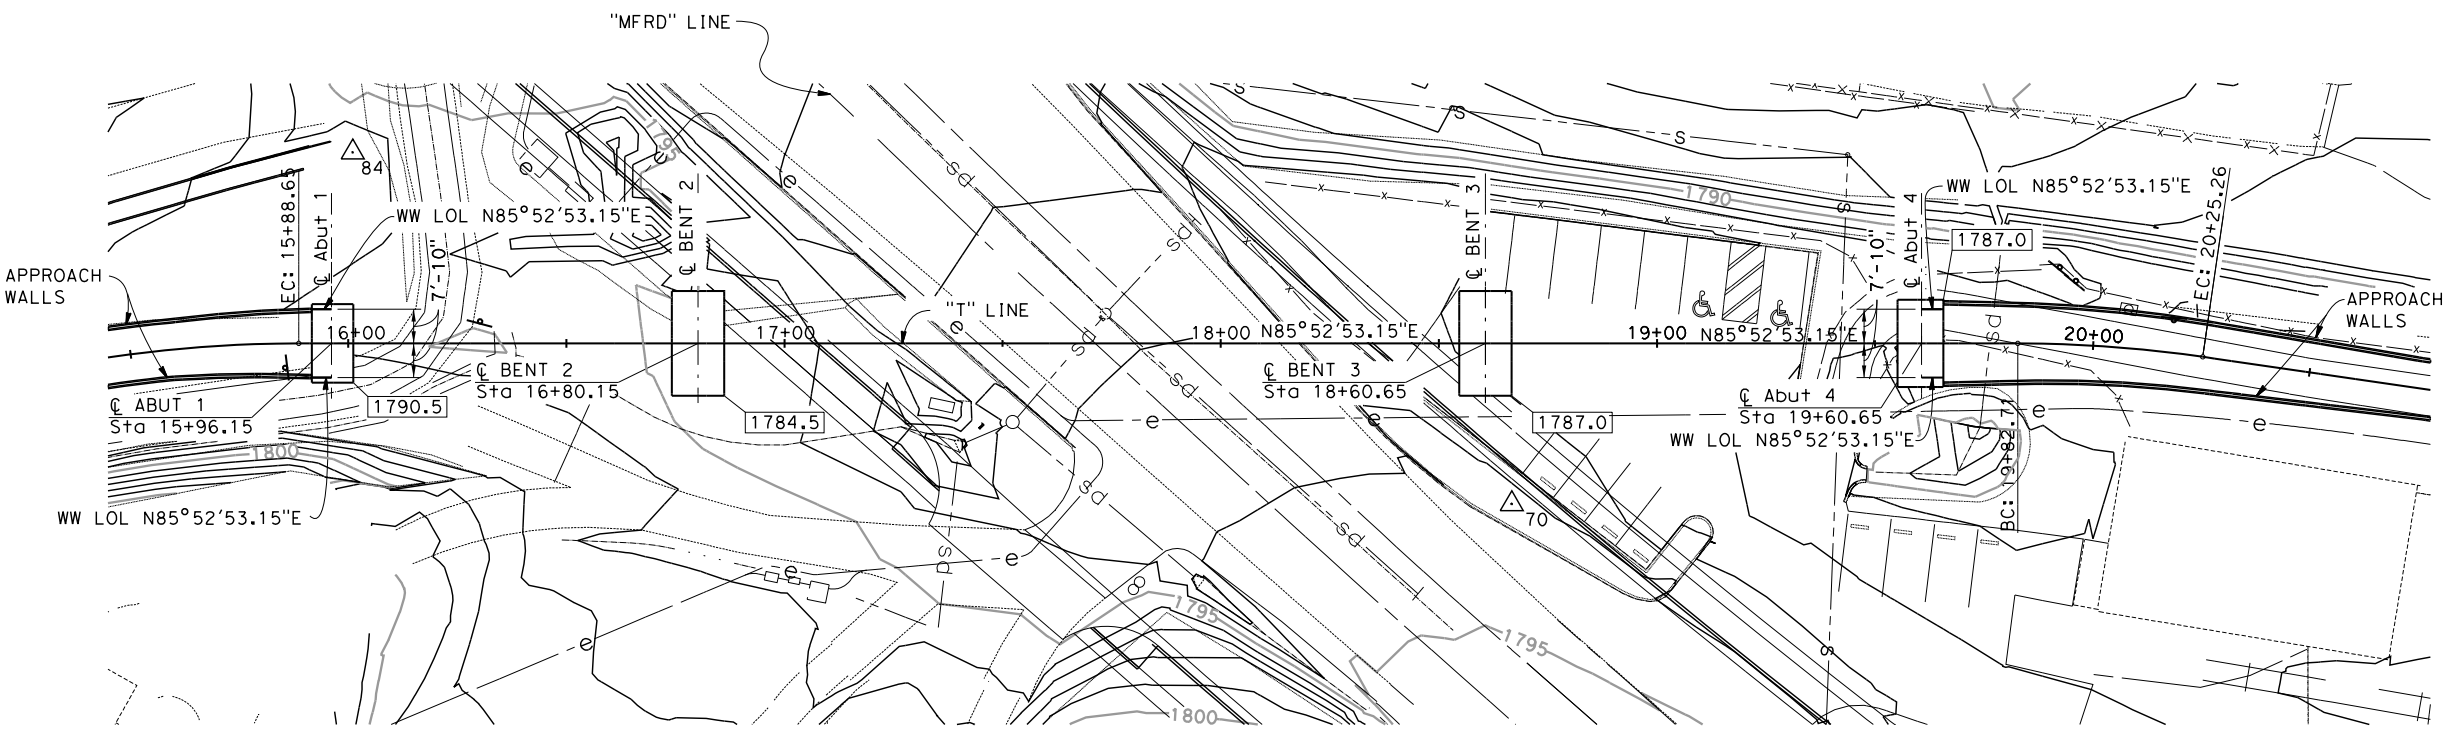

	NORTHING	EASTING
① C. Abut 1 Sta 15+96.15	2020188.98	6896435.65
② C. Abut 4 Sta 19+60.65	2020215.16	6896799.21



- Legend:**
- Indicates bottom of footing elevation
 - Indicates New Structure
 - Indicates Survey Control Point
 - e- Underground Electrical
 - sd- Storm Drain
 - s- Sanitary Sewer


**FOUNDATION PLAN
SCALE 1"=20'**

FOR REDUCED PLANS
0
1
2
ORIGINAL SCALE IS IN INCHES
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1/23/2024
TIME PLOTTED => 5:50:44 PM

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ROAD NUMBER:




**COUNTY OF EL DORADO
DEPARTMENT OF TRANSPORTATION**

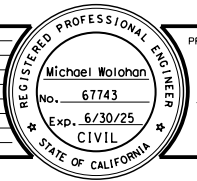
**EL DORADO TRAIL
MISSOURI FLAT ROAD
PEDESTRIAN OVERCROSSING**

SHEET
S-4
27 OF 42
W.D. No.


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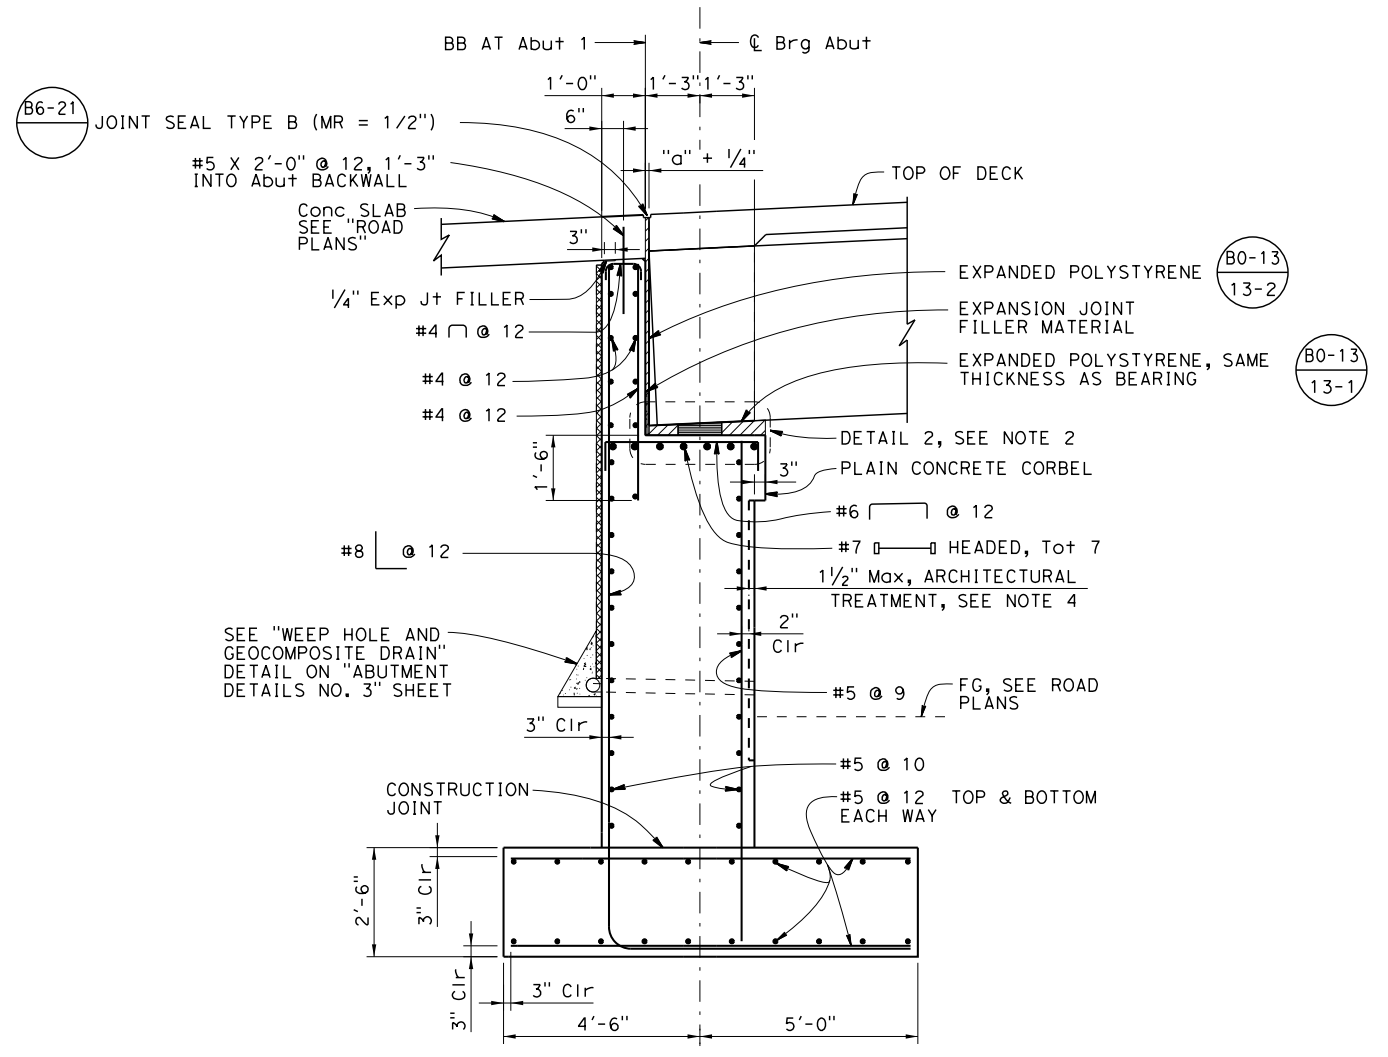
PLAN
1/4"=1'-0"

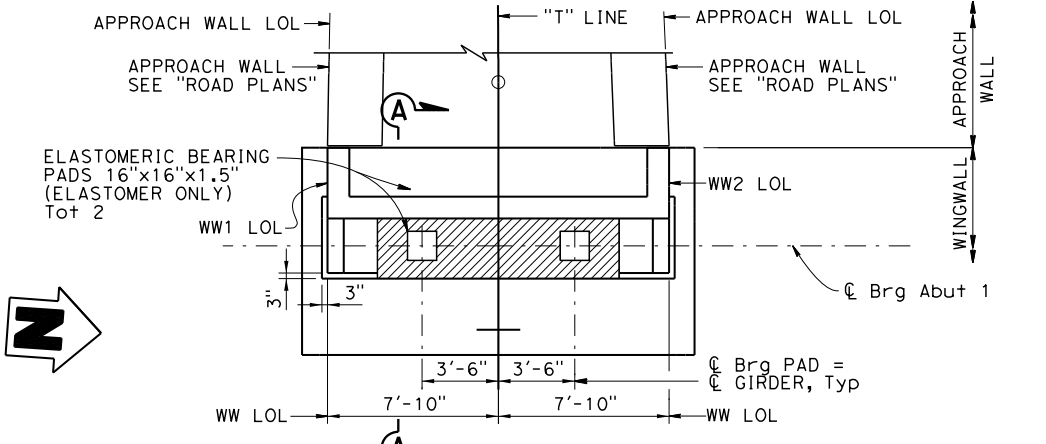

ELEVATION
1/4"=1'-0"

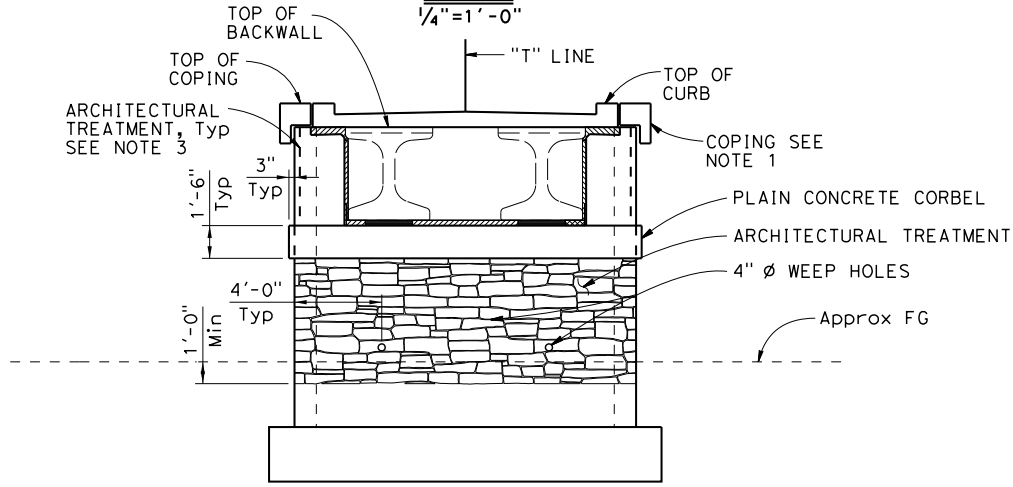

FOOTING PLAN
1/4"=1'-0"

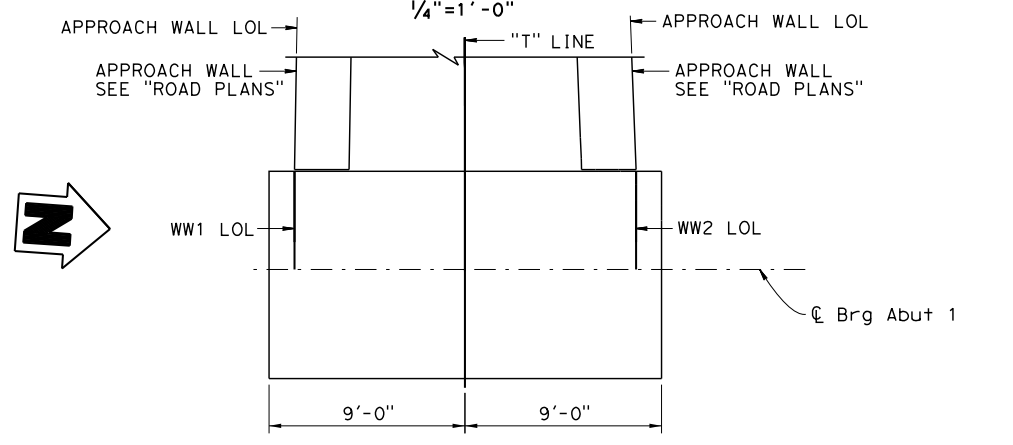

SECTION A-A
1/2"=1'-0"

- NOTES:
1. For Coping details see "ABUTMENT DETAILS NO. 2" sheet.
 2. For Detail 2 see "ABUTMENT DETAILS NO. 3" sheet.
 3. For limits of architectural treatment on wingwalls, see "ABUTMENT ARCHITECTURAL TREATMENT LIMITS" on "ABUTMENT DETAILS NO. 3" sheet.
 4. Limits of architectural treatment shall extend 1'-0" Min below FG.


LEGEND:
 DENOTES LIMITS OF ARCHITECTURAL TREATMENT

ABUTMENT 1 LAYOUT
SCALE AS SHOWN

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 P. B. 3/6/2020
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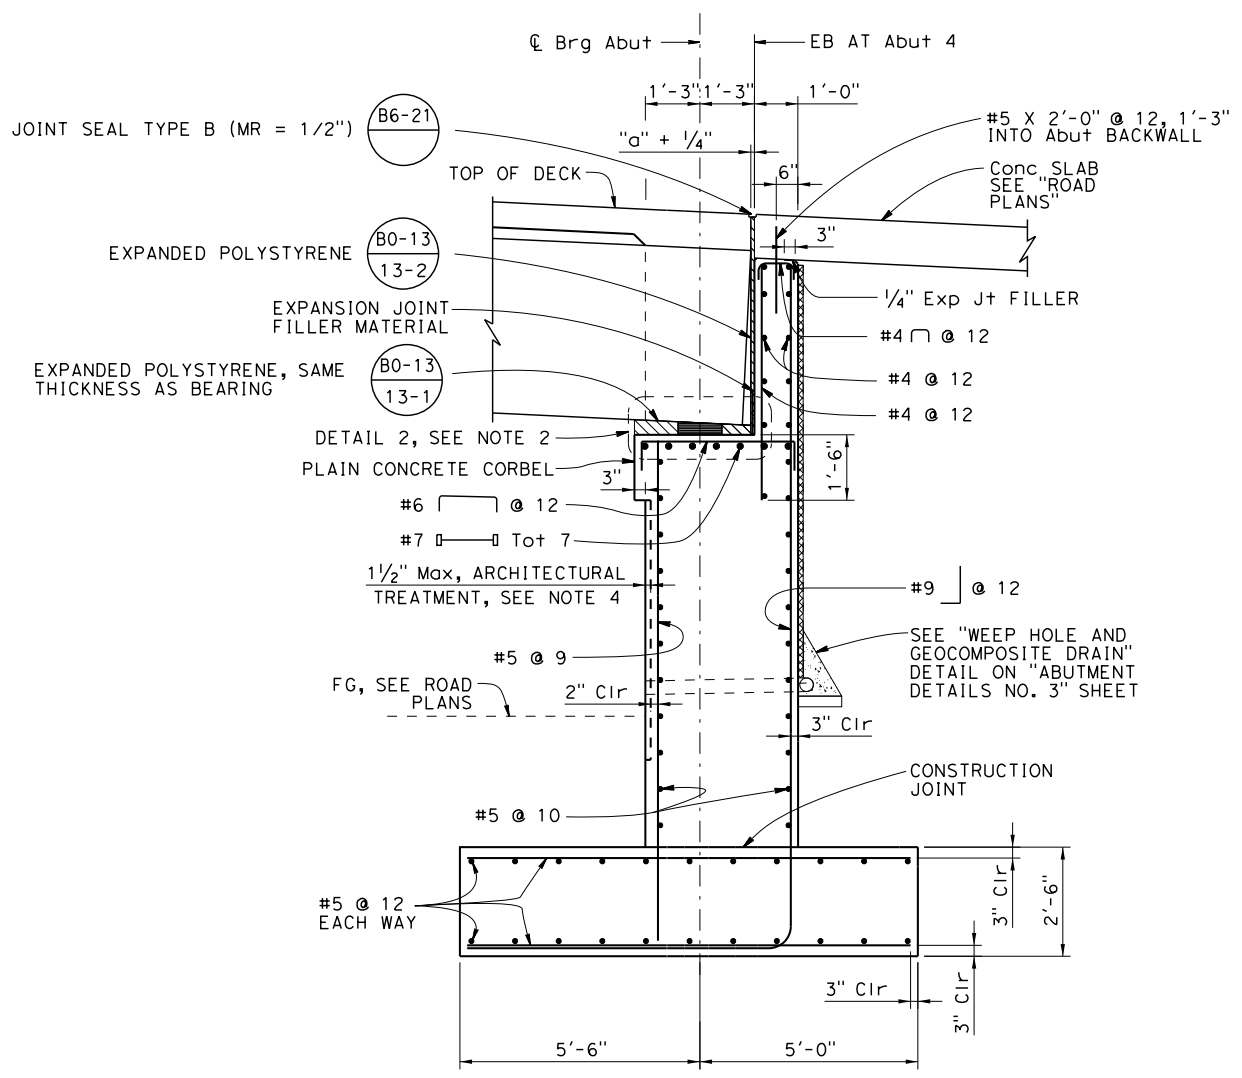
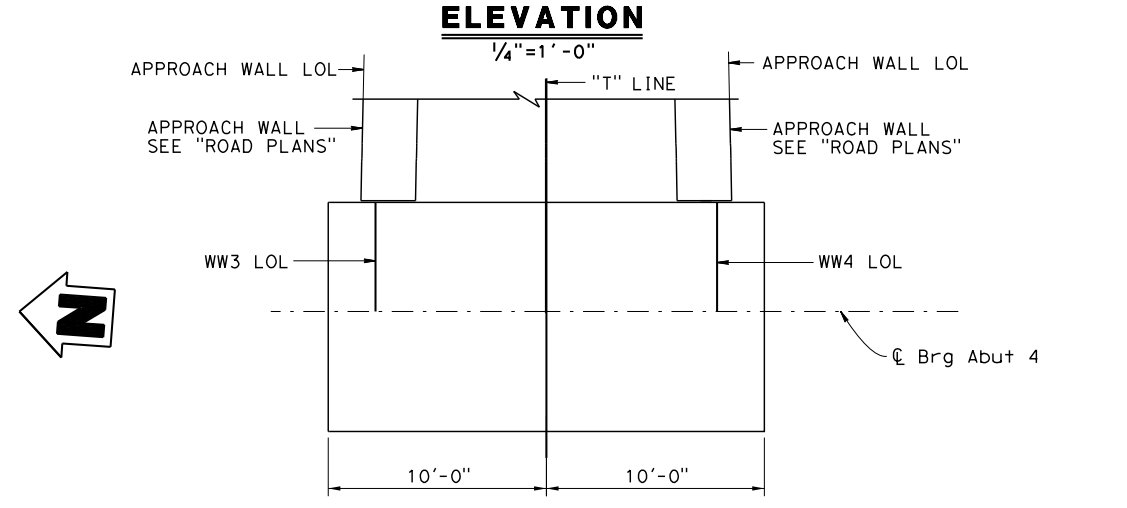
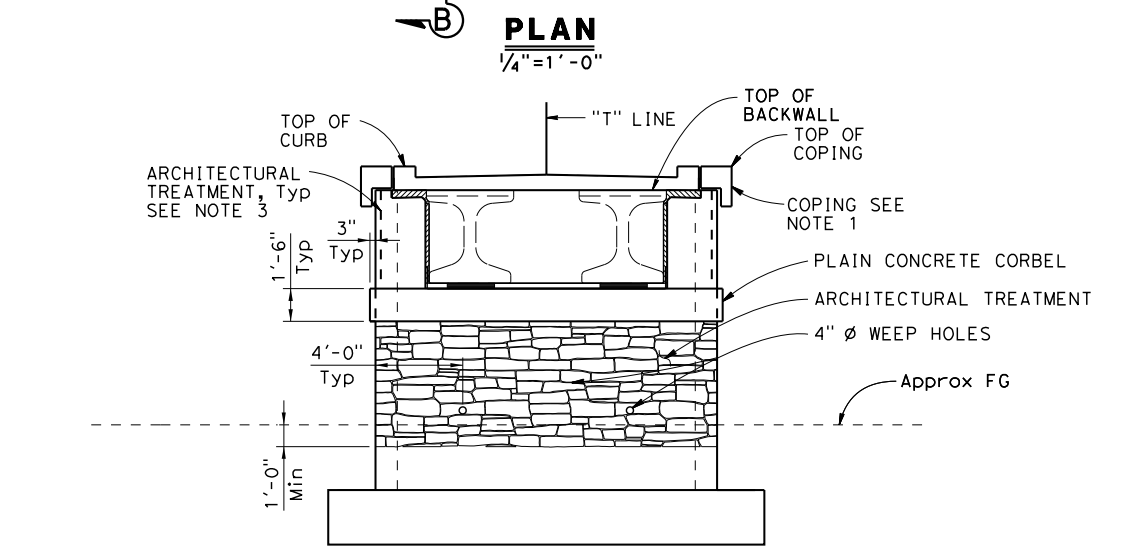
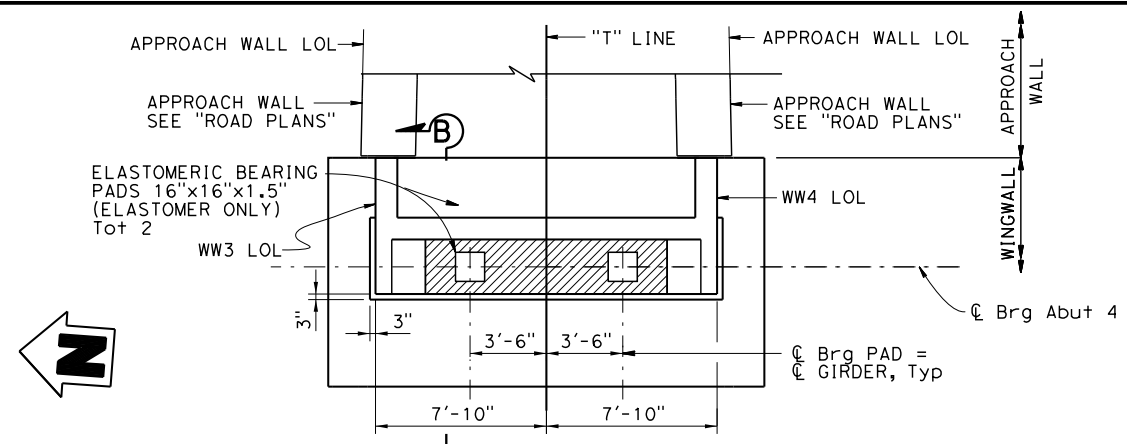


COUNTY OF EL DORADO
DEPARTMENT OF TRANSPORTATION

EL DORADO TRAIL
MISSOURI FLAT ROAD
PEDESTRIAN OVERCROSSING

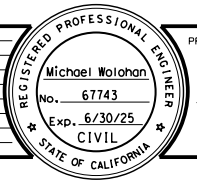SHEET
S-5
28 OF 42
W.D. No.

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- NOTES:
- For Coping details see "ABUTMENT DETAILS NO. 2" sheet.
 - For Detail 2 see "ABUTMENT DETAILS NO. 3" sheet.
 - For limits of architectural treatment on wingwalls, see "ABUTMENT ARCHITECTURAL TREATMENT LIMITS" on "ABUTMENT DETAILS NO. 3" sheet.
 - Limits of architectural treatment shall extend 1'-0" Min below FG.

LEGEND:


DENOTES LIMITS OF ARCHITECTURAL TREATMENT

ABUTMENT 4 LAYOUT
SCALE AS SHOWN

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 DATE: 1/23/2024

DESIGNED: M. W. H.H.
 DRAWN: H.H.
 CHECKED: DATE: 3/6/2020
 P. B.
 ROAD NUMBER:

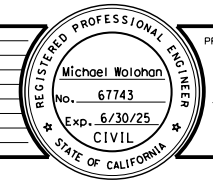


COUNTY OF EL DORADO
DEPARTMENT OF TRANSPORTATION

EL DORADO TRAIL
MISSOURI FLAT ROAD
PEDESTRIAN OVERCROSSING

SHEET S-6
29 OF 42
W.D. No.


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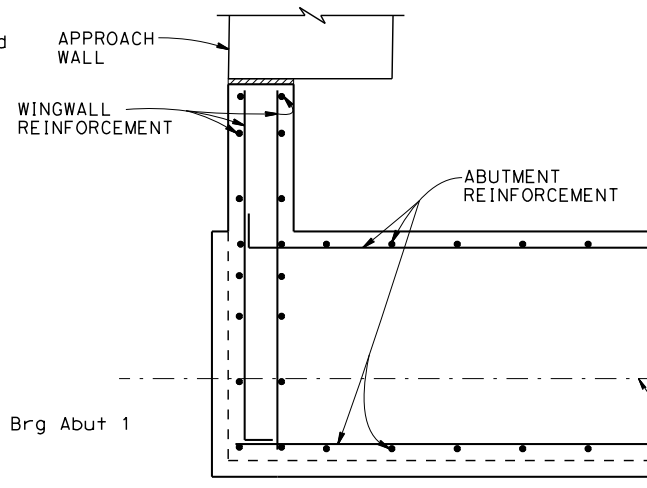
SECTION C-C
3/4"=1'-0"

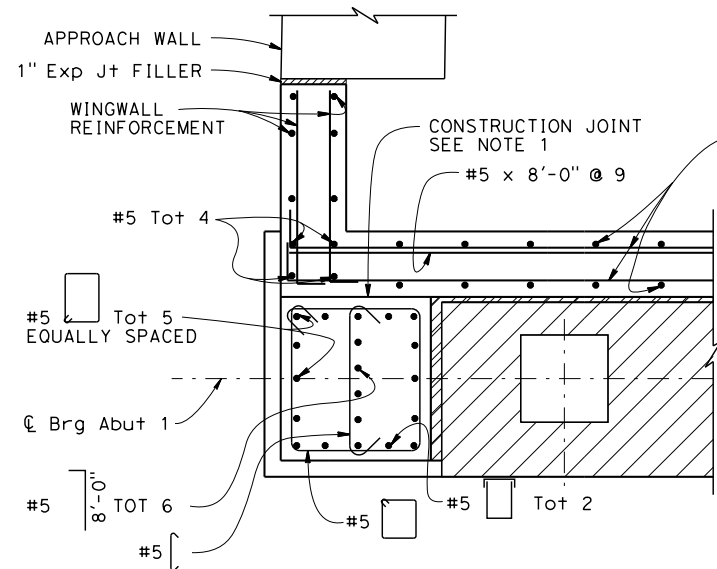Indicates limits of 15 pound construction paper


BACKWALL REINFORCEMENT




SECTION D-D
3/4"=1'-0"

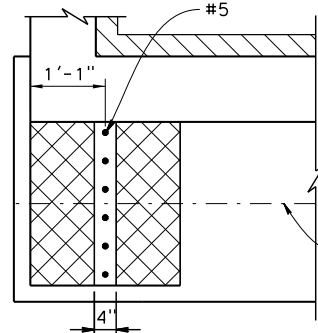


SECTION E-E
3/4"=1'-0"

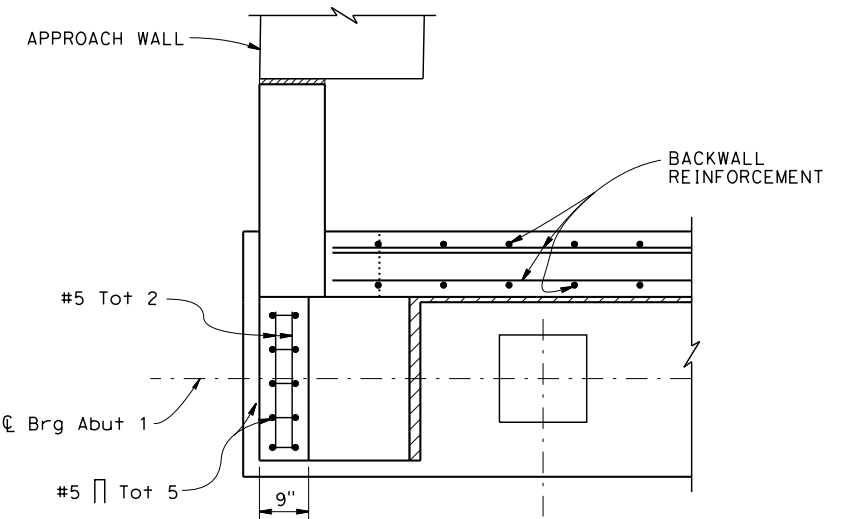


SECTION F-F
3/4"=1'-0"

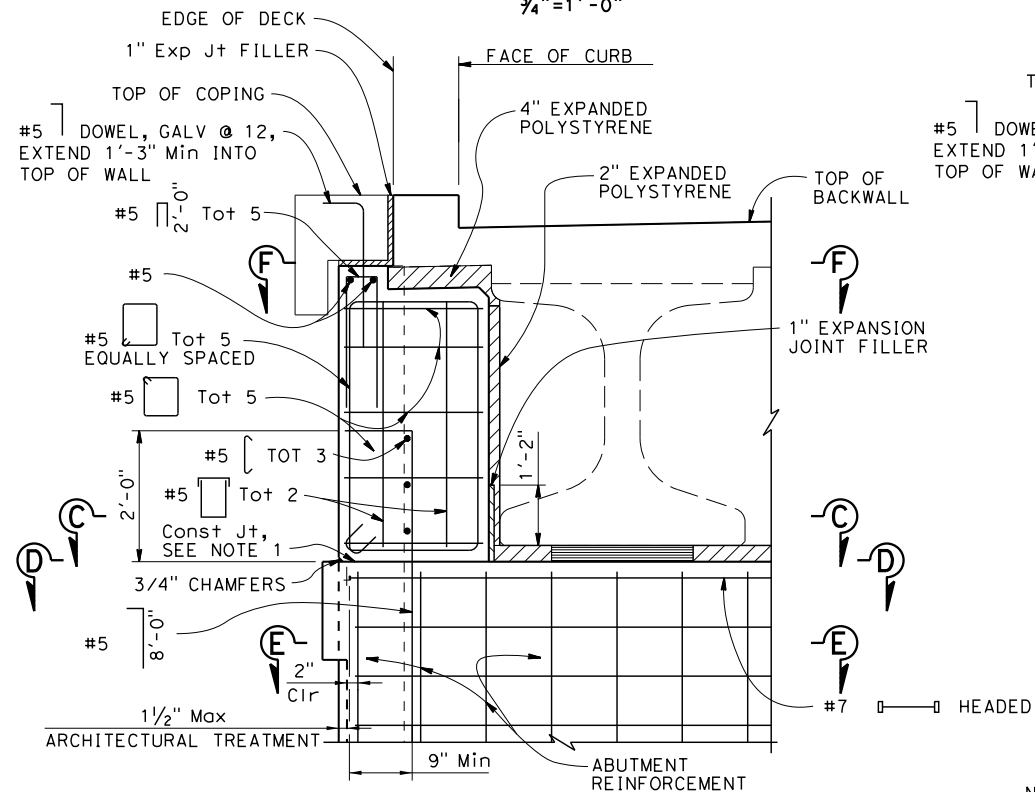


SHEAR KEY DETAIL
3/4"=1'-0"
(ABUTMENT 1 SHOWN, ABUTMENT 4 SIMILAR)

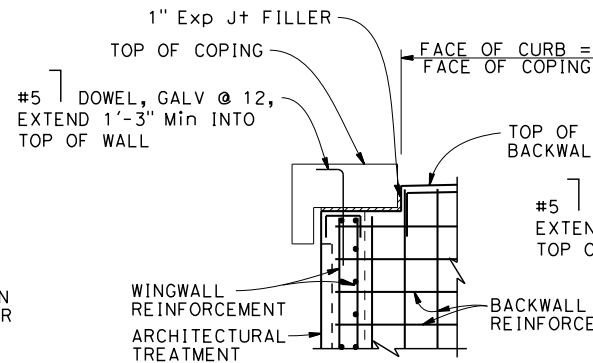

SECTION G-G
1/2"=1'-0"

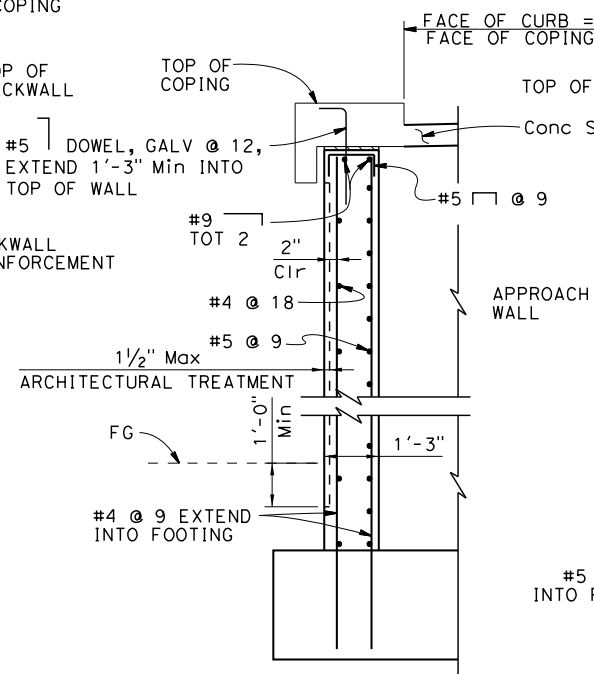

SECTION H-H
1/2"=1'-0"

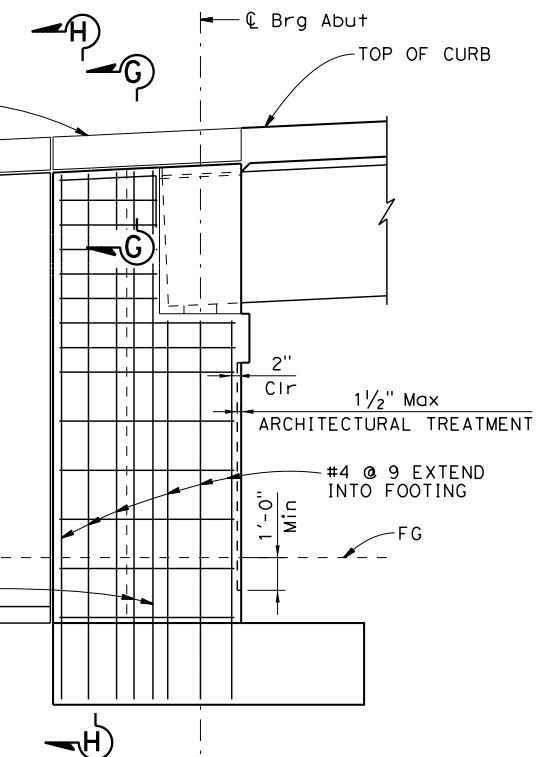

WINGWALL ELEVATION
3/8"=1'-0"
(WW1 & WW3 SHOWN, WW2 & WW4 SIMILAR)


- NOTES:
- Construction Joint, surface to be smooth finish and lined with 15 pound construction paper.
 - For details not shown, see B0-1
 - For Coping details see "ABUTMENT DETAILS NO. 2" sheet.
 - For CONCRETE SLAB details, see "ROAD PLANS".

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 Michael M. Wolohan
 REGISTERED CIVIL ENGINEER
 1/23/2024

DESIGNED: M. W. H.H.
 DRAWN: H.H.
 CHECKED: P. B. DATE: 3/6/2020
 ROAD NUMBER:




COUNTY OF EL DORADO
DEPARTMENT OF TRANSPORTATION

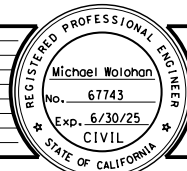
EL DORADO TRAIL
MISSOURI FLAT ROAD
PEDESTRIAN OVERCROSSING

SHEET
S-7
30 OF 42
W.D. No.


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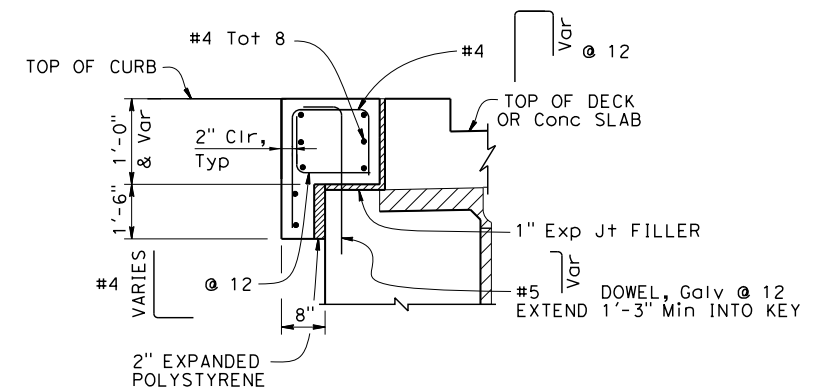
PART PLAN ABUT
 1/4"=1'-0"
 (ABUT 1 SHOWN, ABUT 4 SIMILAR)

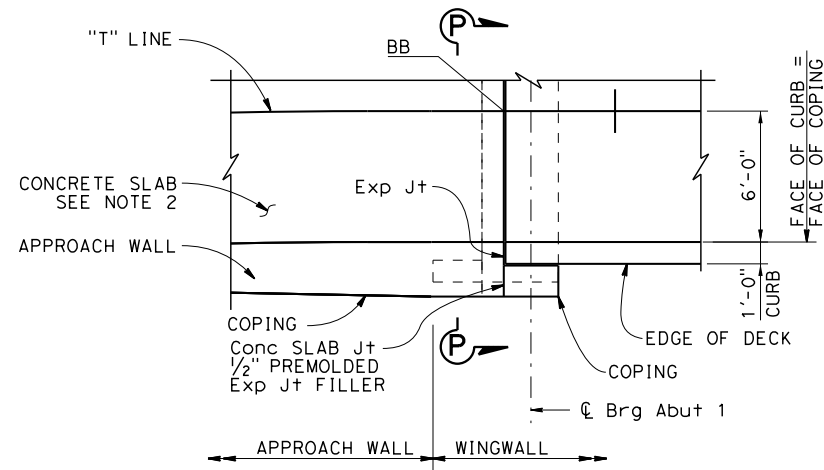

WW ELEVATION
 1/4"=1'-0"
 (WW1 SHOWN, OTHER WW'S SIMILAR)

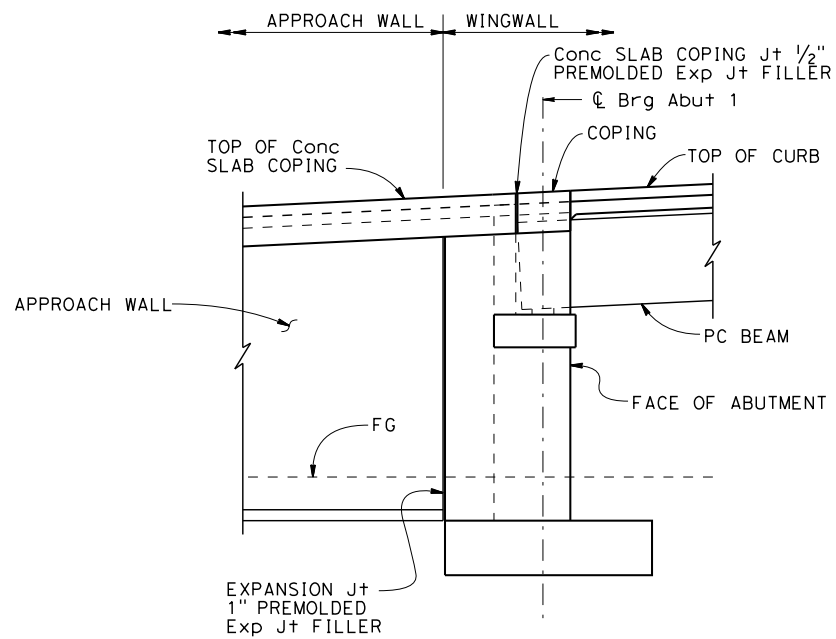

SECTION P-P
 1/2"=1'-0"

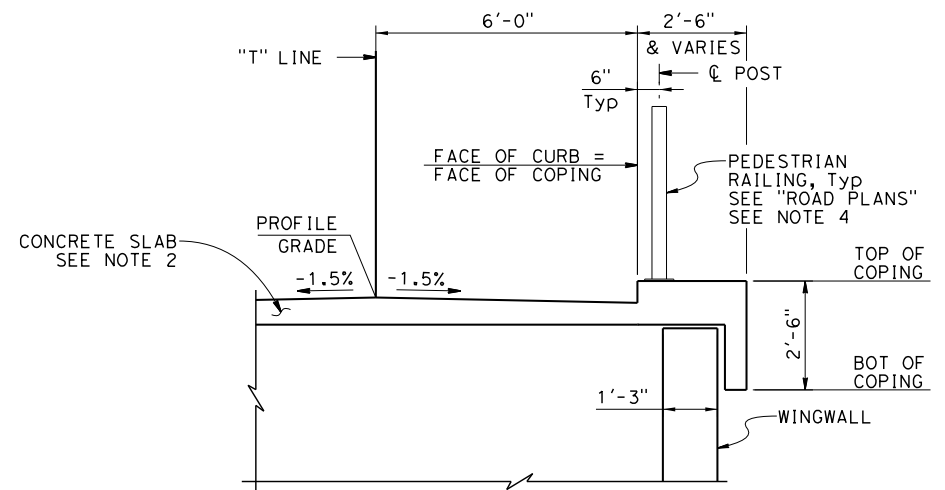

COPING REINFORCEMENT DETAIL
 No Scale


- NOTES:
- SEE "ROAD PLANS" FOR APPROACH WALL DETAILS.
 - SEE "ROAD PLANS" FOR CONCRETE SLAB DETAILS.
 - SEE "ABUTMENT ARCHITECTURAL TREATMENT LIMITS" ON "ABUTMENT DETAILS NO. 3" SHEET FOR LIMITS OF ARCHITECTURAL TREATMENT ON WINGWALLS.
 - Coordinate location of PEDESTRIAN RAILING joint with abutment joint, see "ROAD PLANS."

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DESIGNED: M. W.
 DRAWN: H. H.
 CHECKED: P. B.
 DATE: 3/6/2020
 ROAD NUMBER:





COUNTY OF EL DORADO
 DEPARTMENT OF TRANSPORTATION

EL DORADO TRAIL
 MISSOURI FLAT ROAD
 PEDESTRIAN OVERCROSSING

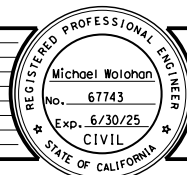
ABUTMENT DETAILS NO. 2
 SCALE AS SHOWN

SHEET
 S-8
 31 OF 42
 W.O. No.

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DETAIL 3
No Scale

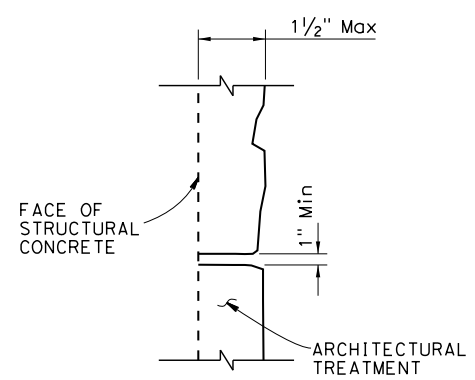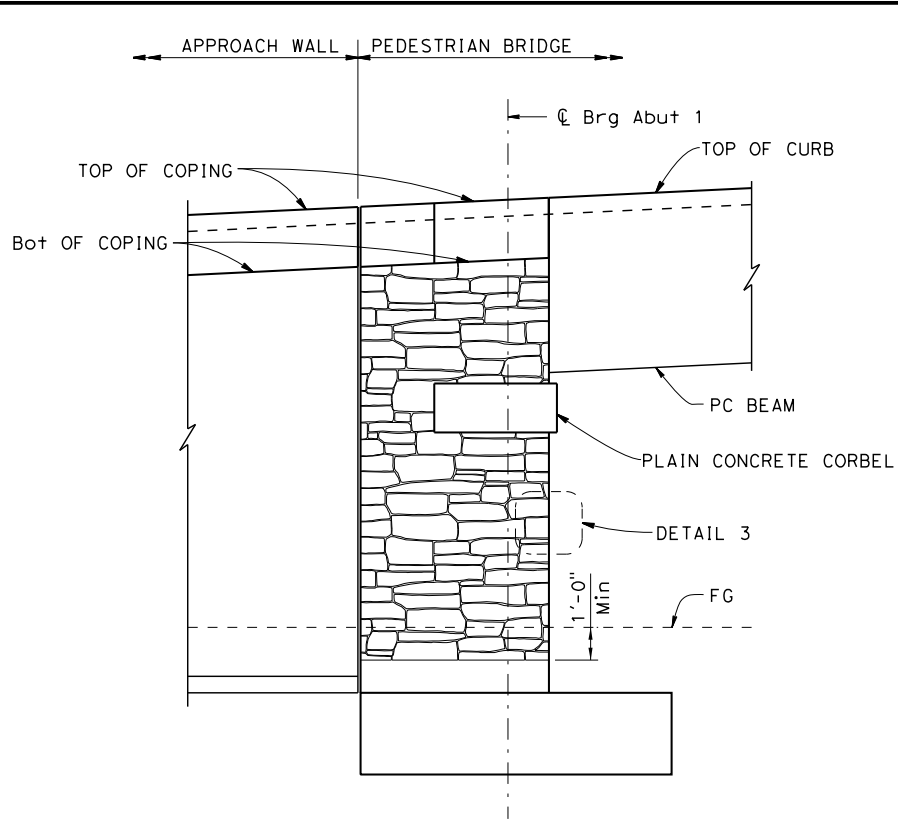


ABUTMENT

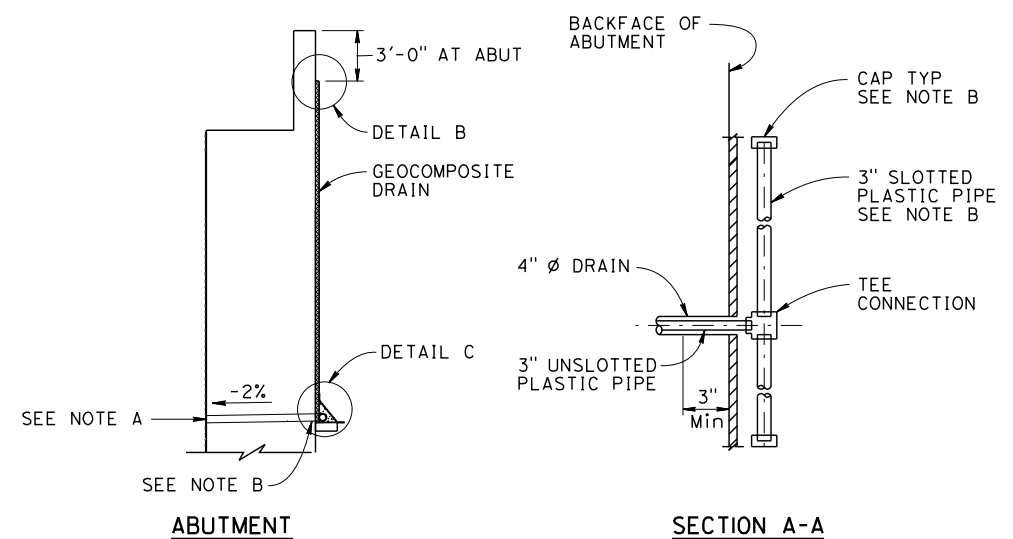
SECTION A-A

ABUTMENT ARCHITECTURAL TREATMENT LIMITS


No Scale
(ABUTMENT 1 SHOWN, ABUTMENT 4 SIMILAR)
 LEGEND:
 DENOTES LIMITS OF ARCHITECTURAL TREATMENT
 NOTE: ARCHITECTURAL TREATMENT SHALL EXTEND 1'-0" BELOW FG.

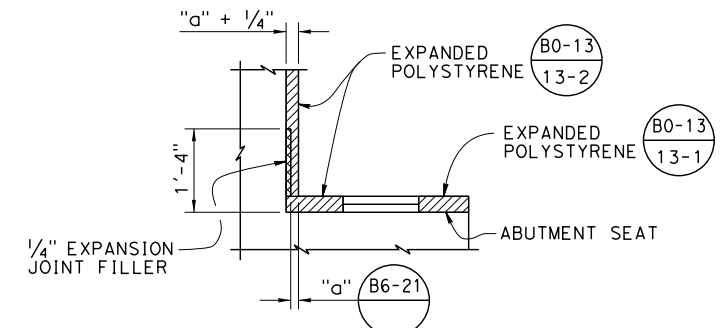

DETAIL 2
No Scale

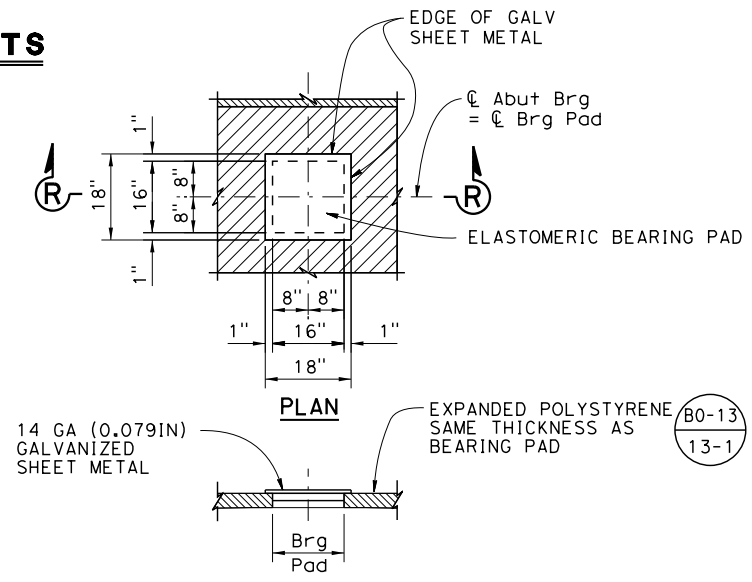

SECTION R-R
BEARING PAD DETAIL
No Scale

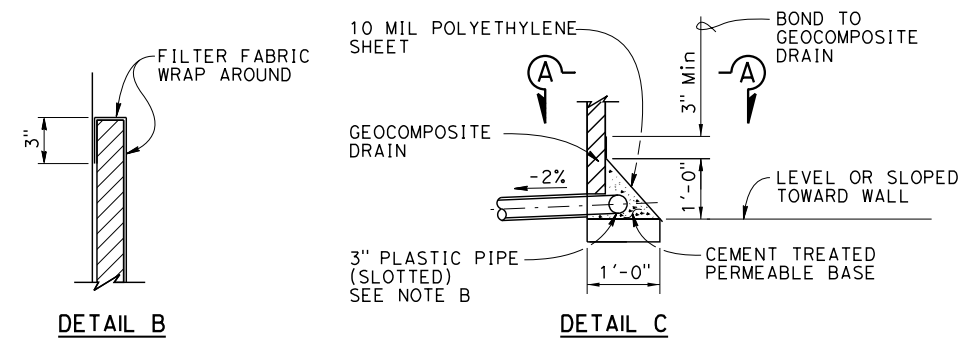

DETAIL B

DETAIL C

WEEP HOLE AND GEOCOMPOSITE DRAIN


- Notes: No Scale
- A. 4" Ø drains at intermediate sag points and at 25'-0" Max. center to center. For walls adjacent to sidewalks or curbs, provide 4" Ø plastic pipe under sidewalk to discharge through curb face. Exposed wall drains shall be located 0'-3"± above finished grade.
 - B. Geocomposite drain, cement treated permeable base, and 3" Ø slotted plastic pipe continuous behind abutment. Cap ends of pipe. Provide "Tee" connection at each 4" Ø casing.
 - C. Connect the low end of plastic pipe to the main outlet pipe as applicable.

ABUTMENT DETAILS NO. 3
SCALE AS SHOWN

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 REGISTERED CIVIL ENGINEER
 1/23/2024

DESIGNED: M. W.
 DRAWN: H. H.
 CHECKED: P. B.
 ROAD NUMBER: 3/6/2020

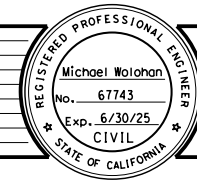

COUNTY OF EL DORADO
DEPARTMENT OF TRANSPORTATION


EL DORADO TRAIL
MISSOURI FLAT ROAD
PEDESTRIAN OVERCROSSING

SHEET
S-9
32 OF 42
W.O. No.


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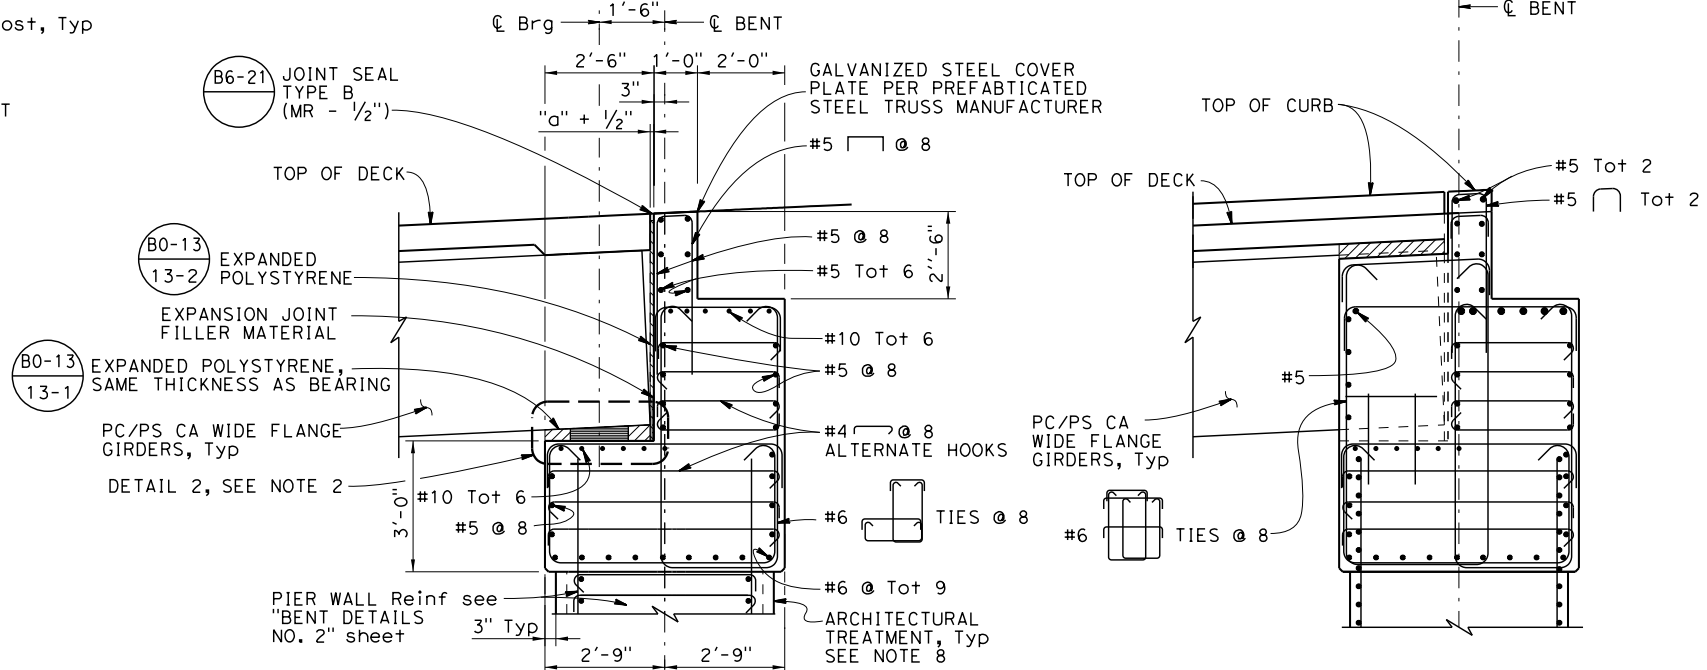
FOR REDUCED PLANS
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PLAN
1/2" = 1'-0"




ELEVATION
1/2" = 1'-0"

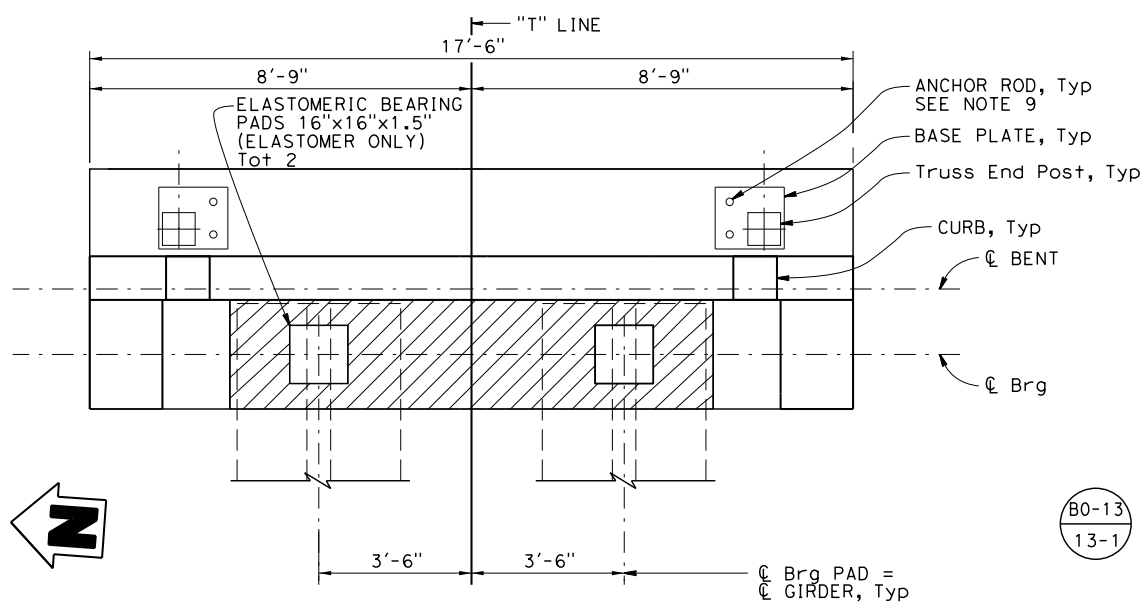

SECTION A-A
1/2" = 1'-0"

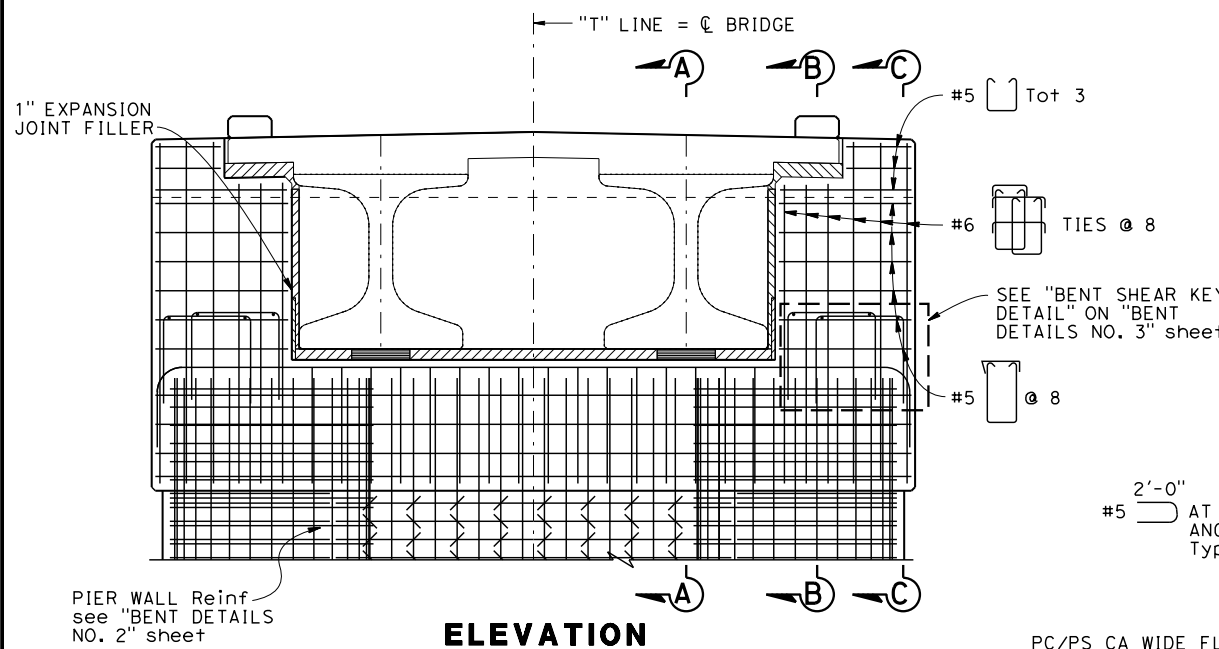SECTION B-B
1/2" = 1'-0"
SEE NOTE 7

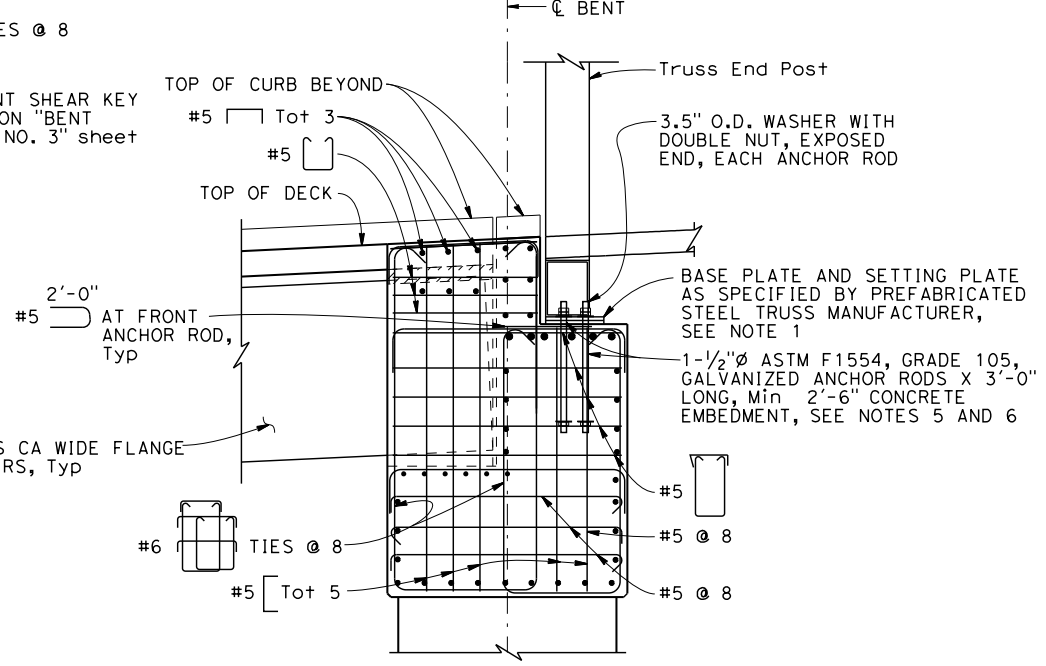

SECTION C-C
1/2" = 1'-0"
SEE NOTE 7

- NOTES:
- Fixed end of truss at Bent 2. Expansion end of truss at Bent 3 with slotted holes to accommodate anticipated movement.
 - For Detail 2 see "ABUTMENT DETAILS NO. 3" sheet.
 - Span 2 is fixed at Bent 2.
 - Bent 2 shown, Bent 3 similar.
 - 3.5" O.D. washer with nut at anchored end of rod. Tack weld nut to anchor bolt and washer to nut.
 - Coordinate location of anchor bolts with PREFABRICATED STEEL TRUSS manufacturer. Minimum 9" edge distance to closest concrete face.
 - See "SECTION A-A" for additional reinforcing details.
 - See "BENT ARCHITECTURAL TREATMENT LIMITS" on "BENT DETAILS NO. 3" sheet.
 - Confirm location of anchor rods with STEEL TRUSS MANUFACTURER prior to placing concrete.


BENT DETAILS NO. 1
SCALE AS SHOWN

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REGISTERED CIVIL ENGINEER
DATE: 1/23/2024

DESIGNED: M. W. H.H.
DRAWN: H.H.
CHECKED: P. B. DATE: 3/6/2020
ROAD NUMBER:




COUNTY OF EL DORADO
DEPARTMENT OF TRANSPORTATION

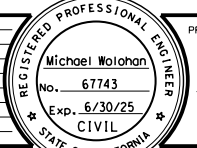
EL DORADO TRAIL
MISSOURI FLAT ROAD
PEDESTRIAN OVERCROSSING

SHEET
S-10
33 OF 42
W.D. No.


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SECTION E-E
1/2"=1'-0"

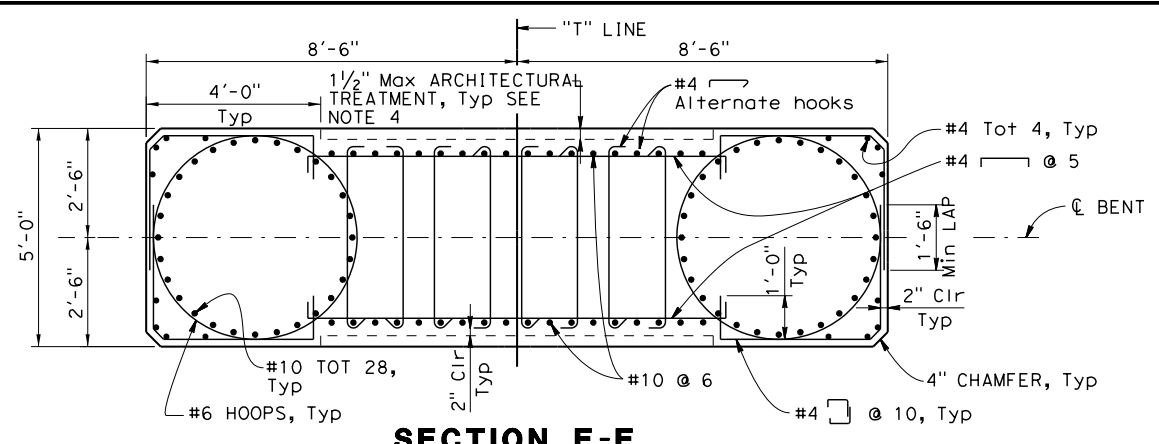

ELEVATION
1/2"=1'-0"

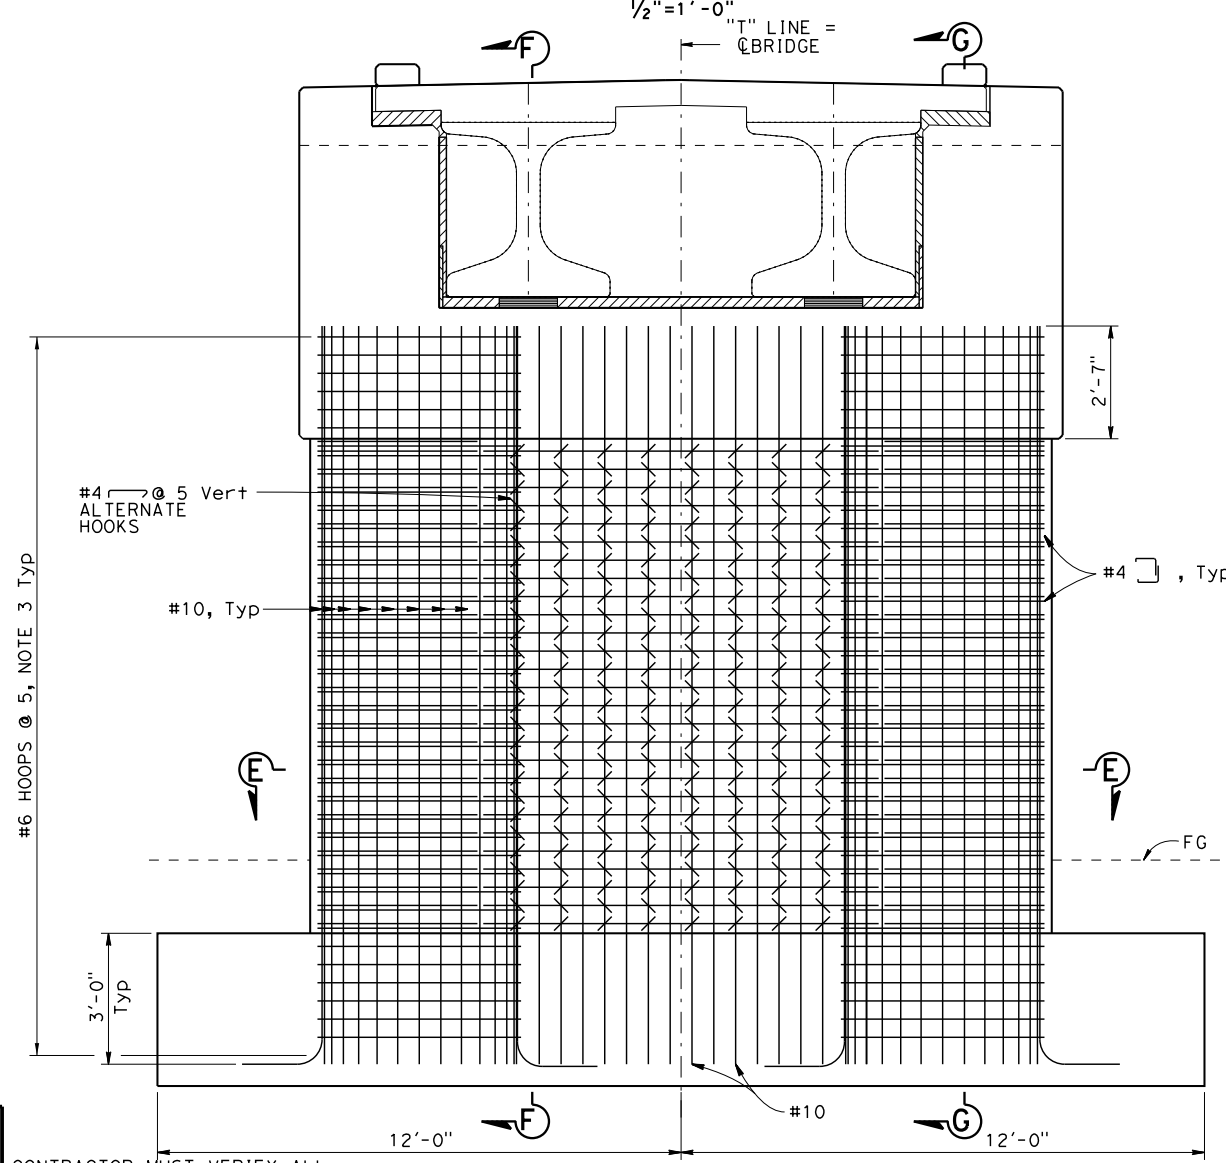

SECTION F-F
1/2"=1'-0"

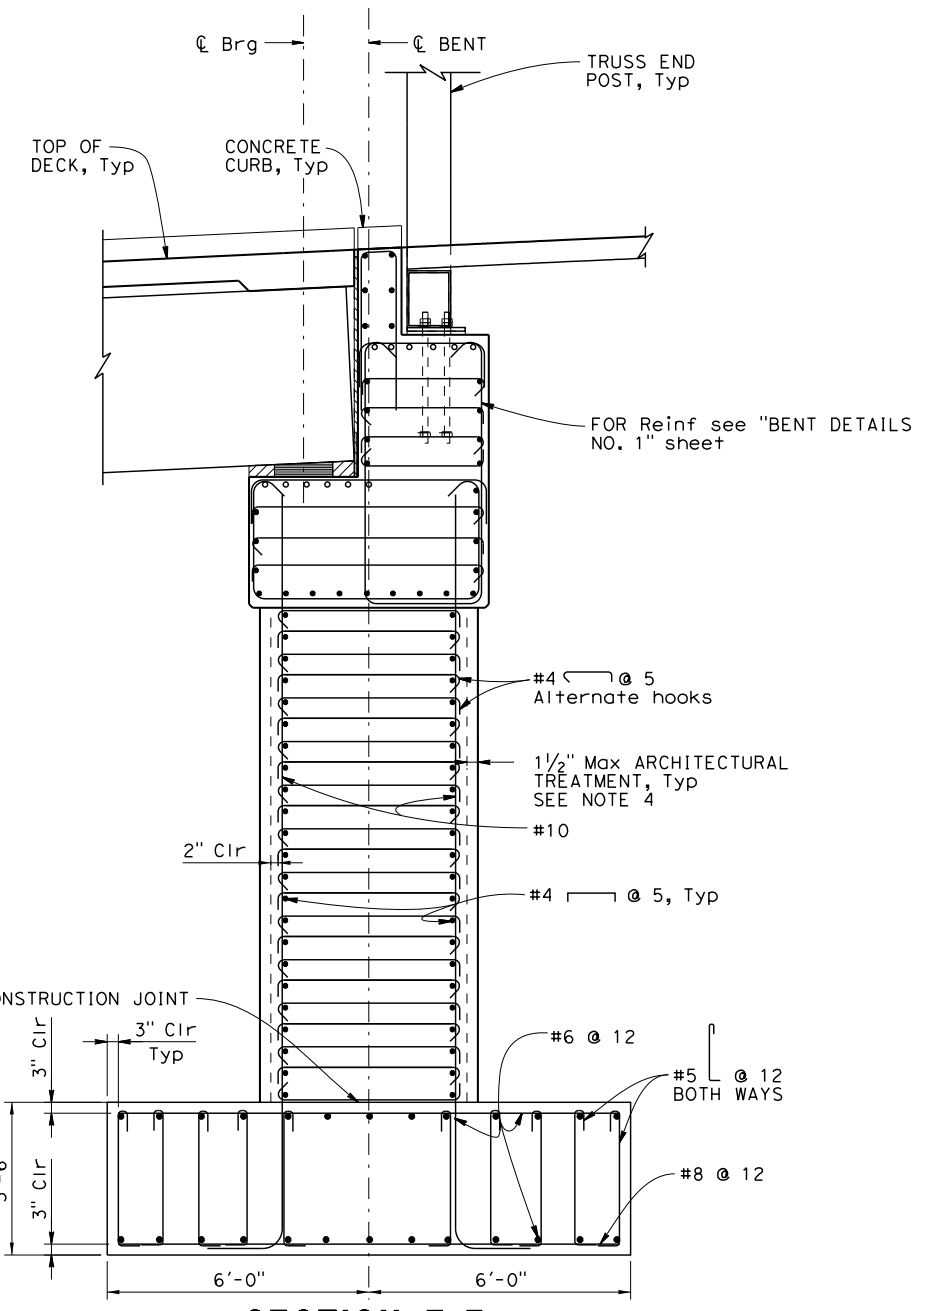
- NOTES:**
- Bent 2 shown, Bent 3 similar.
 - For Section G-G, see "BENT DETAILS NO. 3" sheet.
 - Hoops shall be "ULTIMATE" butt spliced continuous.
 - See "BENT ARCHITECTURAL TREATMENT LIMITS" on "BENT DETAILS NO. 3" sheet.

BENT DETAILS NO. 2
SCALE AS SHOWN

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 1/23/2024

DESIGNED: M. W.
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 CHECKED: P. B.
 DATE: 3/6/2020
 ROAD NUMBER:




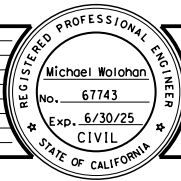


COUNTY OF EL DORADO
DEPARTMENT OF TRANSPORTATION

EL DORADO TRAIL
MISSOURI FLAT ROAD
PEDESTRIAN OVERCROSSING

SHEET
S-11
34 OF 42
W.D. No.

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LEGEND:
 DENOTES LIMITS OF ARCHITECTURAL TREATMENT

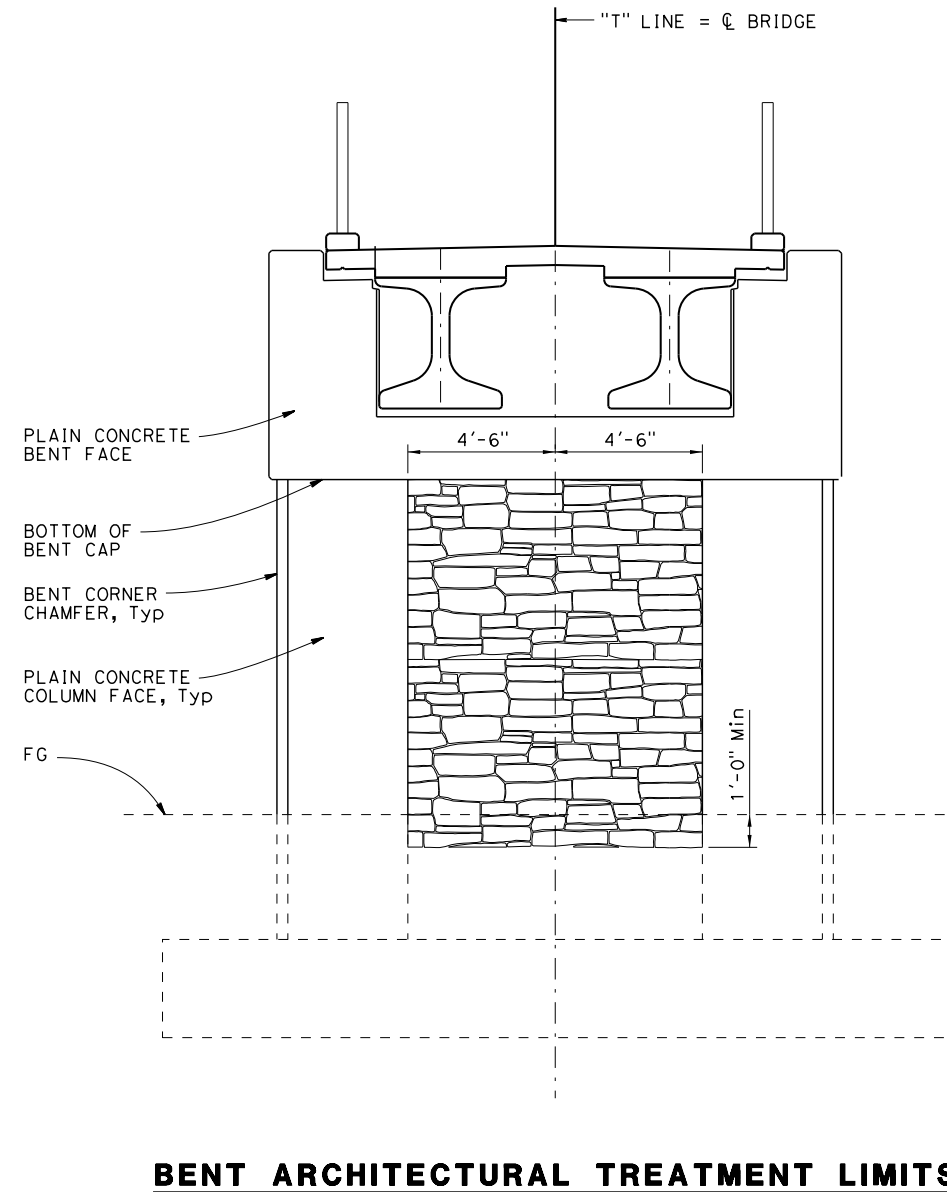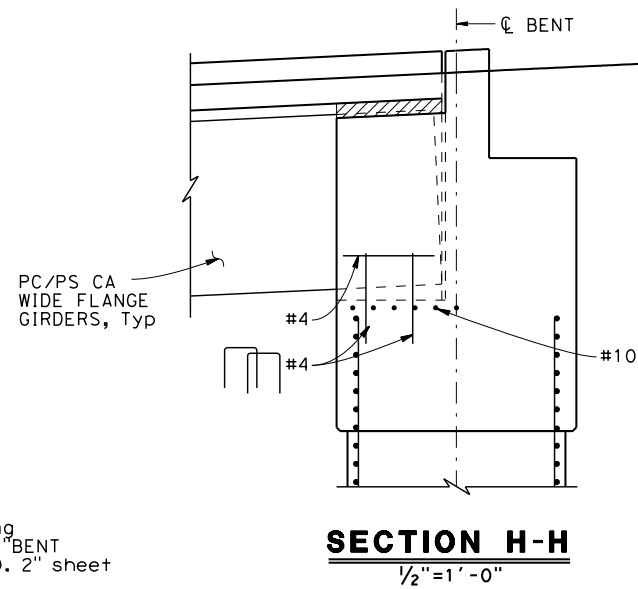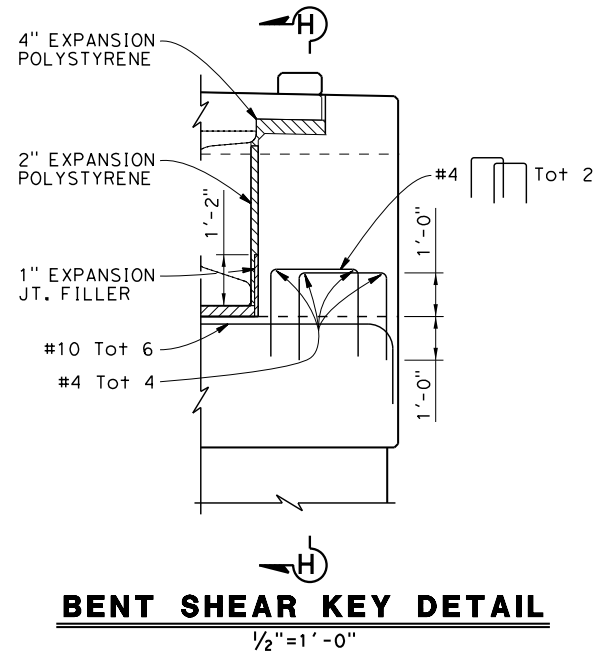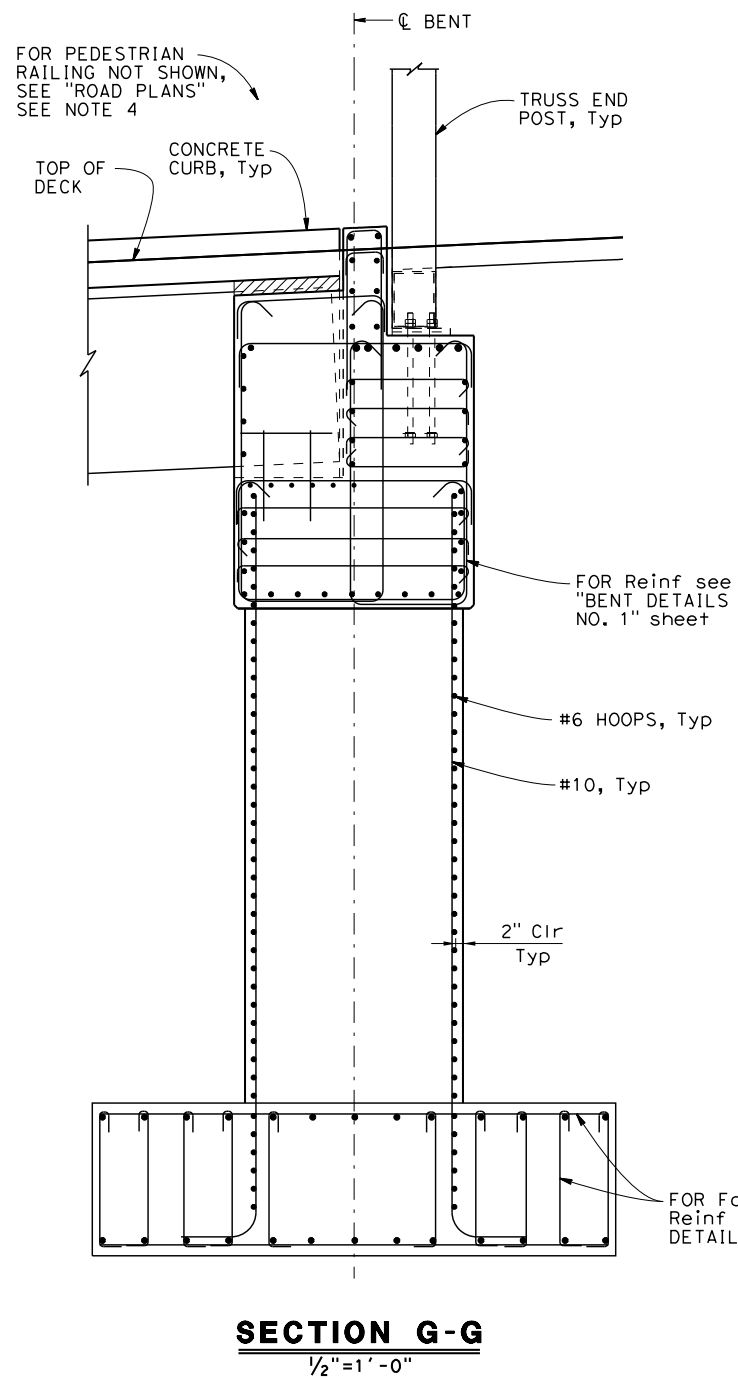- NOTES:
- Bent cap reinforcement not shown for clarity.
 - Shear key face reinforcement not shown for clarity.
 - ARCHITECTURAL TREATMENT shall extend 1'-0" minimum below finish grade. See "ABUTMENT DETAILS NO. 3" sheet for additional details.
 - Coordinate location of PEDESTRIAN RAILING joint with PC/PS span expansion joint and begin and end of STEEL TRUSS span.


BENT DETAILS NO. 3
 SCALE AS SHOWN

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 Exp. 6/30/25
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 REGISTERED CIVIL ENGINEER
 1/23/2024
 DATE:

DESIGNED: M. W.
 DRAWN: H. H.
 CHECKED: P. B.
 ROAD NUMBER: 3/6/2020





COUNTY OF EL DORADO
 DEPARTMENT OF TRANSPORTATION

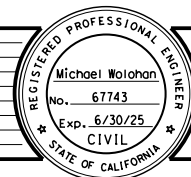
EL DORADO TRAIL
 MISSOURI FLAT ROAD
 PEDESTRIAN OVERCROSSING

SHEET
 S-12
 35 OF 42
 W.O. No.

ORIGINAL SCALE IS IN INCHES USERNAME => mtchoai.dwg PLOTTED => 1/23/2024 TIME PLOTTED => 8:34:28 PM
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- NOTES:
- Steel truss manufacturer to design PREFABRICATED STEEL TRUSS including wire mesh panels, PEDESTRIAN TRUSS RAILING and CONCRETE DECK.
 - For birdge lighting, see "LIGHTING PLANS."
 - Clear distance between Bent 2 & Bent 3 backwalls is 179'-0".

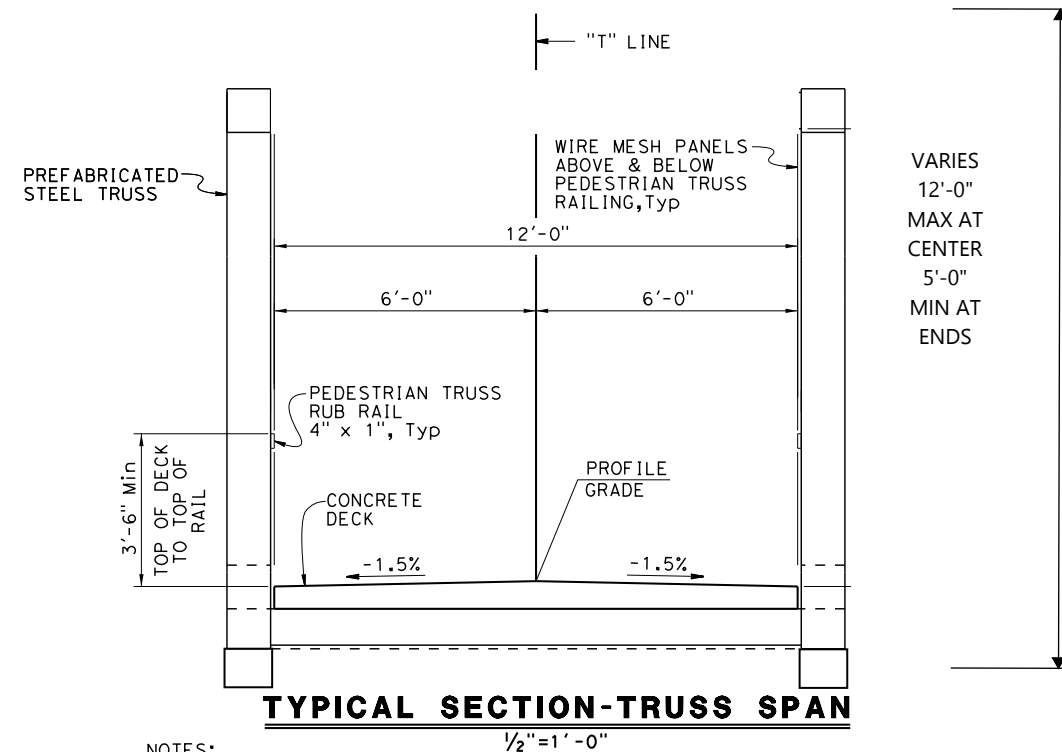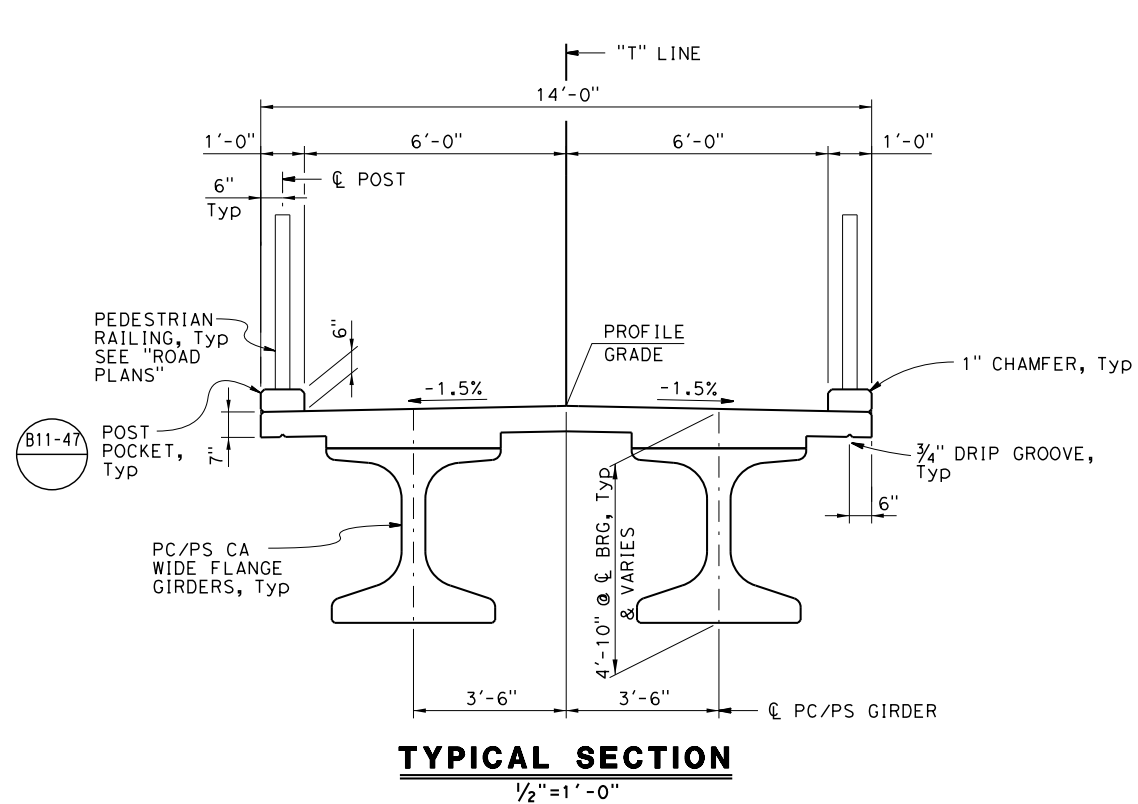


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COUNTY OF EL DORADO
DEPARTMENT OF TRANSPORTATION

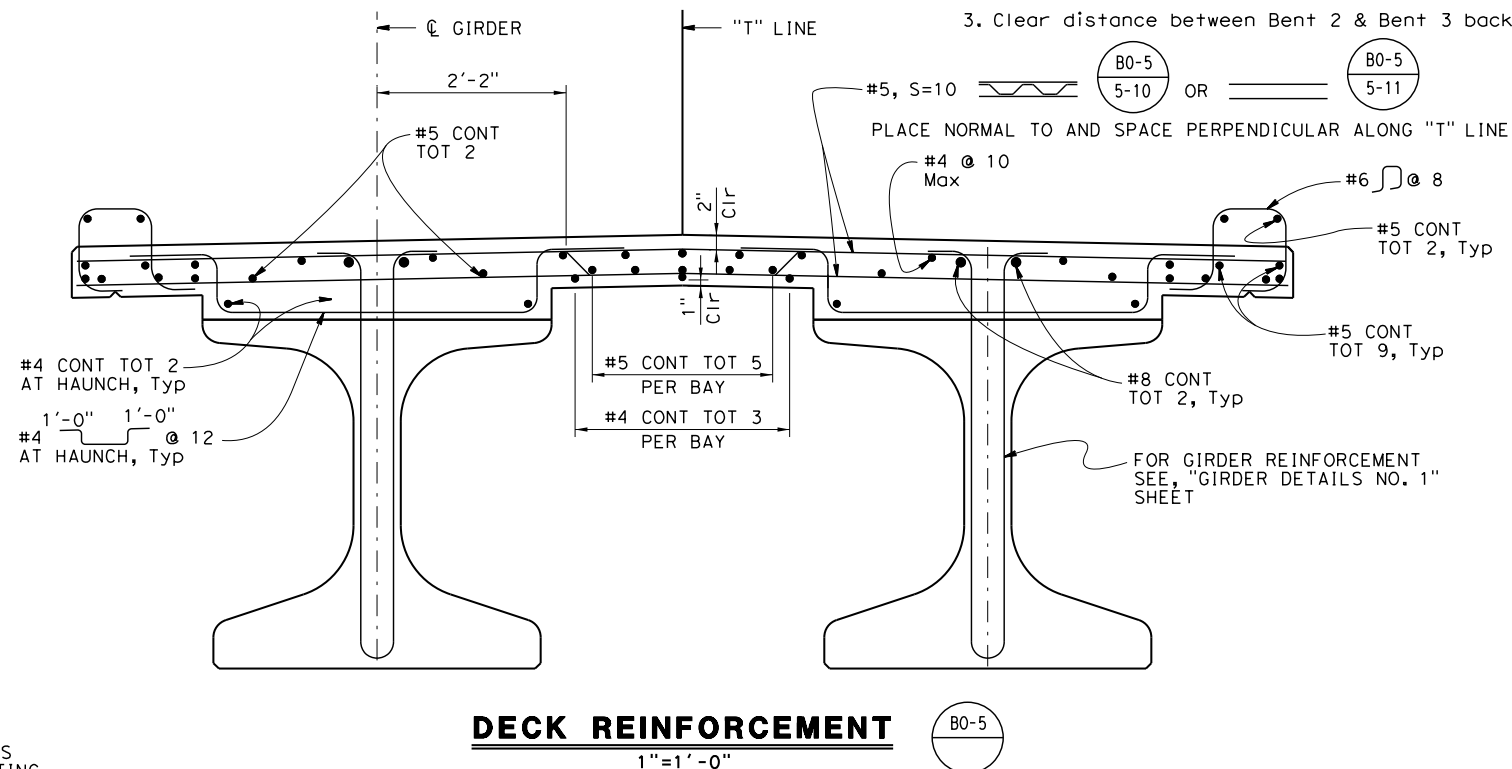EL DORADO TRAIL
MISSOURI FLAT ROAD
PEDESTRIAN OVERCROSSING

TYPICAL SECTION
SCALE AS SHOWN


SHEET
S-13
36 OF 42
W.O. No.
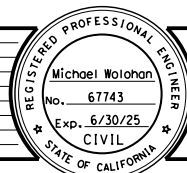
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1/23/2024


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FOR REDUCED PLANS



GIRDER LAYOUT SPAN 1

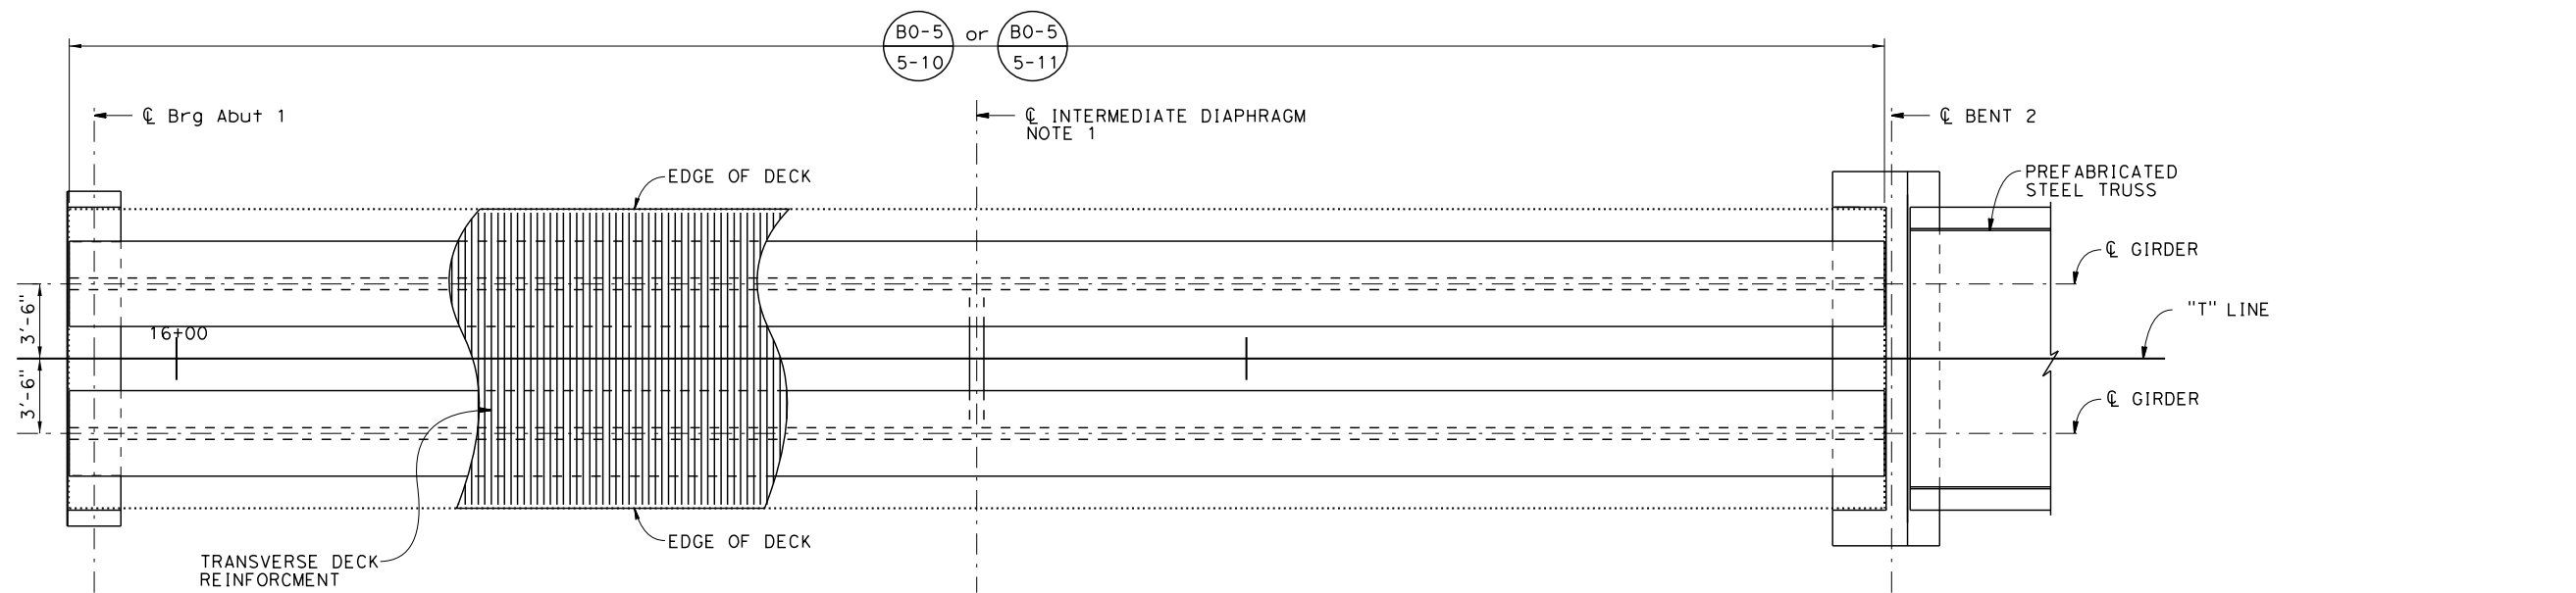1/4"=1'-0"

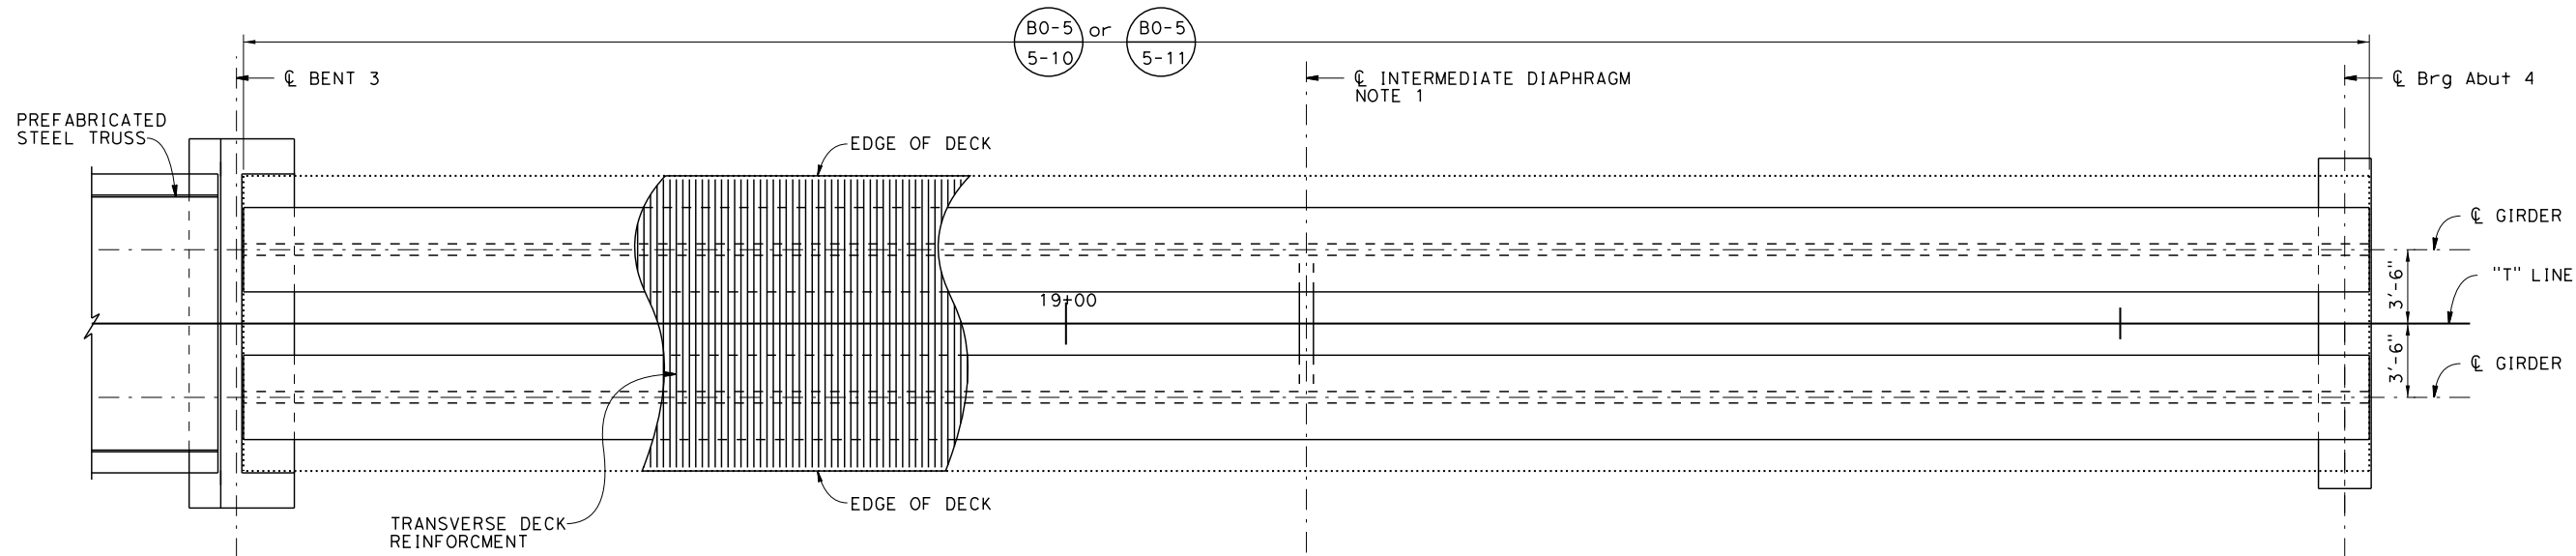

GIRDER LAYOUT SPAN 3

1/4"=1'-0"

NOTES:

- For Precast Girder and Intermediate Diaphragm details see "PRECAST GIRDER DETAILS" sheets.




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DESIGNED: M. W.
 DRAWN: H. H.
 CHECKED: P. B.
 DATE: 3/6/2020
 ROAD NUMBER:




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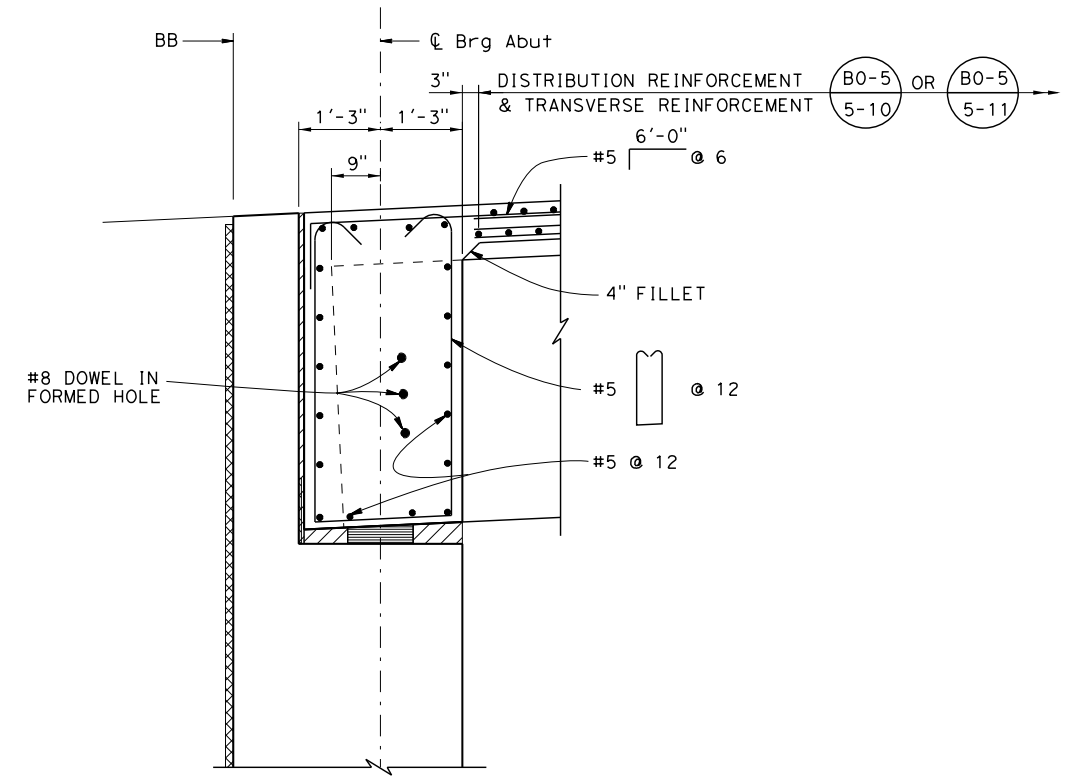
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 MISSOURI FLAT ROAD
 PEDESTRIAN OVERCROSSING

SHEET
 S-14
 37 OF 42
 W.O. No.

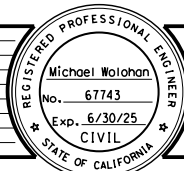ORIGINAL SCALE IS IN INCHES
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 2
 1
 0
 FOR REDUCED PLANS

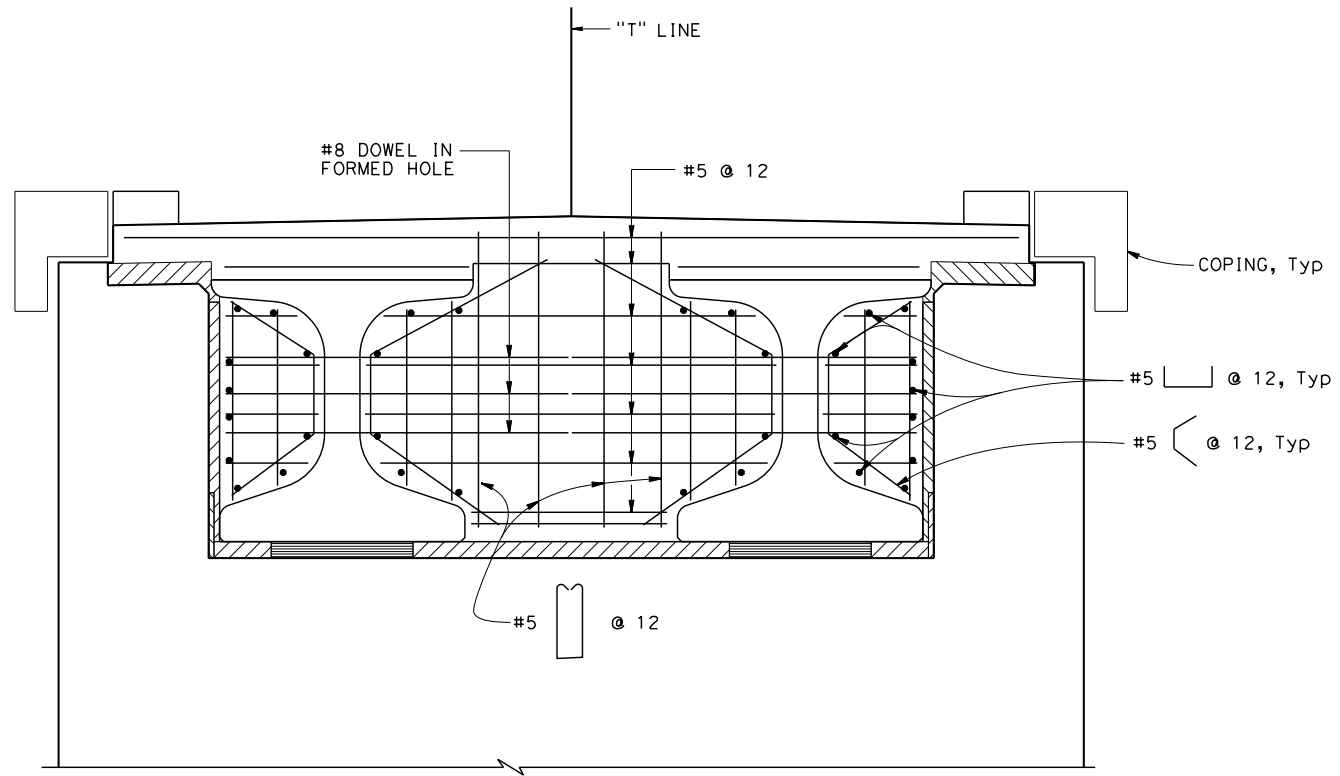

END DIAPHRAGM
3/4" = 1' - 0"




END DIAPHRAGM SECTION
3/4" = 1' - 0"

TYLIN INTERNATIONAL

1545 RIVER PARK DRIVE, SUITE 201
 SACRAMENTO, CA 95815
 T. Y. Lin International or its officers or agents shall not be responsible for the accuracy or completeness of electronic copies of this plan sheet.

CONTRACTOR MUST VERIFY ALL CONTROLLING FIELD DIMENSIONS BEFORE ORDERING OR FABRICATING ANY MATERIAL.

REVISION	NUMBER	DATE	DESCRIPTION	BY

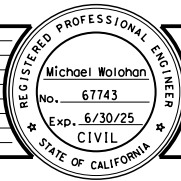

PREPARED UNDER THE SUPERVISION OF:
 Michael Wolohan
 No. 67743
 Exp. 6/30/25
 CIVIL
 REGISTERED CIVIL ENGINEER
 1/23/2024
 DATE:

DESIGNED: M. W.
 DRAWN: H. H.
 CHECKED: P. B.
 DATE: 3/6/2020
 ROAD NUMBER:



COUNTY OF EL DORADO
 DEPARTMENT OF TRANSPORTATION

EL DORADO TRAIL
 MISSOURI FLAT ROAD
 PEDESTRIAN OVERCROSSING


PRECAST GIRDER DETAILS NO. 1
 SCALE AS SHOWN

SHEET
 S-15
 38 OF 42
 W.O. No.

DIST	COUNTY	ROUTE	POST MILES TOTAL PROJECT	SHEET No.	TOTAL SHEETS
03	ED	XX		39	42

Michael M. Wolohan 1/24/22
 REGISTERED CIVIL ENGINEER DATE
 1/23/24
 PLANS APPROVAL DATE
 No. C67743
 Exp. 6/30/25
 CIVIL
 STATE OF CALIFORNIA

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 The Registered Civil Engineer for the project is responsible for the selection and proper application of the component design and any modifications shown.

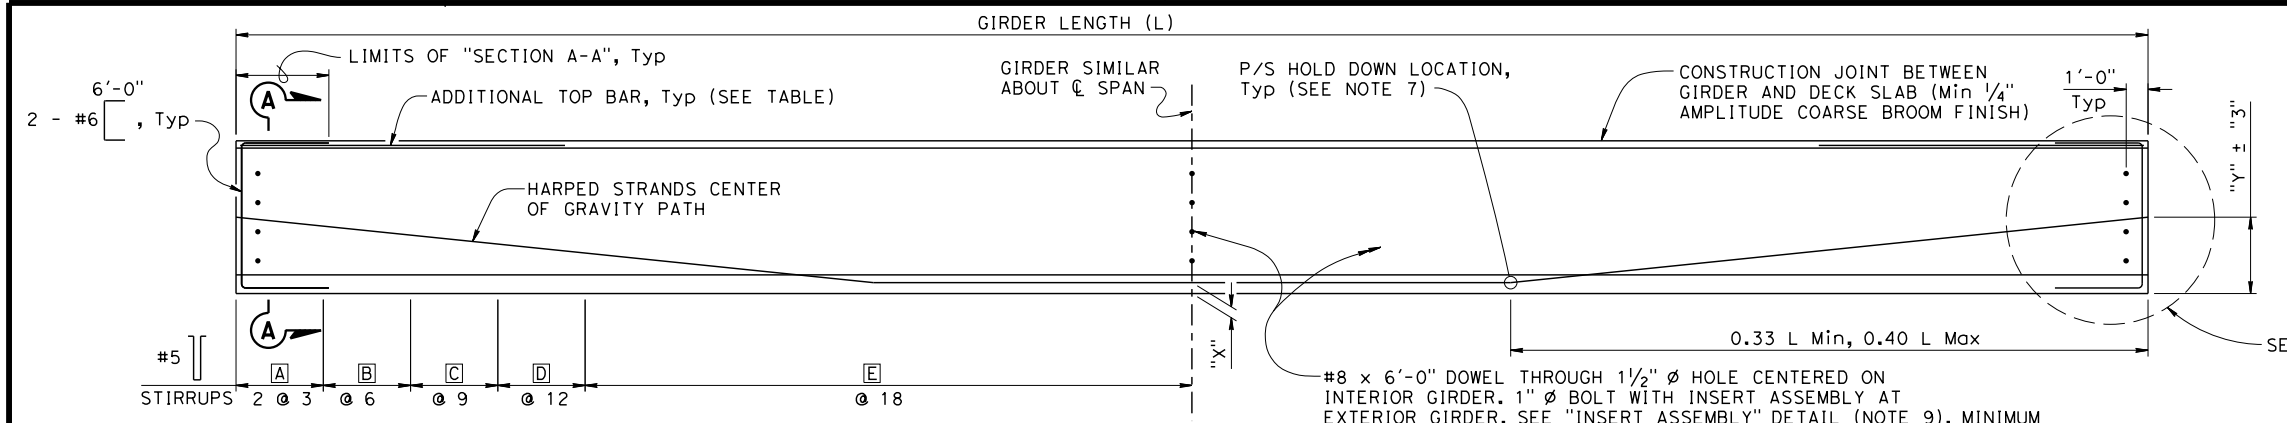

LOCATION	A	B	C	D	E
SPAN 1 GIRDERS	24 SPA	12 SPA	8 SPA	6 SPA	13 SPA
SPAN 3 GIRDERS	20 SPA	12 SPA	8 SPA	6 SPA	19 SPA


ELEVATION

NOTE:
Girder ends to be cast such that a level surface is provided at bearing pads


LOCATION	GIRDER LENGTH (L)	GIRDER DEPTH (D)	"x" (in)	JACKING FORCE (P) (kips)	As, min (in ²)	"y" (in)	CONCRETE STRENGTH (ksi)		MIDSPAN DEAD LOAD DEFLECTION (in)	
							f'ci	f'c	DECK	RAIL
SPAN 1 GIRDERS	84'-4"	4'-0"	-	1055	5.208	3.5	6.0	7.0	0.63	0.05
			3.5	176	0.868	20.5				
SPAN 3 GIRDERS	100'-4"	4'-0"	-	1494	7.378	5.68	6.0	7.0	1.25	0.09
			5.5	352	1.736	17.5				

NOTES

- The Jacking Force (P) is the jacking force required at the point of control along the span. The jacking force does not include any specific fabrication losses.
- Concrete strength:
f'ci is at time of initial stressing
f'c is at 28 days
- Deflection components are informational only and will be used to set screed line elevations.
- Screed line elevations for deck concrete will be determined by the Engineer.
- Prestressing strand shall be 270 ksi low relaxation.
- Contractor may interpolate "Jacking Force" and "x" values between the limits shown, as approved by the Engineer.
- There must be a minimum of two hold downs per girder for the prestressing within the span.
- As, min is the minimum area required of prestressing steel.
- For "INSERT ASSEMBLY" Detail, see "PC/PRETENSIONED WIDE FLANGE GIRDER (HARPED STRANDS MISC. DETAILS)" sheet.

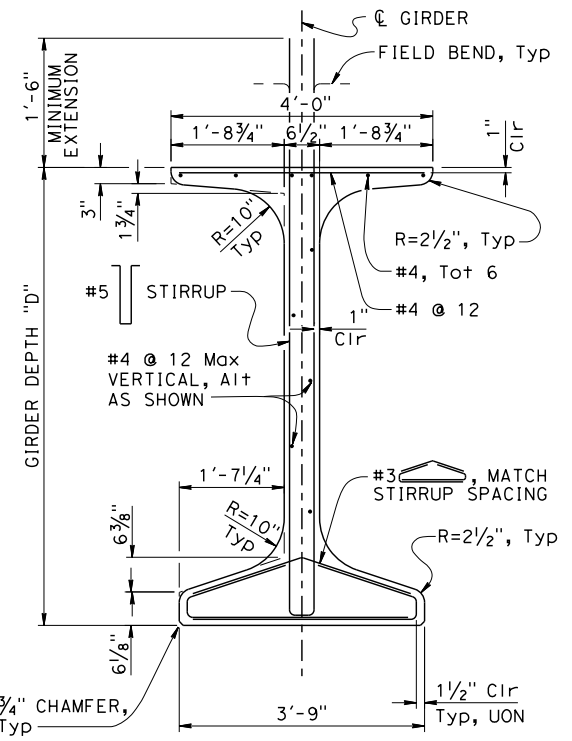


TYPICAL GIRDER SECTION

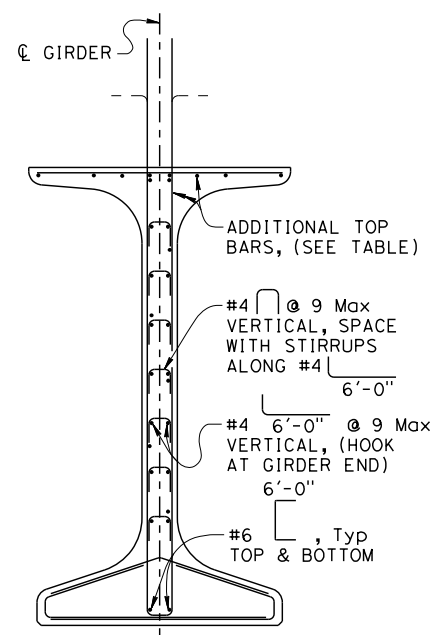

SECTION A-A

NOTE:
For details not shown, see "TYPICAL GIRDER SECTION"

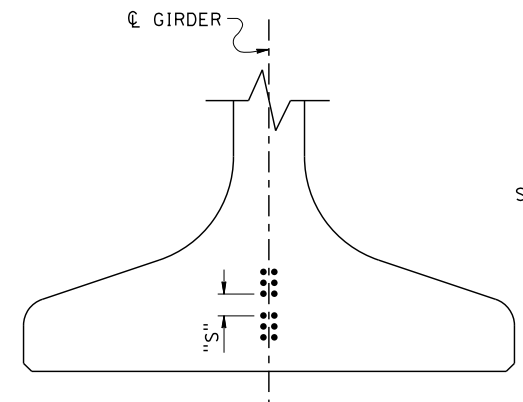

CLEARANCES FOR PRETENSIONED STRANDS

- STRAND CLEARANCES NOTES:
- Strands may be bundled in groups consisting of 3 vertically, 2 horizontally at midspan, and separated at the ends.
 - The minimum distance "S" between groups or individual strands is 1 3/4" for 0.5" Ø strand and 2" for 0.6" Ø strand.
 - "S" is measured between centers of adjacent strands.
 - Approval of Engineer is required for deviation.

PRECAST GIRDER DETAILS NO. 2

NO SCALE

EL DORADO TRAIL
MISSOURI FLAT ROAD
PEDESTRIAN OVERCROSSING

USERNAME => michael.wolohan
 FILE => 710099-m-xs1-124-1.dgn
 TIME PLOTTED => 1/23/2024 7:50:40 PM

BRIDGE STANDARD DETAILS xs1-124-1 FILE NO. October 2016 APPROVAL DATE <small>The components of the Bridge Standard Details have been prepared under the responsible charge of the Technical Owner, a registered civil engineer in the State of California.</small>		STATE OF CALIFORNIA DEPARTMENT OF TRANSPORTATION		DIVISION OF ENGINEERING SERVICES		BRIDGE NO. POST MILE		PC/PRETENSIONED WIDE FLANGE GIRDER (HARPED STRANDS)	
<small>Refer to: http://www.dot.ca.gov/hq/esc/techpubs/manual/bridgemanuals/bridge-standard-detail-sheets/index.html</small>		<small>FILE => 710099-m-xs1-124-1.dgn USERNAME => michael.wolohan TIME PLOTTED => 7:50:40 PM DATE PLOTTED => 1/23/2024</small>		<small>ORIGINAL SCALE IN INCHES FOR REDUCED PLANS</small>		<small>UNIT: PROJECT NUMBER & PHASE:</small>		<small>CONTRACT NO.:</small>	
				<small>DISREGARD PRINTS BEARING EARLIER REVISION DATES</small>		<small>REVISION DATES</small>		<small>SHEET 39 OF 42</small>	



DIST	COUNTY	ROUTE	POST MILES TOTAL PROJECT	SHEET No.	TOTAL SHEETS
03	ED	XX		40	42

Michael M. Wolohan 1/24/22
 REGISTERED CIVIL ENGINEER DATE


1/23/24
 PLANS APPROVAL DATE

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The Registered Civil Engineer for the project is responsible for the selection and proper application of the component design and any modifications shown.

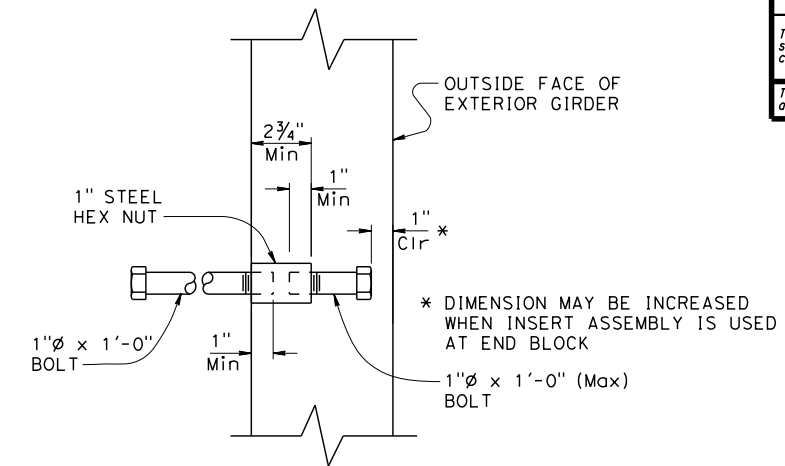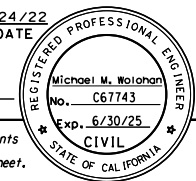


INSERT ASSEMBLY

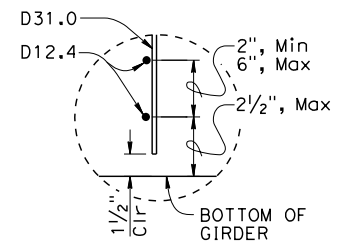


- NOTES:
- Bottom of stirrup WWR detail shown, top similar
 - Longitudinal wire area shall be 40% or greater of vertical deformed wire's area

DETAIL A

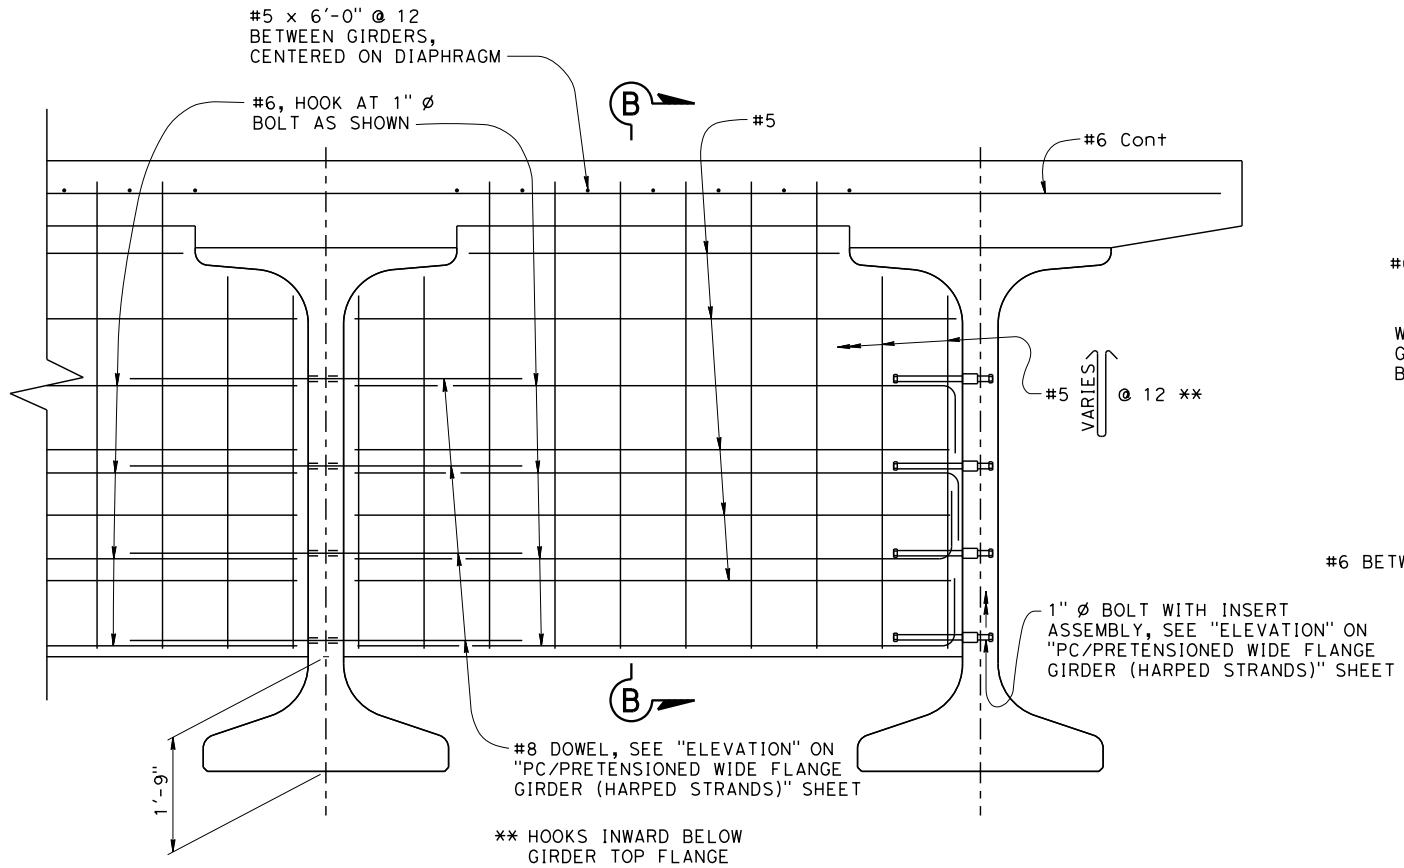


INTERMEDIATE DIAPHRAGM

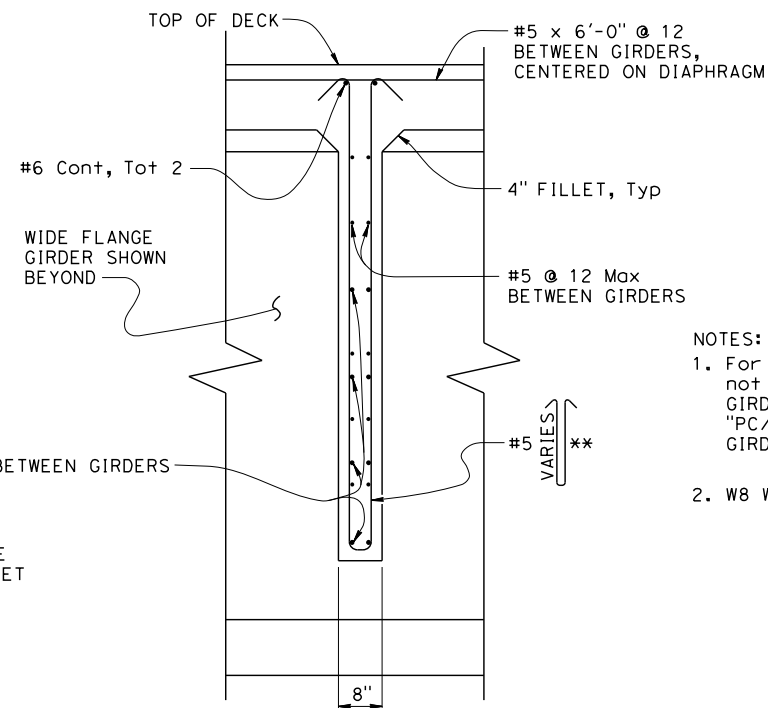

SECTION B-B

ADDITIONAL TOP BAR, SEE "PC/PRETENSIONED WIDE FLANGE GIRDER (HARPED STRANDS)" SHEET

- NOTES:
- For details shown but not noted, see "TYPICAL GIRDER SECTION" detail on "PC/PRETENSIONED WIDE FLANGE GIRDER (HARPED STRANDS)" sheet
 - W8 WWR not shown

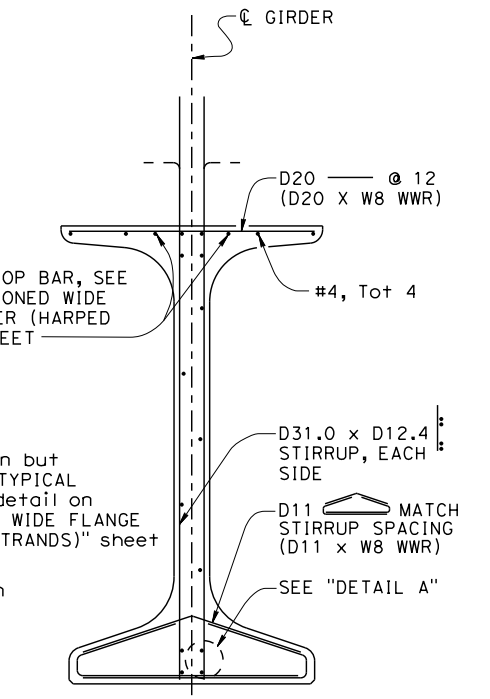

WELDED WIRE REINFORCEMENT (WWR) ALTERNATIVE

PRECAST GIRDER DETAILS NO. 3

NO SCALE

EL DORADO TRAIL
MISSOURI FLAT ROAD
PEDESTRIAN OVERCROSSING

PC/PRETENSIONED WIDE FLANGE GIRDER (HARPED STRANDS MISC. DETAILS)

USERNAME => michael.wolohan
FILE => 710099-m-xs1-124-2.dgn
TIME PLOTTED => 1/23/2024 7:56:06 PM

BRIDGE STANDARD DETAILS		
xs1-124-2	October 2016	The components of the Bridge Standard Details have been prepared under the responsible charge of the Technical Owner, a registered civil engineer in the State of California
FILE NO.	APPROVAL DATE	

FILE => 710099-m-xs1-124-2.dgn	ORIGINAL SCALE IN INCHES FOR REDUCED PLANS	0 1 2 3
USERNAME => michael.wolohan	DATE PLOTTED => 1/23/2024	

STATE OF CALIFORNIA DEPARTMENT OF TRANSPORTATION	DIVISION OF ENGINEERING SERVICES	BRIDGE NO.	POST MILE

UNIT: PROJECT NUMBER & PHASE:	CONTRACT NO.:	REVISION DATES	SHEET OF
		10-3-16 11-1-16	40 42

DISREGARD PRINTS BEARING EARLIER REVISION DATES

ELEVATION REFERENCE:
Boring elevations estimated from topographic data provided by T.Y. Lin International on 12/18/2017.

DIST	COUNTY	ROUTE	POST MILES TOTAL PROJECT	SHEET No	TOTAL SHEETS
03	ED	XX		41	42

08/20/18
CERTIFIED ENGINEERING GEOLOGIST DATE

1/23/24
PLANS APPROVAL DATE


The State of California or its officers or agents shall not be responsible for the accuracy or completeness of scanned copies of this plan sheet.

REGISTERED GEOLOGIST
DAVID A. KITZMANN
No. 2412
CERTIFIED ENGINEERING GEOLOGIST
STATE OF CALIFORNIA


WRECO
7807 LAGUNA BLVD., SUITE 400
ELK GROVE, CALIFORNIA 95758 WRECO JOB NO.: P17076

T.Y. LIN INTERNATIONAL
1545 RIVER PARK DRIVE, SUITE 201
SACRAMENTO, CA 95815

- Notes:
- Field classification of soils was in accordance with the Caltrans Soil & Rock Logging, Classification, and Presentation Manual (2010 Edition).
 - 1.4" samples were taken using a 1.375" ID split barrel sampler per Standard Penetration Test (SPT) performed in accordance with ASTM D 1586-11.
 - 1.4" samples were taken with an automated hammer system consisting of a hammer weight of 140 lbs. free falling a distance of 30". Autohammer energy ratio (ETR) measurements indicate an ETR=77%. The last 12" of an 18" drive were recovered as the blow count number required to drive the sampler.
 - The length of each sampled interval is shown graphically on the boring log. Whole number blow counts ("N") represent the "standard penetration resistance" interval in accordance with ASTM D1586-11. Where less than 1 foot of penetration is achieved, the blow count shown is for that fraction of the "standard penetration resistance" interval actually penetrated. Where indicated by an asterisk (*) the number of blows shown is for only that fraction of the initial 6" "seating drive" interval penetration. Material characteristics shown in () where estimated.
 - The blow counts shown on the logs are the raw blow counts which have not been corrected for hammer energy, sample size, overburden, or any other correction factor.
 - The apparent density of granular soil is based on a corrected Standard Penetration Test N60 value.
 - Rock classification according to Caltrans Soil and Rock Logging, Classification and Presentation manual (2010 Edition). Descriptions were determined in the field. REC = Core Recovered (percent). RQD = Rock Quality Designation (percent).
 - Boring locations were measuring in the field based on existing site features and correlated to topographic survey provided by T.Y. Lin International on 12/18/2017.
 - Electronic media for plan view provided by T.Y. Lin International on 12/18/2017.

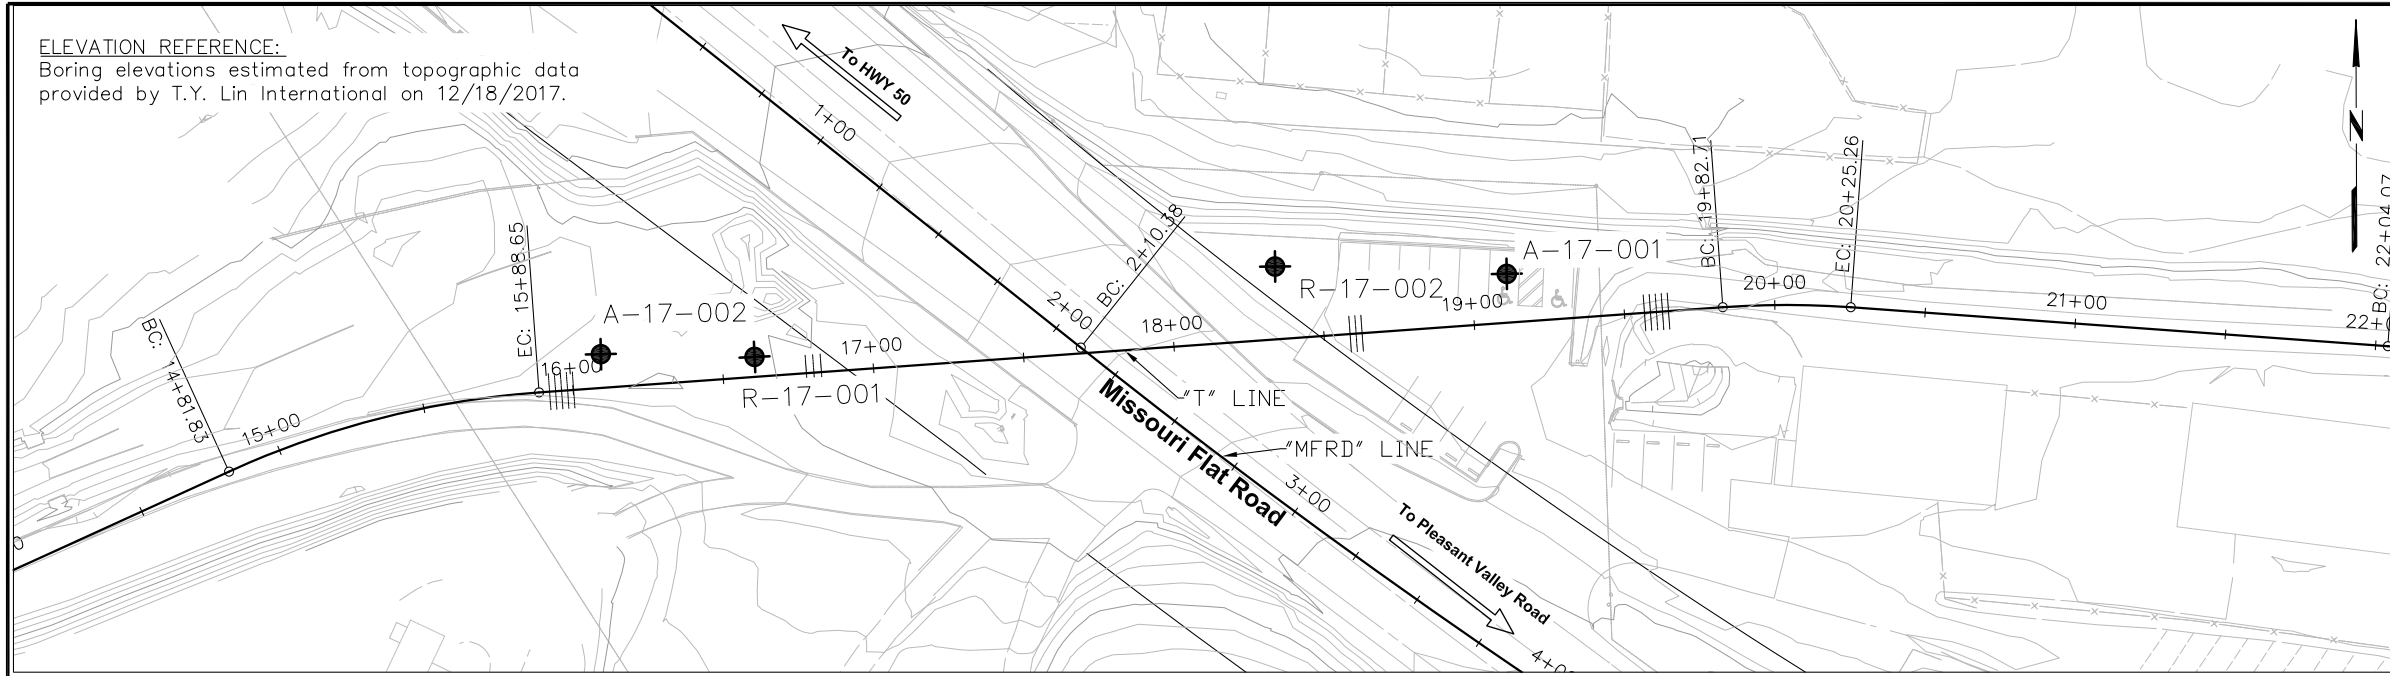

PLAN
1"=30'

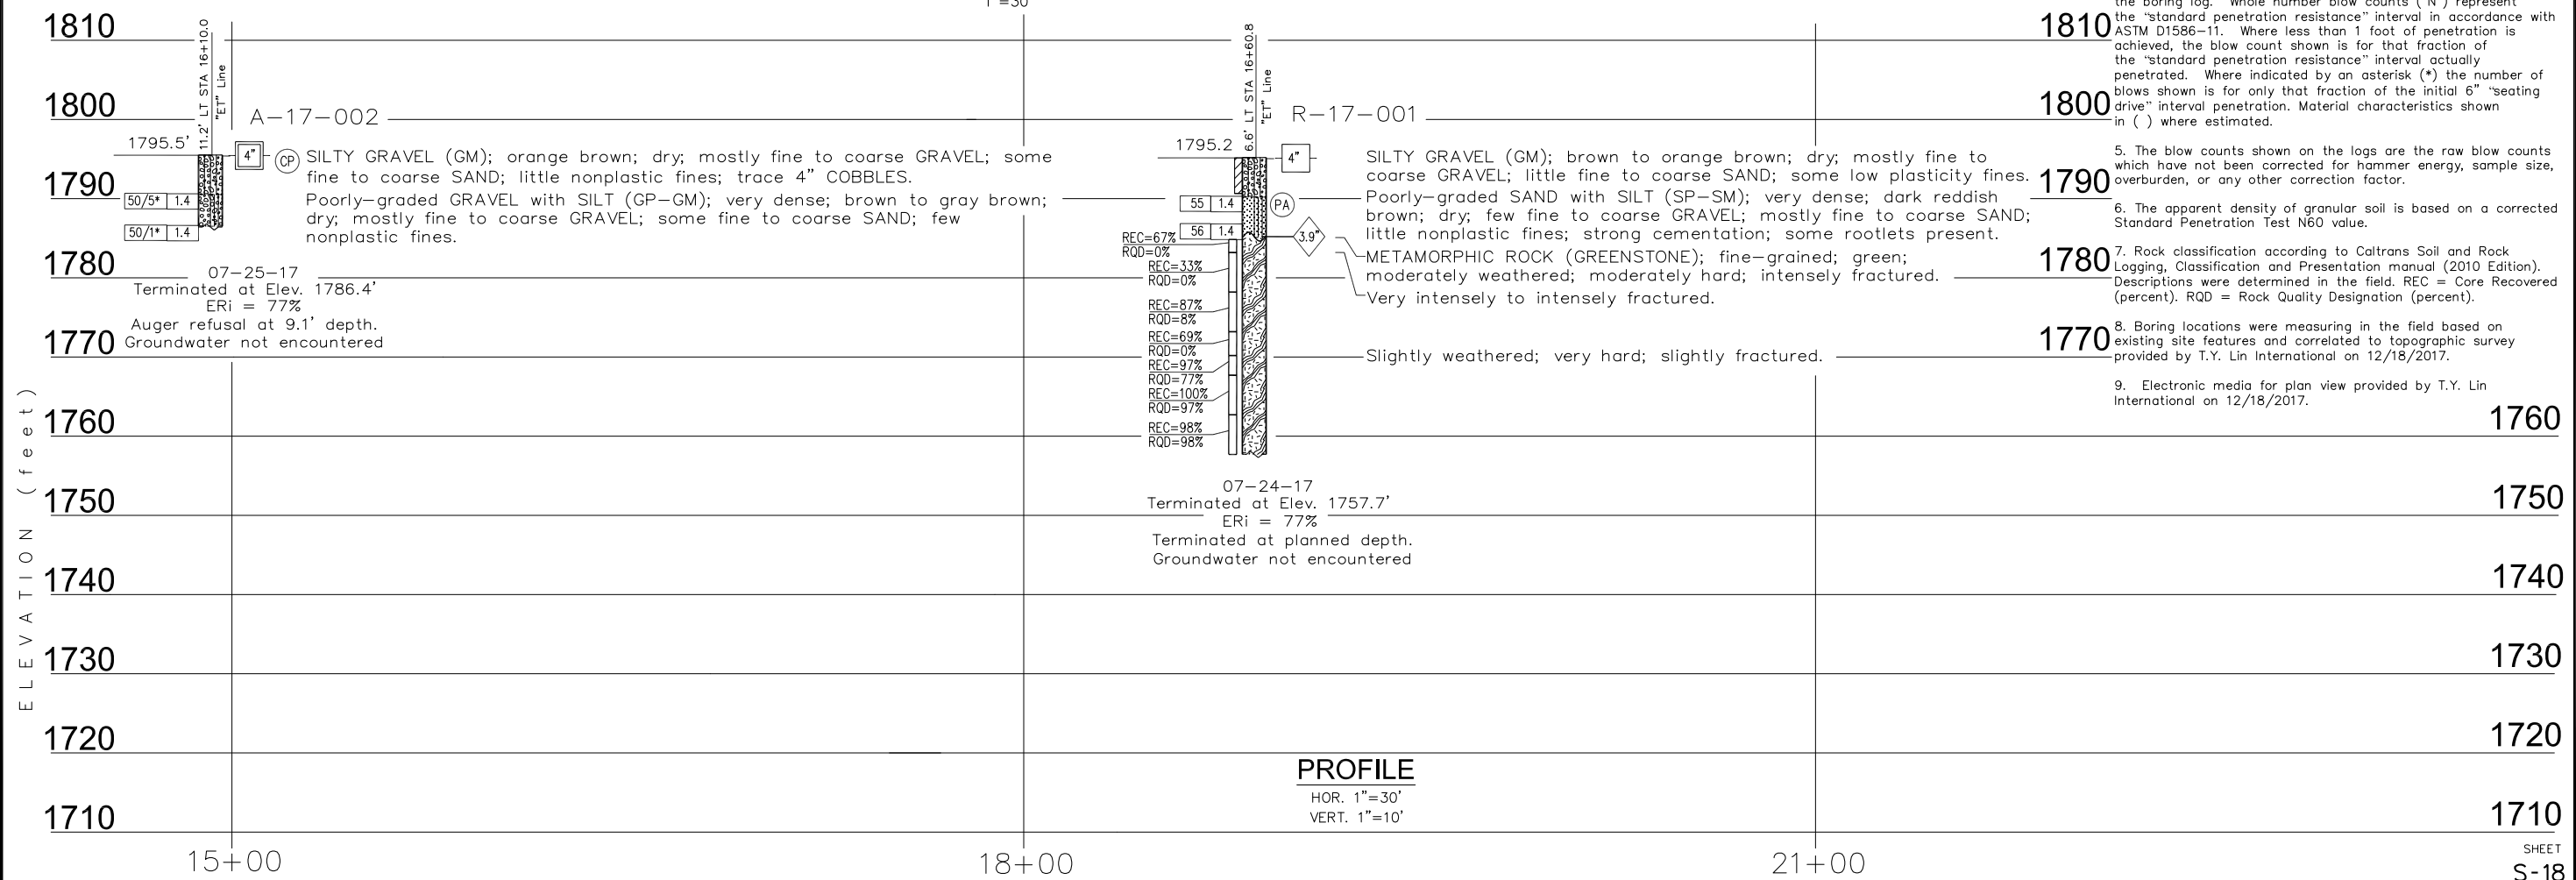


PROFILE
HOR. 1"=30'
VERT. 1"=10'

11/2/2015 OR_Missouri Flat LOTB_rev.dwg

DATE PLOTTED => \$DATE
TIME PLOTTED => \$TIME
USERNAME => \$USER

ENGINEERING SERVICES		GEOTECHNICAL SERVICES		PREPARED FOR THE EL DORADO COUNTY COMMUNITY DEVELOPMENT AGENCY	XX PROJECT ENGINEER	BRIDGE NO. XXX-XXXX	EL DORADO TRAIL AT MISSOURI FLAT ROAD BIKE/PED OC
FUNCTIONAL SUPERVISOR Name	DRAWN BY: D. Lukashov CHECKED BY: A. Kahn	FIELD INVESTIGATION BY: D. Lukashov	DATE: 07/24-25/17			POST MILE XX.XX	
OGS CIVIL LOG OF TEST BORINGS SHEET				ORIGINAL SCALE IN INCHES FOR REDUCED PLANS	CU XXXXXX EA XXXXXX	DISREGARD PRINTS BEARING EARLIER REVISION DATES	REVISION DATES (PRELIMINARY STAGE ONLY)
						SHEET 41	OF 42

ELEVATION REFERENCE:
Boring elevations estimated from topographic data provided by T.Y. Lin International on 12/18/2017.

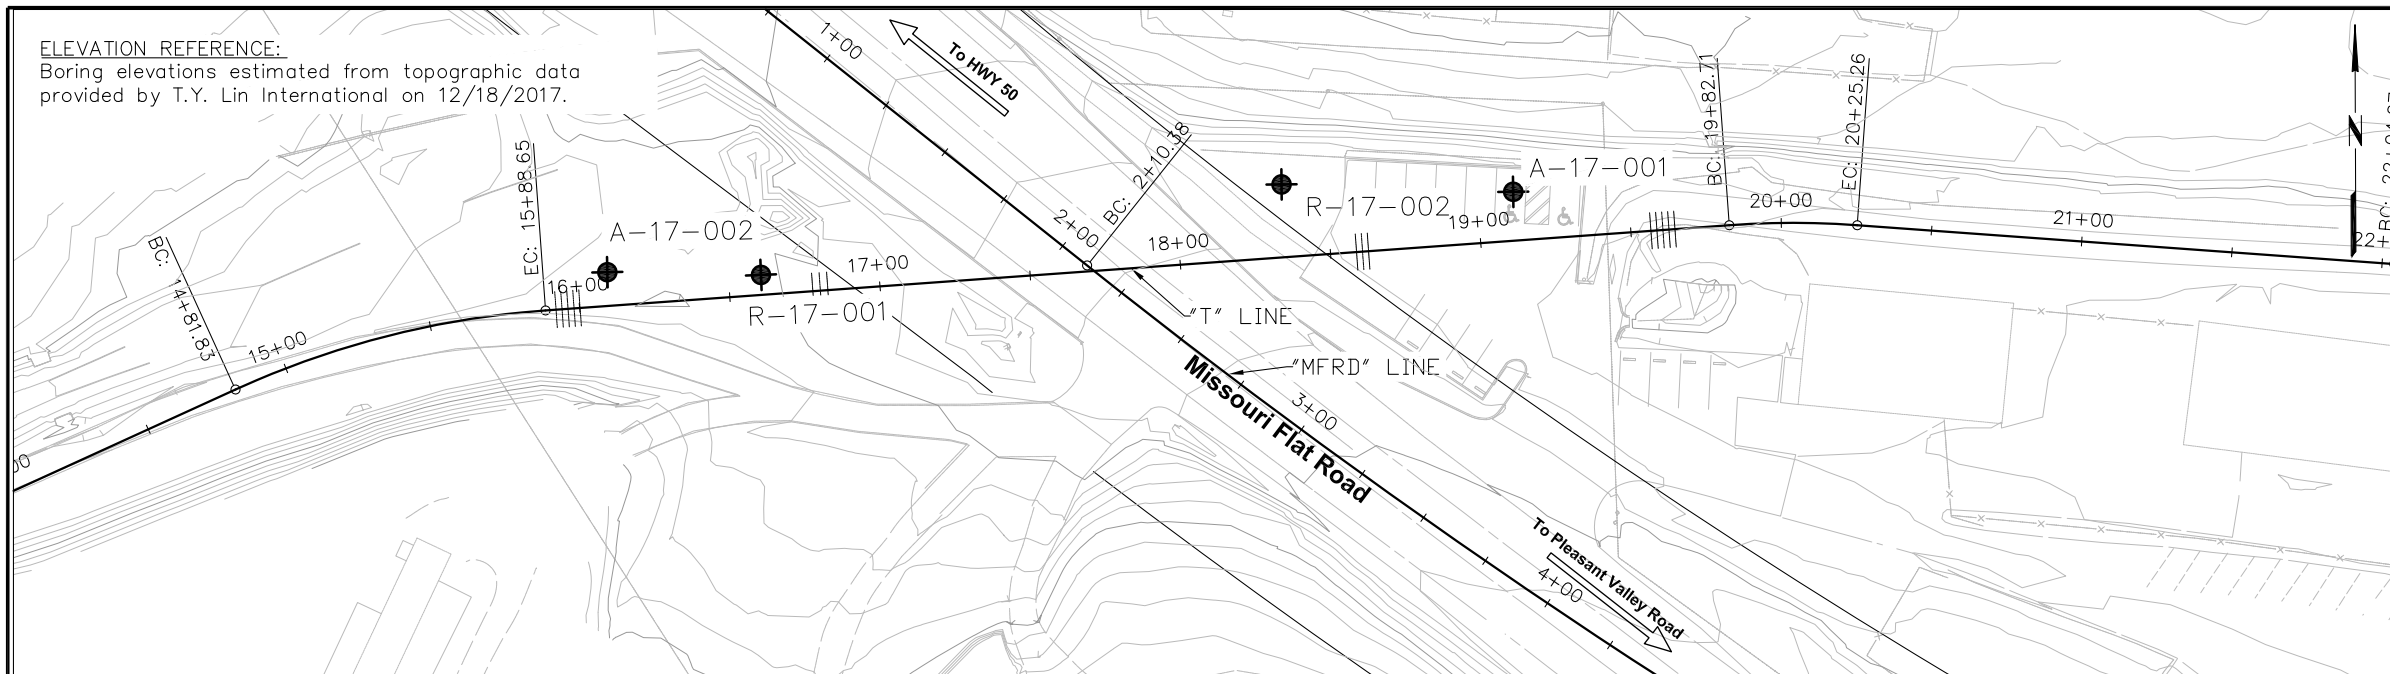


DIST	COUNTY	ROUTE	POST MILES TOTAL PROJECT	SHEET No	TOTAL SHEETS
03	ED	XX		42	42

CERTIFIED ENGINEERING GEOLOGIST
 DAVID A. KITZMANN
 No. 2412
 08/20/18
 DATE
 1/23/24
 PLANS APPROVAL DATE
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 WRECO
 7807 LAGUNA BLVD., SUITE 400
 ELK GROVE, CALIFORNIA 95758 WRECO JOB NO.: P17076
 T.Y. LIN INTERNATIONAL
 1545 RIVER PARK DRIVE, SUITE 201
 SACRAMENTO, CA 95815

- Notes:
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 - Boring locations were measuring in the field based on existing site features and correlated to topographic survey provided by T.Y. Lin International on 12/18/2017.
 - Electronic media for plan view provided by T.Y. Lin International on 12/18/2017.

PLAN
1"=30'

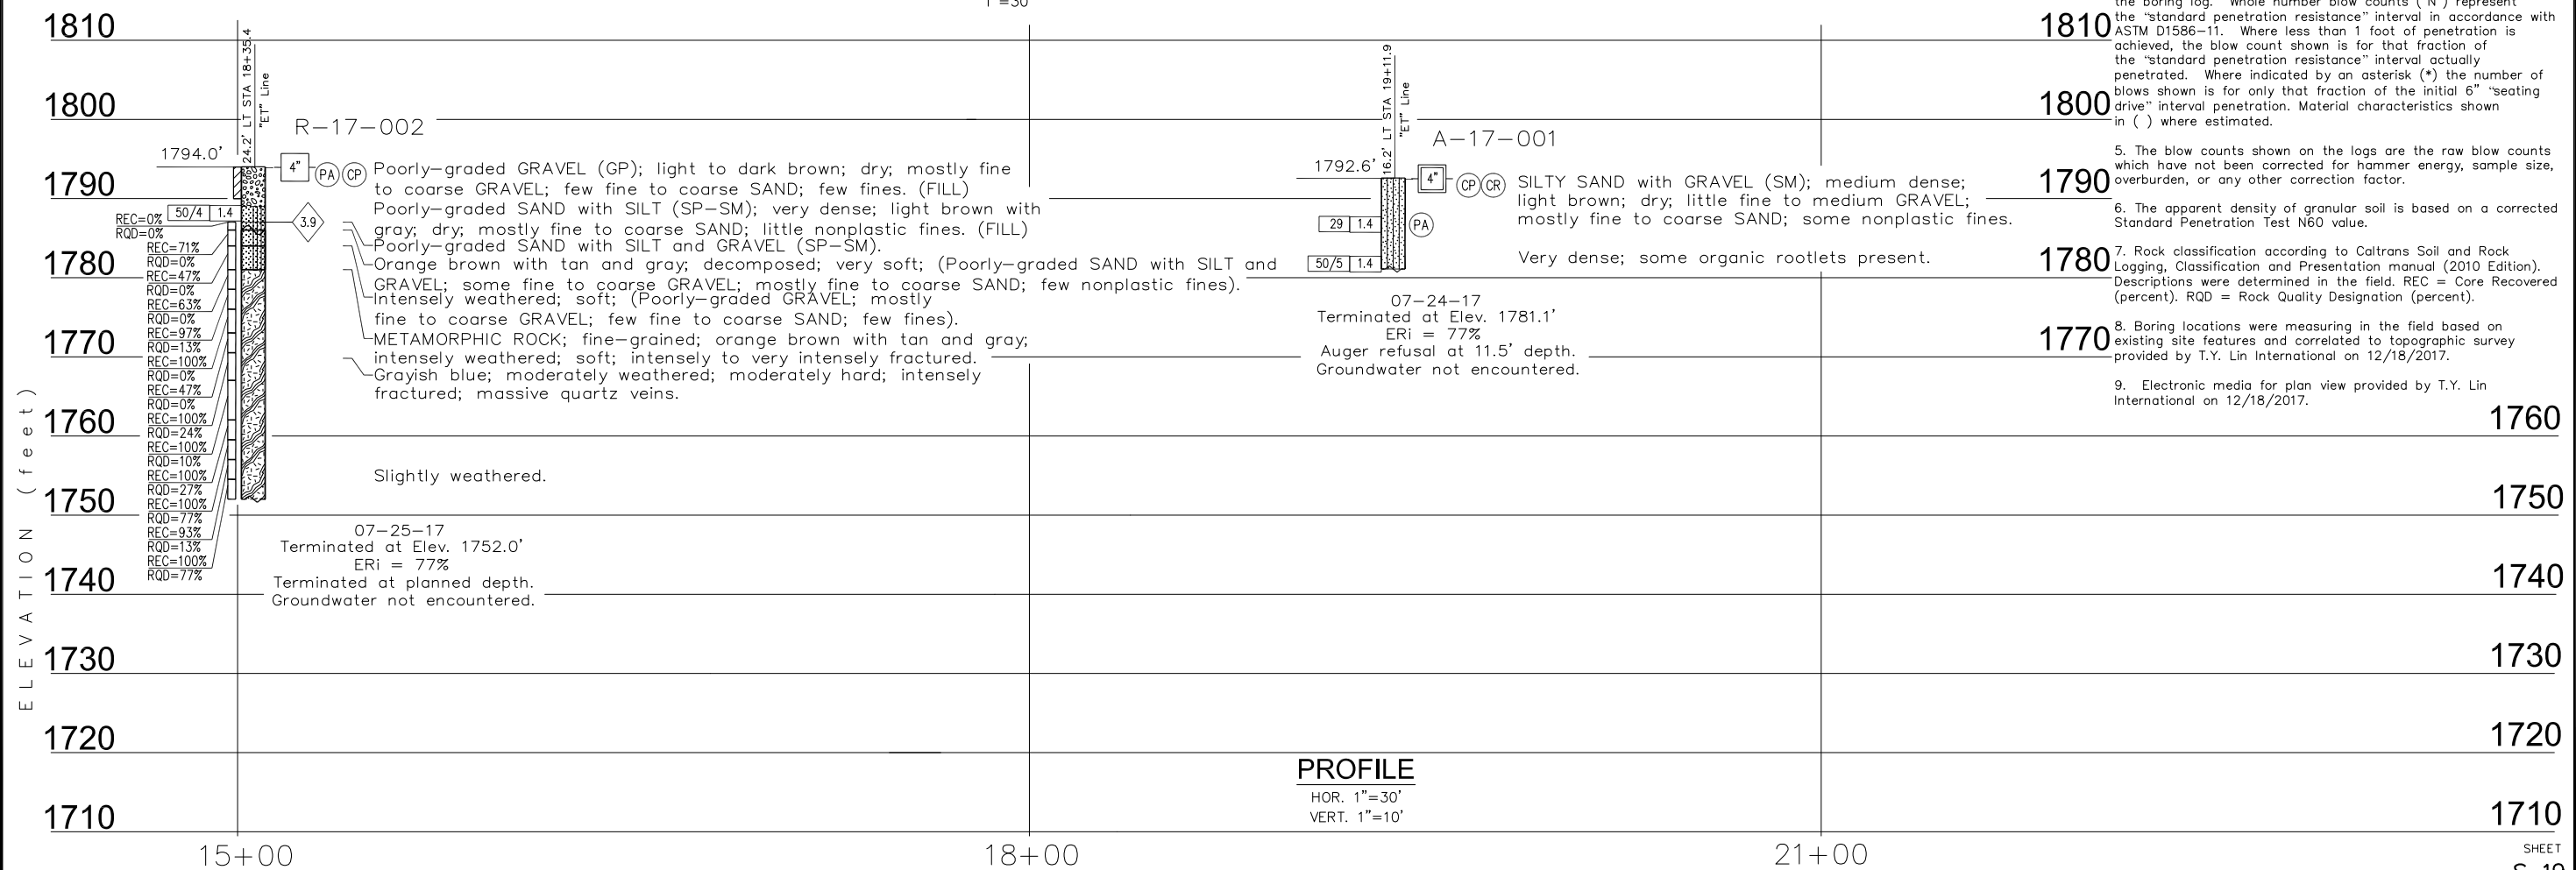

PROFILE
HOR. 1"=30'
VERT. 1"=10'

11/2/2015 CR_Missouri Flat LOTB_rev.dwg

DATE PLOTTED => \$TIME
USERNAME => \$USER

ENGINEERING SERVICES		GEOTECHNICAL SERVICES		PREPARED FOR THE EL DORADO COUNTY COMMUNITY DEVELOPMENT AGENCY	BRIDGE NO. XXX-XXXX	EL DORADO TRAIL AT MISSOURI FLAT ROAD BIKE/PED OC LOG OF TEST BORINGS 2 OF 2
FUNCTIONAL SUPERVISOR Name	DRAWN BY: D. Lukashov CHECKED BY: A. Kahn	FIELD INVESTIGATION BY: D. Lukashov	DATE: 07/24-25/17	XX PROJECT ENGINEER	POST MILE XX.XX	
OGS CIVIL LOG OF TEST BORINGS SHEET				ORIGINAL SCALE IN INCHES FOR REDUCED PLANS	CU XXXXXX EA XXXXXX	REVISION DATES (PRELIMINARY STAGE ONLY)
					DISREGARD PRINTS BEARING EARLIER REVISION DATES	SHEET 42 OF 42