



PROPERTY OWNER:

PROJECT MANAGER:

DATE:

DATE:

ZONING:

# SITE NUMBER: CVL03123 PLANNING DEPARTMEN SITE NAME: DRY CREEK JONESVILLE

6521 GREEN VALLEY ROAD **PLACERVILLE, CALIFORNIA 95667** 

JURISDICTION: COUNTY OF EL DORADO


APN: 317-250-56-100

PACE ID: MRSFR073684, FA: 13787633, PTN: 3701A0WDE3

# SITE TYPE: MONOPINE/CO-LOCATION

WRITING OF ANY DISCREPANCIES BEFORE PROCEEDING WITH THE WORK OR MATERIAL ORDERS OR BE RESPONSIBLE FOR THE SAME, CONTRACTOR SHALL USE

BEST MANAGEMENT PRACTICE TO PREVENT STORM WATER POLLUTION DURING

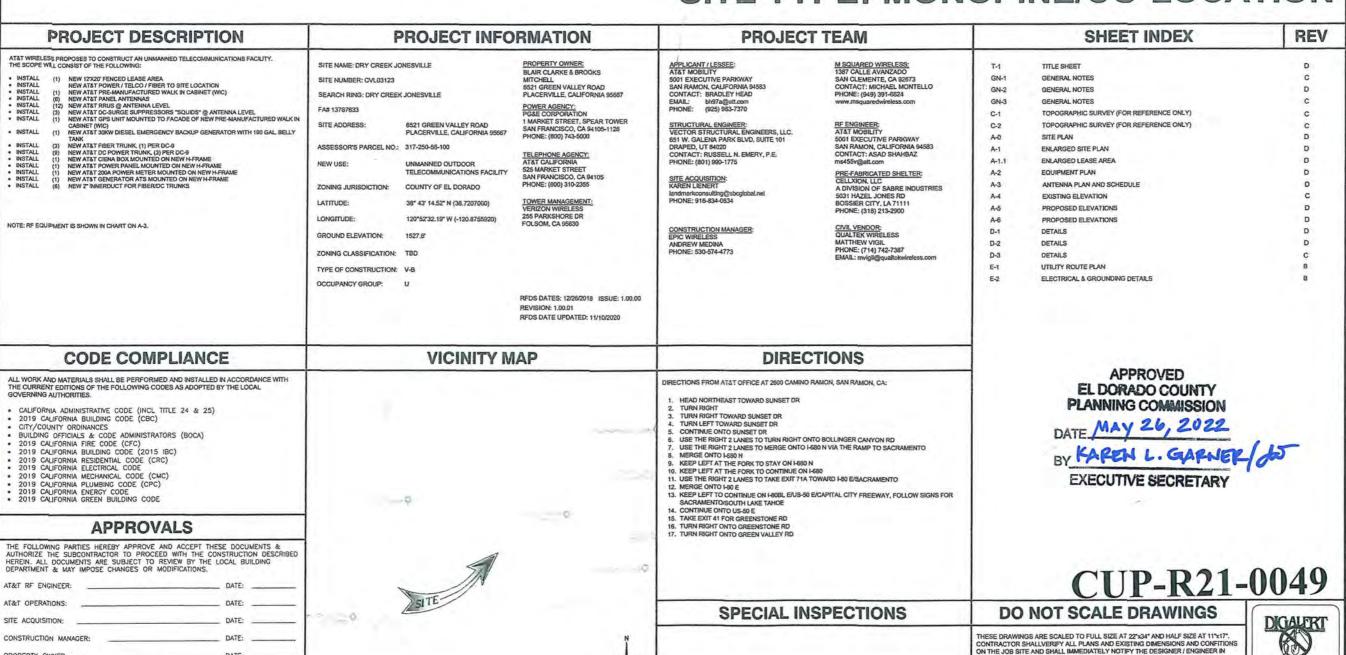

DRY CREEK **JONESVILLE** 6521 GREEN VALLEY ROAD PLACERVILLE, CALIFORNIA 95667



SAN RAMON, CALIFORNIA 94583





AT&T SITE NO: CVL0312 ROJECT NO 13787633

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D	07/21/2021	100% ZOs REV-RFDS/RLS	WD
C	04/26/2021	100% ZDa	姬
В	05/22/2021	100% ZDa	SD
A	02/08/2021	90% ZDo FOR REVIEW	50
REV	DATE	DESCRIPTION	BY

1-800-422-4133 Working Days Before You C Understanding Service Australian of southern CALPGRISA

IT IS A VIOLATION OF LAW FOR ANY PERSON, UNLESS THEY ARE ACTING UNDER THE DIRECTION OF A LICENS PROFESSIONAL ENGINEER, TO ALTER THIS DOCUMENT.

SHEET TITLE

TITLE SHEET

SHEET NUMBER

T-1

GENERAL CONSTRUCTION NOTES:

FOR THE PURPOSE OF CONSTRUCTION DRAWINGS, THE FOLLOWING DEFINITIONS SHALL APPLY: FOR THE PURPOSE OF CONSTRUCTION DRAWINGS, GENERAL CONTRACTOR — GENERAL CONTRACTOR SUBCONTRACTOR - CONTRACTOR (CONSTRUCTION) OWNER - AT&T

OWNER - AT&T

2. ALL SITE WORK SHALL BE COMPLETED AS INDICATED ON THE DRAWINGS AND AT&T PROJECT SPECIFICATIONS.

3. CENERAL CONTRACTOR AND SUBCONTRACTOR SHALL VISIT THE SITE AND SHALL FAMILIARIZE HIMSELF WITH ALL CONDITIONS AFFECTING THE NEW WORK AND SHALL MAKE PROVISIONS. GENERAL CONTRACTOR AND SUBCONTRACTOR SHALL BE RESPONSIBLE FOR FAMILIARIZING HIMSELF WITH ALL CONTRACT DOCUMENTS. FIELD CONDITIONS, DIMENSIONS, AND CONTRINING THAT THE WORK MAY BE ACCOMPLISHED AS SHOWN PRIOR TO PROCEEDING WITH CONSTRUCTION. ANY DISCREPANCIES SHALL BE BROUGHT TO THE ATTENTION.

PRIOR TO PROCECDING WITH CONSTRUCTION. ANY DISCREPANCIES SHALL BE BROUGHT TO THE ATTENTION OF THE ARCHTECT/ENGINEER PRIOR TO THE COMMENCEMENT OF WORK.

4. ALL MATERIALS FURNISHED AND INSTALLED SHALL BE IN STRICT ACCORDANCE WITH ALL APPLICABLE CODES, REGULATIONS, AND ORDINANCES, GENERAL CONTRACTOR SHALL ISSUE ALL APPROPRIATE NOTICES AND COMPLY WITH ALL LATAT, ORDINANCES, RULES, REGULATIONS, AND LAWPUL ORDERS OF ANY PUBLIC AUTHORITY REGARDING THE PERFORMANCE OF WORK.

5. ALL WORK CARRIED OUT SHALL COMPLY WITH ALL APPLICABLE MUNICIPAL AND UTILITY COMPANY SPECIFICATIONS AND LOCAL JURISDICTIONAL CODES, ORDINANCES, AND APPLICABLE REGULATIONS.

6. UNLESS NOTEO OTHERWISE, THE WORK SHALL INCLUDE FURNISHING MATERIALS, EQUIPMENT, APPURTENANCES, AND LABOR NECESSARY TO COMPLETE ALL INSTALLATIONS AS INDICATED ON THE DRAWNINGS.

7. PLANS ARE NOT TO BE SCALED, THESE PLANS ARE INTENDED TO BE A DIAGRAMMATIC OUTLINE ONLY PLANS ARE NOT TO BE SCALED. THESE PLANS ARE INTENDED TO BE A DURGRAMMATIC OUTLINE ONLY UNLESS OTHERWISE NOTED. DIMENSIONS SHOWN ARE TO FINISH SURFACES UNLESS OTHERWISE NOTED. SPACING BETWEEN EQUIPMENT IS THE MINIMUM REQUIRED CLEARANCE. THEREFORE, IT IS CRITICAL TO FIELD VERRY DIMENSIONS, SHOULD THERE BE ANY QUESTIONS REGARDING THE CONTRACT DOCUMENTS, THE SUBCONTRACTOR SHALL BE RESPONSIBLE FOR OBTAINING A CLARIFICATION FROM THE ARCHITECT/PSICIENCE PRIOR TO PROCEEDING WITH THE WORK. DETAILS ARE INTENDED TO SHOWN DESIGN INTENT. MODIFICATIONS MAY BE REQUIRED TO SUIT JOB DIMENSIONS OR CONDITIONS AND SUCH INTENT. MODIFICATIONS MAY BE REQUIRED TO SUIT JOB DIMENSIONS OR CONDITIONS AND SUCH MODIFICATIONS SHALL BE INCLUDED AS PART OF WORK AND PREPARED BY THE ARCHITECT/ENGINEER PRIOR TO PROCEEDING WITH WORK

8. THE SUBCONTRACTOR SHALL INSTALL ALL EQUIPMENT AND MATERIALS IN ACCORDANCE WITH MANUFACTURER'S RECOMMENDATIONS UNLESS SPECIFICALLY STATED OTHERWISE.

9. IF THE SPECIFIED EQUIPMENT CANNOT BE INSTALLED AS SHOWN ON THESE DRAWINGS, THE

9, IF THE SPECIFIED EQUIPMENT CANNOT BE INSTALLED AS SHOWN ON THESE DRAWNINGS, THE SUBCONTRACTOR SHALL PROPOSE AN ALTERNATIVE SPACE FOR APPROVAL BY THE ARCHITECT/ENGINEER PRIOR TO PROCEEDING.

10. GENERAL CONTRACTOR SHALL BE RESPONSIBLE FOR THE SAFETY OF WORK AREA, ADJACENT AREAS AND BUILDING OCCUPANTS THAT ARE LIKELY TO BE AFFECTED BY THE WORK UNDER THIS CONTRACT. WORK SHALL CONFORM TO ALL OSHA REQUIREMENTS AND THE LOCAL JURISDICTION.

11. GENERAL CONTRACTOR SHALL COORDINATE WORK AND SCHEDULE WORK ACTIVITIES WITH OTHER DISCUSSIONS.

12. ERECTION SHALL BE DONE IN A WORKMANLIKE MANNER BY COMPETENT EXPERIENCED WORKMAN IN ACCORDANCE WITH APPLICABLE CODES AND THE BEST ACCEPTED PRACTICE, ALL MEMBERS SHALL BE LAID PLUMB AND TRUE AS INDICATED ON THE DRAWINGS.

1.3. SEAL PENETRATIONS THROUGH FIRE RATED AREAS WITH UL LISTED MATERIALS APPROVED BY LOCAL

13. SEAL PENEITRATIONS THROUGH FIRE RATED AREAS WITH UL LISTED MATERIALS APPROVED BY LOCAL JURISDICTION, SUBCONTRACTOR SHALL KEEP AREA CLEAN, HAZARD FREE, AND DISPOSE OF ALL DEBRIS.
14. WORK PREVIOUSLY COMPLETED IS REPRESENTED BY LIGHT SHADED LINES AND NOTES. THE SCOPE OF WORK FOR THIS PROJECT IS REPRESENTED BY DARK SHADED LINES AND NOTES, SUBCONTRACTOR SHALL NOTIFY THE GENERAL CONTRACTOR OF ANY EXISTING CONDITIONS THAT DEVIATE FROM THE DRAWINGS PRIOR TO THE BEGINNING CONSTRUCTION.
15. SUBCONTRACTOR SHALL PROVIDE WRITTEN NOTICE TO THE CONSTRUCTION MANAGER 48 HOURS PRIOR TO COMMENCEMENT.

COMMENCEMENT OF WORK.

16. THE SUBCONTRACTOR SHALL PROTECT EXISTING IMPROVEMENTS, PAVEMENTS, CURBS, LANDSCAPING AND

STRUCTURES, ANY DAMAGED PART SHALL BY STRUCTURES, ANY DAMAGED PART SHALL BE REPAIRED AT SUBCONTRACTOR'S EXPENSE TO THE SATISFACTION OF THE OWNER.

17. THE SUBCONTRACTOR SHALL CONTACT UTILITY LOCATING SERVICES PRIOR TO THE START OF CONSTRUCTION.

18. GENERAL CONTRACTOR SHALL COORDINATE AND MAINTAIN ACCESS FOR ALL TRADES AND

 SENERAL CONTRACTOR SHALL COORDINATE AND MAINTAIN ACCESS FOR ALL TRADES AND SUBCONTRACTORS TO THE SITE AND/OR BUILDING.
 THE GENERAL CONTRACTOR SHALL BE RESPONSIBLE FOR SECURITY OF THE SITE FOR THE DURATION OF CONSTRUCTION UNTIL JOB COMPLETION.
 THE GENERAL CONTRACTOR SHALL MAINTAIN IN GOOD CONDITION ONE COMPLETE SET OF PLANS WITH ALL REVISIONS, ADDENDA, AND CHANGE ORDERS ON THE PREMISES AT ALL TIMES.
 THE GENERAL CONTRACTOR AND SUBCONTRACTOR SHALL PROVIDE PORTABLE FIRE EXTINGUISHERS WITH A RATING OF NOT LESS THAN 2-A OT 2-A:10-B:C AND SHALL BE WITHIN 25 FEET OF TRAVEL DISTANCE TO ALL PORTIONS OF WHERE THE WORK IS BEING COMPLETED DURING CONSTRUCTION 22. ALL EXISTING ACTIVE SEWER, WATER, GAS, ELECTRIC, AND OTHER UTILITIES SHALL BE PROTECTED AT ALL TIMES, AND WHERE REQUIRED FOR THE PROPER EXECUTION OF THE WORK, SHALL BE RELOCATED AS DIRECTED BY THE ARCHITECT/PRIGNERE EXTREME CAUTIONS SHOULD BE USED BY THE SUBCONTRACTOR DIRECTED BY THE ARCHITECT/ENGINEER EXECUTION OF THE WORK, SHALL BE RELOCATED AS DIRECTED BY THE ARCHITECT/ENGINEER EXTREME CAUTION SHOULD BE USED BY THE SUBCONTRACTOR WHEN EXCAVATING OR DRILLING PIERS AROUND OR NEAR LITUTIES. SUBCONTRACTOR SHALL PROVIDE SAFETY TRAINING FOR THE WORKING CREW. THIS SHALL INCLUDE BUT NOT BE LIMITED TO A) FALL PROTECTION, B) CONFINED SPACE, C) ELECTRICAL SAFETY, D) TRENCHING & EXCAVATION.

23. ALL EXISTING INACTIVE SEWER, WATER, GAS, ELECTRIC, AND OTHER UTILLITIES, WHICH INTERFERE WITH THE EXECUTION OF THE WORK, SHALL BE REMOVED, CAPPED, PLUGGED OR OTHERWED ISCONNECTED AT POINTS WHICH WILL NOT INTERFERE WITH THE EXECUTION OF THE WORK, AS DIRECTED BY THE

RESPONSIBLE ARCHITECT/ENGINEER, AND SUBJECT TO THE APPROVAL OF THE OWNER AND/OR LOCAL

24. THE AREAS OF THE DWNER'S PROPERTY DISTURBED BY THE WORK AND NOT COVERED BY THE TOWER. EQUIPMENT OR DRIVEWAY, SHALL BE GRADED TO A UNIFORM SLOPE, AND STABILIZED TO PREVENT

EROSION.

5. SUBCONTRACTOR SHALL MINIMIZE DISTURBANCE TO THE EXISTING SITE DURING CONSTRUCTION. EROSION CONTROL MEASURES, IF REQUIRED DURING CONSTRUCTION, SHALL BE IN CONFORMANCE WITH THE FEDERAL AND LOCAL JURISDICTION FOR EROSION AND SEDIMENT CONTROL.

5. NO FILL OR EMBANKMENT MATERIAL, SHALL BE PLACED ON FROZEN GROUNDING, FROZEN MATERIALS, SNOW OR ICC SHALL NOT BE PLACED IN ANY FILL OR EMBANKMENT.

7. THE SUBGRADE SHALL BE BROUGHT TO A SMOOTH UNIFORM GRADE AND COMPACTED TO 95 PERCENT STRANDARD PROCTOR DENSITY UNDER PAYEMENT AND STRUCTURES AND BO PERCENT STRANDARD PROCTOR DENSITY UNDER PAYEMENT AND STRUCTURES AND BO PERCENT STRANDARD PROCTOR

STANDARD PROCIOR DENSITY UNDER PAWEMENT AND STRUCTURES AND BO PERCENT STANDARD PROCIOR DENSITY IN OPEN SPACE, ALL TRENCHES IN PUBLIC RIGHT OF WAY SHALL BE BACKFILLED WITH FLOWABLE FILL OR OTHER MATERIAL PRE—APPROVED BY THE LOCAL JURISDICTION.

ALL NECESSARY RUBBISH, STUMPS, DEBRIS, STICKS, STONES, AND OTHER REFUSE SHALL BE REMOVED FROM THE SITE AND DISPOSED OF IN A LAWFUL WANNER.

ALL BROCHURES, OPERATING AND MAINTENANCE MANUALS, CATALOGS, SHOP DRAWINGS, AND OTHER DOCUMENTS SHALL BE TURNED OVER TO THE GENERAL GONTRACTOR AT COMPLETION OF CONSTRUCTION AND DEBUG TO DAYWED TO DAYWED. AND PRIOR TO PAYMENT.

AND PRIOR TO PAYMENT.

30. SUBCONTRACTOR SHALL SUBMIT A COMPLETE SET OF AS-BUILT REDLINES TO THE GENERAL CONTRACTOR UPON COMPLETION OF PROJECT AND PRIOR TO FINAL PAYMENT.

31. SUBCONTRACTOR SHALL LEAVE PREMISES IN A CLEAN CONDITION.

32. THE NEW FACILITY WILL BE UNMANNED AND DOES NOT REQUIRE POTABLE WATER OR SEWER SERVICE, AND IS NOT FOR HUMAN HABITAT (NO HANDICAP ACCESS REQUIRED).

33. OCCUPANCY IS LIMITED TO PERIODIC MAINTENANCE AND INSPECTION, APPROXIMATELY 2 TIMES PER HANDEL BY ALTHE TECHNICIANS.

MONTH, BY AT&T TECHNICIANS.

MONTH, BY AT&T TECHNICIANS.

34. NO OUTDOOR STORAGE OR SOLID WASTE CONTAINERS ARE NEW.

35. ALL MATERIAL SHALL BE FURNISHED AND WORK SHALL BE PERFORMED IN ACCORDANCE WITH THE LATEST REVISION AT&T MOBILITY GROUNDING STANDARD "TECHNICAL SPECIFICATION FOR CONSTRUCTION OF GSM/GPRS WIRELESS SITES" AND "TECHNICAL SPECIFICATION FOR FACILITY GROUNDING". IN CASE OF A CONFLICT BETWEEN THE CONSTRUCTION SPECIFICATION AND THE DRAWINGS, THE DRAWINGS SHALL

36. SUBCONTRACTORS SHALL BE RESPONSIBLE FOR OBTAINING ALL PERMITS AND INSPECTIONS REQUIRED FOR CONSTRUCTION. IF SUBCONTRACTOR CANNOT OBTAIN A PERMIT, THEY MUST NOTIFY THE GENERAL CONTRACTOR IMMEDIATELY.

37. SUBCONTRACTOR SHALL REMOVE ALL TRASH AND DEBRIS FROM THE SITE ON A DAILY BASIS.

38. INFORMATION SHOWN ON THESE DRAWINGS WAS OBTAINED FROM SITE VISITS AND/OR DRAWINGS PROVIDED BY THE SITE OWNER. CONTRACTIORS SHALL NOTIFY THE ENGINEER OF ANY DISCREPANCIES PRIOR TO ORDERING MATERIAL OR PROCEEDING WITH CONSTRUCTION.

39. NO WHITE STROBIC LIGHTS ARE PERMITTED. LIGHTING IF REQUIRED, WILL MEET FAA STANDARDS AND REQUIREMENTS.

40. ALL COAXIAL CABLE INSTALLATIONS TO FOLLOW MANUFACTURER'S INSTRUCTIONS AND RECOMMENDATIONS.

41 NO NOISE, SMOKE, DUST, OR VIBRATIONS WILL RESULT FROM THIS FACILITY. (DISREGARD THIS NOTE IF

THIS SITE HAS A GENERATOR)
42. NO ADDITIONAL PARKING TO BE NEW . EXISTING ACCESS AND PARKING TO REMAIN, UNLESS NOTED

43. NO LANDSCAPING IS NEW AT THIS SITE, UNLESS NOTED OTHERWISE

**ELECTRICAL NOTES:** 

ELECTRICAL CONTRACTOR SHALL SUPPLY AND INSTALL ANY/ALL ELECTRICAL WORK INDICATED. ANY/ALL CONSTRUCTION SHALL BE IN ACCORDANCE W/DRAWINGS AND ANY/ALL APPLICABLE SPECIFICATIONS. IF ANY PROBLEMS ARE ENCOUNTERED BY COMPLYING WITH THESE REQUIREMENTS, CONTRACTOR SHALL NOTIFY 'CONSTRUCTION MANAGER' AS SOON AS POSSIBLE, AFTER THE DISCOVERY OF THE PROBLEMS. AND SHALL NOT PROCEED WITH THAT PORTION OF WORK, UNTIL THE 'CONSTRUCTION MANAGER' HAS

AND SHALL NOT PROCEED WITH THAT PORTION OF WORK, UNTIL THE 'CONSTRUCTION MANAGER' HAS DIRECTED THE CORRECTIVE ACTIONS TO BE TAKEN,

ELECTRICAL CONTRACTOR SHALL VISIT THE JOB SITE AND FAMILIARIZE HIMSELF WITH ANY/ALL CONDITIONS AFFECTING ELECTRICAL CONTRACTOR, DRIVEN THEREOF, ALL EXISTING CONDITIONS OF ELECTRICAL SOLUP, LIGHT FIXTURES, ETC., THAT ARE PART OF THE FINAL SYSTEM, SHALL BE VERIFIED BY THE CONTRACTOR, PRIOR TO THE SUBMITTING OF HIS BID. FAILURE TO COMPLY WITH THIS PARAGRAPH WILL IN NO WAY RELIEVE CONTRACTOR OF PERFORMING ALL WORK NECESSARY FOR A COMPLETE AND WORKING SYSTEM.

3. ALL WORK SHALL BE PERFORMED IN ACCORDANCE WITH THE LATEST EDITION OF THE NEC AND ALL CODES AND LOCAL ORDINANCES OF THE LOCAL POWER & TELEPHONE COMPANIES HAVING JURISDICTION AND SHALL INCLUDE BUT NOT BE LIMITED TO:

C - NATIONAL FIRE CODES

A. UL - UNDERWRITERS LABORATORIES

B. NEC - NATIONAL ELECTRICAL MANUFACTURERS ASSOC.

D. OSHA - OCCUPATIONAL SECTRICAL CODE

C. NEMA - NATIONAL ELECTRICAL MANUFACTURERS ASSOC.

D. OSHA - OCCUPATIONAL SECTRICAL SPETY AND HEALTH ACT

E. SBC - STANDARD BUILDING CODE

ALL EQUIPMENT, AND CONFIRM WITH "CONSTRUCTION MANAGER" ANY SIZES AND LOCATIONS WHEN

ALL EQUIPMENT, AND CONFIRM WITH "CONSTRUCTION MANAGER" ANY SIZES AND LOCATIONS WHEN NEEDED. EXISTING SERVICES: CONTRACTOR SHALL NOT INTERRUPT EXISTING SERVICES WITHOUT WRITTEN PERMISSION OF THE OWNER.

CONTRACTOR SHALL PAY FOR ANY/ALL PERMITS, FEES, INSPECTIONS AND TESTING, CONTRACTOR IS TO OBTAIN PERMITS AND APPROVED SUBMITTALS PRIOR TO THE WORK BEGINNING OR ORDERING EQUIPMENT

THE TERM "PROVIDE" USED IN CONSTRUCTION DOCUMENTS AND SPECIFICATIONS, INDICATES THAT THE CONTRACTOR SHALL FURNISH AND INSTALL.

CONTRACTOR SHALL CONFIRM WITH LOCAL UTILITY COMPANY ANY/ALL REQUIREMENTS SUCH AS THE: LUG

SIZE RESTRICTIONS, CONDUIT ENTRY, SIZE OF TRANSFORMERS, SCHEDULED DOWNTIME FOR THE OWNERS'
CONFIRMATION, ETC... ANY/ALL CONFLICTS SHALL BE BROUGHT TO THE ATTENTION OF THE CONSTRUCTION
MANAGER, PRIOR TO BEGINNING ANY WORK.

9. MINIMUM WIRE SIZE SHALL BE \$12 AWG, NOT INCLUDING CONTROL WIRING, UNLESS NOTED OTHERWISE,
ALL CONDUCTORS SHALL BE COPPER WITH THWN INSULATION.

10. OUTLET BOXES SHALL BE PRESSED STEEL IN DRY LOCATIONS, CAST ALLOY WITH THREADED HUBS IN

OUTLET BUSES SHALL BE PRESSED STEEL IN DRY LOCATIONS, CAST ALLOY WITH THREADED HUBS IN WET/DAMP LOCATIONS AND SPECIAL ENCLOSURES FOR OTHER CLASSIFIED AREA.
 IT IS NOT THE INTENT OF THESE PLANS TO SHOW EVERY MINOR DETAIL OF THE CONSTRUCTION.
 CONTRACTOR IS EXPECTED TO FURNISH AND INSTALL ALL ITEMS FOR A COMPLETE ELECTRICAL SYSTEM AND PROVIDE ALL REQUIREMENTS FOR THE EQUIPMENT TO BE PLACED IN PROPER WORKING ORDER.
 ELECTRICAL SYSTEM SHALL BE AS COMPLETELY AND EFFECTIVELY GROUNDED, AS REQUIRED BY SPECIFICATIONS, SET FORTH BY ATL&T.
 ALL WORK SHALL BE PERFORMED BY A LICENSED ELECTRICAL CONTRACTOR IN A FIRST CLASS.

WORMANUKE MANNER THE COMPLETED SYSTEM SHALL BE FULLY OPERATIVE AND SUBJECT TO REGULATORY INSPECTION AND APPROVAL BY CONSTRUCTION MANAGER.

14. ALL WORK SHALL BE COORDINATED WITH OTHER TRADES TO AVOID INTERFERENCE WITH THE PROGRESS OF CONSTRUCTION.

14. ALL WORK SHALL BE COORDINATED WITH OTHER TRADES TO AVOID INTERFERENCE WITH THE PROGRESS OF CONSTRUCTION.
15. CONTRACTOR SHALL GUARANTEE ANY/ALL MATERIALS AND WORK FREE FROM DEFECTS FOR A PERIOD OF NOT LESS THAN ONE YEAR FROM DATE OF ACCEPTANCE.
16. THE CORRECTION OF ANY DEFECTS SHALL BE COMPLETED WITHOUT ANY ADDITIONAL CHARGE AND SHALL INCLUDE THE REPLACEMENT OR THE REPAIR OF ANY OTHER PHASE OF THE INSTALLATION, WHICH MAY

LAVE BEEN DAMAGED THEREIN. 17. ADEQUATE AND REQUIRED LIABILITY INSURANCE SHALL BE PROVIDED FOR PROTECTION AGAINST PUBLIC

LOSS AND ANY/ALL PROPERTY DAMAGE FOR THE DURATION OF WORK.

18. PROVIDE AND INSTALL CONDUIT, CONDUCTORS, PULL WIRES, BOXES, COVER PLATES AND DEVICES FOR ALL OUTLETS AS INDICATED.

19. DITCHING AND BACK FILL CONTRACTOR SHALL PROVIDE FOR ALL UNDERGROUND INSTALLED CONDUIT

AND/OR CABLES INCLUDING EXCAVATION AND BACKFILLING AND COMPACTION. REFER TO NOTES AND

AND/OR CABLES INCLUDING EXCAVATION, AND BACKFILLING.

20. MATERIALS, PRODUCTS AND EQUIPMENT, INCLUDING ALL COMPONENTS THEREOF, SHALL BE NEW AND SHALL APPEAR ON THE LIST OF U.L. APPROVED ITEMS AND SHALL MEET OR EXCEED THE REQUIREMENTS OF THE NEC, NEMA AND ISCE.

21. CONTRACTOR SHALL SUBMIT SHOP DRAWINGS OR MANUFACTURES CATALOG INFORMATION OF ANY/ALL

LIGHTING FIXTURES, SWITCHES AND ALL OTHER ELECTRICAL ITEMS FOR APPROVAL BY THE CONSTRUCTION MANAGER PRIOR TO INSTALLATION.

MANAGER PRIOR TO INSTALLATION.

22. ANY CUTTING OR PATCHING DEEMED NECESSARY FOR ELECTRICAL WORK IS THE ELECTRICAL CONTRACTORS RESPONSIBILITY AND SHALL BE INCLUDED IN THE COST FOR WORK AND PERFORMED TO THE SATISFACTION OF THE 'CONSTRUCTION MANAGER' UPON FINAL ACCEPTANCE.

23. THE ELECTRICAL CONTRACTOR SHALL LABEL ALL PANELS WITH ONLY TYPEWRITTEN DIRECTORIES. ALL ELECTRICAL WIRING SHALL BE THE RESPONSIBILITY OF THE ELECTRICAL CONTRACTOR.

24. DISCONNECT SWITCHES SHALL BE HEP. RATED HEAVY-DUTY, QUICK-MAKE AND QUICK-BREAK PROLOSURES AS REQUIRED BY EXPONSIBE TYPE.

24. DISCONNECT SWITCHES SHALL BE H.P. RATED HEAVY-DUTY, QUICK-MAKE AND QUICK-BREAK ENCLOSURES, AS REQUIRED BY EXPOSURE TYPE.
25. ALL CONNECTIONS SHALL BE MADE WITH A PROTECTIVE COATING OF AN ANTI-QXIDE COMPOUND SUCH AS "NO-QXIDE A" BY DEARBORNE CHEMICAL CO. COAT ALL WIRE SURFACES BEFORE CONNECTING. EXPOSED COPPER SURFACES, INCLUDING GROUND BARS, SHALL BE TREATED — NO SUBSTITUTIONS.
26. RACEWAYS: CONDUIT SHALL BE SCHEDULE 40 PVC MEETING OR EXCEEDING NEMA TC2 — 1990. CONTRACTOR SHALL PLUG AND CAP EACH END OF SPARE AND EMPTY CONDUITS AND PROVIDE TWO SEPARATE PULL STRINGS — 200 LBS TEST POLYETHYLENE CORD. ALL CONDUIT BENDS SHALL BE A MINIMUM OF 2 FT. RADIUS, ROS CONDUITS WHEN SPECIPED, SHALL MEET UL-B FOR GALVANIZED STEEL ALL FITTINGS SHALL BE SUITABLE FOR USE WITH THREADED RIGID CONDUIT, COAT ALL THREADS WITH "BRITE SINC" OR "GOLD CAN U".

'BRITE ZINC' OR 'GOLD GALL'.

27. SUPPORT OF ALL ELECTRICAL WORK SHALL BE AS REQUIRED BY NEC.

28. CONDUCTORS: CONTRACTOR SHALL USE 98% CONDUCTIVITY COPPER WITH TYPE THWN INSULATION, 800 VOLT, COLOR CODED, USE SOUD CONDUCTORS FOR WIRE UP TO AND INCLUDING NO. 8 AWG. USE STRANDED CONDUCTORS FOR WIRE ABOVE NO. 8 AWG.

29. CONNECTORS FOR POWER CONDUCTORS: CONTRACTOR SHALL USE PRESSURE TYPE INSULATED TWIST-ON CONNECTORS FOR NO. 10 AWG AND SMALLER. USE SOLDERLESS MECHANICAL TERMINAL LUGS FOR NO, 8 AWG.

AND LARGER

SERVICE: 240/120V, SINGLE PHASE, 3 WIRE CONNECTION AVAILABLE FROM UTILITY COMPANY, OWNER OR OWNERS AGENT WILL APPLY FOR POWER, TELEPHONE SERVICE: CONTRACTOR SHALL PROVIDE EMPTY CONDUITS WITH PULL STRINGS AS INDICATED ON

32 ELECTRICAL AND TELCO RACEWAYS TO BE BURIED A MINIMUM OF 2' DEPTH.

CONTRACTOR SHALL PLACE TWO LENGTHS OF WARNING TAPE AT A DEPTH OF 12" BELOW GROUND AND DIRECTLY ABOVE ELECTRICAL AND TELCO SERVICE CONDUITS. CAUTIONS TAPE TO READ "CAUTION BURIED

ELECTRIC" OR "BURIED TELECOMM".

34. ALL BOLTS SHALL BE STAINLESS STEEL

GROUNDING NOTES:

COMPRESSION CONNECTIONS (2), 2 AWG BARE TINNED SOLID COPPER CONDUCTORS TO GROUNDING BAR, ROUTE CONDUCTORS TO BURIED GROUNDING RING AND PROVIDE PARALLEL EVICTURE UNIT OF THE WAY OF THE CONDUCTORS TO BURIED GROUNDING RING AND PROVIDE PARALLEL EVICTURE UNIT OF THE WAY OF THE WA

GROUNDING BAR, ROUTE CONDUCTORS TO BURIED GROUNDING RING AND PROVIDE PARALLE EXCTHERMIC WELD.

EC SHALL USE PERMANENT MARKER TO DRAW THE LINES BETWEEN EACH SECTION AND LABEL EACH SECTION ("P", "A", "N", "I") WITH I "HIGH LETTERS.

ALL HARDWARE IS—B STIANLESS STEEL, INCLUDING LOCK WASHERS, COAT ALL SURFACES WITH AN ANTI-ODIDANT COMPOUND BEFORE MATING, ALL HARDWARE SHALL BE STAINLESS.

WITH AN ANTI-OXIDANT COMPOUND BEFORE MATING. ALL HARDWARE SHALL BE STAINLESS STEEL 3/8 INCH DIAMETER OR LARGER. FOR GROUND BOND TO STEEL ONLY: INSERT A CADMUM FLAT WASHER BETWEEN LUG AND STEEL COAT ALL SURFACES WITH AN ANTI-OXIDANT COMPOUND BEFORE MATING. NUT & WASHER SHALL BE PLACED ON THE FRONT SIDE OF THE GROUNDING BAR AND BOLTED ON THE BACK SIDE. NUMBER OF GROUNDING BARS MAY VARY DEPENDING ON THE TYPE OF TOWER, ANTENNA LOCATION, AND CONNECTION ORIENTATION. PROVIDE AS REQUIRED. WHEN THE SCOPE OF WORK REQUIRES THE ADDITION OF A GROUNDING BAR TO AN EXISTING TOWER THE SUBCONTRACTOR SHALL DETAIN APPROVAL FROM THE TOWER OWNER PRIOR TO MOUNTING THE GROUNDING BAR TO THE TOWER. ALL CECTRICAL AND GROUNDING AT THE CELL SITE SHALL COMPLY WITH THE NATIONAL FLECTRICAL CODE (NEV) NATIONAL SIRE PROTECTION ASSOCIATION (NEPA) 780 (LATEST).

ELECTRICAL CODE (NEC), NATIONAL FIRE PROTECTION ASSOCIATION (NFPA) 780 (LATEST

FOUNDATION, EXCAVATION & BACKFILL NOTES:

ALL FINAL GRADED SLOPES SHALL BE A MAXIMUM OF 3 HORIZONTAL TO 1 VERTICAL.
ALL EXCAVATIONS PREPARED FOR PLACEMENT OF CONCRETE SHALL BE OF UNDISTURBED SOILS,
SUBSTANTIALLY HORIZONTAL AND FREE FROM ANY LOOSE, UNSUITABLE MATERIAL OF FROZEN SOILS, AND
WITHOUT THE PRESENCE OF POUNDING WATER, DEWATERING FOR EXCESS GROUND WATER SHALL BE
PROVIDED WHEN REQUIRED. COMPACTION OF SOILS UNDER CONCRETE PAD FOUNDINGS SHALL NOT BE
LESS THAN 95% OF THE MODIFIED PROCTOR MAXIMUM DRY DENSITY FOR THE SOIL IN ACCORDANCE WITH

LESS THAM 95% OF THE MODIFIED PROCTOR MAXIMUM DRY DENSITY FOR THE SOIL IN ACCORDANCE WITH ASTM D1557.

CONCRETE FOUNDATIONS SHALL NOT BE PLACED ON ORGANIC OR UNSUITABLE MATERIAL. IF INADEQUATE BEARING CAPACITY IS REACHED AT THE DESIGNED EXCAVATION DEPTH, THE UNSATISFACTORY SOIL SHALL BE EXCAVATED TO ITS FULL DEPTH AND EITHER BE REPLACED WITH MECHANICALLY COMPACTED CRANULAR MATERIAL OR THE EXCAVATION SHALL BE FILLED WITH CONCRETE OF THE SAME TYPE SPECIFIED FOR THE FOUNDATION. CRUSHED STONE MAY BE USED TO STABILIZE THE BOTTOM OF THE EXCAVATION, ANY STONE SUB BASE MATERIAL, IF USED, SHALL NOT SUBSTITUTE FOR REQUIRED THICKNESS OF CONCRETE. ALL EXCAVATIONS SHALL BE CLEAN OF UNSUITABLE MATERIAL SUCH AS VEGETATION, TRASH, DEBRIS, AND SO FORTH PRIOR TO BACK FILLING. BACK FILL SHALL CONSIST OF APPROVED MATERIALS SUCH AS EARTH, LOAM, SANDY CLAY, SAND, AND GRAVEL, OR SOFT SHALE, FREE FROM CLODS OR LARGE STONES OVER 2 1/2" MAX DIMENSIONS, ALL BACK FILL SHALL BE PLACED IN COMPACTED LAYERS.

ALL FILL MATERIALS AND FOUNDATION BACK FILL SHALL BE PLACED IN COMPACTED TO NOT LESS THAN 95% OF THE MODIFIED PROCTOR MAXIMUM DRY DENSITY FOR SOIL IN ACCORDANCE WITH ASTM D1557.

NEW LY PLACED CONCRETE FOUNDATIONS SHALL CURE A MINIMUM OF 72 HRS PRIOR TO BACK FILLING. FINISH GRADE OF CONCRETE FOUNDATIONS SHALL SUCPE AND FINISH GRADE AND PREVENT STANDING WATER. THE FINISH (GRADE OF CONCRETE PAGE IN THE AMAINUM OF 4 INCHES AND FETNAM SHALL BE SEQUED.

FINISH OR GRADING SHALL BE SURPED TO PROVIDE POSITIVE DRAINAGE AND PREVENT STANDING WATER. THE FINISH CRADE OF CONCRETE PAGE SHALL BE A MAXIMUM OF 4 INCHES AND FINISH GRADE ELEVATIONS. PROVIDE SURFACE FILL GRAVEL TO ESTABLISH SPECIFIED BELEVATION WHERE REQUIRED.

NEW LY GRADED SURFACE FILL GRAVEL TO ESTABLISH SPECIFIED BLEVATIONS WHERE REQUIRED.

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NEW LY GRADED SURFACE AREAS TO RECEIVE GRAVEL SHALL BE COVERED WITH GEOTEXTILE FABRIC TYPE: TYPAR-3401 AS MANUFACTURED BY "CONSTRUCTION MATERIAL 1-BOO-239-3841" OR AN APPROVED EQUIVALENT, SHOWN ON PLANS. THE GEOTEXTILE FABRIC SHALL BE BLACK IN COLOR TO CONTROL THE RECURRENCE OF VEGETATIVE GROWTH AND EXTEND TO WITHIN 1 FOOT OUTSIDE THE SIFE FENCING OR ELECTRICAL GROUNDING SYSTEM PERIMETER WHICH EVER IS GREATER. ALL FABRIC SHALL BE COVERED WITH A MINIMUM OF 4" DEEP COMPACTED STONE OR GRAVEL AS SPECIFIED. I.E. FOOT TYPE No. 57 FOR FENCED COMPOUND; FOOT TYPE No. 67 FOR ACCESS DRIVE AREA. IN ALL AREAS TO RECEIVE FILL, REMOVE ALL VEGETATION, TOPSOIL, DEBRIS, WET AND UNSATISFACTORY SOIL MATERIALS, OBSTRUCTIONS, AND DELETERIOUS MATERIALS, FORM GROUND SURFACE, PLOW STRIP OR BREAK UP SLOPED SURFACES STEEPER THAN 1 VERTICAL TO 4 HORIZONTAL SUCH THAT FILL MATERIAL WILL BIND WITH EVISTING/OPPERAPED SNIL SURFACES.

UP SLOPED SURFACES STEEPER THAN 1 VERTICAL TO 4 HORIZONTAL SUCH THAT FILL MATERIAL WILL BIND WITH EXISTING/PREPARED SOIL SURFACE.
WHEN SUB GRADE OR PREPARED GROUND SURFACE HAS A DENSITY LESS THAN THAT REQUIRED FOR THE FILL MATERIAL, SCARIFY THE GROUND SURFACE TO DEPTH REQUIRED, PULVERIZE, MOISTURE—CONDITION AND/OR REATTE THE SOILS AND RECOMPACT TO THE REQUIRED DENSITY PRIOR TO PLACEMENT OF FILLS. IN AREAS WHICH EXISTING GRAVEL SURFACING IS REMOVED OR DISTURBED DURING CONSTRUCTION

OPERATIONS. REPLACE GRAVEL SURFACING TO MATCH ADJACENT GRAVEL SURFACING AND RESTORED TO THE SAME THICKNESS AND COMPACTION AS SPECIFIED. ALL RESTORED GRAVEL SURFACING SHALL BE FREE FROM

SAME THICKNESS AND COMPACTION AS SPECIFIED, ALL RESTORED GRAVEL SURFACING SHALL BE FREE FROM CORRUGATIONS AND WAVES.

12. EXISTING GRAVEL SURFACING MAY BE EXCAVATED SEPARATELY AND REUSED WITH THE CONDITION THAT ANY UNFAVORABLE AMOUNTS OF ORGANIC MATTER, OR OTHER DELETERIOUS MATERIALS ARE REMOVED PRIOR TO REUSE, FURNISH ANY ADDITIONAL GRAVEL RESURFACING MATERIAL AS NEEDED TO PROVIDE A FULL DEPTH COMPACTED SURFACE THROUGHOUT SITE.

13. GRAVEL SUB SURFACE SHALL BE PREPARED TO REQUIRED COMPACTION, AND SUB GRAVE LEEVATIONS.

BEFORE GRAVEL SURFACING IS PLACED AND/OR RESTORED. ANY LOOSE OR DISTURBED MATERIALS SHALL BE THOROUGHLY COMPACTED AND ANY DEPRESSIONS IN THE SUB GRADE SHALL BE FILLED AND COMPACTED WITH APPROVED SELECTED MATERIAL GRAVEL SURFACING MATERIAL SHALL NOT BE USED FOR FILLING DEPRESSIONS IN THE SUB GRADE.

PROTECT EXISTING GRAVEL SURFACING AND SUB GRADE IN AREAS WHERE EQUIPMENT LOADS WILL OPERATE.

USE PLANKING "NATTS" OR OTHER SUITABLE PROTECTION DESIGNED TO SPREAD EQUIPMENT LOADS AS MAY BE NECESSARY. REPAIR ANY DAMAGE TO EXISTING GRAVEL SURFACING OR SUB GRADE WHERE SUCH DAMAGE IS DUE TO THE CONTRACTORS OPERATIONS.

IS DUE TO THE CONTRACTORS OPERATIONS.

15. DAMAGE TO EXISTING STRUCTURES AND/OR UTILITIES RESULTING FROM CONTRACTORS NEGLIGENCE SHALL BE REPAIRED AND/ OR REPLACED TO THE OWNERS SATISFACTION AT NO ADDITIONAL COST TO THE CONTRACT, ALL SUITABLE BORROW MATERIAL FOR BACK FILL OF THE SITE SHALL BE INCLUDED IN THE BID. EXCESS TOPSOIL AND UNSUITABLE MATERIAL SHALL BE DISPOSED OF OFF SITE AT LOCATIONS APPROVED BY GOVERNING AGENCIES AT NO ADDITIONAL COST TO THE CONTRACT.

DRY CREEK JONESVILLE 6521 GREEN VALLEY ROAD PLACERVILLE, CALIFORNIA

ISSUED FOR



SAN RAMON, CALIFORNIA 94583

95667





ATAT SITE NO CVL0312 PROJECT NO: 13787633 DRAWN BY CHECKED BY:

-			H
D	07/21/2021	100% ZDa REY-RFDS/RLS	WD
¢	04/26/2021	100% ZDa	MF
В	03/22/2021	100% ZDa	50
A	02/05/2021	90% ZDa FOR REVIEW	SD
REV	DATE	DESCRIPTION	BY

LICENSOR

SHEET TITLE GENERAL NOTES


GN-1



DIESEL

NFPA SIGNAGE

**TOTAL GALLONS 190** 

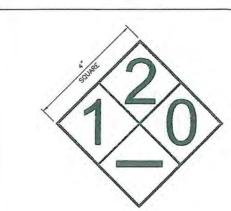

RF SIGNAGE



**GUIDELINES:** 

Obey all posted signs.

Beyond this point: Radio frequency fields at this site may exceed FCC rules for human

For your safety, obey all posted signs and site guidelines for working in radio frequency environments.

TYPICAL / WARNING

Beyond this point: Radio frequency fields at this site exceed the FCC rules for human

NOTICE

Radio frequency fields beyond this point may exceed the FCC general public exposure limit. Obey all posted signs and site guidelines for working in radio frequency

CAUTION

A NOTICE A

RF SAFETY PROGRAM IN EFFECT AT THIS SITE

ONLY AUTHORIZED PERSONNEL MAY ENTER this site.

All personnel must have RF SAFETY TRAINING as per the written RFSAFETY PROGRAM for this site.

Assume all antennae are active, unless LOCKED OUT. Before working on antennas, notify owners and DISABLE APPROPRIATE TRANSMITTERS.

Maintain a safe distance from all antennas.

Do not stop or work in front of active antennas. Use personal RF MONITORS while working at this site. Replace all transmitter shields after service. ⚠ Do not mount or use antennas in equipment room



Fallure to obey all posted signs and site guidelines for working in radio frequency environments could result in serious injury.

SITE IDENTIFICATION SIGNAGE

REQUIRED BATTERY NFPA SIGNAGE

24"x36" SCALE: NTS 11"x17" SCALE: NTS

RF SIGNAGE

24"x36" SCALE: NTS 11"x17" SCALE: NTS

24"x36" SCALE: NTS 11"x17" SCALE: NTS

REV DATE DESCRIPTION

AT&T SITE NO:

CHECKED BY:

DRY CREEK JONESVILLE 6521 GREEN VALLEY

ROAD PLACERVILLE, CALIFORNIA

95667

\$001 EXECUTIVE PARKWAY SAN RAMON, CALIFORNIA 94583

WIRELESS GROUP LLC

1397 CALLE AVANZADO

13787633

SD

SHEET TITLE

GENERAL NOTES

D 07/21/2021 100% ZDs REY-RFDS/RLS C 04/26/2021 100% ZDa B 03/22/2021 100% ZDs

A 02/08/2021 90% ZDs FOR REVIEW

GN-2

CALIFORNIA PROPOSITION 65 WARNING

> CANCER AND REPRODUCTIVE HARM WWW.P65WARNINGS.CA.GOV **AVERTISSEMENT**

CANCER ET EFFET NOCIF SUR IS REPRODUCTION WWW.P65WARNINGS.CA.GOV **AVERTISSEMENT** 

PRODUCE CANDER Y DANCS REPRODUCTIVOS WWW.P65WARNINGS.CA.GOV

NO TRESPASSING **AUTHORIZED** PERSONNEL ONLY

24"x36" SCALE: NTS 11"x17" SCALE: NTS

PROP 65

NO TRESPASSING SIGNAGE

24"x36" SCALE: NTS 11"x17" SCALE: NTS

# SITE WORK & DRAINAGE

### PART 1 - GENERAL

CLEARING, CRUBBING, STRIPPING, EROSION CONTROL, SURVEY, LAYOUT, SUBGRADE PREPARATION AND FINISH GRADING AS REQUIRED TO COMPLETE THE NEW WORK SHOWN IN THESE PLANS.

7 1

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- A. DOT (STATE DEPARTMENT OF TRANSPORTATION STANDARD SPECIFICATIONS FOR HICHWAY
- CONSTRUCTION-CURRENT EDITION).
  ASTM (AMERICAN SOCIETY FOR TESTING AND MATERIALS).
- OSHA (OCCUPATION SAFETY AND HEALTH ADMINISTRATION).

- 1.2 INSPECTION AND TESTING: A FIELD TESTING OF EARTHWORK COMPACTION AND CONCRETE CYLINDERS SHALL BE PERFORMED BY SUBCONTRACTORS INDEPENDENT TESTING LAB. THIS WORK TO BE COORDINATED BY THE SUBCONTRACTOR B. ALL WORK SHALL BE INSPECTED AND RELEASED BY THE GENERAL CONTRACTOR WHO SHALL CARRY OUT THE GENERAL INSPECTION OF THE WORK WITH SPECIFIC CONCERN TO PROPER PERFORMANCE OF THE WORK AS SPECIFIED AND/OR CALLED FOR ON THE DRAWINGS, IT IS THE SUBCONTRACTOR'S RESPONSIBILITY TO REQUEST TIMELY INSPECTIONS PRIOR TO PROCEEDING WITH FURTHER WORK THAT WOULD MAKE PARTS OF WORK INACCESSIBLE OR DIFFICULT TO INSPECT.

### 1.3 SITE MAINTENANCE AND PROTECTION

- .3 SITE MAINTENANCE AND PROTECTION:
  PROVIDE ALL NECESSARY JOB SITE MAINTENANCE FROM COMMENCEMENT OF WORK UNTIL COMPLETION OF THE SUBCONTRACT.

  AVOID DAMAGE TO THE SITE AND TO EXISTING FACILITIES, STRUCTURES, TREES, AND SHRUBS DESIGNATED TO REMAIN. TAKE PROTECTIVE MEASURES TO PREVENT EXISTING FACILITIES THAT ARE NOT DESIGNATED FOR REMOVAL FROM BEING DAMAGED BY THE WORK.

  KEEP SITE FREE OF ALL PONDING WATER.
  PROVIDE EROSION CONTROL MEASURES IN ACCORDANCE WITH STATE DOT AND EPA REQUIREMENTS.
  PROVIDE AND MAINTAIN ALL TEMPORARY FENCING, BARRICADES, WARNING SIGNALS AND SHILAR DEVICES.
  NECESSARY TO PROTECT AGAINST THEFT FROM PROPERTY DURING THE ENTIRE PERIOD OF CONSTRUCTION.
  REMOVE ALL SUCH DEVICES UPON COMPLETION OF THE WORK.

  EXISTING UTILITIES: DO NOT INTERRUPT EXISTING UTILITIES SERVING FACILITIES OCCUPIED BY THE OWNER.
  OR OTHERS, EXCEPT WHEN PERMITTED IN WRITING BY THE ENGINEER AND THEN ONLY AFTER
  ACCEPTABLE TEMPORARY UTILITY SERVICES HAVE BEEN PROVIDED.
- PROVIDE A MINIMUM 48-HOUR NOTICE TO THE ENGINEER AND RECEIVE WRITTEN NOTICE TO PROCEED BEFORE INTERRUPTING ANY UTILITY SERVICE.

### PART 2 - PRODUCTS

- 2.1 SUITABLE BACKFILL: ASTM D2321 (CLASS I, II, III OR IVA) FREE FROM FROZEN LUMPS, REFUSE, STONES OR ROCKS LARGER THAN 3 INCHES IN ANY DIMENSION OR OTHER MATERIAL THAT MAY MAKE THE INORGANIC MATERIAL UNSUITABLE FOR BACKFILL.
- THE INORGANIC MATERIAL UNSUITABLE FOR BACKFILL.

  2.2 NON-POROUS GRANULAR EMBANKMENT AND BACKFILL: ASTM D2321 (CLASS III, IVA OR IVB) COARSE
  AGGREGATE. FREE FROM FROZEN LUMPS, REFUSE, STONES OR ROCKS LARGER THAN 3 INCHES IN ANY
  DIMENSION OR OTHER MATERIAL THAT MAY MAKE THE INORGANIC MATERIAL UNSUITABLE FOR BACKFILL

  2.3 POROUS GRANULAR EMBANKMENT AND BACKFILL: ASTM D2321 (CLASS IA, IB OF II) COARSE AGGREGATE
  FREE FROM FROZEN LUMPS, REFUSE, STONES OR ROCKS LARGER THAN 3 INCHES IN ANY DIMENSION OR
  OTHER MATERIAL THAT MAY MAKE THE INORGANIC MATERIAL UNSUITABLE FOR BACKFILL

  2.4 SELECT STRUCTURAL FILL: GRANULAR FILL MATERIAL MEETING THE REQUIREMENTS OF ASTM EBSO-95.
- FOR USE AROUND AND UNDER STRUCTURES WHERE STRUCTURAL FILL MATERIAL ARE REQUIRED.

  2.5 GRANULAR BEDDING AND TRENCH BACKFILL: WELL-GRADED SAND MEETING THE GRADATION REQUIREMENTS ASTM D2487 (SE OR SW-SM).

  COARSE AGGREGATE FOR ACCESS ROAD SUBBASE COURSE SHALL CONFORM TO ASTM D2940.
- 2.6 COARSE AGGREGATE FOR ACCESS ROAD SUBBASE COURSE SHALL CONFORM TO ASTIN 02940.

  2.7 UNSUITABLE MATERIAL: HIGH AND MODERATELY PLASTIC SILTS AND CLAYS (LL>45), MATERIAL CONTAINING REFUSE, FROZEN LUMPS, DEMOLISHED BITUMINOUS MATERIAL, VEGETATIVE MATTER, WOOD, STONES IN EXCESS OF 3 INCHES IN ANY DIMENSION, AND DEBRIS AS DETERMINED BY THE CONSTRUCTION MANAGER. TYPICAL THESE WILL BE SOILS CLASSIFIED BY ASTM AS PT, MH, CH, OH, ML, AND OL.

  2.8 GEOTEXTILE FABRIC: MIRAF! 500X OR APPROVED EQUAL.

  2.9 PLASTIC MARKING TAPE: SHALL BE ACID AND ALKALI RESISTANT POLYETHYLENE FILM SPECIFICALLY MANUFACTURED FOR MARKING AND LOCATING UNDERGROUND UTILITIES, 6 INCHES WIDE WITH A MINIMUM THICKNESS OF 0.004 INCH. TAPE SHALL HAVE MINIMUM STRENGTH OF 1500 PSI IN 607H DIRECTIONS AND MANUFACTURED WITH INTEGRAL CONDUCTORS, FOIL BACKING OR OTHER MEANS TO ENABLE DETECTION BY A METAL DETECTOR WHEN BURIED UP TO 3 FEET DEEP. THE METALLIC CORE OF THE TAPE SHALL BE ENCASED IN A PROTECTIVE JACKET OR PROVIDED WITH OTHER MEANS TO PROTECT IT FROM CORROSION. TAPE COLOR SHALL BE RED FOR ELECTRIC UTILITIES AND ORANGE FOR TELECOMMUNICATION UTILITIES.

## PART 2 - EXECUTION

- A. BEFORE STARTING GENERAL SITE PREPARATION ACTIVITIES, INSTALL EROSION AND SEDIMENT CONTROL MEASURES: THE WORK AREA SHALL BE CONSTRUCTED AND MAINTAINED IN SUCH CONDITION THAT IN THE EVENT OF RAIN THE SITE WILL BE DRAINED AT ANY TIME.

  B. BEFORE ALL SURVEY, LAYOUT, STAKKING, AND MARKING, ESTABLISH AND MAINTAIN ALL LINES, GRADES, ELEVATIONS AND BENCHMARKS NEEDED FOR EXECUTION OF THE WORK.

  C. CLEAR AND GRUB THE AREA WITHIN THE LIMITS OF THE SITE, REMOVE TREES, BRUSH, STUMPS, RUBBISH AND OTHER DEBRIS AND VEGETATION RESTING ON OR PROTRUDING THROUGH THE SURFACE OF THE SITE AREA TO BE CLEARED.
- REMOVE THE FOLLOWING MATERIALS TO A DEPTH OF NO LESS THAN 12 INCHES BELOW THE ORIGINAL GROUND SURFACE: ROOTS, STUMPS, AND OTHER DEBRIS, BRUSH, AND REFUSE EMBEDDED IN OR PROTINGING THROUGH THE GROUND SURFACE, RAKE, DISK OR PLOW THE AREA TO A DEPTH OF NO LESS THAN 6 INCHES, AND REMOVE TO A DEPTH OF 12 INCHES ALL ROOTS AND OTHER DEBRIS.

- THEREBY EXPOSED.

  REMOVE TOPSOIL MATERIAL COMPLETELY FROM THE SURFACE UNTIL THE SOIL NO LONGER MEETS THE DEFINITION OF TOPSOIL. AVOID MIXING TOPSOIL WITH SUBSOIL OR OTHER UNDESIRABLE MATERIALS. EXCEPT WHERE EXCAVATION TO GREATER DEPTH IS INDICATED, FILL DEPRESSIONS RESULTING FROM CLEARING, GRUBBING AND DEMOLITION WORK COMPLETELY WITH SUITABLE FILL. REMOVE FROM THE SITE AND DISPOSE IN AN AUTHORIZED LANDRILL ALL DEBRIS RESULTING FROM CLEARING AND GRUBBING OPERATIONS. BURNING WILL NOT BE PERMITTED. PRIOR TO EXCAVATION, THOROUGHLY EXAMINE THE AREA TO BE EXCAVATED AND/OR TRENCHED TO VERIFY THE LOCATIONS OF FEATURES INDICATED ON THE DRAWINGS AND TO ASCERTAIN THE EXISTENCE AND LOCATION OF ARY STRUCTURE, UNDERGROUND STRUCTURE, OR OTHER ITEM NOT SHOWN THAT MIGHT INTERFERE WITH THE NEW CONSTRUCTION, NOTIFY THE CONSTRUCTION MANAGER OF ANY OBSTRUCTIONS THAT WILL PREVENT ACCOMPLISHMENT OF THE WORK AS INDICATED ON THE DRAWINGS. SEPARATE AND STOCK PILE ALL EXCAVATED MATERIALS SUITABLE FOR BACKFILL ALL EXCESS EXCAVATED AND UNSUITABLE MATERIALS SHALL BE DISPOSED OF OFF-SITE IN A LEGAL MANNER.

- A. AS SOON AS PRACTICAL, AFTER COMPLETING CONSTRUCTION OF THE RELATED STRUCTURE, INCLUDING

- A. AS SOON AS PRACTICAL, AFTER COMPLETING CONSTRUCTION OF THE RELATED STRUCTURE, INCLUDING EXPIRATION OF THE SPECIFIED MINIMUM CURING PERIOD FOR CAST—IN-PLACE CORRETE, BACKFILL THE EXCAYATION WITH APPROVED MATERIAL TO RESTORE THE REQUIRED FINISHED GRADE.

  1. PRIOR TO PLACING BACKFILL ARQUIND STRUCTURES, ALL FORMS SHALL BE REMOYED AND THE EXCAYATION CLEANED OF ALL TRASH, DEBRIS, AND UNSUITABLE MATERIAL OR SELECT GRANULAR BACKFILL MATERIAL OR SELECT GRANULAR BACKFILL MATERIAL WHEN REQUIRED IN UNIFORM HORIZONTAL LAYERS OF NO GREATER THAN 8—INCHES LOOSE THICKNESS AND COMPACTED. WHERE HAND OPERATED COMPACTORS ARE USED, THE FILL MATERIAL SHALL BE PLACED IN LIFTS NOT TO EXCEED 4 INCHES IN LOOSE DEPTH AND COMPACTED.

  3. WHENEVER THE DENSITY TESTING INDICATES THAT THE CONTRACTOR HAS NOT OSTAINED THE SPECIFIED DENSITY, THE SUCCEEDING LAYER SHALL NOT BE PLACED UNTIL THE SPECIFICATION REQUIREMENTS ARE MET UNLESS OTHERWISE AUTHORIZED BY THE GEOTECHNICAL ENGINEER. THE CONTRACTOR SHALL TAKE WHATEVER APPROPRIATE ACTION IS NECESSARY, SUCH AS DISKING AND DRYING, ADDING WATER, OR INCREASING THE COMPACTIVE EFFORT TO MEET THE MINIMUM COMPACTION REQUIREMENTS.

  B. THOROUGHLY COMPACT EACH LAYER OF BACKFILL TO A MINIMUM OF 95% OF THE MAXIMUM DRY DENSITY AS PROVIDED BY THE STANDARD PROCTOR TEST, ASTM D 698.

### 3.3 TRENCH EXCAVATION:

- A. UTILITY TRENCHES SHALL BE EXCAVATED TO THE LINES AND GRADES SHOWN ON THE DRAWINGS OR AS DIRECTED BY THE GENERAL CONTRACTOR. PROVIDE SHORING, SHEETING AND BRACING AS REQUIRED TO PREVENT CAVING OR SLOUGHING OF THE TRENCH WALLS. EXTEND THE TRENCH WIDTH A MINIMUM OF 6 INCHES BEYOND THE OUTSIDE EDGE OF THE OUTSIMOST CONDUIT.
- B. WHEN SOFT YIELDING, OR OTHERWISE UNSTABLE SOIL CONDITIONS ARE ENCOUNTERED, BACKFILL AT THE REQUIRED TRENCH TO A DEPTH OF NO LESS THAN 12 INCHES BELOW THE REQUIRED ELEVATION AND BACKFILL WITH GRANULAR BEDDING MATERIAL.

- 3.5 AGGREGATE ACCESS ROAD:

  A. CLEAR, GRUB, STRIP AND EXCAVATE FOR THE ACCESS ROAD TO THE LINES AND GRADES INDICATED ON THE DRAWINGS. SCARIFY TO A DEPTH OF 6 INCHES AND PROOF—ROLL ALL HOLES, RUTS, SOFT PLACES AND OTHER DEFECTS SHALL BE CORRECTED.

  B. THE ENTIRE SUBGRADE SHALL BE COMPACTED TO NOT LESS THAN 95 PERCENT OF THE MAXIMUM DRY DENSITY AS PROVIDED BY THE STANDARD PROCTOR TEST, ASTM D 1557.

  C. AFTER PREPARATION OF THE SUBGRADE IS COMPLETE THE GEOTEXTILE FABRIC (MIRAFI SODXI) SHALL BE INSTALLED TO THE LIMITS INDICATED ON THE DRAWINGS BY ROLLING THE FABRIC OUT LONGITUDINALLY ALONG THE ROADWAY. THE FABRIC SHALL NOT BE DRAGGED ACROSS THE SUBGRADE PLACE THE ENTIRE ROLL IN A SINGLE OPERATION, ROLLING OUT AS SMOOTHLY AS POSSIBLE.

  1. OVERLAPS PARALLEL TO THE ROADWAY WILL BE PERMITTED AT THE CENTERLINE AND AT LOCATIONS BEYOND THE ROADWAY SURFACE WIDTH (I.E. WITHIN THE SHOULDER WIDTH) ONLY. NO LONGITUDINAL OVERLAPS SHALL BE LOCATED BETWEEN THE CENTERLINE AND THE SHOULDER. PARALLEL OVERLAPS SHALL BE A MINIMUM OF 3 FEET WIDE.
- SHALL BE A MINIMUM OF 3 FEET WIDE. TRANSVERSE (PERPENDICULAR TO THE ROADWAY) OVERLAPS AT THE END OF A ROLL SHALL OVERLAP IN THE DIRECTION OF THE AGGREGATE PLACEMENT (PREVIOUS ROLL ON TOP) AND SHALL HAVE A MINIMUM
- LENGTH OF 3 FEET.

  ALL OVERLAPS SHALL BE PINNED WITH STAPLES OR NAILS A MINIMUM OF 10 INCHES LONG TO INSURE POSITIONING DURING PLACEMENT OF AGGREGATE. PIN LONGITUDINAL SEAMS AT 25 FOOT CENTERS AND TRANSVERSE SEAMS EVERY 5 FEET.

  THE AGGREGATE BASE AND SURFACE COURSES SHALL BE CONSTRUCTED IN LAYERS NOT MORE THAN 4
- THE AGGREGATE BASE AND SURFACE COURSES SHALL BE CONSTRUCTED IN LAYERS NOT MORE THAN 4 MICH (COMPACTED) THICKNESS, AGGREGATE TO BE PLACED ON GEOTEXTILE FABRIC SHALL BE END-DUMPED ON THE FABRIC FROM THE FREE END OF THE FABRIC OR OVER PREVIOUSLY PLACED AGGREGATE. THE FIRST LIFT SHALL BE BLADED DOWN TO A THICKNESS OF 8 INCHES PRIOR TO COMPACTION. AT NO TIME SHALL EQUIPMENT, EITHER TRANSPORTING THE AGGREGATE OR GRADING THE AGGREGATE, BE PERMITTED ON THE ROADWAY WITH LESS THAN 4 INCHES OF MATERIAL COVERING THE
- FABRIC.
  THE ACCREGATE SHALL BE IMMEDIATELY COMPACTED TO NOT LESS THAN 95 PERCENT OF THE MAXIMUM
  DRY DENSITY AS PROVIDED BY THE PROCTOR TEST, ASTM D 1557 WITH A TARRIFORM PROCESS. ASTM D 1567 WITH A WITH A VIBRATORY MACHINE OR ANY COMBINATION OF THE ABOVE. THE
  TOP LAYER SHALL BE GIVEN A FINAL ROLLING WITH A THREE-WHEEL OR TANDEM ROLLER.

- 6 FINISH GRADING: FERFORM ALL GRADING TO PROVIDE POSITIVE DRAINAGE AWAY FROM STRUCTURES AND SMOOTH, EVEN SURFACE DRAINAGE OF THE ENTIRE AREA WITHIN THE LIMITS OF CONSTRUCTION: GRADING SHALL BE COMPATIBLE WITH ALL SURROUNDING TOPOGRAPHY AND STRUCTURES. UTILIZE SATISFACTORY FILL MATERIAL RESULTING FROM THE EXCAVATION WORK IN THE CONSTRUCTION OF FILLS, EMBANKMENTS AND FOR REPLACEMENT OF REMOVED UNSUITABLE MATERIALS.

- C. ACHIEVE FINISHED GRADE BY PLACING A MINIMUM OF 4 INCHES OF 1/2" 3/4" CRUSHED STONE ON TOP SOIL STABILIZER FABRIC.

  D. REPAIR ALL ACCESS ROADS AND SURROUNDING AREAS USED DURING THE COURSE OF THIS WORK TO THEIR ORIGINAL CONDITION.

- A. DIVISION 500 KDOT FLEXIBLE PAVEMENT. (UPDATE PER LOCAL DOT)
  B. SECTION 403 MODOT ASPHALT CONCRETE PAVEMENT.

# ENVIRONMENTAL NOTES

- ALL WORK PERFORMED SHALL BE DONE IN ACCORDANCE WITH ISSUED PERMITS, THE CONTRACTOR SHALL BE RESPONSIBLE FOR PAYMENT OF FINES AND PROPER CLEAN UP FOR AREAS IN VIOLATION. CONTRACTOR AND/OR DEVELOPER SHALL BE RESPONSIBLE FOR CONSTRUCTION AND MAINTENANCE OF EROSION AND SEDIMENTATION CONTROLS DURING CONSTRUCTION FOR PROTECTION OF ADJACENT PROPERTIES, ROADWAYS AND WATERWAYS AND SHALL BE MAINTAINED IN PLACE THROUGH FINAL JURISDICTIONAL INSPECTION & RELEASE OF SITE.
- INSPECTION & RELEASE OF SITE.

  CONTRACTOR SHALL INSTALL/CONSTRUCT ALL NECESSARY SEDIMENT/SILT CONTROL FENCING AND PROTECTIVE
  MEASURES WITHIN THE LIMITS OF SITE DISTURBANCE PRIOR TO CONSTRUCTION.

  NO SEDIMENT SHALL BE ALLOWED TO EXIT THE PROPERTY. THE CONTRACTOR IS RESPONSIBLE FOR TAKING
  ADEQUATE MEASURES FOR CONTROLLING EROSION. ADDITIONAL SEDIMENT CONTROL, FENCING MAY BE
  REQUIRED IN ANY AREAS SUBJECT TO EROSION.

  CONTRACTOR SHALL BE RESPONSIBLE FOR DAILY INSPECTIONS AND ANY REPAIRS OF ALL SEDIMENT
  CONTROL MEASURES INCLUDING SEDIMENT REMOVAL AS NECESSARY.

  CLEARING OF VEGETATION AND THEE REMOVAL SHALL BE ONLY AS PERMITTED AND BE HELD TO A
  MINIMUM. ONLY TREES NECESSARY FOR CONSTRUCTION OF THE FACILITIES SHALL BE REMOVED.

- MINIMUM, ONLY TREES NECESSARY FOR CONSTRUCTION OF THE FACILITIES SHALL BE REMOVED. 
  SEEDING AND MULCHING AND/OR SOODING OF THE SITE WILL BE ACCOMPLISHED AS SOON AS 
  POSSIBLE AFTER COMPLETION OF THE PROJECT FACILITIES AFFECTING LAND DISTURBANCE. 
  CONTRACTOR SHALL PROVIDE ALL EROSION AND SEDIMENTATION CONTROL MEASURES AS REQUIRED 
  BY LOCAL, COUNTY AND STATE CODES AND ORDINANCES TO PROTECT EMBANKHATS FROM SOIL 
  LOSS AND TO PREVENT ACCUMULATION OF SOIL AND SILT IN STREAMS AND DRAINAGE PATHS 
  LEAVING THE CONSTRUCTION AFTER. THIS MAY INCLUDE SUCH MEASURES AS SILT FENCES, STRAW
- BALE SEDIMENT BARRIERS, AND CHECK DAMS.

  RIP RAP OF SIZES INDICATED SHALL CONSIST OF CLEAN, HARD, SOUND, DURABLE, UNIFORM IN
  QUALITY STONE FREE OF ANY DETRIMENTAL QUANTITY OF SOFT, FRABLE, THIN, ELONGATED OR
  LAMINATED PIECES, DISINTEGRATED MATERIAL, ORGANIC MATTER, OIL, ALKALI, OR OTHER
  DELETERIOUS SUBSTRANCES

# CONCRETE NOTES

- A. CEMENT SHALL CONFORM TO ASTM C-150. TYPE II

  B. COMPRESSIVE STRENGTH = 4.000 PSI

  C. CONCRETE SLUMP SHALL BE 3"+/-1" FOR SLASS AND 4"+/-1" FOR ALL OTHER WORK

  D. WATER CEMENT RATIO = 0.45 MAX

  2. AGGREGATES FOR NORMAL WEIGHT CONCRETE SHALL CONFORM TO ASTM C-33 (1" MAXIMUM SIZE), AND ASTM
- ACGREGATES FOR NORMAL WEIGHT CONCRETE.

  —330 FOR STRUCTURAL LIGHT WEIGHT CONCRETE.

  WHERE CONCRETE WILL BE IN CONTACT WITH NATIVE OR IMPORTED SOIL WHICH HAS A VERY SEVERE SULFATE.

  CONTENT, POZZOLAN SHALL BE ADDED AS REQUIRED.

  EXTERIOR CONCRETE EXPOSED TO FREEZING TEMPERATURES AND/OR SALT OR DELIGING CHEMICALS SHALL HAVE
  AIR ENTRAINMENT AND THE CEMENT CONTENT APPROPRIATE FOR THE EXPECTED EXPOSURE.

  WATER SHALL BE POTABLE OR CLEAN, FREE FROM DELETERIOUS AMOUNTS OF ACIDS, ALKALIS OR ORGANIC

  MATERIALS OILS AND SALTS.

- MATERIALS, OILS, AND SALTS. MATERIALS, OILS, AND SALIS.

  READY-MIX CONCRETE SHALL BE MIXED AND DELIVERED IN ACCORDANCE WITH ASTM C-94.

  FLOOR SLABS SHALL CONFORM TO ASTM C-38 STANDARDS AND SHALL BE AT LEAST 3 1/2 INCHES THICK -
- 7. FLOOR SLASS SHALL DON'TOM TO ANY CAUSE STANDARDS AND SHALL BE AT LEAST 37/2 MICHES SPECIFIC SEE FOUNDATION PLANS FOR REINFORCEMENT, BASE, UNDERLAYMENT, VAPOR BARRIER OR OTHER SPECIFIC REQUIREMENTS.

  FLOOR SLASS SHALL BE LEVEL OR TRUE SLOPES AS SHOWN ON DRAWINGS, TOLERANCE: 1/8 INCH IN 10 FEET 9. PROVIDE LIGHT BROOM FINISH ON ALL EXPOSED CONCRETE UNLESS NOTED OTHERWISE.

  10. PRIOR TO COMMENCING ANY FOUNDATION WORK, COORDINATE WORK WITH ANY EXISTING UTILITIES, FOUNDATIONS SHALL BE LOWERED WHERE REQUIRED TO AVOID UTILITIES.

- 11. ALL EDGES OF PERMANENTLY EXPOSED CONCRETE SURFACES SHALL BE CHAMFERED 3/4" UNLESS NOTED
- 11. ALL EDGES OF FERNANCIAL CARBON CONCRETE HAS OBTAINED AT LEAST 90% OF COMPRESSIVE STRENGTH.

  12. FORMWORK SHALL REMAIN PLACE UNTIL CONCRETE HAS OBTAINED AT LEAST 90% OF COMPRESSIVE STRENGTH.

  THE CONTRACTOR SHALL PROVIDE ALL SHORING AND RESHORING.

  13. PROVIDE CONCRETE SLABS OVER A 10 MIL POLYETHYLENE VAPOR BARRIER OVER 4" OF POROUS FILL UNLESS.
- 14 ALL PORQUE FILL MATERIAL SHALL BE A CLEAN GRANULAR MATERIAL PORQUE FILL SHALL BE COMPACTED TO
- 14. ALL POROUS FILL MATERIAL SHALL BE A CLEAN GRANLIAR MATERIAL, POROUS FILL SHALL BE COMPACIED TO 90% MAX. DRY DENSITY.
  15. WALKWAYS AND OTHER EXTERIOR SLABS ARE NOT INDICATED ON THE STRUCTURE DRAWINGS, SEE THE SITE PLAN AND AGENTICECTURED DRAWINGS FOR LOCATIONS, DIMENSIONS, ELEVATIONS, JOINTING DETAILS AND FINISH DETAILS. PROVIDE 4" WALKS REINFORCED WITH 6X6 WI-AXWIL4" WWF UNLESS OTHERWISE NOTED.
  16. ALL CONCRETE MATERIALS AND WORKMANSHIP SHALL CONFORM TO CHAPTER 19 THE CBC AND TO ALL REQUIREMENTS OF ACI 301, "SPECIFICATIONS FOR STRUCTURAL CONCRETE FOR BUILDINGS," EXCEPT AS SPECIFIED

- REQUIREMENTS OF ACT 301, SPECIFICATIONS ON AN ANTICAL REPORTS OF ACT 301, SPECIFICATIONS OF APPROVED COMPACTED FILL.

  17. ALL FOOTINGS SHALL REST ON FIRM NATURAL SOIL OR APPROVED COMPACTED FILL.

  18. MONOPOLE CAISSONS ARE DESIGNED BY OTHERS. PROVIDE ADEQUATE SEPARATION AND/OR COMPRESSIBLE MATERIAL AROUND THE TOP OF THE CAISSON AS DIRECTED BY THE CAISSON ENGINEER TO PROTECT ADJACENT NEW AND EXISTING FOUNDATIONS AND OTHER ELEMENTS.

  19. CONTROL JOINTS SHALL BE PLACED IN ALL CONCRETE SLABS PER THE SCHEDULE BELOW. SAWCUT WITHIN 4 HOURS AFTER THE POUR USING THE "SOFF-CUT" PROCEDURE.

SLAB THICKNESS	MAXIMUM SPACING
4"	10'-0"
5"	12'-0"
6" AND LARGE	15'-0"

# REINFORCING STEEL NOTES

- ALL REINFORCING SHALL BE NEW DEFORMED BARS CONFORMING TO ASTM A615, GRADE 60 OR ASTM A706, GRADE 60. ALL WELDED REINFORCING BARS SHALL CONFORM TO ASTM A706.
- REINFORCING STEEL SPLICE/DEVELOPMENT LENGTHS SHALL CONFORM TO THE FOLLOWING MINIMUM LENGTHS
- INLESS NOTED OTHERWISE: SPLICED BARS SHALL BE WIRED TOGETHER. SPLICE/DEVELOPMENT LENGTH (INCHES) OTHER BAR
  - BAR SIZE TOP BAR

THE BAR LENGTHS APPLY TO HORIZONTAL REINFORCEMENT PLACED WITH MORE THAN 12" OF FRESH CONCRETE CAST BELOW THE SPLICE OR DEVELOP LENGTH. COMPRESSION DOWEL EMBEDMENT: 22 BAR DIAMETERS WELDED WIRE FABRIC ONE SPACING OF CROSS WIRES PLUS 2"

- 3. MINIMUM CONCRETE COVER UNLESS NOTED OTHERWISE: 3" UNFORMED SURFACE IN CONTACT WITH THE GROUND FORMED SURFACES EXPOSED TO EARTH OR WEATHER #6 BARS AND LARGER #5 BARS AND SMALLER: FORMED SURFACES NOT EXPOSED TO EARTH OR WEATHER 1.5" 1.5 REAMS GIRDERS AND COLUMNS: SLABS, WALLS AND JOISTS #11 BARS AND SMALLER: 0.75"
- BARS SHALL BE CLEAN OF MUD, OIL, OR OTHER COATINGS LIKELY TO IMPAIR BONDING.
  ALL REINFORCING SHALL BE SECURED IN PLACE PRIOR TO INSPECTIONS, PLACING CONCRETE, OR GROUTING MASONRY.
- MASONRY.

  6. WELDING: BARS SHALL NOT BE WELDED UNLESS AUTHORIZED. WHEN AUTHORIZED, CONFORM TO ACI 301 SEC 3.2,
  2.2. AND AWS D1.4 "WELDING" AND PROVIDE ASTM A706, GRADE 60 REINFORCEMENT.

  7. FIELD BENDING: CONFORM TO ACI 301 SEC 3.3.2.8 "FIELD BENDING OR STRAIGHTENING". BAR SIZES #3 THROUGH #5 MAY BE FIELD BENT COLD THE FIRST TIME, OTHER BARS REQUIRE PREHEATING, DO NOT TWIST
- B. SPLICE ALL BARS IN MASONRY WITH A MINIMUM OF 46 BAR DIAMETER LAPS (2'-0" MINIMUM).

  9. ALL VERTICAL WALL REINFORCEMENT SHALL BE CONTINUOUS BETWEEN SPLICE LOCATIONS SHOWN IN THE DETAILS.

DRY CREEK JONESVILLE 6521 GREEN VALLEY ROAD PLACERVILLE, CALIFORNIA 95667



SAN RAMON, CALIFORNIA 94583





AT&T SITE NO CVL03123 PROJECT NO: 13787633 DRAWN BY: SD

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C	04/26/2021	100% ZDs	WF
В	03/22/2021	100% ZDs	SO
A	02/05/2021	90% ZDs FOR REVIEW	SD
REV	DATE	DESCRIPTION	BY

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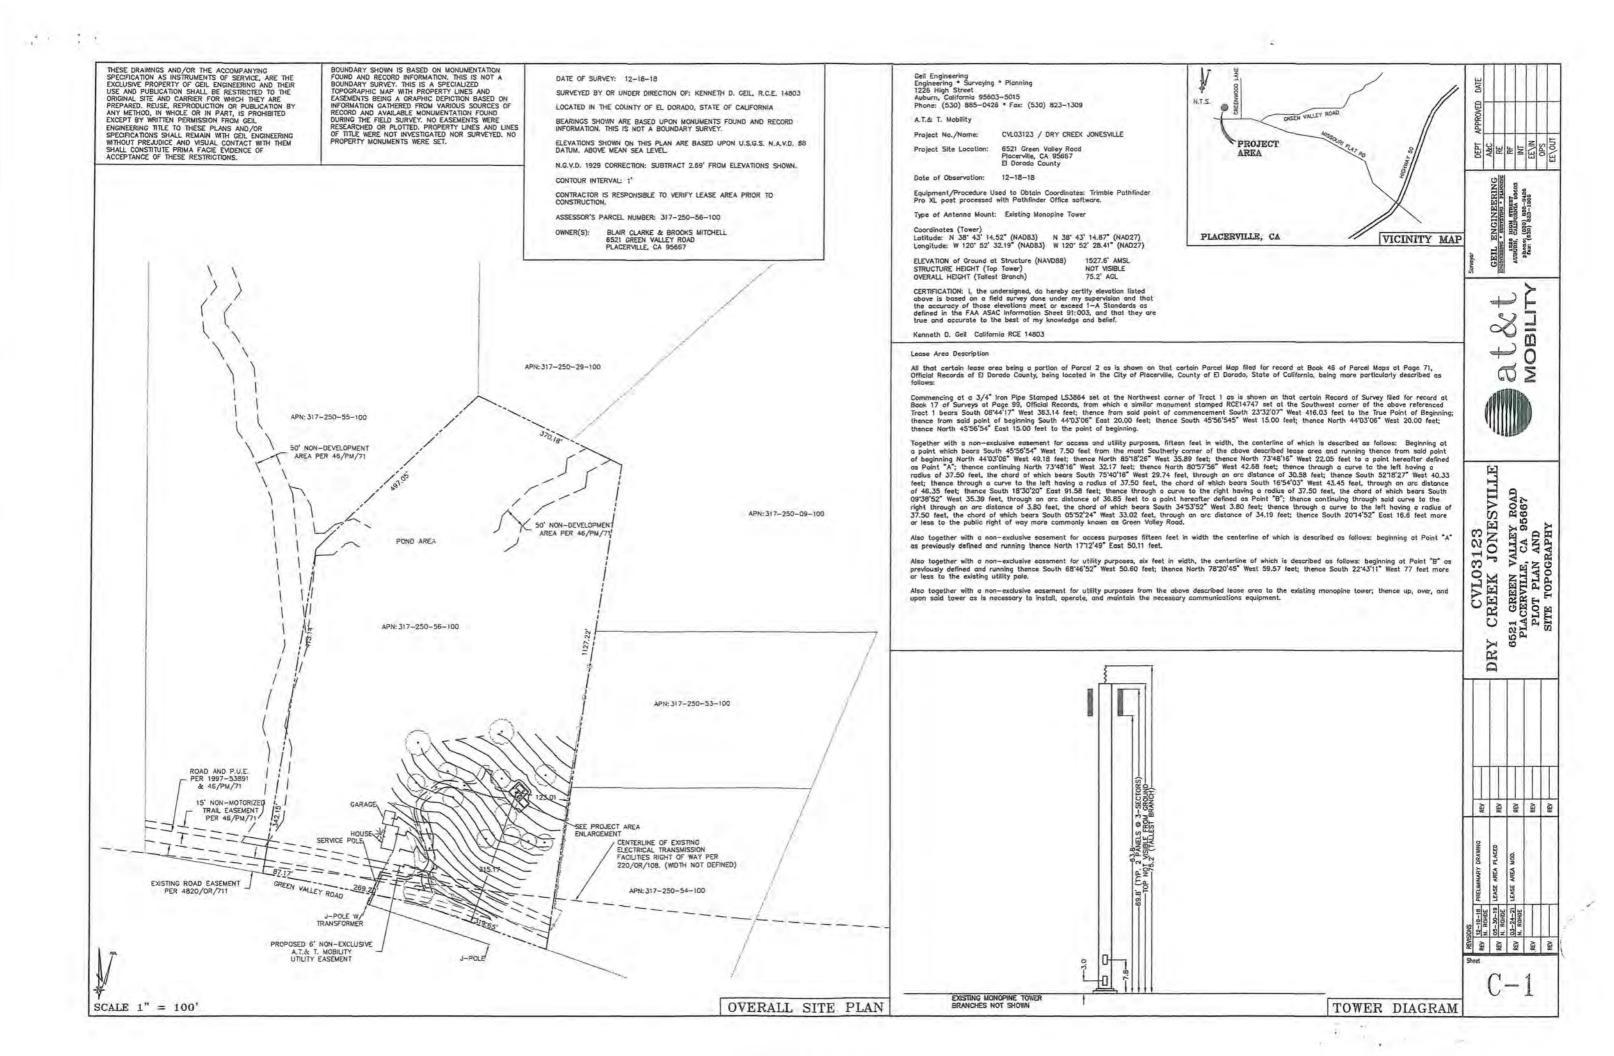
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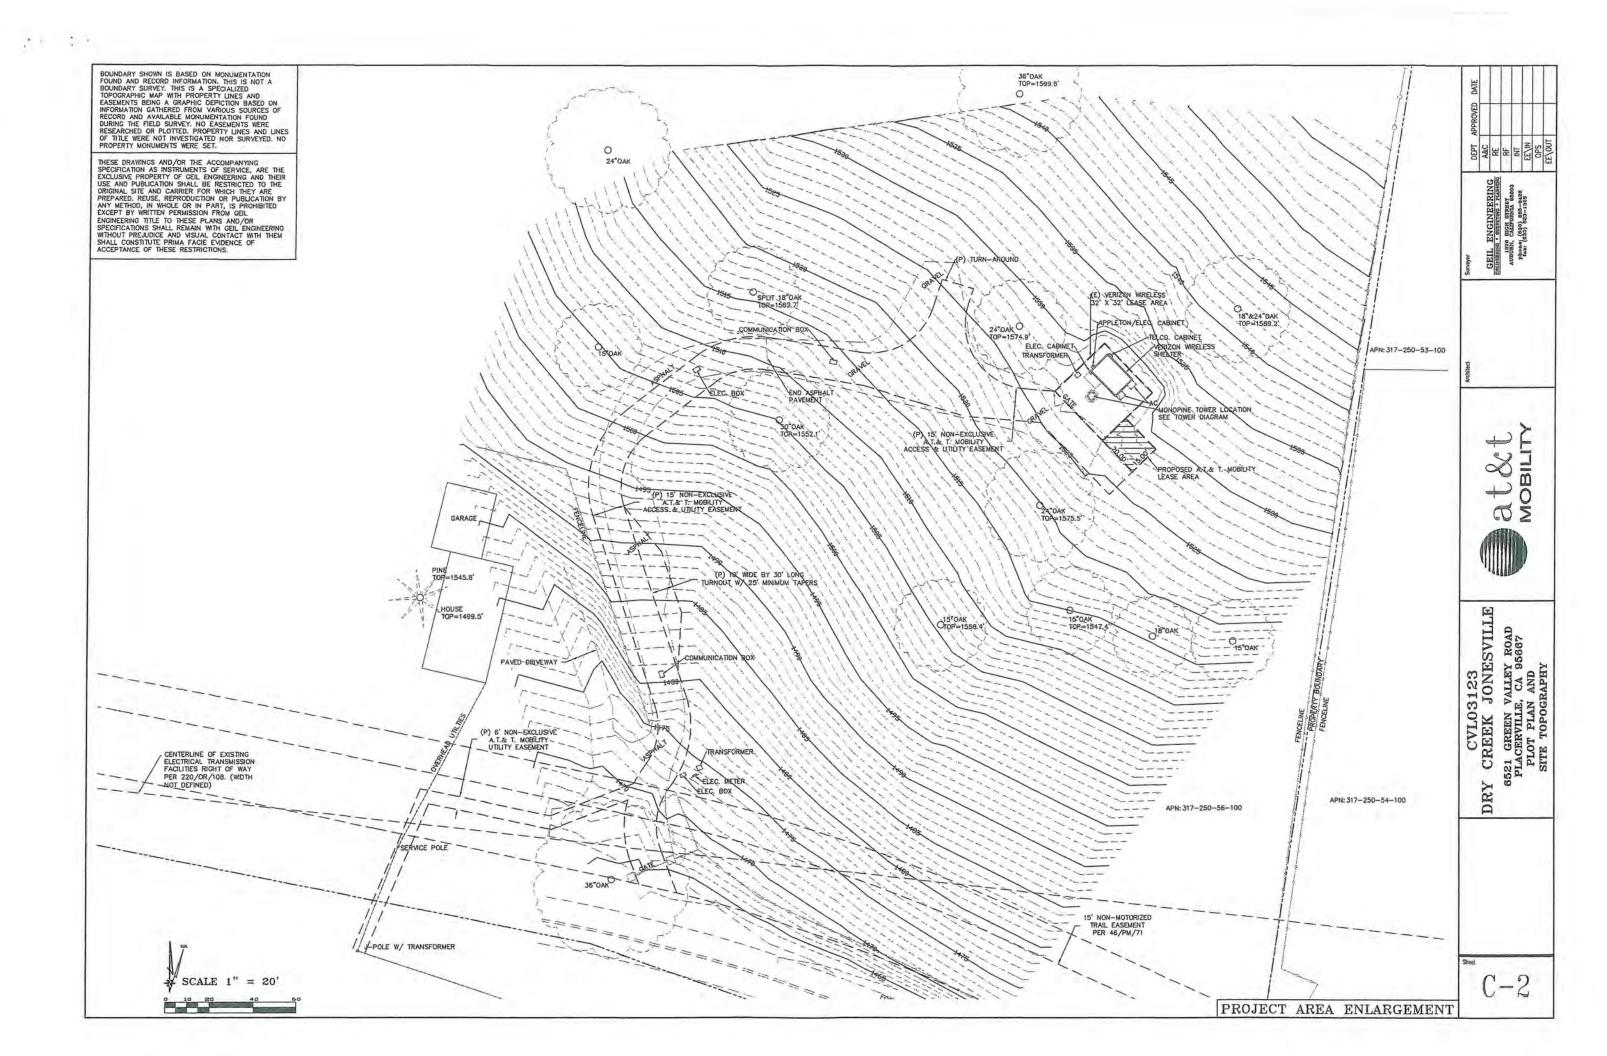
SHEET TITLE

GENERAL NOTES

SHEET NUMBER

GN-3





### NOTES:

- 1, THE WIRELESS COMMUNICATION FACILITY COMPLIES WITH FEDERAL STANDARDS FOR RADIO FREQUENCY IN ACCORDANCE WITH THE TELECOMMUNICATION ACT OF 1998 AND SUBSECUENT AMENDMENTS AND ANY OTHER REQUIREMENTS IMPOSED BY STATE OR FEDERAL REGULATORY AGENCIES.
- NO EXISTING PARKING STALLS ARE BEING ADDED OR REMOVED AS PART OF THE NEW INSTALLATION.
- THE BELOW GRADING INFORMATION IS AN ESTIMATE:


  \*TRENCH IS TO BE 3'-0' DEEP AND 16' WIDE ALL SPOILS TO BE PLACED BACK INTO TRENCH & COMPACTED TO 90%

  \*CONCRETE FOOTING IS TO BE 18 YARDS WITH A 5'-0' DIA.


  \*CONCRETE PAD IS TO BE 9 YARDS TOTAL DISPLACEMENT HALF ABOVE GRADE: DIST TO BE IMPACTED 5 YARDS UNIDER

  \*ALL SPOILS TO BE REMOVED FROM PROJECT SITE

DISCLAIMER:
THIS SET OF DRAWINGS WAS PREPARED UTILIZING
INFORMATION OBTAINED FROM PUBLIC DOCUMENTS MADE
AVAILABLE ON THE JURISDICTIONS WEBSITE. M SQUARED
WIRELESS CANNOT GUARANTEE THE ACCURACY OF THE DATA
AND INFORMATION DEPICTED ON THE JURISDICTIONS WEBPAGE
AND HEREBY EXPRESSLY DISCLAIMS ANY RESPONSIBILITY FOR
THE TRUTH, VALIDITY, NAVALIDITY, ACCURACY, INACCURACY OF
ANY SAID DATA AND INFORMATION. THE PARCEL LINES ON
MAPS ARE FOR ILLUSTRATION PURPOSES ONLY, AND ARE NOT
INTENDED TO BE USED AS A SURVEY PRODUCT. USER ACCEPTS
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SAN RAMON, CALIFORNIA 94583

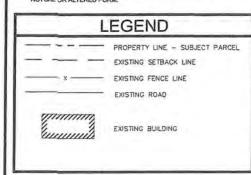

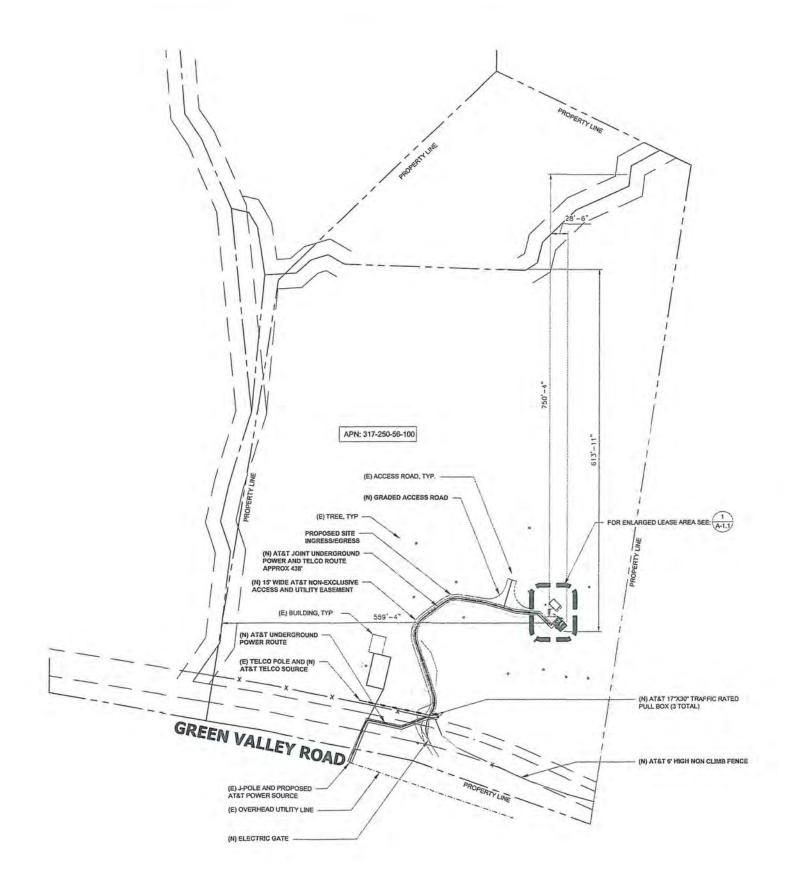

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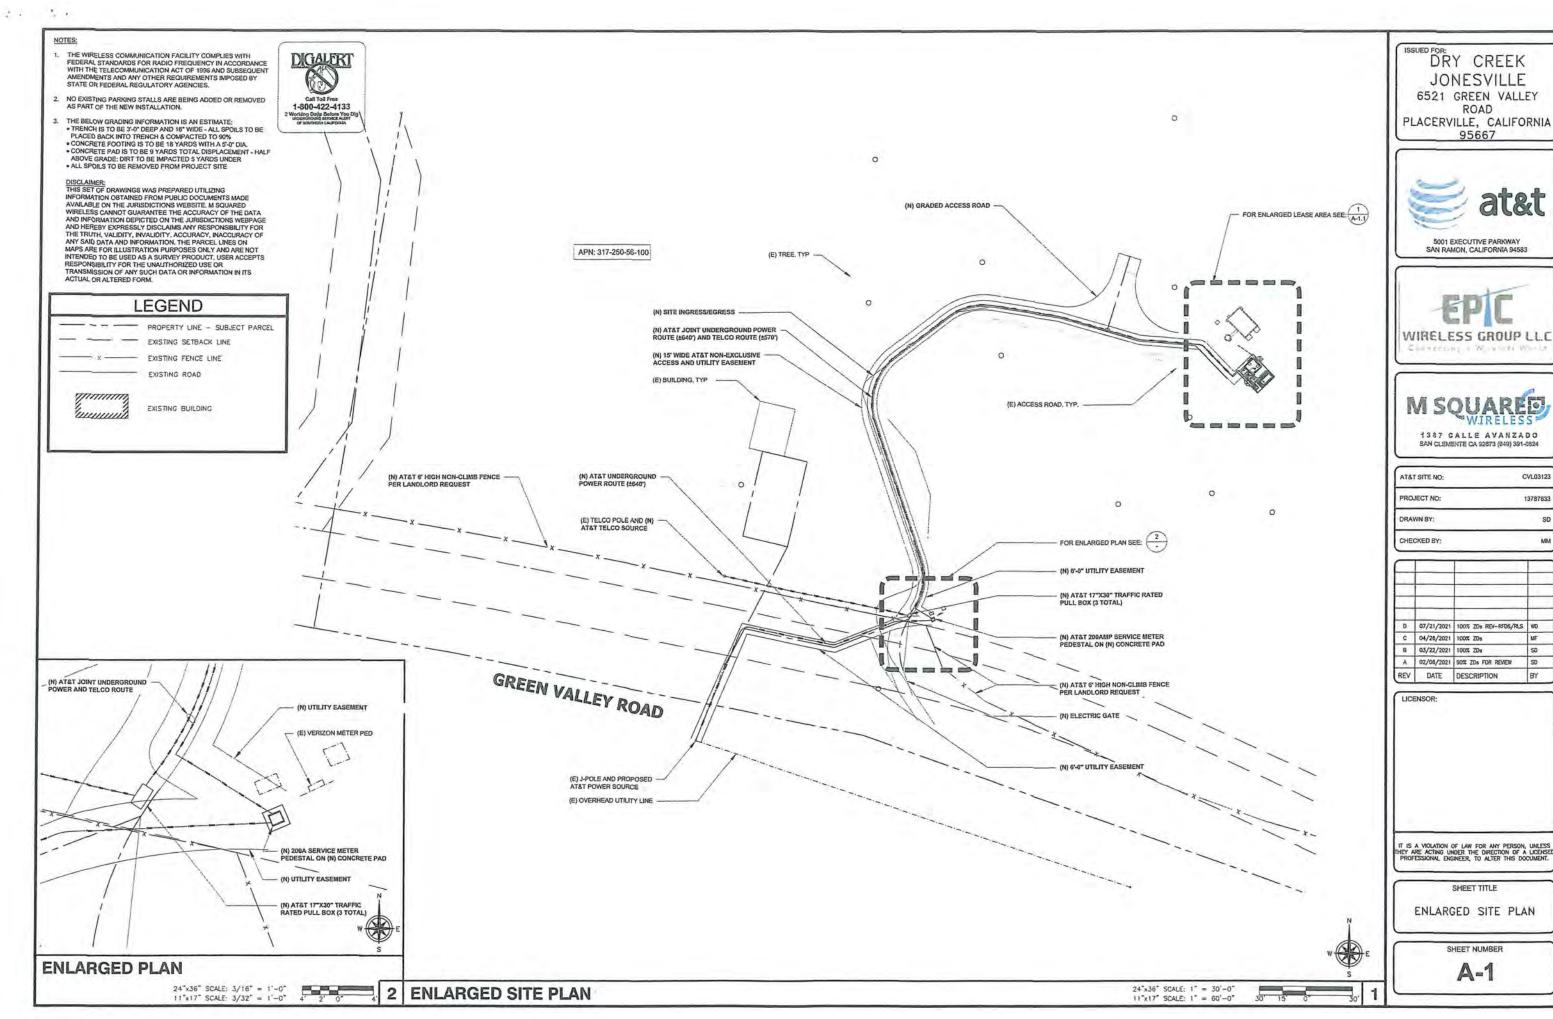
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8	03/22/2021	100% ZDs	SO
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SITE PLAN

SHEET NUMBER








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A	02/08/2021	90% ZDs FOR REVIEW	SD
REV	DATE	DESCRIPTION	BY

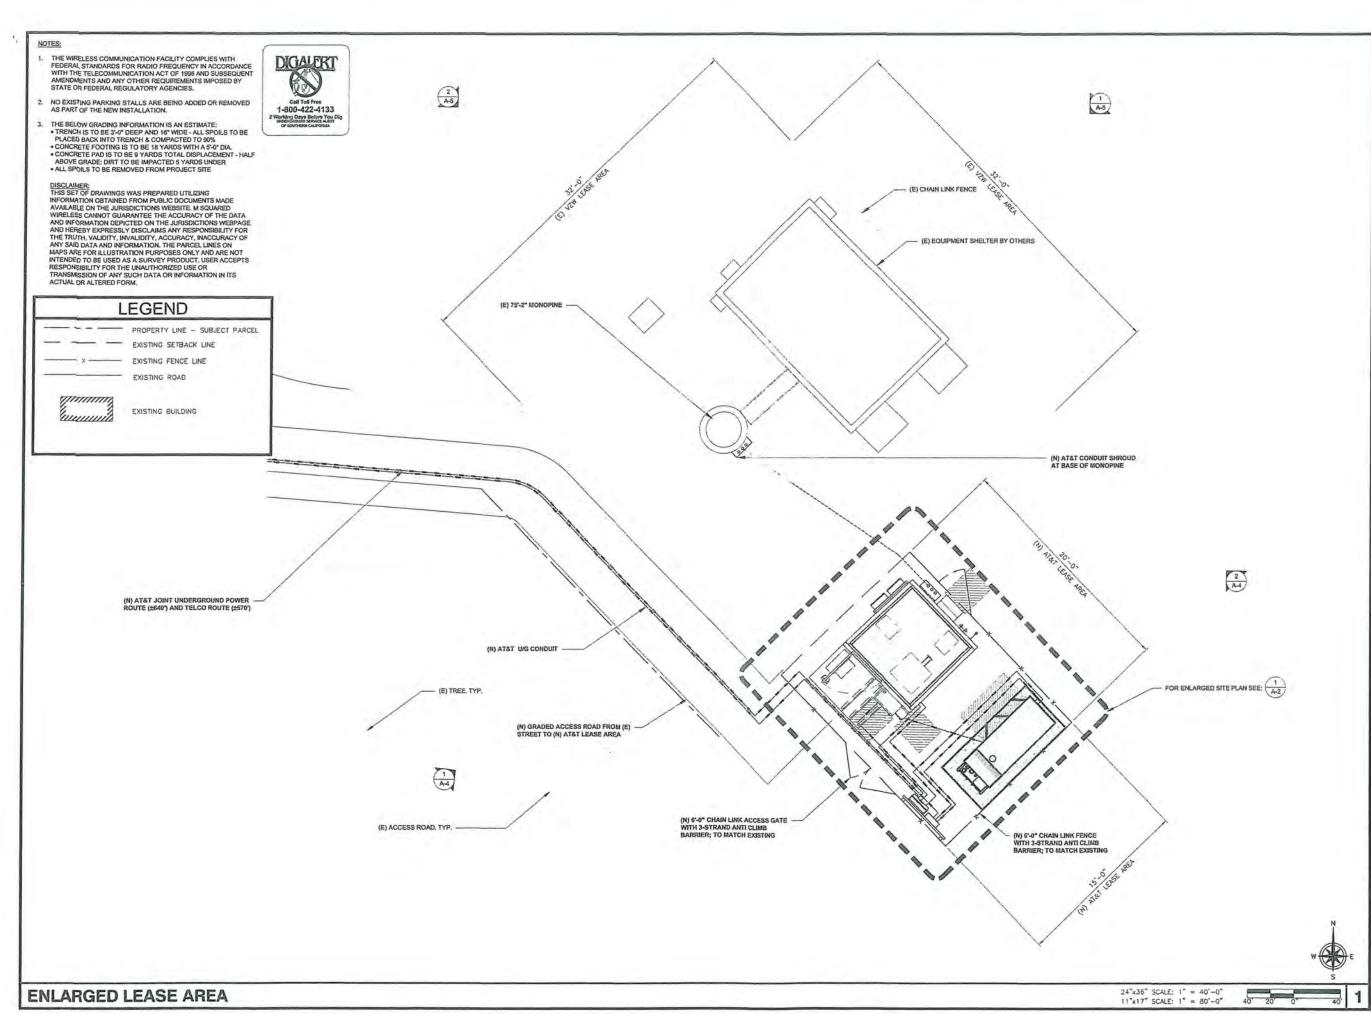

DRY CREEK
JONESVILLE
6521 GREEN VALLEY
ROAD
PLACERVILLE, CALIFORNIA
95667



5001 EXECUTIVE PARKWAY SAN RAMON, CALIFORNIA 94583





SAN CLEMENTE CA 92673 (949) 391-8624

CVL03123

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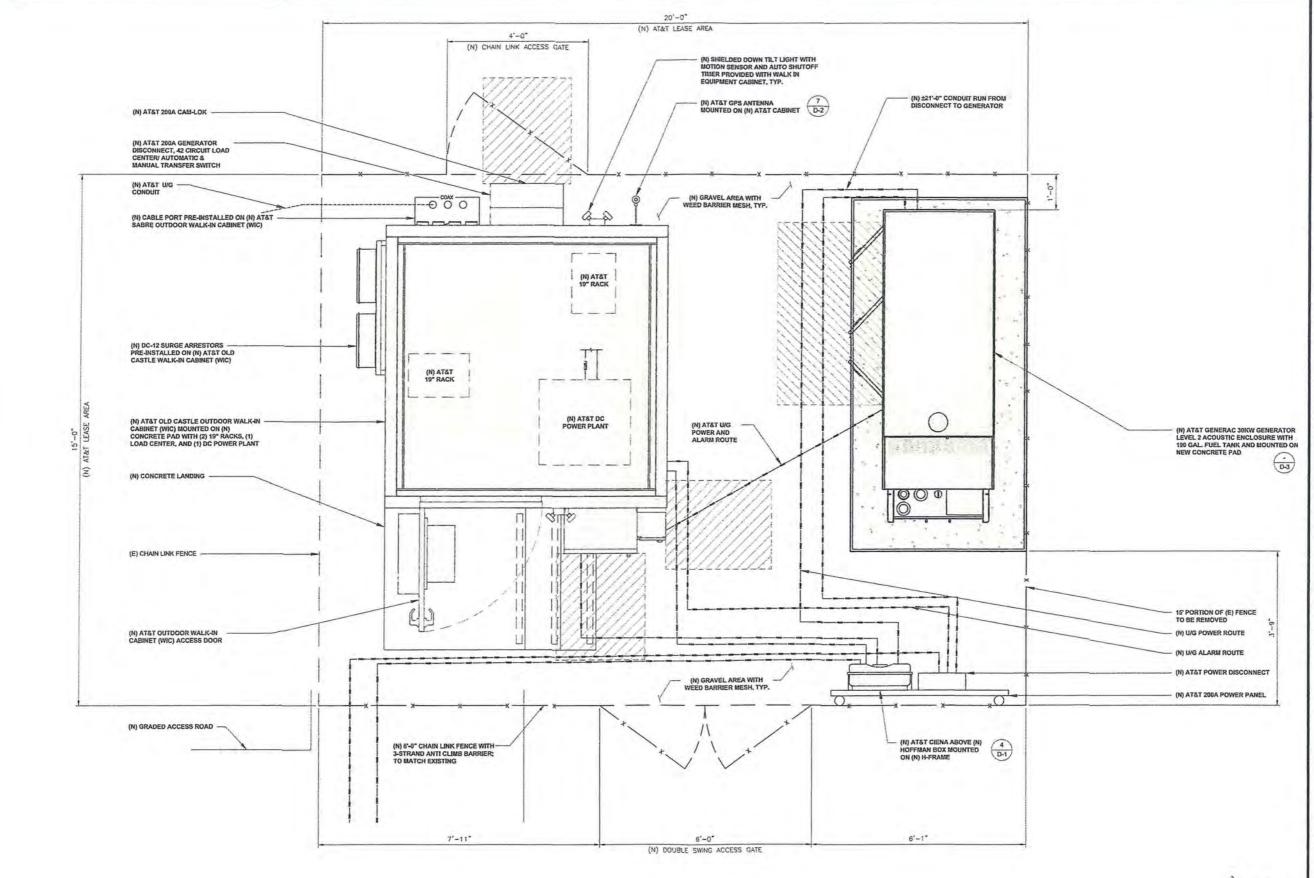
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AREA

SHEET NUMBER

A-1.1



ISSUED FOR DRY CREEK **JONESVILLE** 6521 GREEN VALLEY ROAD PLACERVILLE, CALIFORNIA 95667







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SHEET TITLE

EQUIPMENT PLAN

A-2

24"x36" SCALE: 3/4" = 1'-0" 11"x17" SCALE: 3/8" = 1'-0"

			W OPTIMAL ANTENNA AND REQUIREMENT (VERIFY W			3)		NEW REMOTE RADIO UNITS, TOW ANTENNA FILTERS (VERIF			D	
1	ANTENNA	NEW	MATERIA MODEL	ANTENNA	RAD	LI	MISSION NE	POLICE MODES	RRUS	TMA, ANTENNA FILTER,	TMA	#DC
1	MILEMAN	TECHNOLOGY	ANTENNA MODEL	AZIMUTH	CENTER	LENGTH	TYPE	RRUS MODEL	COUNT	& SURGE SUPRESSOR	SURGE	FEEDS
	A1	LTE 700/850/1900	ANDREW (COMMSCOPE) NNH4-65B-R6H4 (6'-0")	90*	67-0	±90"	FIBER	RRUS BS/B12 4449, RRUS B2/B66A 8843	2	DC-9 'SQUID' SURGE SUPPRESSOR	SURGE COUNT	4
and and	A2	LTE 700/1900/AWS	ANDREW (COMMSCOPE) NNH4-65B-R6H4 (6'-0")	90*	67-0	±90"	FIBER	RRUS B14 4478, RRUS B25 4415	2			2
	B1	LTE 700/850/1900	ANDREW (COMMSCOPE) NNH4-65B-R6H4 (6'-0")	330*	67-0	±90°	FIBER	RRUS 85/B12 4449, RRUS 82/B66A 8843	2	DC-9 'SQUID' SURGE SUPPRESSOR	t	4
	B2	LTE 700/1900/AWS	ANDREW (COMMSCOPE) NNH4-65B-R6H4 (6'-0")	330*	67'-0"	#90	FIBER	RRUS B14 4478, RRUS B25 4415	2			2
	C1	LTE 700/850/1900	ANDREW (COMMSCOPE) NNH4-65B-R6H4 (6'-0")	245*	67-0	±90°	FIBER	RRUS B5/B12 4449, RRUS B2/B66A 8843	2	DC-9 'SQUID' SURGE SUPPRESSOR	1	4
	C2	LTE 700/1900/AWS	ANDREW (COMMSCOPE) NNH4-65B-R6H4 (6'-0")	245*	67-0	±90°	FIBER	RRUS B14 4478, RRUS B25 4415	2			2
									12		3	18
									TOTAL		TOTAL	TOTAL

DRY CREEK **JONESVILLE** 6521 GREEN VALLEY ROAD PLACERVILLE, CALIFORNIA 95667



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C	04/26/2021	100% ZDs	MF
В	03/22/2021	100% ZDs	50
Α.	02/08/2021	90% ZDs FOR REVIEW	SD
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SHEET TITLE ANTENNA PLAN & SCHEDULE


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A-3

# ANTENNA & TOWER MOUNTED EQUIPMENT SCHEDULE

### NOTES TO CONTRACTOR:

- M SQUARED WIRELESS ACCEPTS NO LIABILITY FOR THE STRUCTURAL CAPACITY OF THE TOWER STRUCTURE, MOUNTS, ANTENNAS, CABLES OR ANY OTHER APPURITENANCE ON THE TOWER. THE CONTRACTOR AND SUBCONTRACTOR SHALL COORDINATE WITH AND COMPLY WITH THE PROVISIONS OF THE STRUCTURAL ANALYSIS PREPARED FOR THIS SITE AND PROJECT PRIOR TO THE INSTALLATION OF ANTENNAS AND CABLE ON THE TOWER, IMMEDIATELY REPORT ANY THE TOWER IMMEDIATELY REPORT ANY DISCREPANCIES BETWEEN THE CONSTRUCTION DRAWINGS AND THE
- STRUCTURAL ANALYSIS TO AT&T.
  CONTRACTOR IS TO REFER TO AT&T'S MOST
  CURRENT RADIO FREQUENCY DATA SHEET (RFDS) PRIOR TO CONSTRUCTION CABLE LENGTHS WERE DETERMINED BASED ON
- VISUAL INSPECTION DURING SITE-WALK. CONTRACTOR TO VERIFY ACTUAL LENGTH DURING PRE-CONSTRUCTION WALK CONTRACTOR TO VERIFY PORTS HAVE

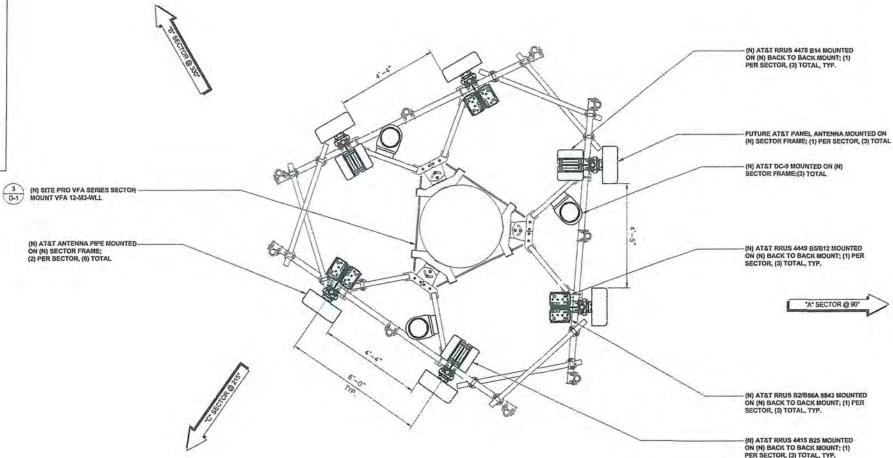

- (N) AT&T RRUS 4415 B25 MOUNTED ON (N) BACK TO BACK MOUNT; (1) PER SECTOR, (3) TOTAL, TYP. 24"x36" SCALE: 1/2" = 1'-0" 11"x17" SCALE: 1/4" = 1'-0" **NEW ANTENNA PLAN** 

(E) VERIZON WIRELESS ANTENNAS TOP OF EXISTING MONOPINE STEEL & TOP OF EXISTING VERIZON ANTENNAS 270"-0" A.G.L. EXISTING VERIZON ANTENNA RAD CENTER
±66-10" A.G.L. (E) EQUIPMENT SHELTER BY OTHERS -(E) CHAIN LINK FENCE

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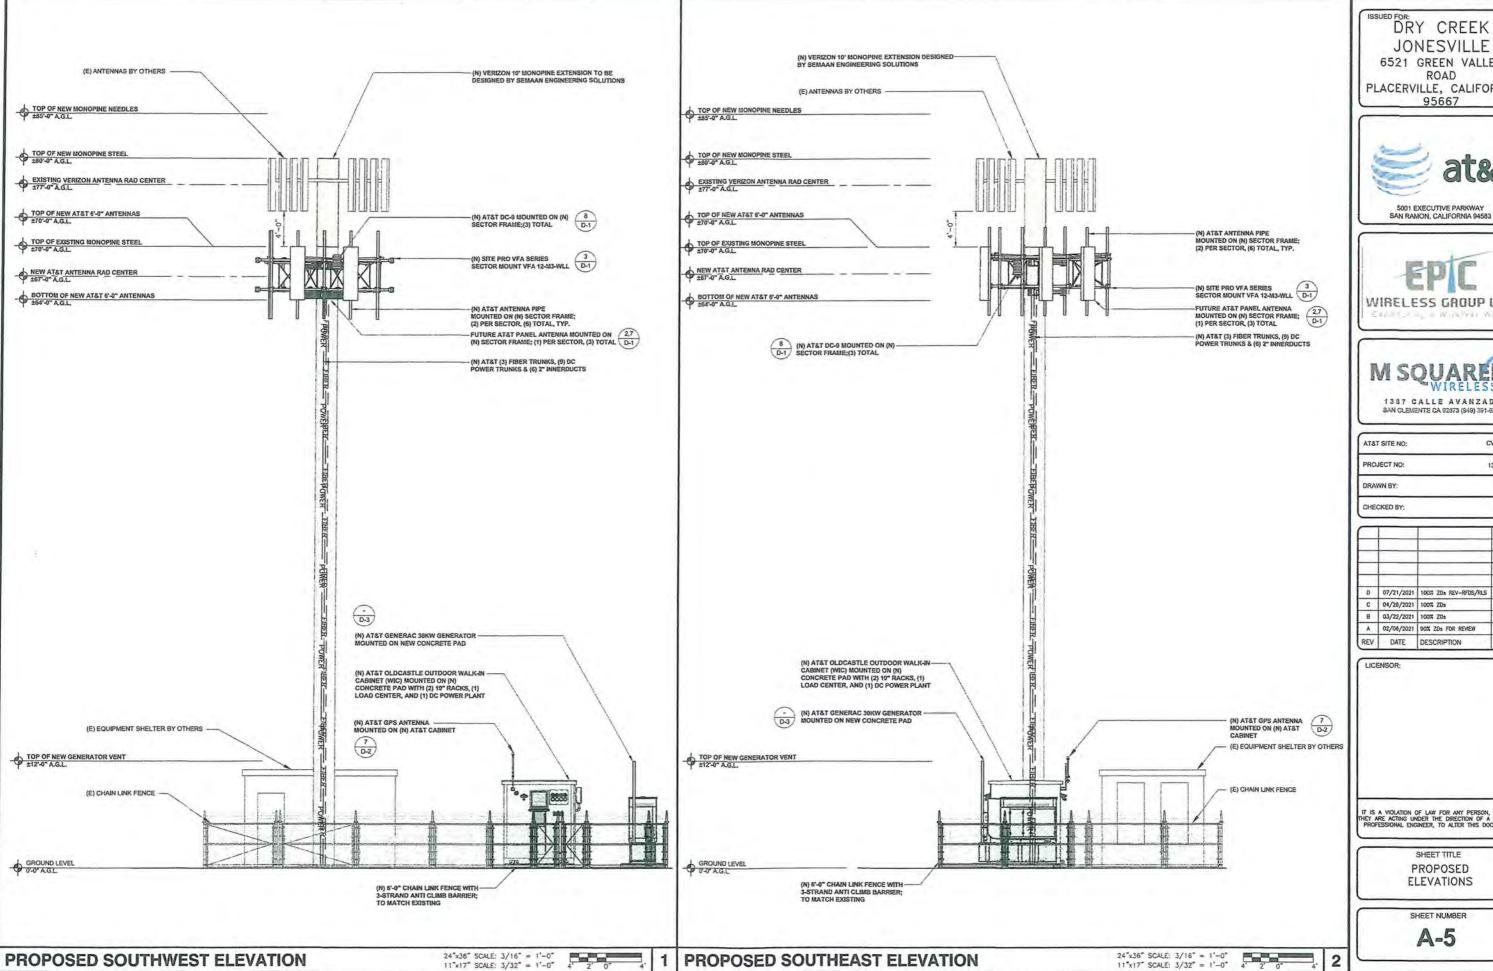
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В	03/22/2021	100% ZDs	SD
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SHEET TITLE

EXISTING ELEVATION



1.7

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95667








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PROPOSED **ELEVATIONS** 

SHEET NUMBER



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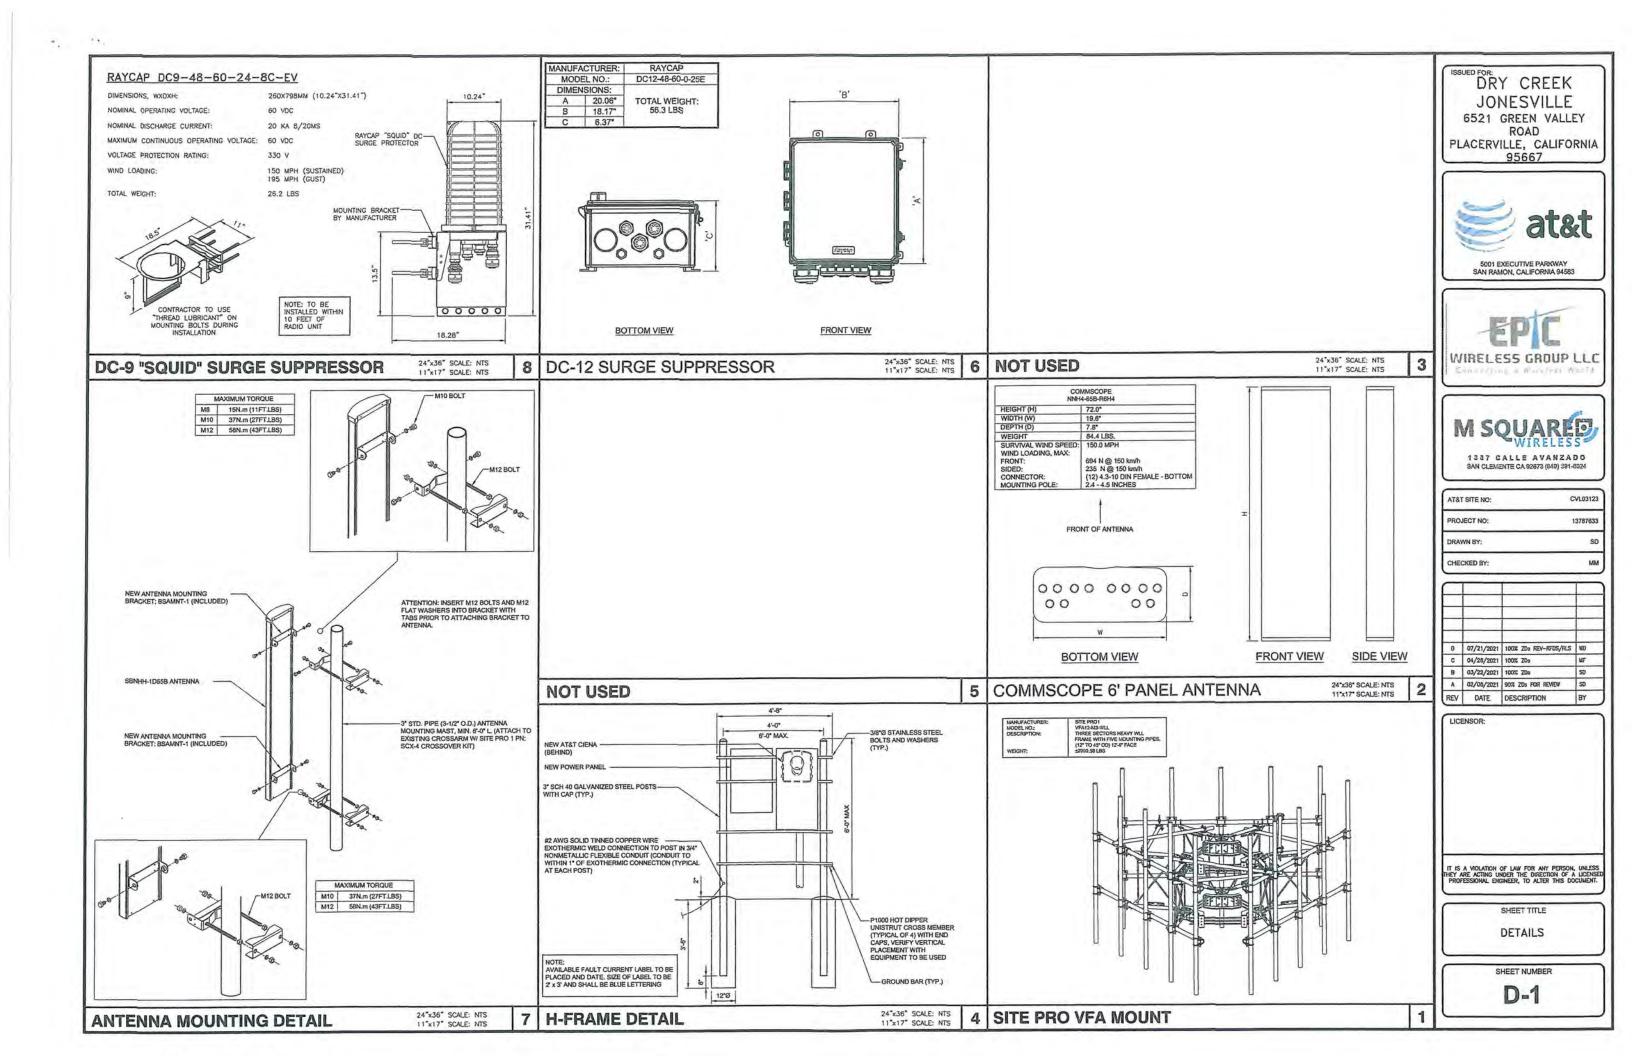
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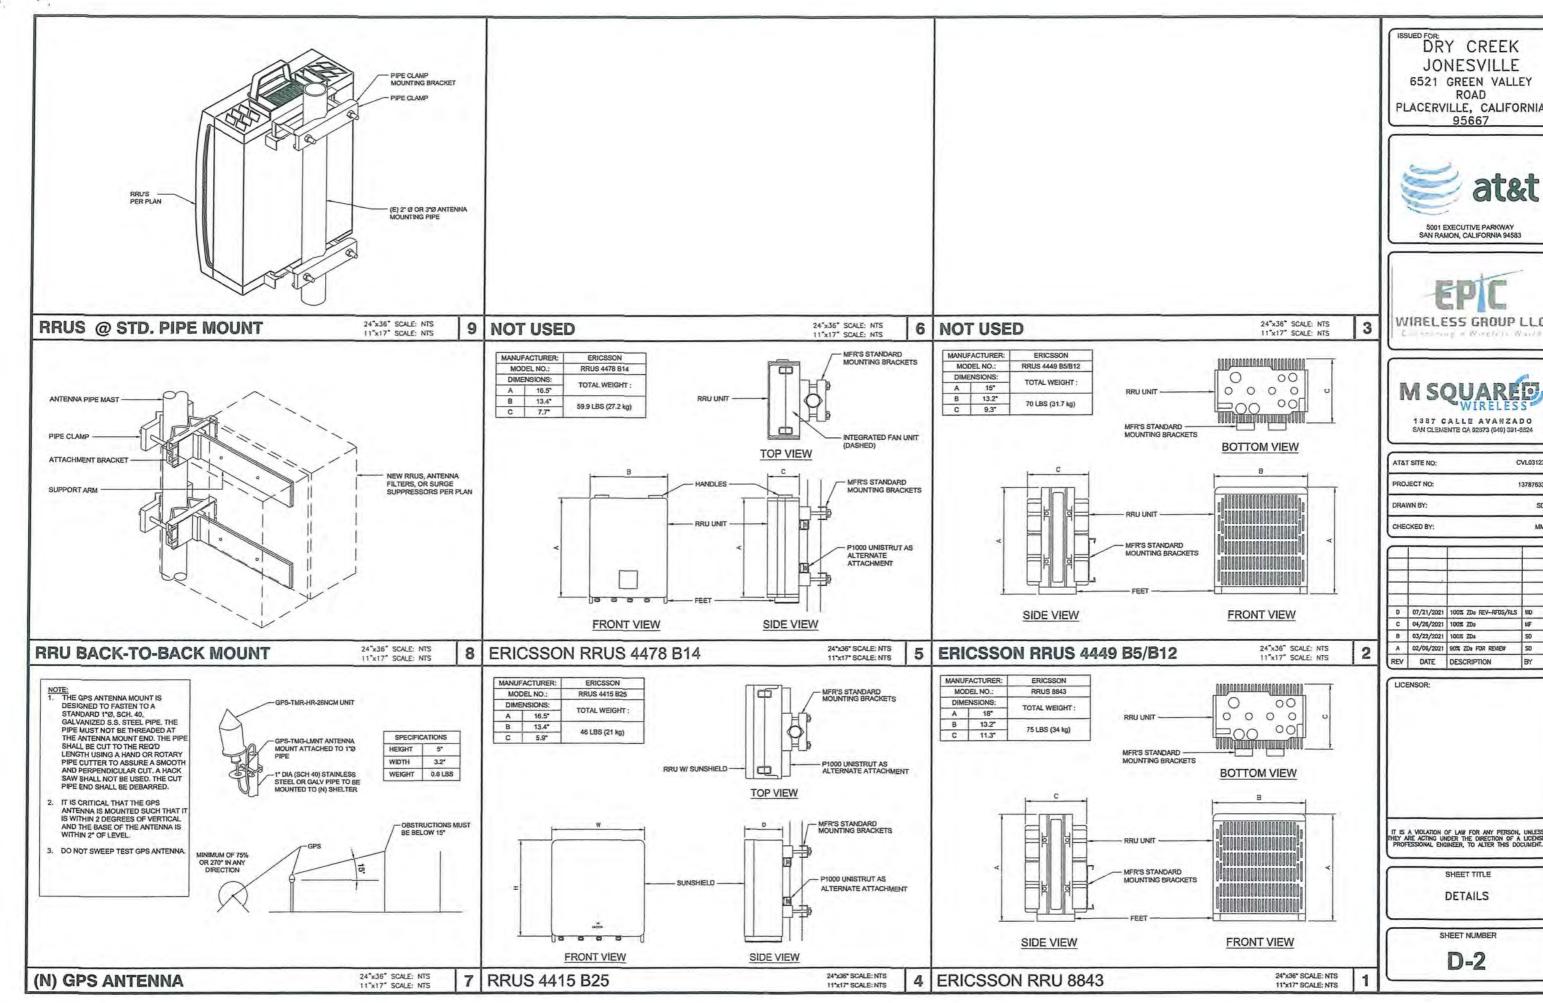
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SHEET TITLE PROPOSED **ELEVATIONS** 

SHEET NUMBER

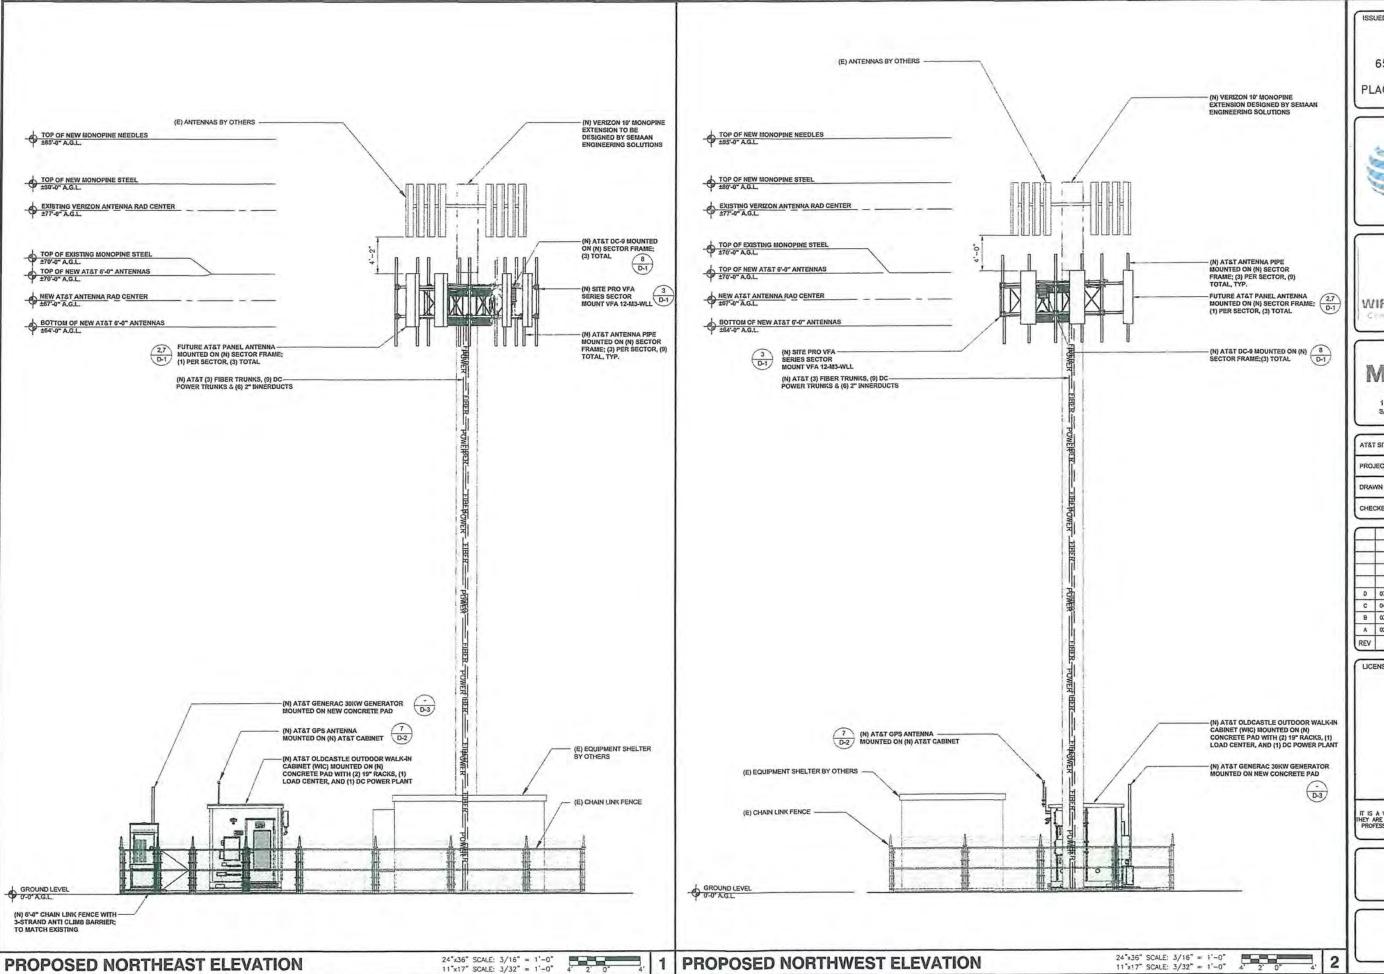



6521 GREEN VALLEY PLACERVILLE, CALIFORNIA







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A	02/06/2021	90% ZDs FOR REVIEW	SO
REV	DATE	DESCRIPTION	BY

Standby Power Rating

30 MW. 38 KVA. 60 Hz

Prime Power Rating

FOR REFERENCE ONLY

ALTERNATOR SYSTEM

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GENERATOR SET

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ENCLOSURE (If Selected)

FUEL TANKS (II Selected)

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 Standon Steel Hardware

# ENGINE SYSTEM C Ol Holes C Calca States (New Set Only)

### FUEL SYSTEM o to the felter

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Denel Arcanishosh ALTERNATOR SYSTEM

### WARRANTY (Standby Gensets Only) GENERATOR SET

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 5 Year Insted Warrelly
 5 Year Insted Warrelly
 7 Year Intended United Warrelly
 7 Year Intended United Warrelly
 10 Year Intended United Warrelly C Exhaudoff schory Testing C 3 Pressor Load Cester C Part Vibration Issues on

FUEL TANKS

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Stantes Sted Fants

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CONTROL SYSTEM

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Oranick (Month) Han
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FUEL TANKS (Size On Last Page) ... Am (2012 mm) Fill Datum 1 mm (2012 mm) Fill Catalon 2 mm (2015 mm) Fill Catalon 3 Overall Protestion Vote 3 Overall Protestion Vote 3 Overall Protestion Vote 3 Overall Protestion Vote à h fain Spil Ber 2 Tank Doub 2 Tank Doub 3 Fail Level Scales and Mana 3 BY Yest System 3 Bits Rated Stanless Steel Fael

GENERAC INDUSTRIAL

# DATAMENTO DATAMENT

ENGINE SYSTEM Coulott old bridge lid Yes o Plat Consumest Pan

CONTROL SYSTEM of Spare Inputs (will) (Netputs in A

C 36d Breaker Sp.Jemi

OPEN SET (Includes Exhaus) Flor)

GENERATOR SET a Special Letting

ALTERNATOR SYSTEM

CIRCUIT BREAKER OPTIONS

© Man Line Croud Produs © 2nd Main Line O'cot Produs

ENCLOSURE

O Westhy Protected Eng

Short lop and Anchory Contact Of Flechison Display-deeps

DRY CREEK **JONESVILLE** 6521 GREEN VALLEY ROAD PLACERVILLE, CALIFORNIA 95667



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SHEET TITLE

DETAILS

SHEET NUMBER

D-3

# Colleg and Standards

Not all codes and standards apply to all configurations. Contact factory for details.



(L) UL2200, UL503, UL469, UL142




DIN S BS5514 and CIN 6271



SAE J1349



NEC700 701 702, 703

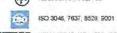

SD030 | 2.2L | 311 MV

INDUSTRIAL DIESEL GENERATOR SET

AMESI

ENGINE SPECIFICATIONS

ALTERNATOR SPECIFICATIONS

NEMA ICS10, MG1, 250, ICS6, AB1

Generac searched globally to ensure the most reliable

For over 50 years, Generac has provided innovative

Generac ensures superior quality by designing and manufacturing most of its generator components, including alternators, enclosures and base tanks, control systems and communications software.

engines power our generators. We choose only engines that have already been proven in heavy-duly industrial

Generac is committed to ensuring our customers' service

configurations and arrangements, allowing us to meet the standby power needs of practically every application.

Long Caro Messa

0-

Generac gensets utilize a wide variety of optons.

support continues after their generator purchase.

GENERAC INDUSTRIAL



Billion Cales
 Billion Tay
 Ballon Tay
 Ballon Tay
 Ballon Extend Connections
 Selected Advanted States theory

# Dialtal H Costrol Pagel- Drai 4x20 Display

# Program Fenctions

ENGINE SYSTEM

Fuel System

Cooling System

Electrical System

CONTROL SYSTEM

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SD030 | 2.2L | 30 WW INDUSTRIAL DIESEL GENERATOR SET

















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GENERAC INDUSTRIAL SD030 | 2.2L | 35 kW INDUSTRIAL DIESEL GENERATOR SET DUINED DATINGS skVA vs. Votage Dip Diesel - goh (Lph)

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WEATHER PROTECTED ENCLOSURE LEVEL 1 ACOUSTIC ENCLOSURE LEVEL 2 ACQUISTIC ENCLOSURE

General Prices Systems, Inc. [ PUI, Deck ] | Made the 12-2000 in control 2021 - Cutting and Performance of Association (Association on an including the change in 2014) for the