
- BASIN FLOORS SHALL HAVE WOOD TROWEL FINISH AND A MINIMUM SLOPE OF 1:4 FROM ALL DIRECTIONS TOWARD OUTLET PIPE.
- MINIMUM CLEAR DISTANCE BETWEEN ALL PIPE OUTSIDE DIAMETERS AT THE MANHOLE SHALL BE THE GREATER OF: OR HALF THE OUTER DIAMETER OF THE SMALLER PIPE.
- ALL CAST-IN-PLACE MANHOLES MUST BE FORMED IN A CIRCULAR SHAPE CONSISTENT WITH THE DIAMETER SPECIFIED ON THE PLANS AND REQUIRED TO FIT UPPER PRECAST SECTIONS. MINIMUM WALL THICKNESS SHALL BE AS SHOWN IN SCHEDULE A, EXCEPT THAT THE MINIMUM WALL THICKNESS SHALL BE 6". PRECAST RINGS SHALL BE SET WET OR REQUIRED KEY FORM SHALL BE INCLUDED IN THE FORM WORK TO ACCEPT THE PRECAST KEY. CONCRETE SHALL BE CONSOLIDATED BY AN ACCEPTABLE METHOD TO ENSURE ALL VOIDS ARE REMOVED.
- PRECAST RISER SECTIONS MAY BE USED WHEN "H" < 8'.
- 11. THE MANHOLE FRAME AND COVER SHALL BE MADE OF GRAY CAST IRON.
- ALL PARTS OF THE MANHOLE FRAME AND COVER EXCEPT MACHINED SURFACES SHALL BE COATED WITH ASPHALTUM PAINT.
- THE MANHOLE FRAME AND COVER SHALL BE TESTED FOR ACCURACY OF FIT AND SHALL BE MARKED IN SETS BEFORE DELIVERY. THE COVER SHALL FIT THE FRAME SNUGLY BUT NOT TIGHTLY.
- 14. SEE SHEET D-2 FOR STATION AND OFFSET OF MH Q.
- 15. CONSTRUCTION PAPER TO BE PLACED BETWEEN CONCRETE COLLAR & OS FLAT SLAB TOP TO FORM JOINT.
- 16. DIMENSION " T_S " = 8" FOR MH ID <= 96"

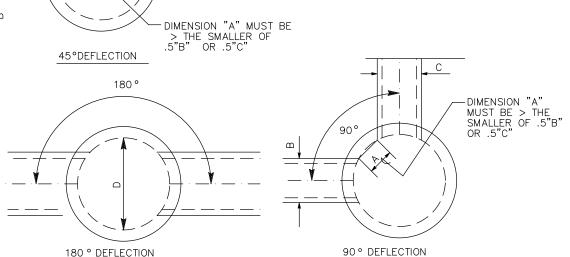

be responsible for the accuracy or completeness of electronic copies of this plan sheet



		SCHEDU	LE A			
		MH STAN	IDARDS			
		DIMENS	IONS			
NOMINAL	DEFLEC	TIONS (DEG	REES)			
	135-180	90	45		H<=	10'-0"
MH ID	Max PIPE ID	Max PIPE ID	Max PIPE ID	Т	Asi	Aso
in	in	in	in	in	si/LF	si/LF
48	30	24	12	5.0	0.16	0.09

Asi = INNER CAGE, OR SINGLE CIRCULAR CAGE REINFORCEMENT.

DESIGN NOTES

COUNTY OF EL DORADO

DEPARTMENT OF TRANSPORTATION

Design Specifications: AASHTO LRFD Bridge Specifications, 6th edition with 2012 interims; Eratta; and CA Amendments. fy=65 ksi

CIP f'c=5.0 ksi f'c=3.6 ksi



EPARED UNDER THE SUPERVISION OF

STORM DRAIN MANHOLE DETAIL SHEET 1 OR 2

NO SCALE

THIS SHEET ACCURATE FOR DRAINAGE WORK ONLY

DRAINAGE DETAILS SCALE: AS SHOWN CU #### EA 03-0E961


DIAMOND SPRINGS PARKWAY PHASE 1B

SHEET

1/28/202

DH


HECKED: JN

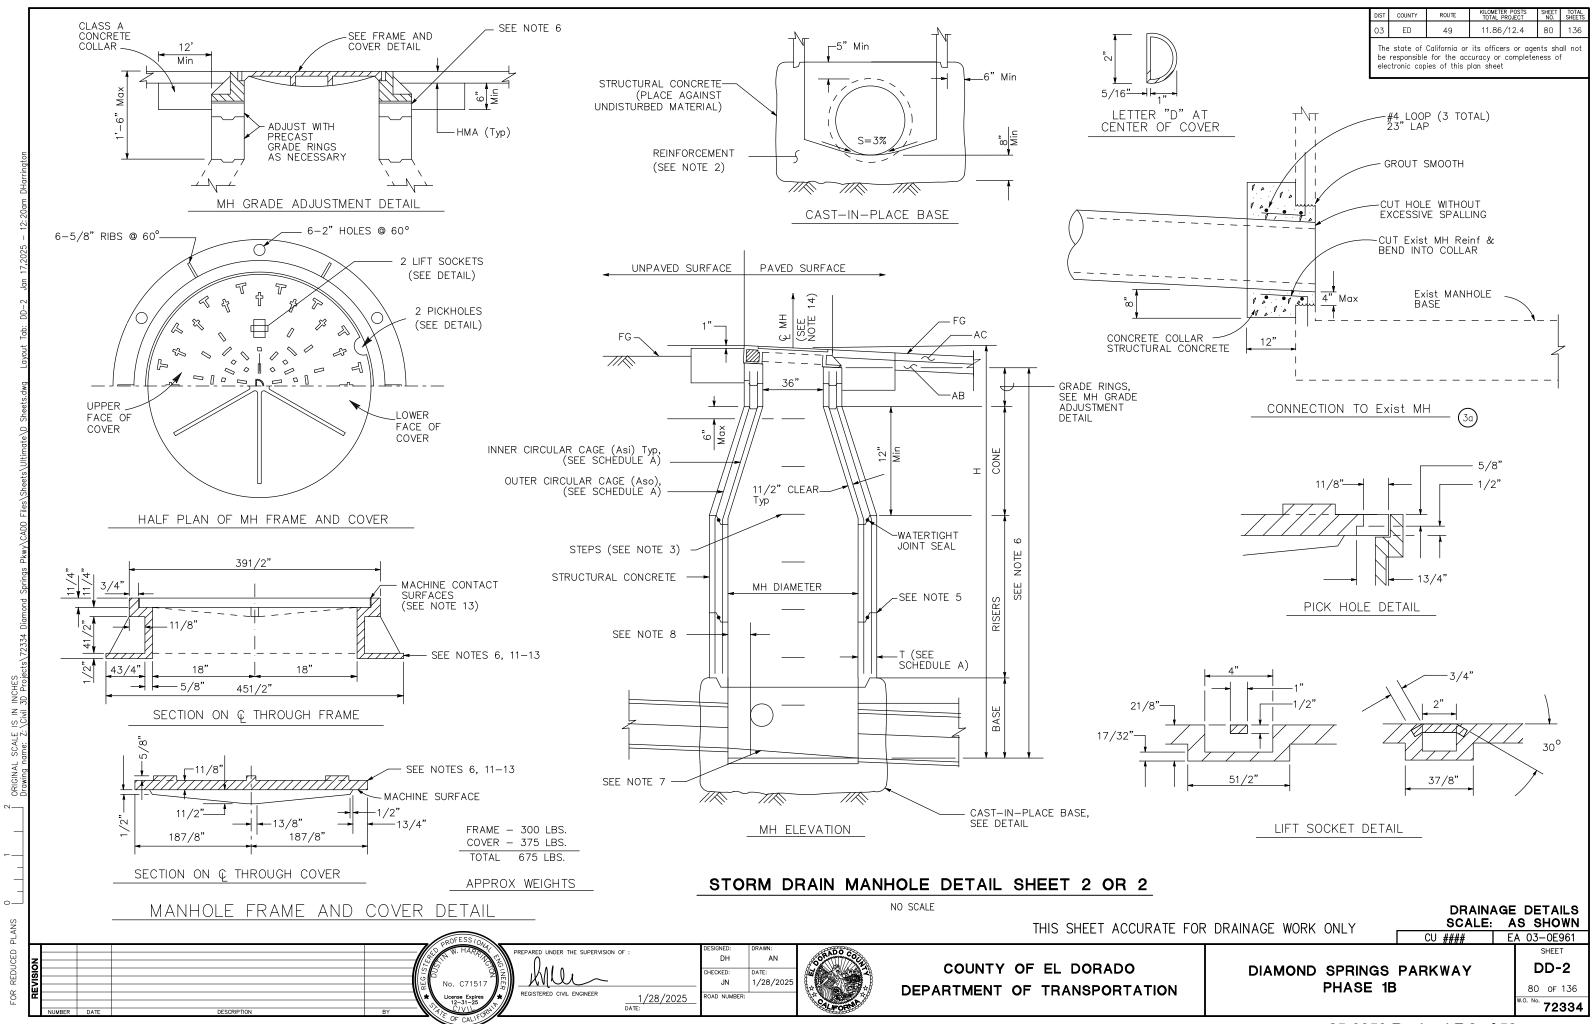

 DIST
 COUNTY
 ROUTE
 KILOMETER POSTS TOTAL PROJECT
 SHEET NO. SHEETS


 0.3
 ED
 49
 11.86/12.4
 81
 1.36


The state of California or its officers or agents shall not be responsible for the accuracy or completeness of electronic copies of this plan sheet

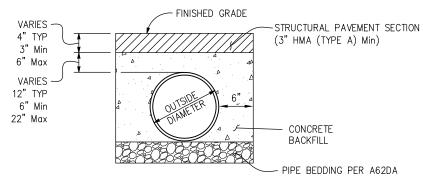

NOTES:

1. USE AT ALL LOCATIONS WHERE CONCRETE BACKFILL (PIPE TRENCH) IS INDICATED ON DRAINAGE PLANS.

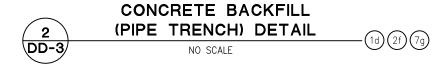

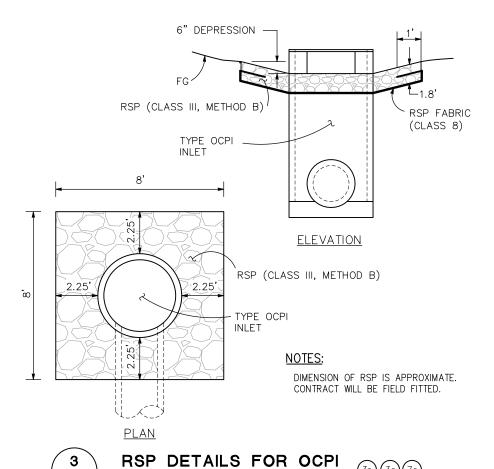

NO SCALE

REPARED UNDER THE SUPERVISION OF :

DH


JN

OAD NUMBER:

1/28/202

HECKED:

1/28/2025 DATE:

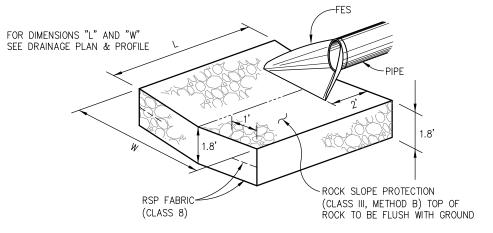

4 ROCK ENERGY DISSIPATOR (4d) (5c) (7f) (7h) (8t)

THIS SHEET ACCURATE FOR DRAINAGE WORK ONLY

DRAINAGE DETAILS
SCALE: AS SHOWN
CU #### EA 03-0E961

DIAMOND SPRINGS PARKWAY PHASE 1B

DD-3 81 OF 136 W.O. No. **72334**

SHEET

COUNTY OF EL DORADO

DEPARTMENT OF TRANSPORTATION

DIST	COUNTY	ROUTE	KILOMETER POSTS TOTAL PROJECT	SHEET NO.	TOTAL SHEETS
03	ED	49	11.86/12.4	82	136

SYSTEM No.	SHEET No.	DRAINAGE UNIT	48" SDMH	DI (TYPE GO)	DI (TYPE OCPI)	12" RCP	12" PP	18" PP	24" PP	36" PP	60" RCP	12" FES	18" FES	24" FES	36" FES	HEADWALL	RSP (BACKING No. 1, METHOD B)	RSP FABRIC (CLASS 8)	NOTES
		UNII	(EA)	(EA)	(EA)	(LF)	(LF)	(LF)	(LF)	(LF)	(LF)	(EA)	(EA)	(EA)	(EA)	(EA)	(CY)	(SY)	
		а																	Existing 48" SDMH
		b							213										
1	D-3	С	1																
		d							252										
		е	1																
		a		1				35											
2		b						35											
		С		4															
	D-4	d		1															
		a b		I				35											
3		С						35											
		d		1				33											
		a		1															
		b		'				58											
		С		1															
4	D-5	d		<u> </u>				78											
		е		1															
		f															6.67	11.11	
		а															4.67	7.78	
		b										1							
5		С				36													
		d										1							
	D-6	е															4.67	7.78	
	D-0	а		1															
		b						35											
6		С	1																
		d						35											
		е		1															
		a											1						
		b						400									6.67	11.11	
		C		4				103											
		d		1				14											
		e f			1			14											
					1												6.67	11.11	
7	D-7	g h						44									0.07	11.11	
		i		1				1 11							-				
		i		ı				90											
		k		1				"											
		I		•				27											
		m											1						
		n															6.67	11.11	
SU	B-BID QUAN		3	12	1	36	0	624	465	0	0	2	2	0	0	0	36	60	

[N] NOT A SEPARATE PAY ITEM, FOR INFORMATION ONLY.

THIS SHEET ACCURATE FOR DRAINAGE WORK ONLY

DRAINAGE QUANTITIES SCALE: NONE CU #### EA 03-0E961

CHECKED: JN DATE: 1/28/2025 1/28/2025 DATE: ROAD NUMBER:



COUNTY OF EL DORADO DEPARTMENT OF TRANSPORTATION

DIAMOND SPRINGS PARKWAY PHASE 1B

SHEET DQ-1 82 of 136 72334

SYSTEM No. SHEET No.	DRAINAGE UNIT	48" SDMH	DI (TYPE GO)	DI (TYPE OCPI)	12" RCP	12" PP	18" PP	24" PP	36" PP	60" RCP	12" FES	18" FES	24" FES	36" FES	HEADWALL	RSP (BACKING No. 1, METHOD B)	RSP FABRIC (CLASS 8)	NOTES
	UNII	(EA)	(EA)	(EA)	(LF)	(LF)	(LF)	(LF)	(LF)	(LF)	(EA)	(EA)	(EA)	(EA)	(EA)	(CY)	(SY)	
	а															10.00	16.67	
	b													1				
	С								54									
	d			1														
	е															10.00	16.67	
	f								12									
	g		1															
8 D-8	h								35									
	i	1																
	i								35									
	k		1															-
	1								54									
	m								-					1				
	n															10.00	16.67	
	a							139								10100		
9 D-9	b							196										
	C	1						100										
	a	'	1															
	b		'				35											
10	C						35											
	d		1				33											
D-10	a		'													6.67	11.11	
D-10	a			1												0.07	11.11	
11	C			'				144					-					
''	d							144					1					
	e												'			10.00	16.67	
	a		1													10.00	10.07	
			'				41											
12	b c	1					41						+					
14	d						41		-				-					
			1				41						-					
D 44	e		1													10.00	16.67	
D-11	a b														1	10.00	10.07	
										109			-		1			
13	С								-	154			+					
	d									154			-		1			
	е												-		1	40.00	40.07	
	f												-			10.00	16.67	
	a		1															
14 D-12	b						73						-					
our ele esses	C		1					4	4						_		44:	
SUB-BID QUAN	HITY	3	8	2	0	0	225	479	190	263	0	0	1	2	2	67	111	

[N] NOT A SEPARATE PAY ITEM, FOR INFORMATION ONLY.

DRAINAGE QUANTITIES SCALE: NONE THIS SHEET ACCURATE FOR DRAINAGE WORK ONLY CU #### EA 03-0E961

CHECKED: JN COUNTY OF EL DORADO DATE: 1/28/2025 DEPARTMENT OF TRANSPORTATION 1/28/2025 DATE: ROAD NUMBER:



DIAMOND SPRINGS PARKWAY PHASE 1B

SHEET DQ-2 83 of 136 72334

SYSTEM No.	SHEET No.	DRAINAGE UNIT	48" SDMH	DI (TYPE GO)	DI (TYPE OCPI)	12" RCP	12" PP	18" PP	24" PP	36" PP	60" RCP	12" FES	18" FES	24" FES	36" FES	HEADWALL	RSP (BACKING No. 1, METHOD B)	RSP FABRIC (CLASS 8)	NOTES
		ONIT	(EA)	(EA)	(EA)	(LF)	(LF)	(LF)	(LF)	(LF)	(LF)	(EA)	(EA)	(EA)	(EA)	(EA)	(CY)	(SY)	
		а															6.67	11.11	
		b	1																
		С							7										
		d		1															
15		е							15										
		f	1																
		g							15										
		h		1															
		i i							12										
		j																	Existing 60" SDMH
		а		1															
		b						18											
16	D-13	С	1																
		d						37											
		е	1																
		a															6.67	11.11	
		b	1					ļ											
		С						21											
17		d		1				10											
		e						12											
	_{5.44}	f		4				12											
	D-14	g		1															
		a		1			07			1									
		b		4			27												
18		c d		1			9												
							9					4							
		e f										1					2.33	3.89	
19	D-15	b						244									2.33	3.09	
19	D-10	a a						244											Existing 48" SDMH
20	D-16	a b							82										Laisting 40 SDIVII I
20	5-10	C							215										
		a		1	+				210										
21	D-18	a b		'	1			44											
۷۱	5-10	С		1															
		a	1	1															
	-	a b	1					109											
22	D-17	C		1				103											
	-11	d		'				362											
	-	e		1				302											
		a e		1				58											
23	D-18	a b		1				30											
SIII	B-BID QUANT		6	12	0	0	36	917	346	0	0	1	0	0	0	0	16	26	
501	D-DID QUAN I	111.1	0	12	U	U	30	917	340	0	U	T T	U	U	0	0	10	20	

[N] NOT A SEPARATE PAY ITEM, FOR INFORMATION ONLY.

THIS SHEET ACCURATE FOR DRAINAGE WORK ONLY

DRAINAGE QUANTITIES SCALE: NONE CU #### EA 03-0E961

REPARED UNDER THE SUPERVISION OF :

DH CHECKED: JN DATE: 1/28/2025 1/28/2025 DATE: ROAD NUMBER:



COUNTY OF EL DORADO DEPARTMENT OF TRANSPORTATION

DIAMOND SPRINGS PARKWAY PHASE 1B

SHEET DQ-3 84 of 136 72334

SYSTEM No.	SHEET No.	DRAINAGE	48" SDMH	DI (TYPE GO)	DI (TYPE OCPI)	12" RCP	12" PP	18" PP	24" PP	36" PP	60" RCP	12" FES	18" FES	24" FES	36" FES	HEADWALL	RSP (BACKING No. 1, METHOD B)	RSP FABRIC (CLASS 8)	NOTES
		UNIT	(EA)	(EA)	(EA)	(LF)	(LF)	(LF)	(LF)	(LF)	(LF)	(EA)	(EA)	(EA)	(EA)	(EA)	(CY)	(SY)	
24	D-18	а						79											
		а															6.67	11.11	
		b	1																
25	D-18	С						9											
		d		1															
		е						73											
		а		1															
		b							185										
26	D-19	С		1															
		d							76										
		е		1															
		а		1															
27	D-20	р						43											
		С																	Existing 48" SDMH
		а															2.33	3.89	
		р										1							
28	D-20	С					35												
		d			1														
		е															6.67	11.11	
		a															6.67	11.11	
29	D-21	b		1															
23	0-21	С					64												
		d						65											·
SU	IB-BID QUAN	TITY	1	6	1	0	99	269	261	0	0	1	0	0	0	0	22	37	·
тот	AL BID QUA	NTITY	13	38	4	36	135	2,035	1,551	190	263	4	2	1	2	2	141	234	

[N] NOT A SEPARATE PAY ITEM, FOR INFORMATION ONLY.

THIS SHEET ACCURATE FOR DRAINAGE WORK ONLY

DRAINAGE QUANTITIES
SCALE: NONE
CU #### EA 03-0E961

NO. OF CONTROL OF CONT

No. C71517

REGISTERED CIVIL ENGINEER

REGISTERED CIVIL ENGINEER

D UNDER THE SUPERVISION OF:

DESIGNED:
DH
AN

CHECKED:
JN
1/28/2025

DATE:

TOAD NUMBER:





COUNTY OF EL DORADO
DEPARTMENT OF TRANSPORTATION


DIAMOND SPRINGS PARKWAY PHASE 1B SHEET DQ-4


85 OF 136


W.O. No. 72334

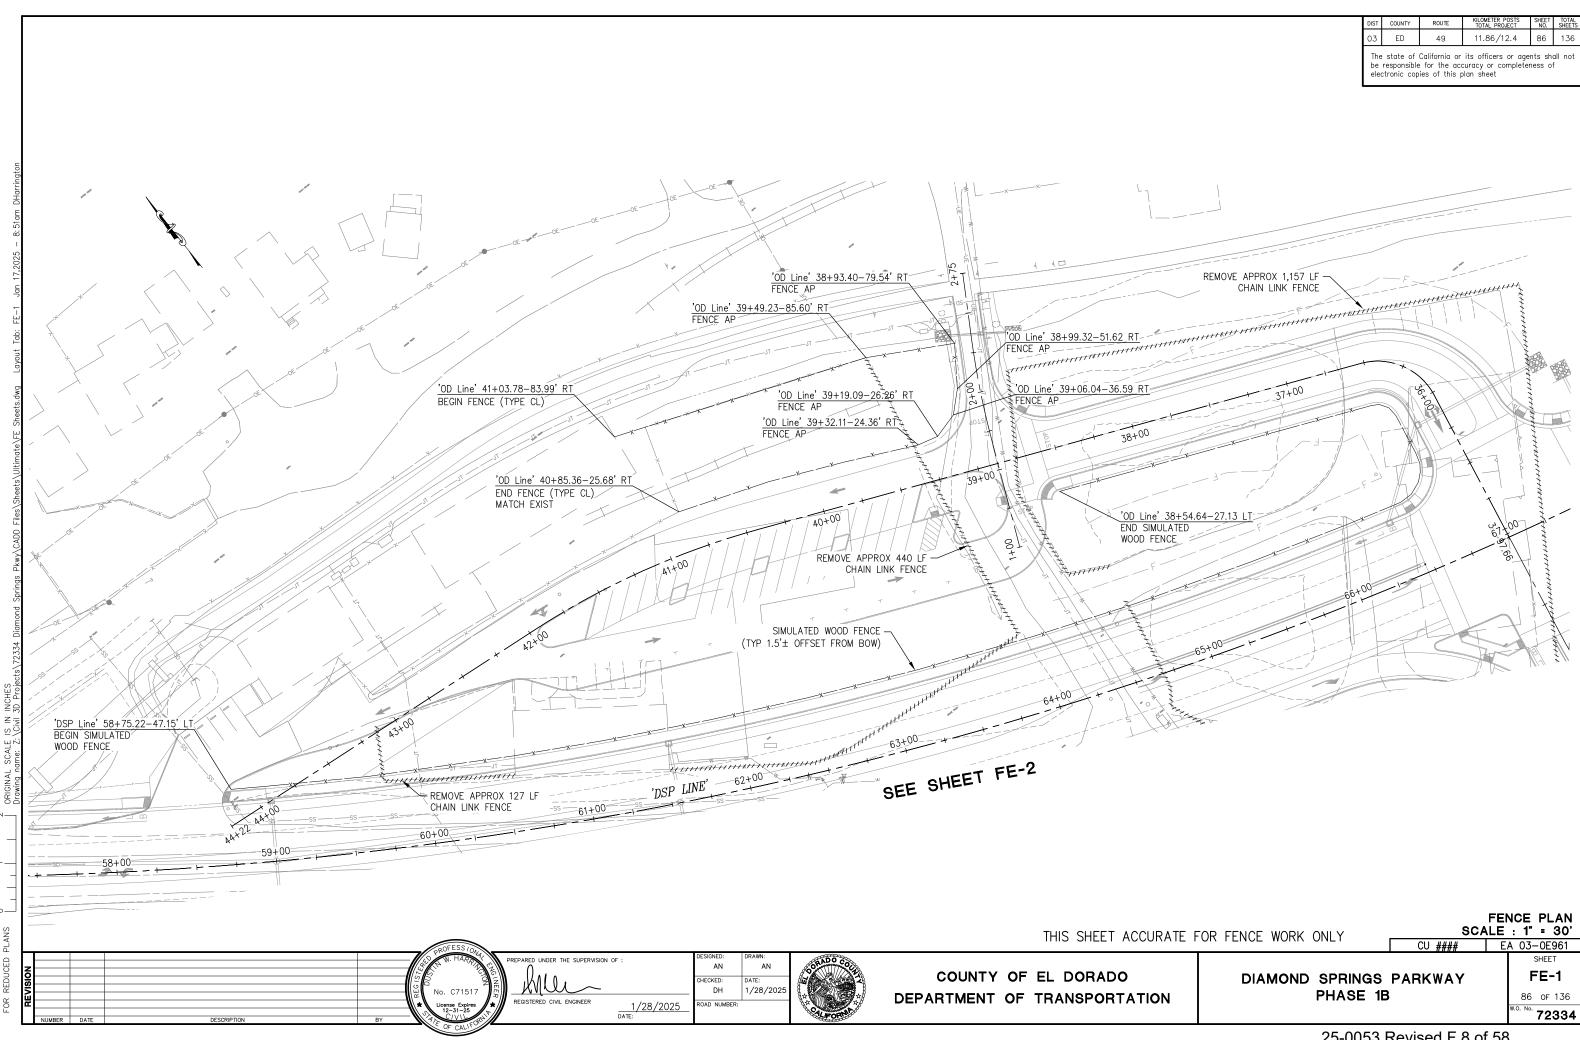


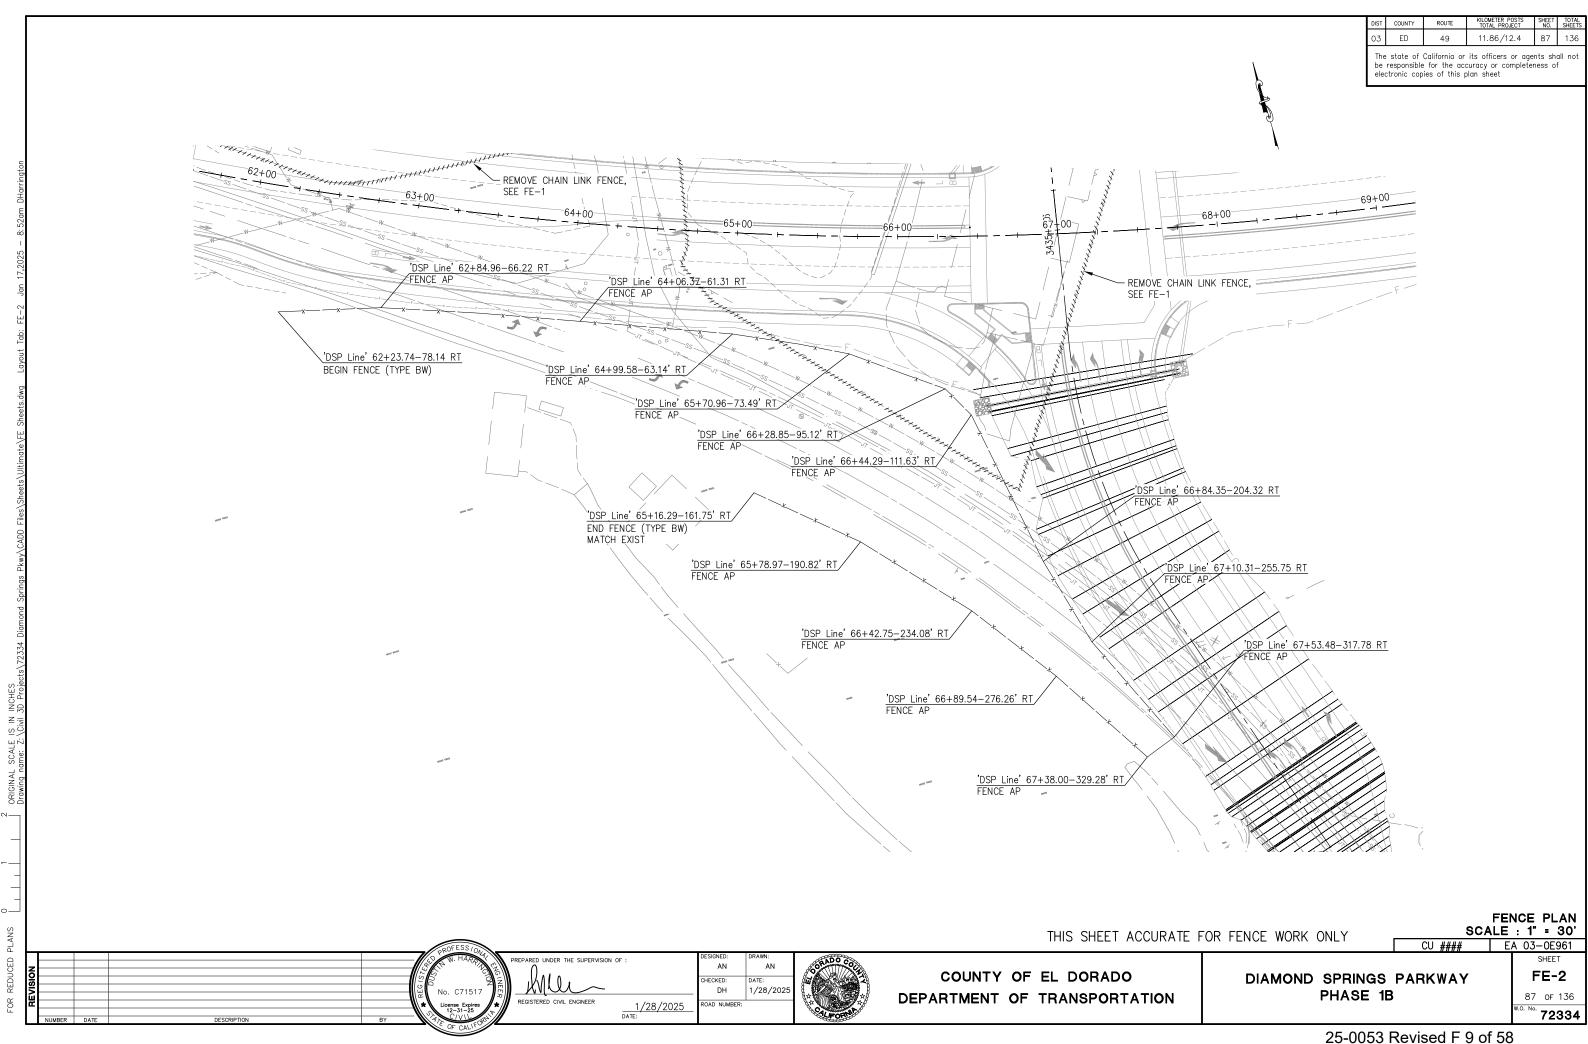


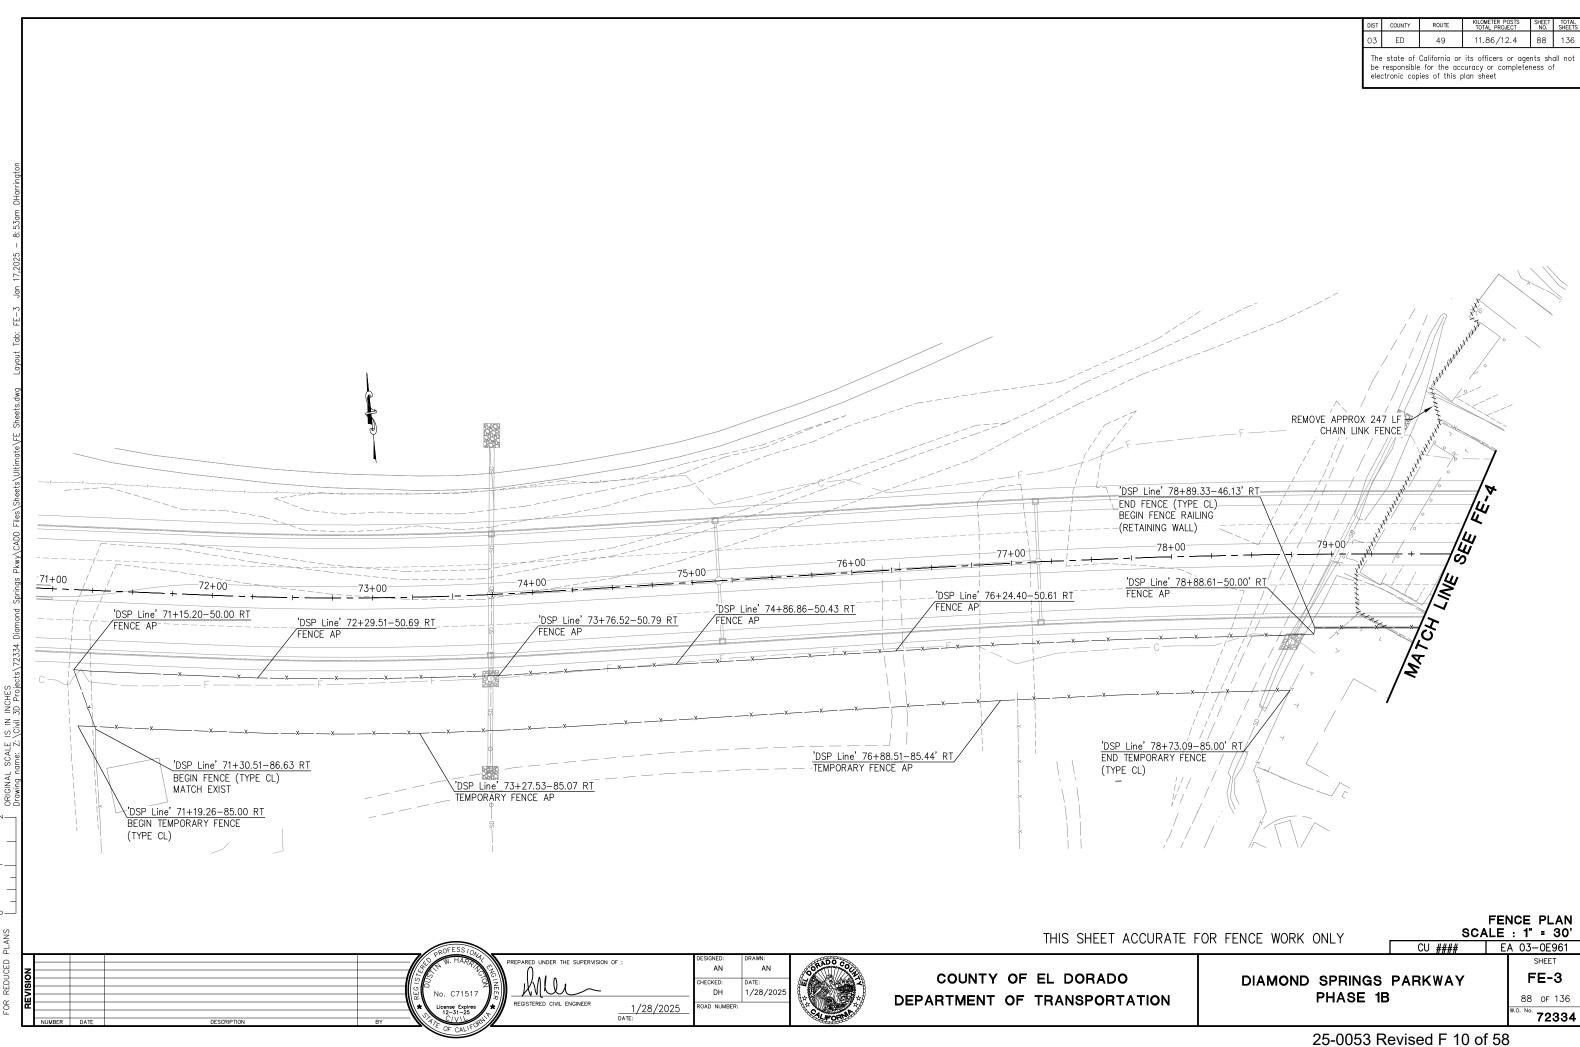


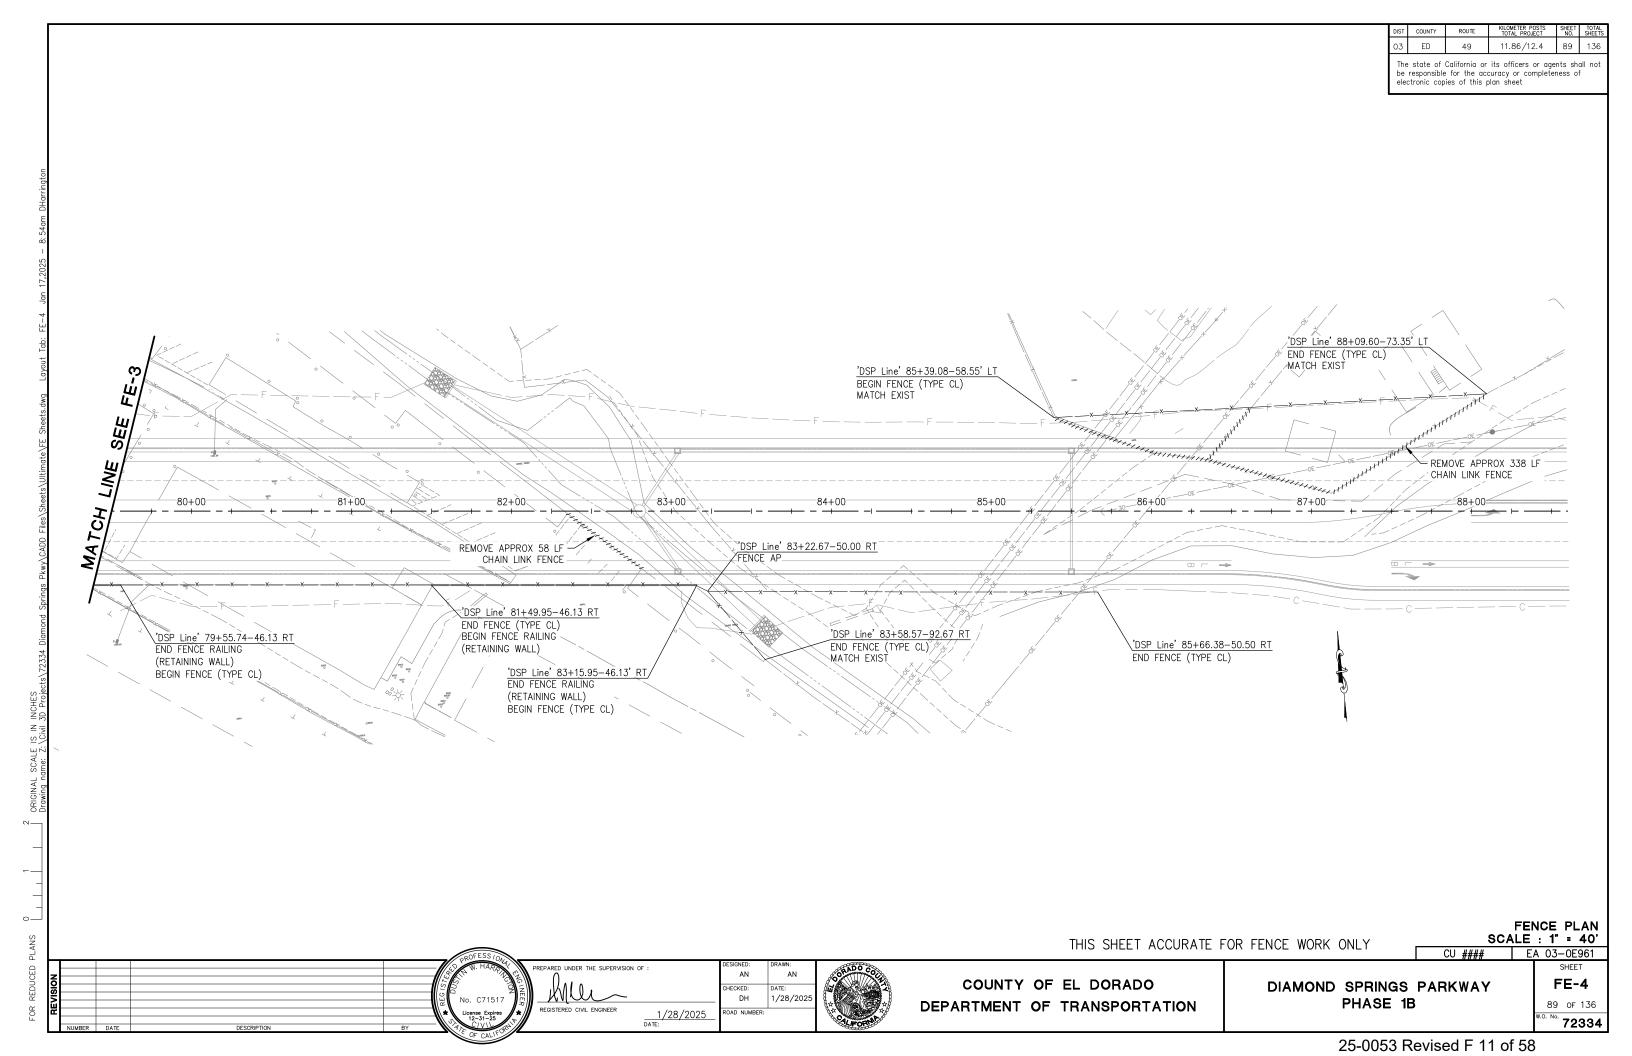


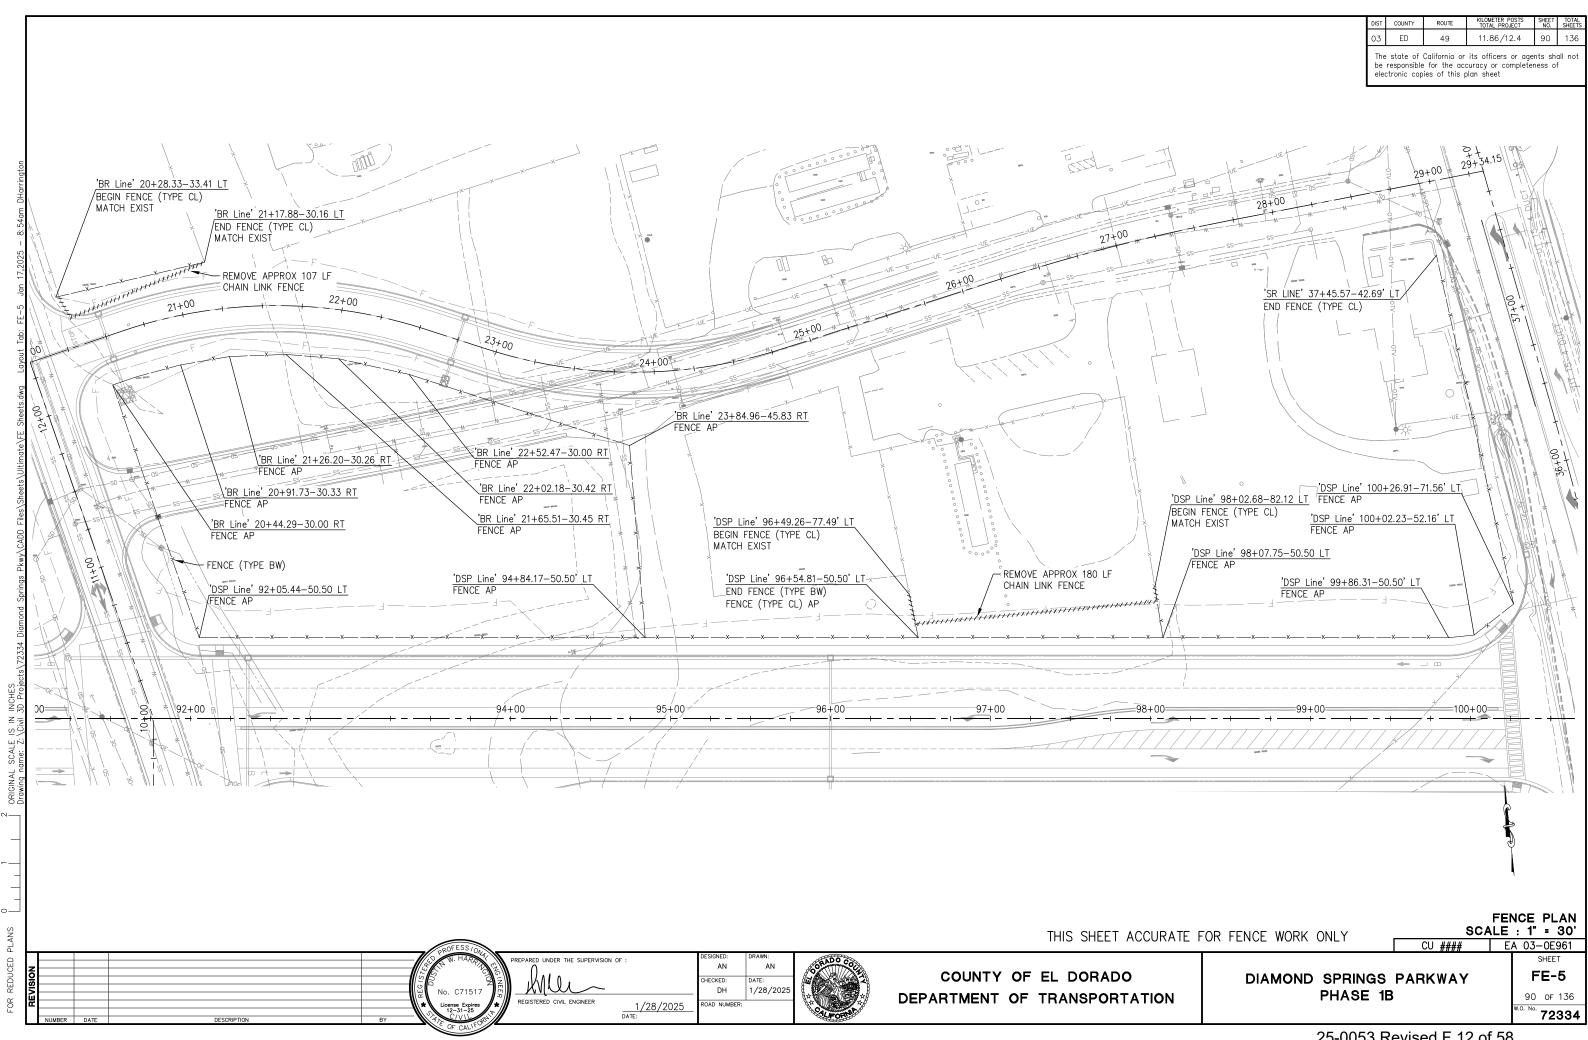


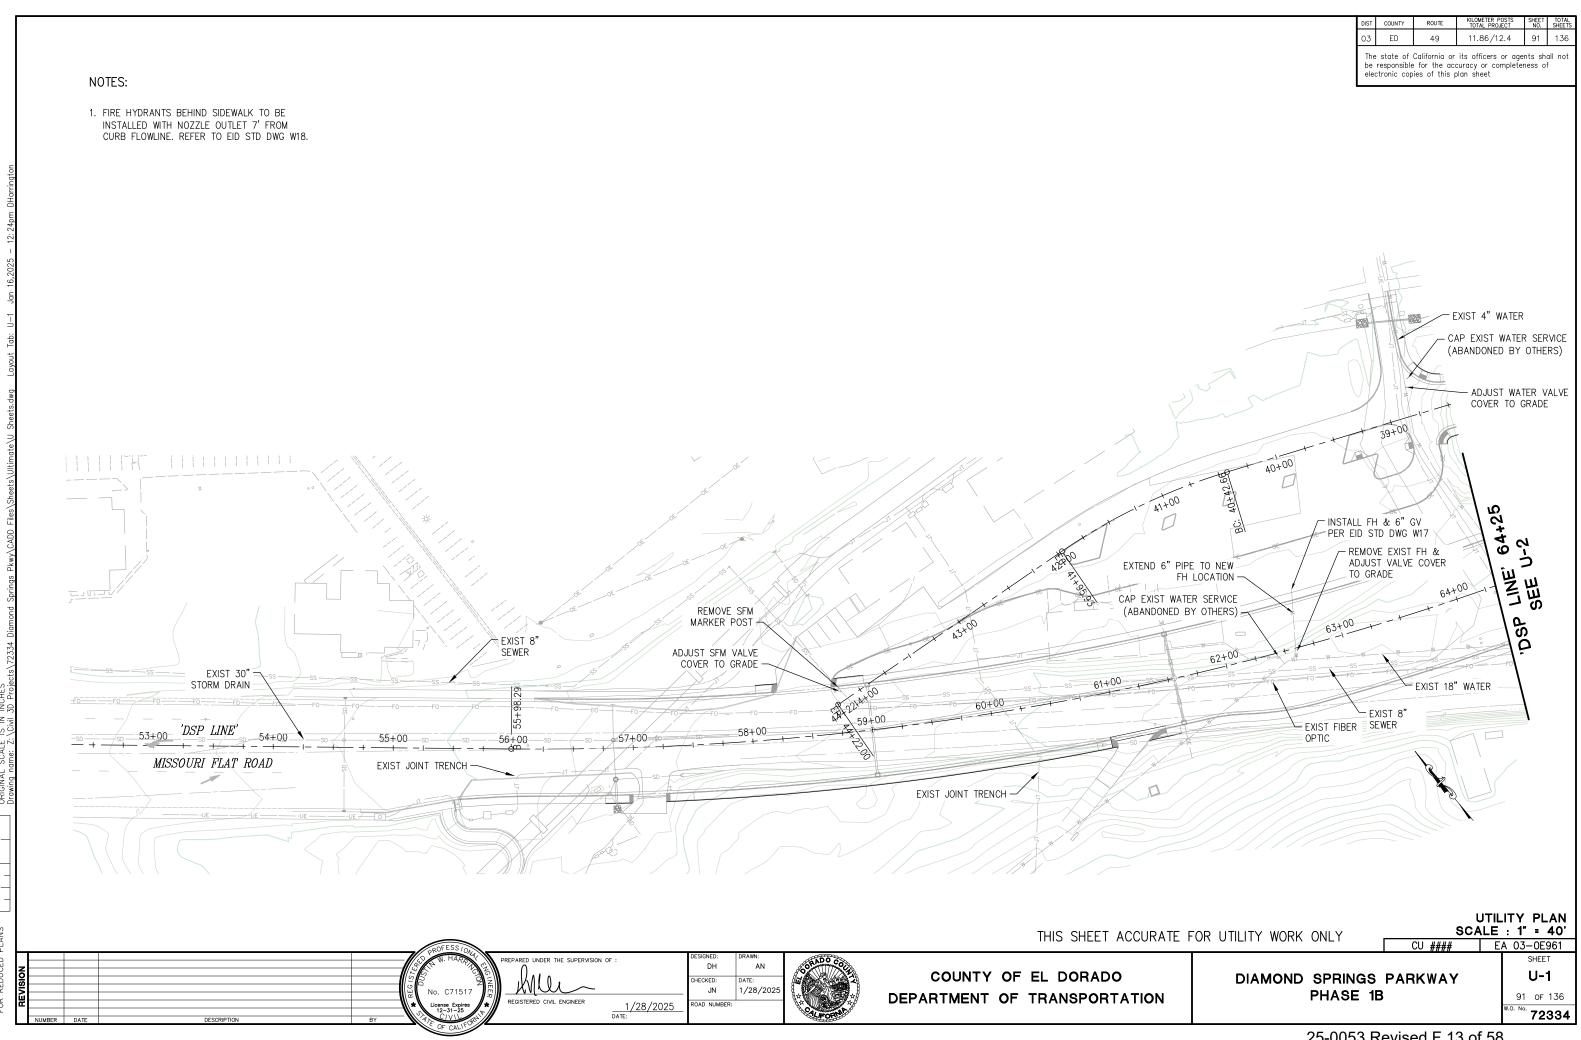

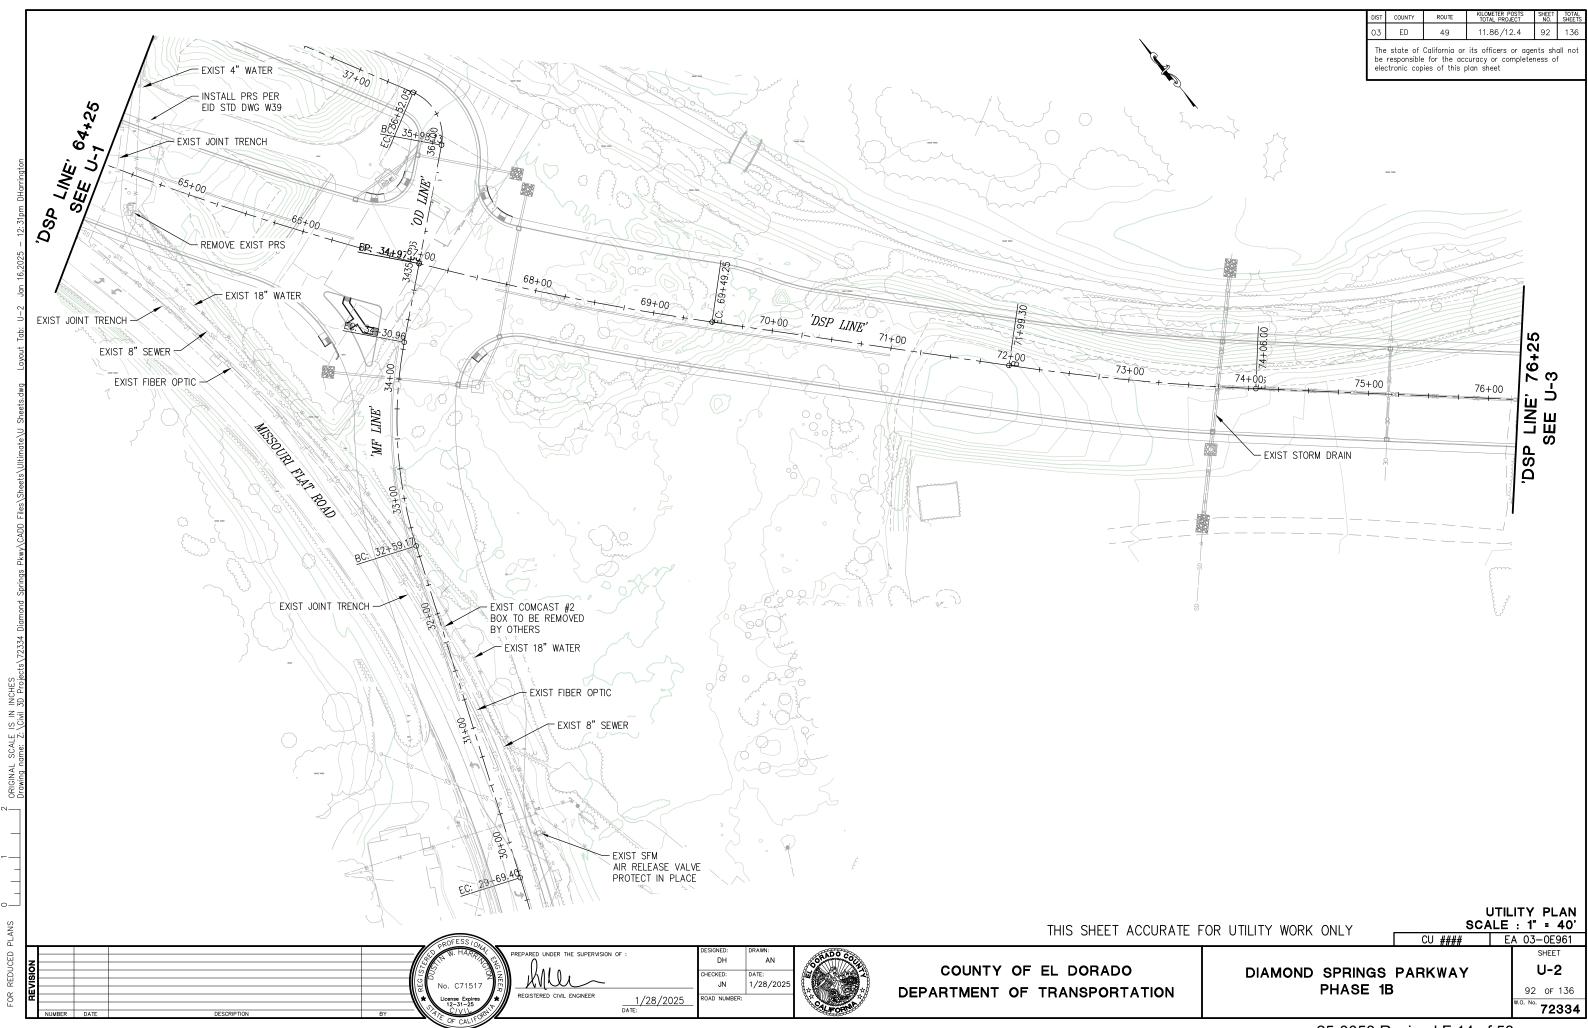

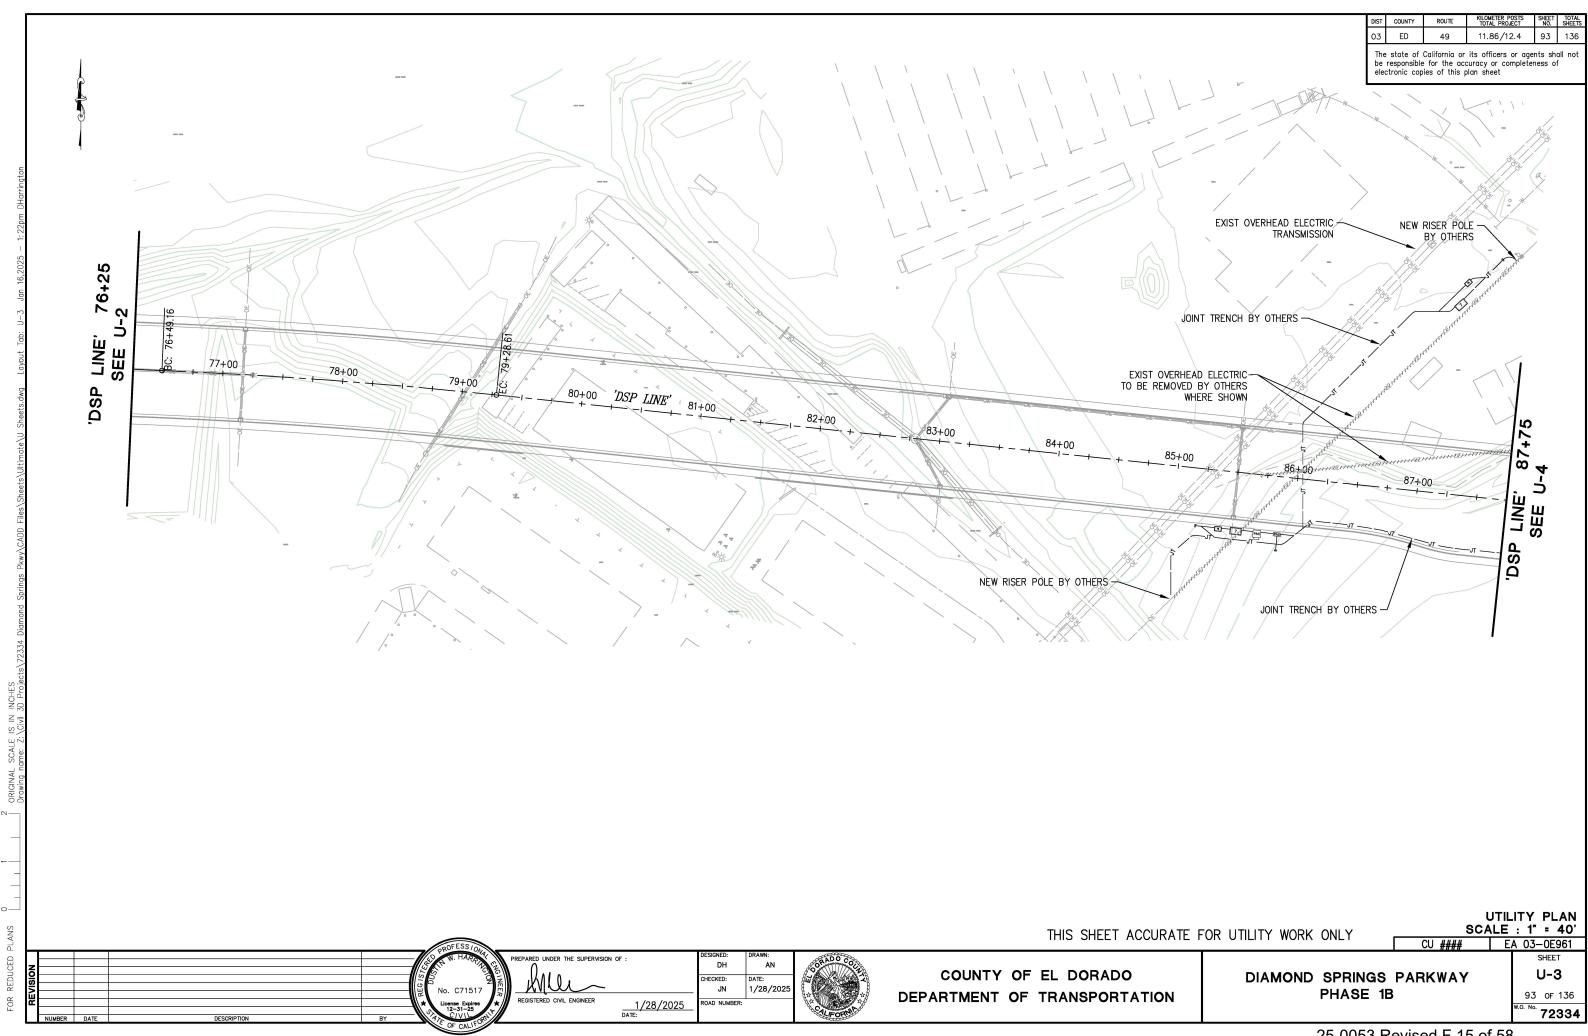

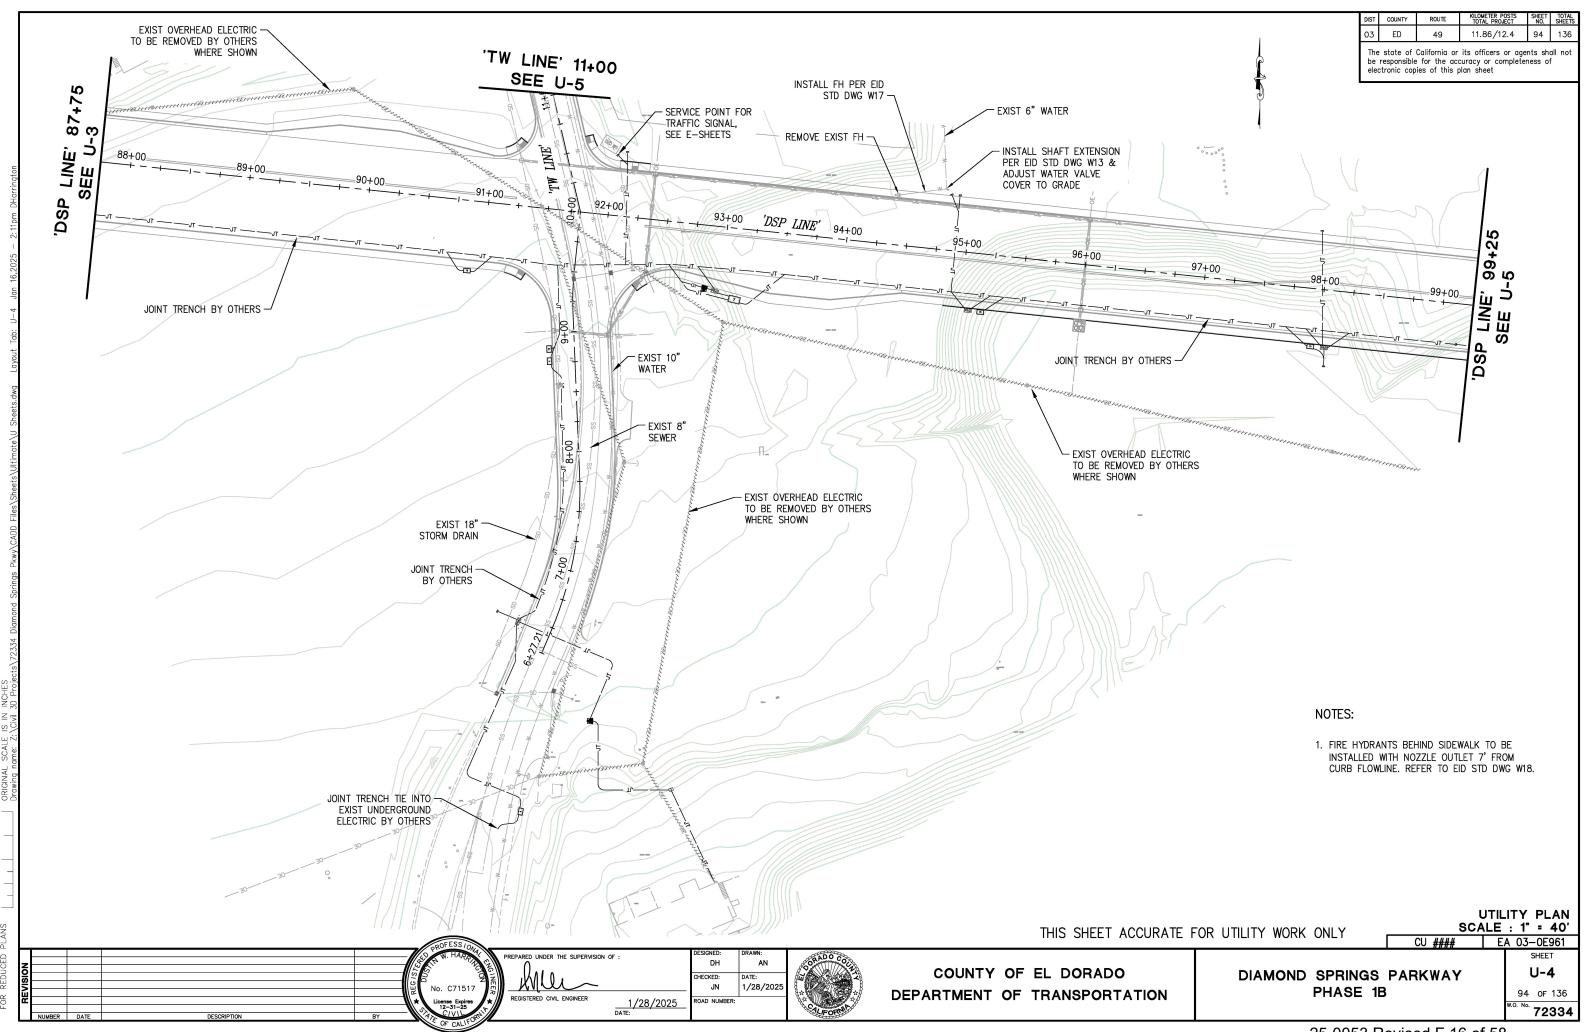

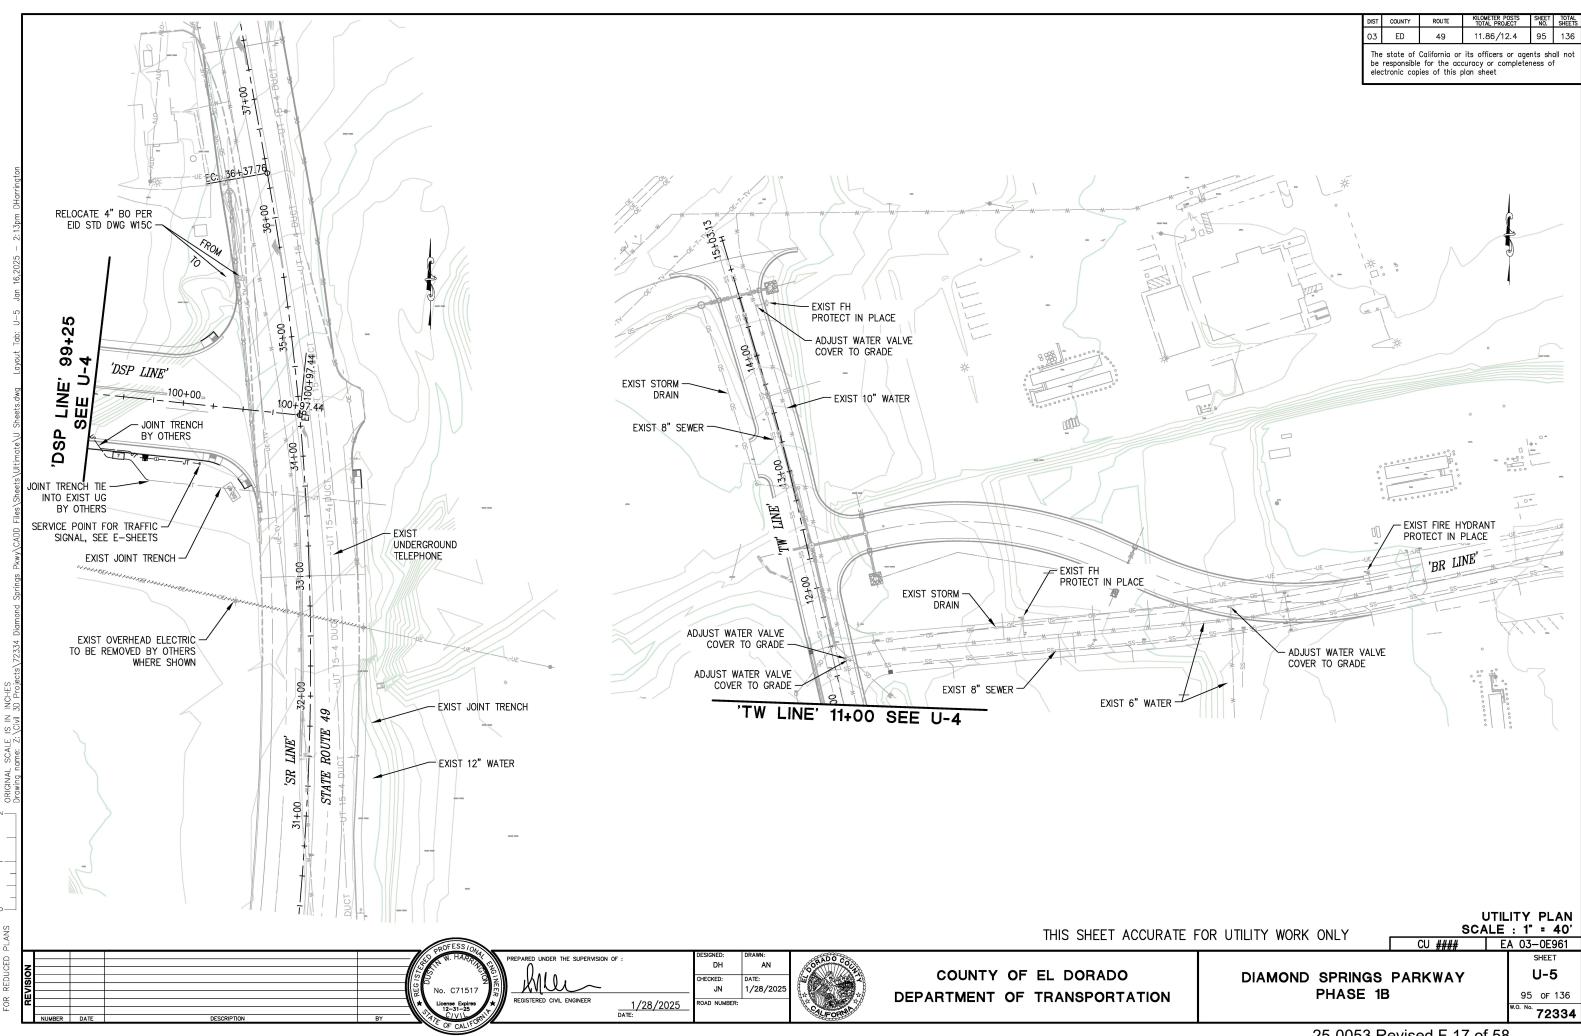

REPARED UNDER THE SUPERVISION OF

No. C71517

JN

1/28/2025 DATE: 1/28/202

SCH. 80 PVC PIPING - COMBINATION ARV

SCH. 80 PVC PIPING - AIR RELEASE VALVE

 ST
 COUNTY
 ROUTE
 KILOMETER POSTS TOTAL PROJECT
 SHEET NO. SHEETS

 3
 ED
 49
 11.86/12.4
 96
 136

The state of California or its officers or agents shall not be responsible for the accuracy or completeness of electronic copies of this plan sheet

UTILITY DETAILS
SCALE : NONE
| EA 03-0E961

COUNTY OF EL DORADO DIAMO

3 / 16 8 11/8/21

DATE

4/22/20 5/5/20

THIS SHEET ACCURATE FOR UTILITY WORK ONLY

KRD

CALE NONE

DRAWN BY L.A. NOTARO


DEPARTMENT OF TRANSPORTATION


DIAMOND SPRINGS PARKWAY PHASE 1B


LEID STANDARD


W39


U-6 96 of 136 D. No. **72334**

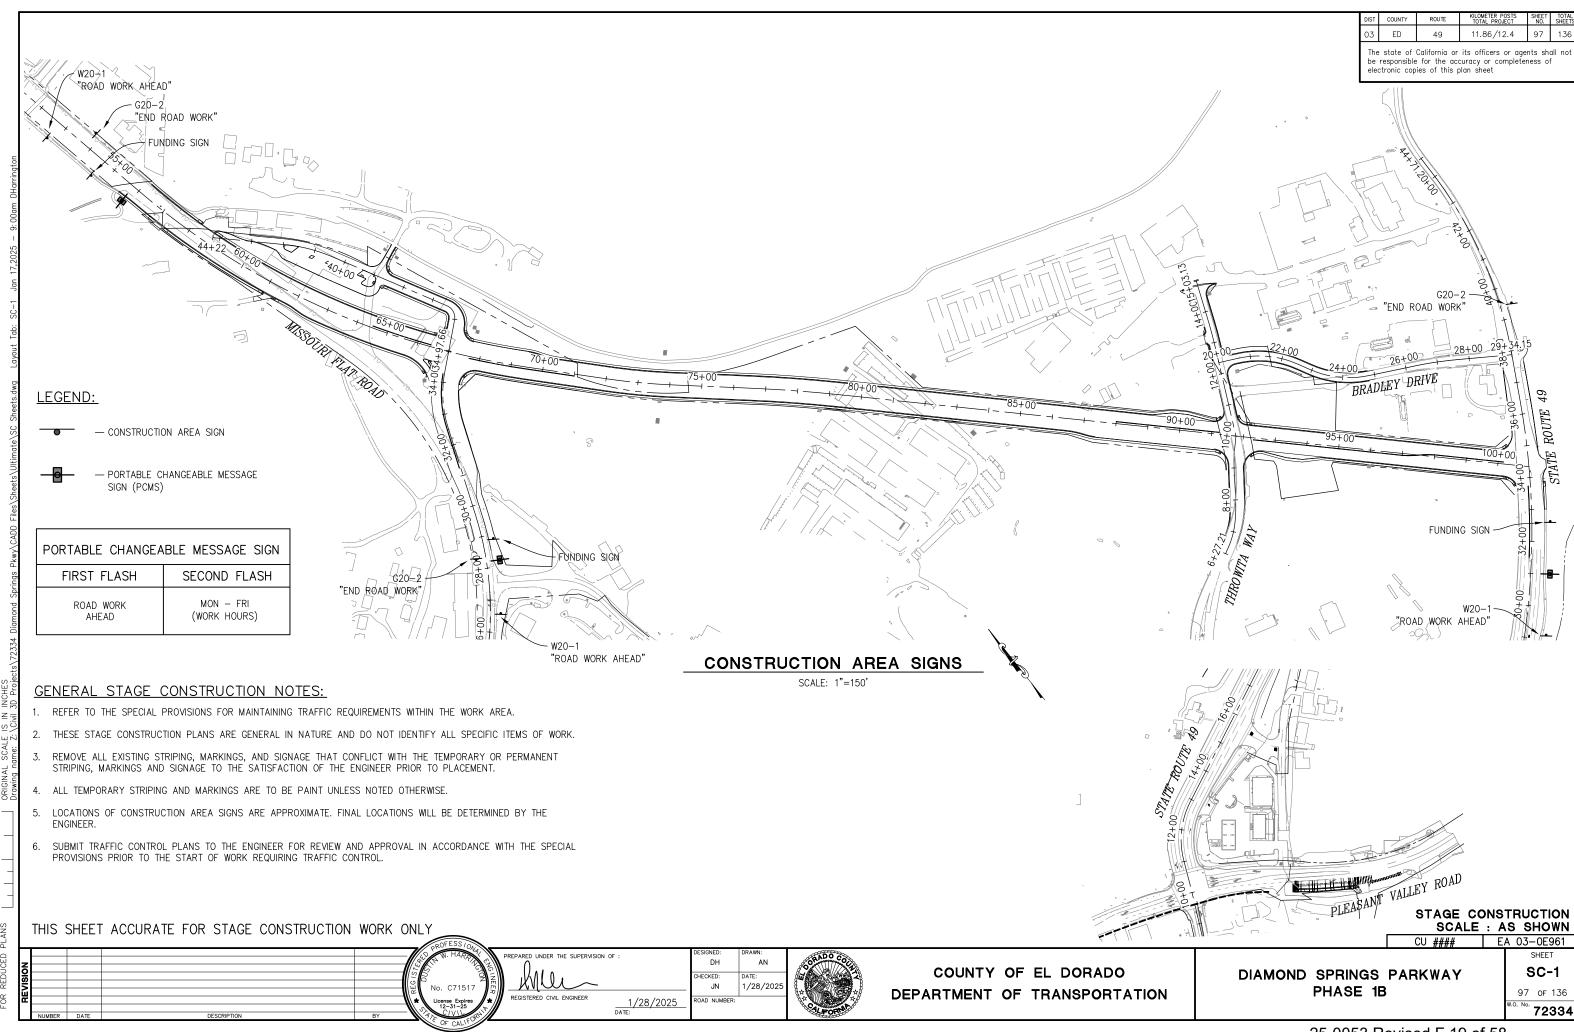


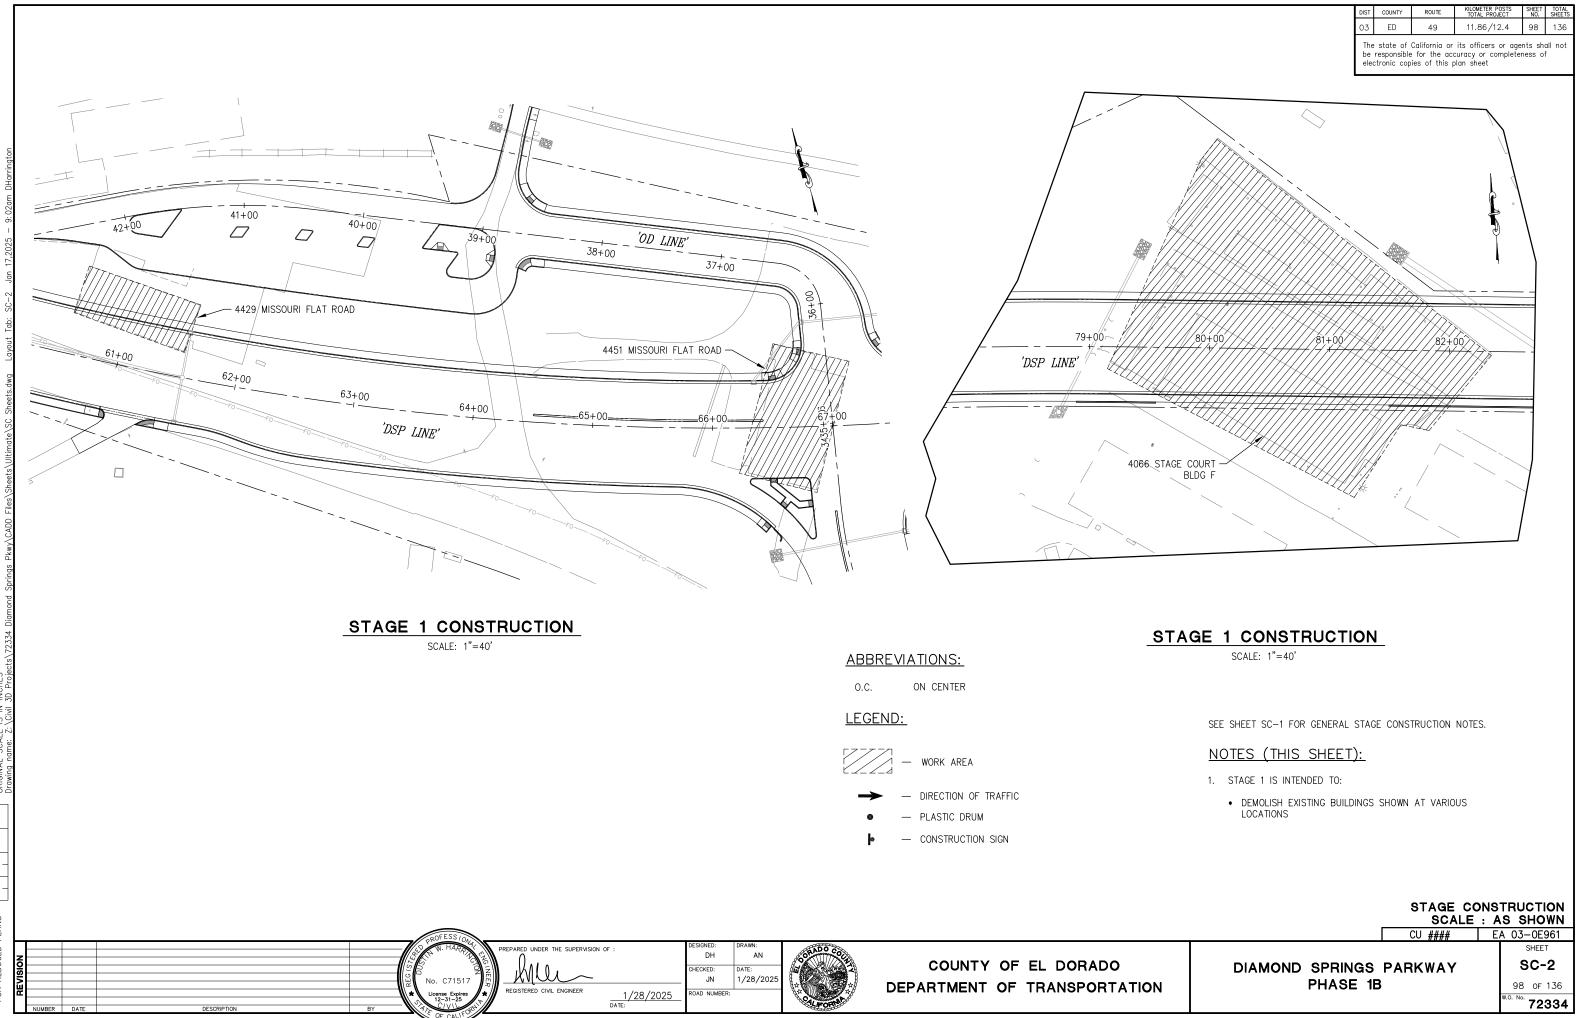


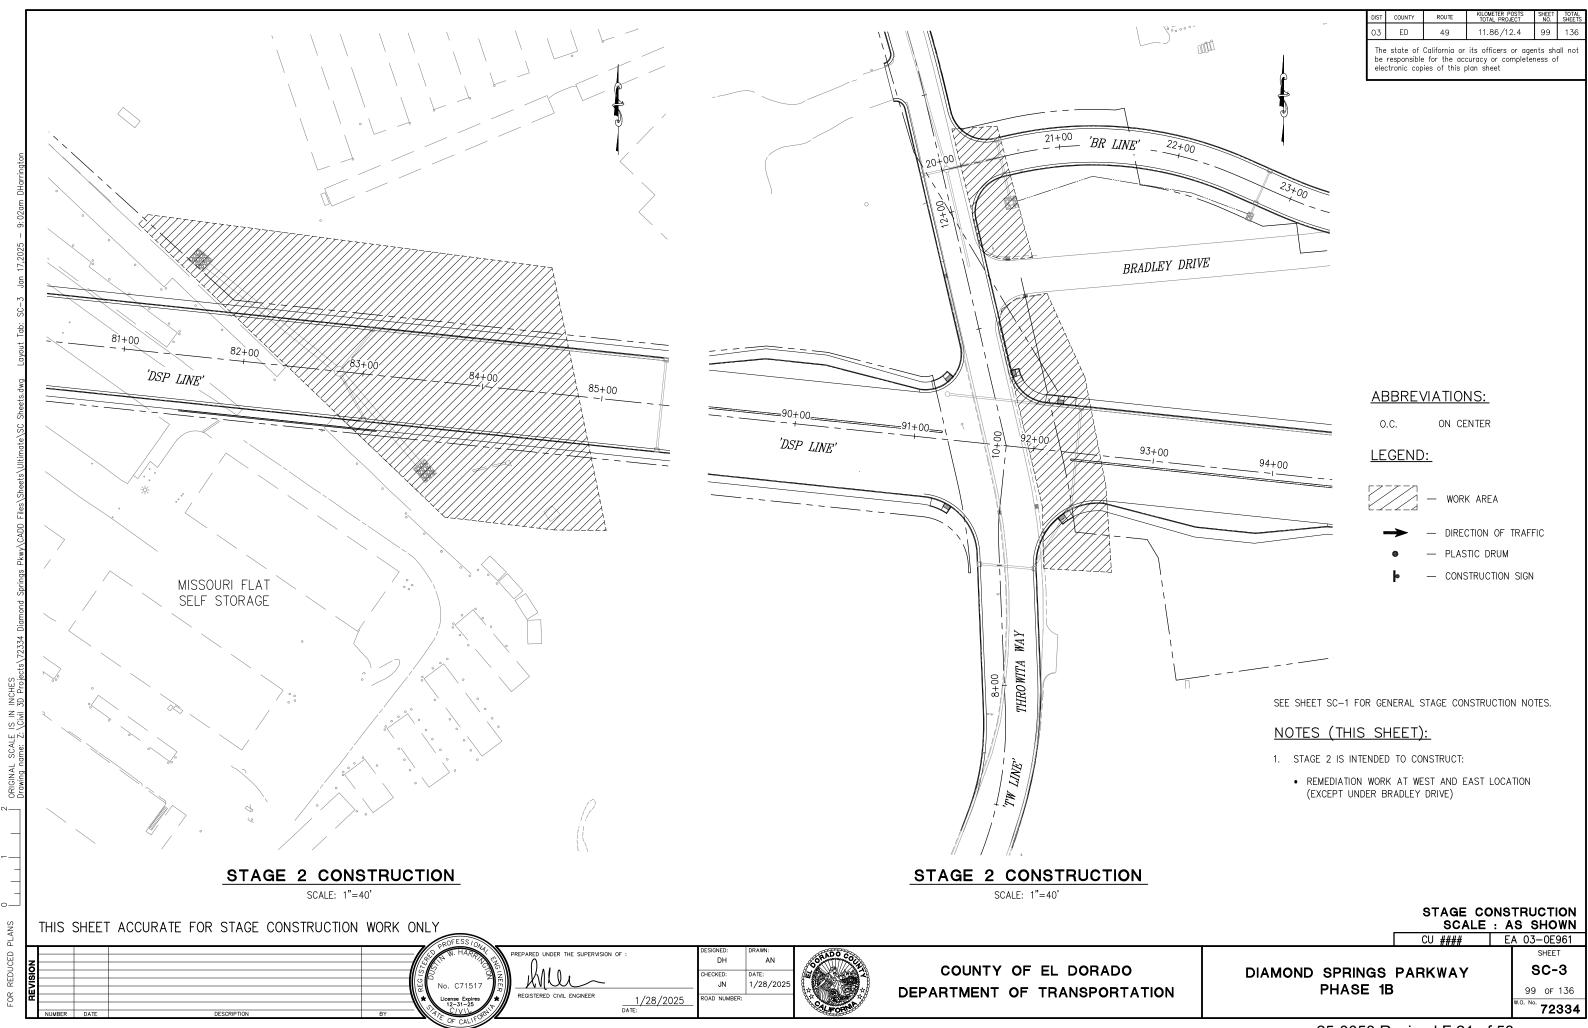

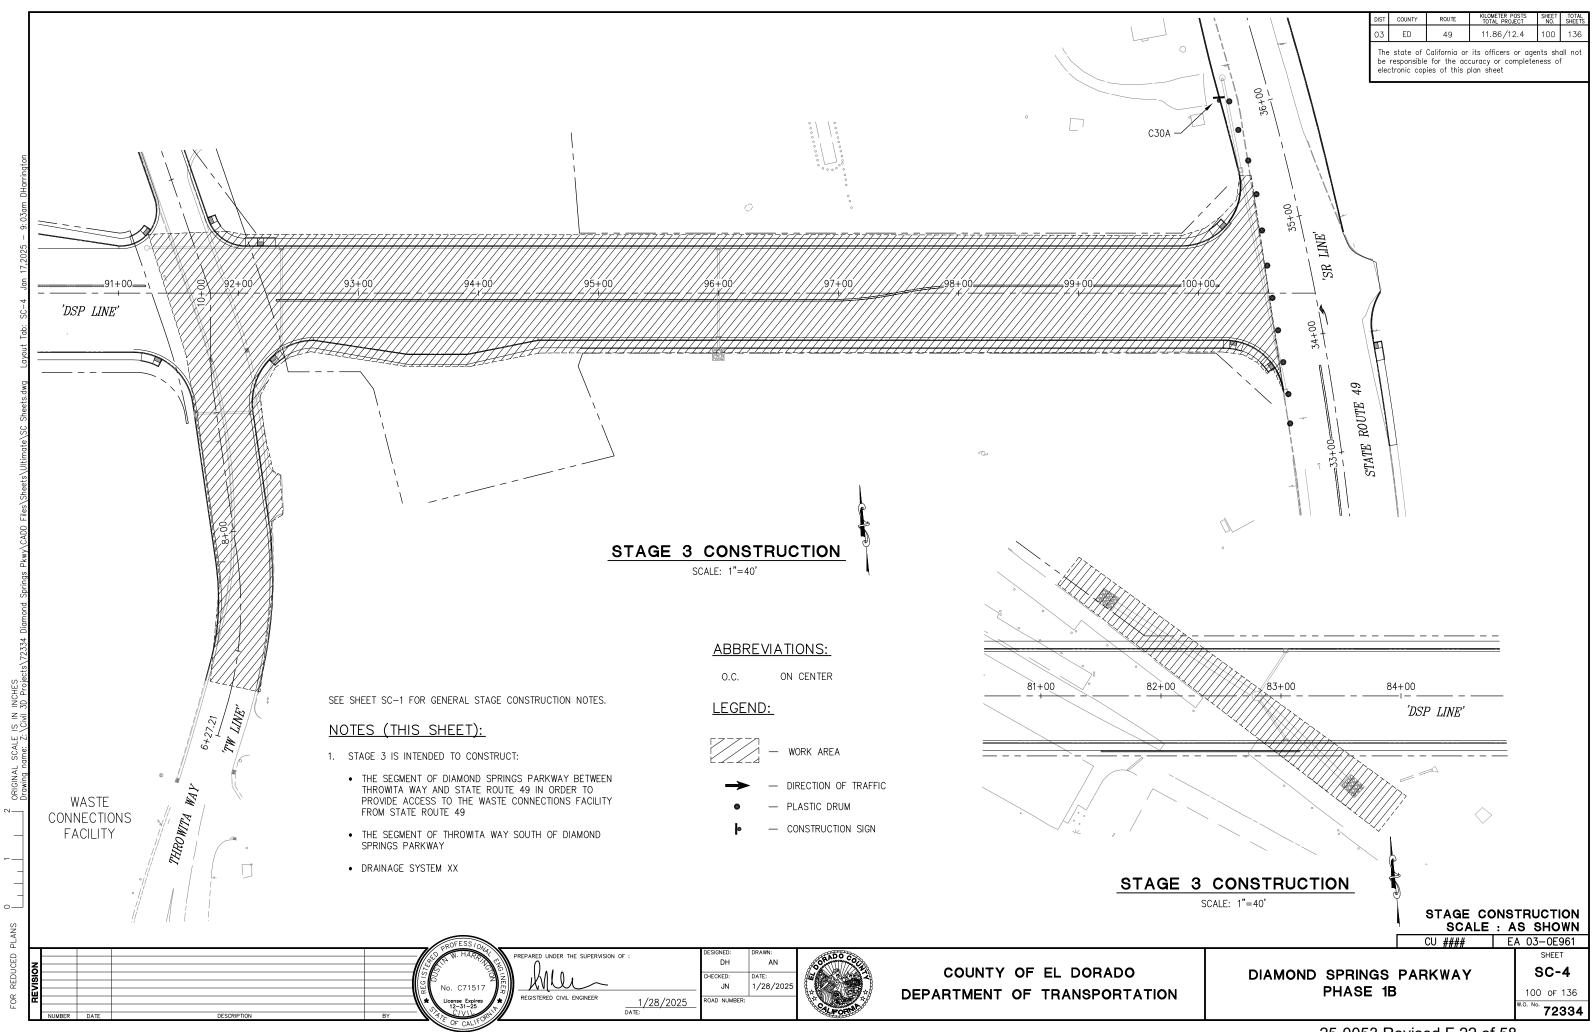

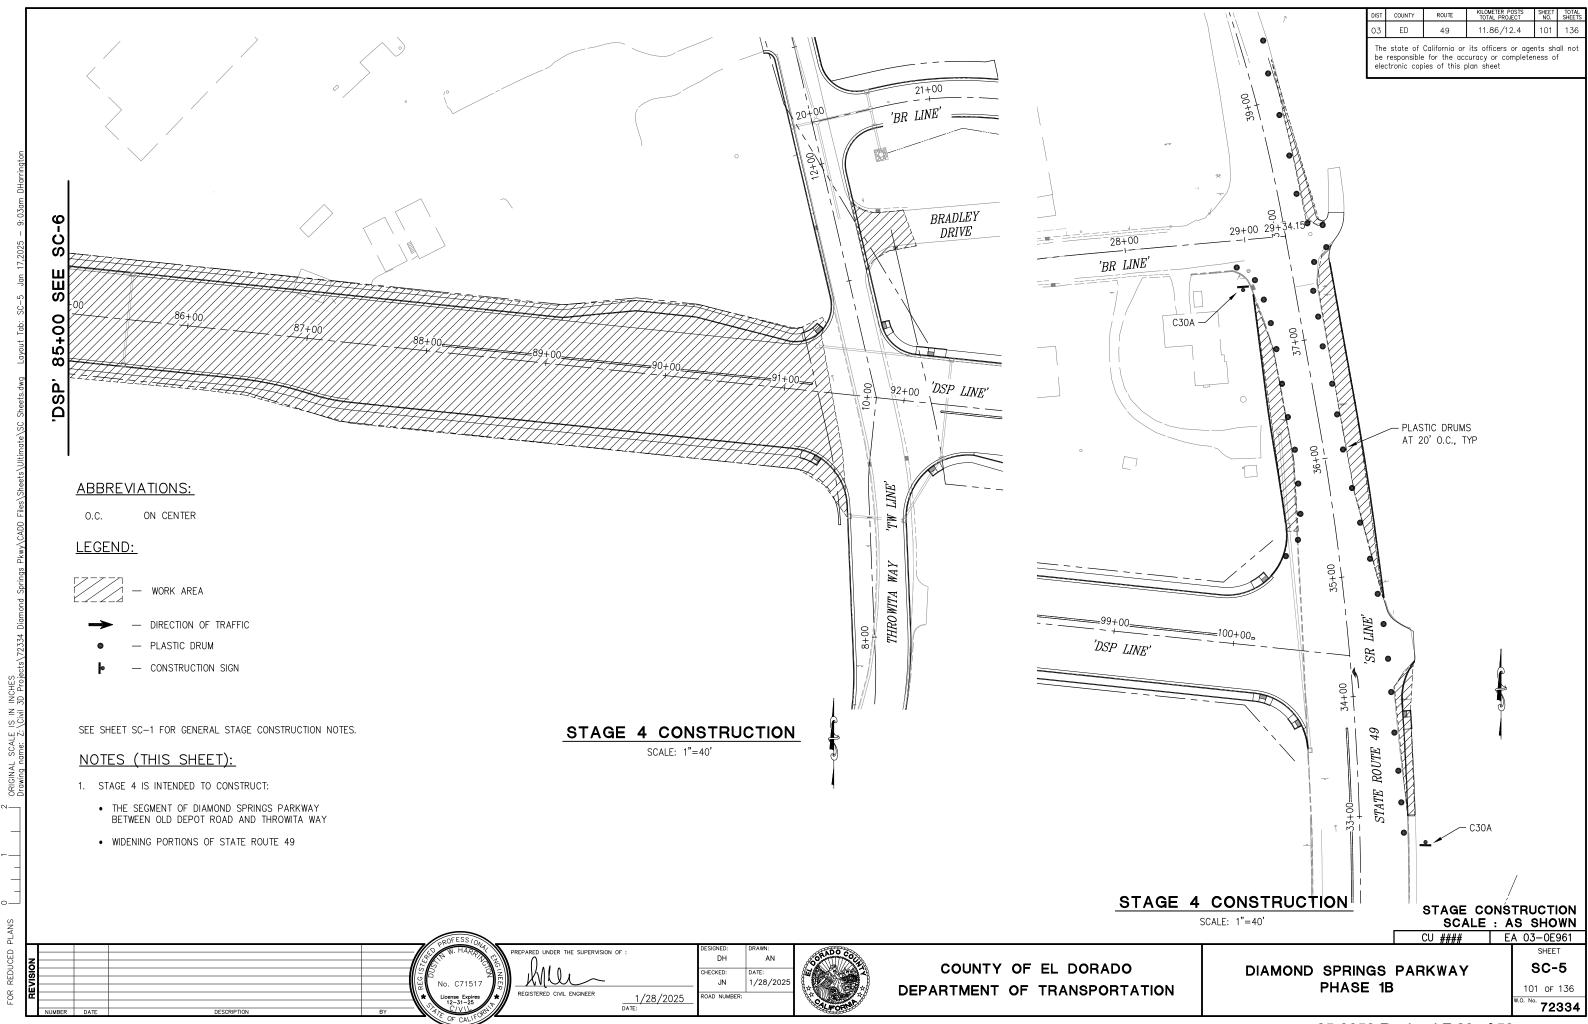

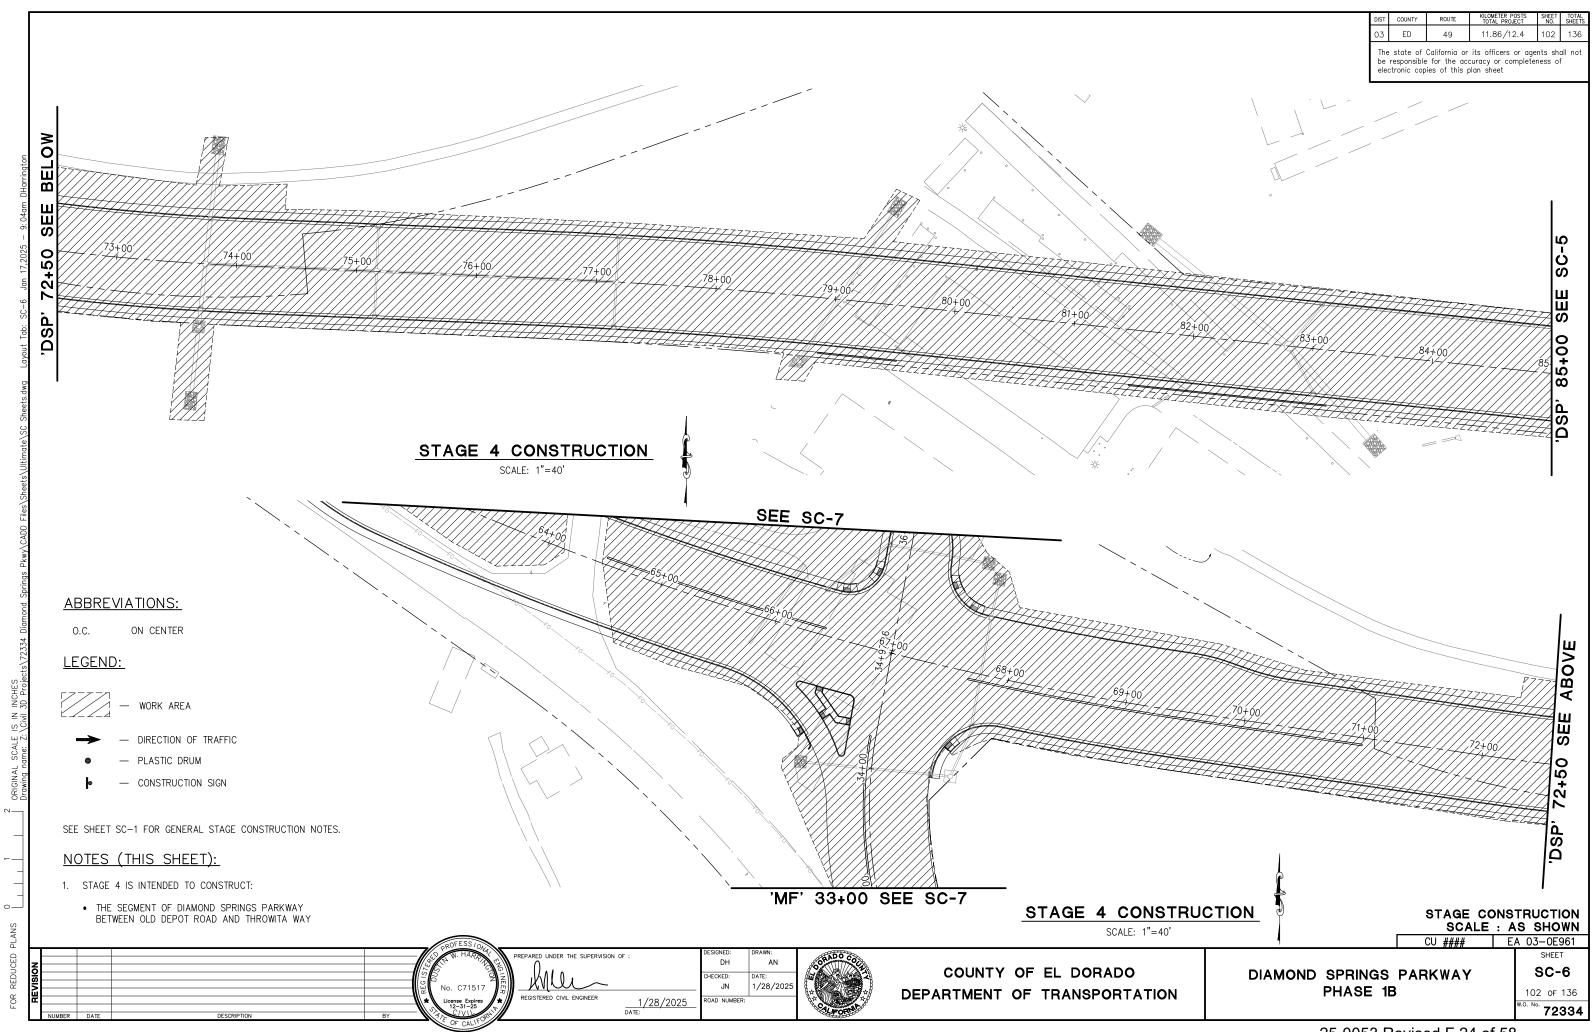

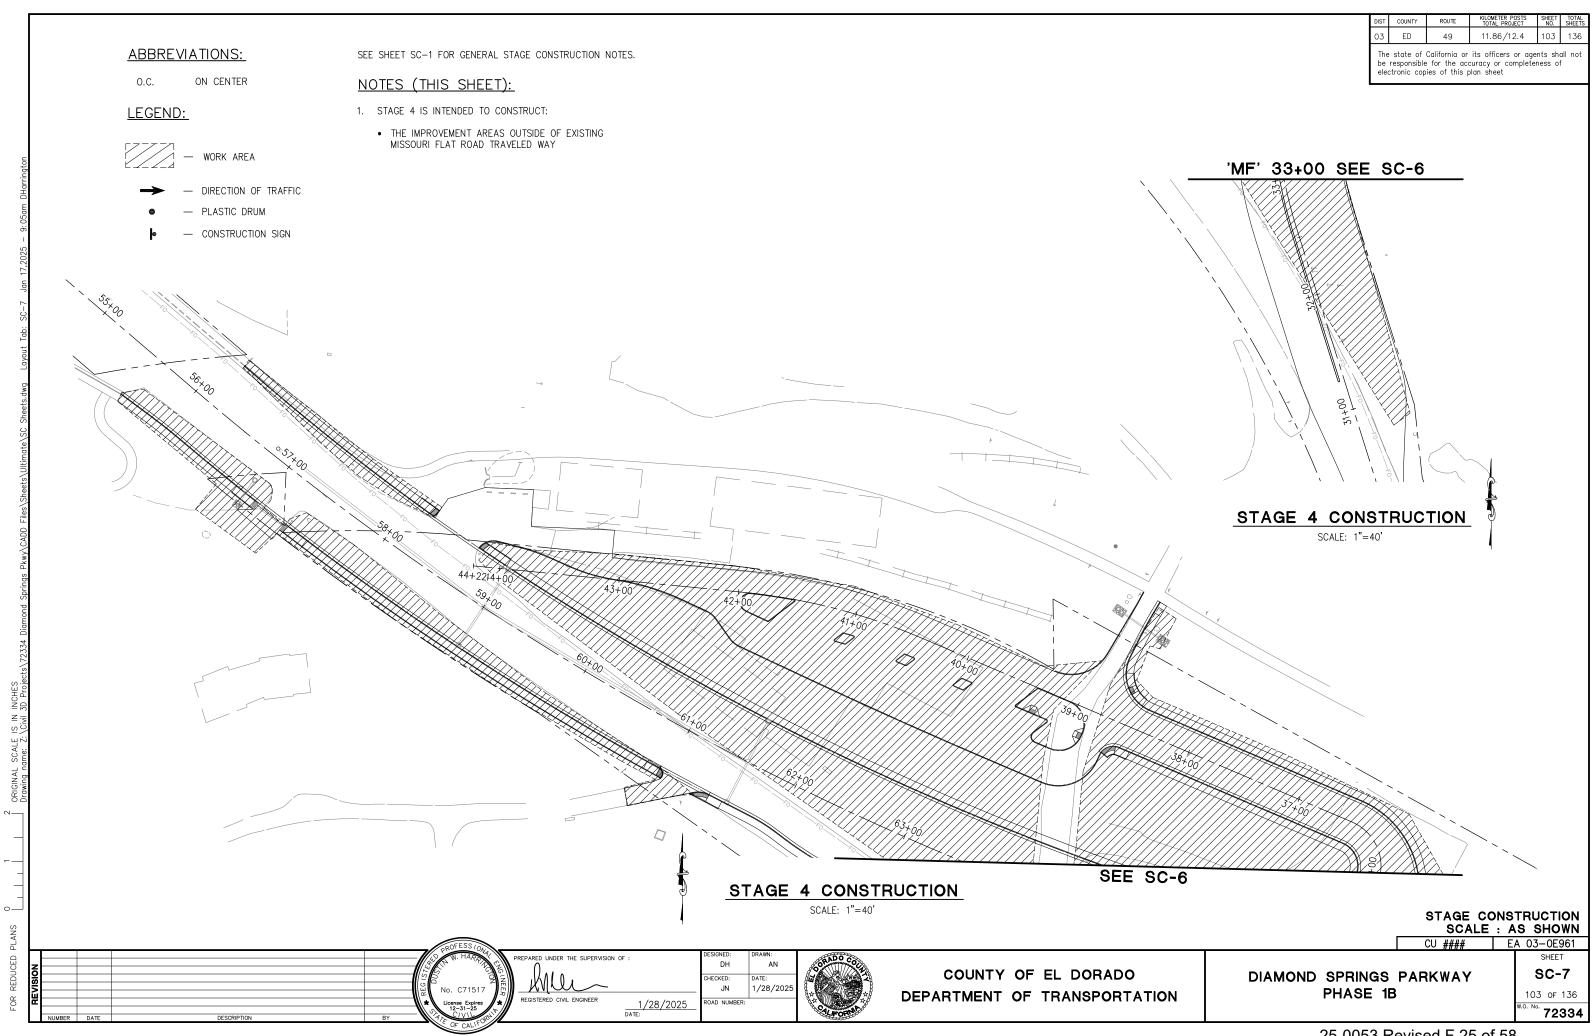

The state of California or its officers or agents shall not be responsible for the accuracy or completeness of electronic copies of this plan sheet Più 8 ABBREVIATIONS: ON CENTER LEGEND: WORK AREA DIRECTION OF TRAFFIC — PLASTIC DRUM CONSTRUCTION SIGN SEE SHEET SC-1 FOR GENERAL STAGE CONSTRUCTION NOTES. NOTES (THIS SHEET): =91+00=\ 1. STAGE 5 IS INTENDED TO CONSTRUCT: 92+00 • THE THROWITA WAY IMPROVEMENTS AND BRADLEY 93+00 DRIVE REALIGNMENT 94+00 95+00 96+00 STAGE 5 CONSTRUCTION

SCALE: 1"=40'

HECKED:

1/28/2025 DATE:

JN

1/28/202

COUNTY OF EL DORADO

DEPARTMENT OF TRANSPORTATION


EPARED UNDER THE SUPERVISION OF :

STAGE CONSTRUCTION SCALE : AS SHOWN


CU #### EA 03-0E961 SHEET

DIAMOND SPRINGS PARKWAY PHASE 1B

SC-8 104 of 136 72334

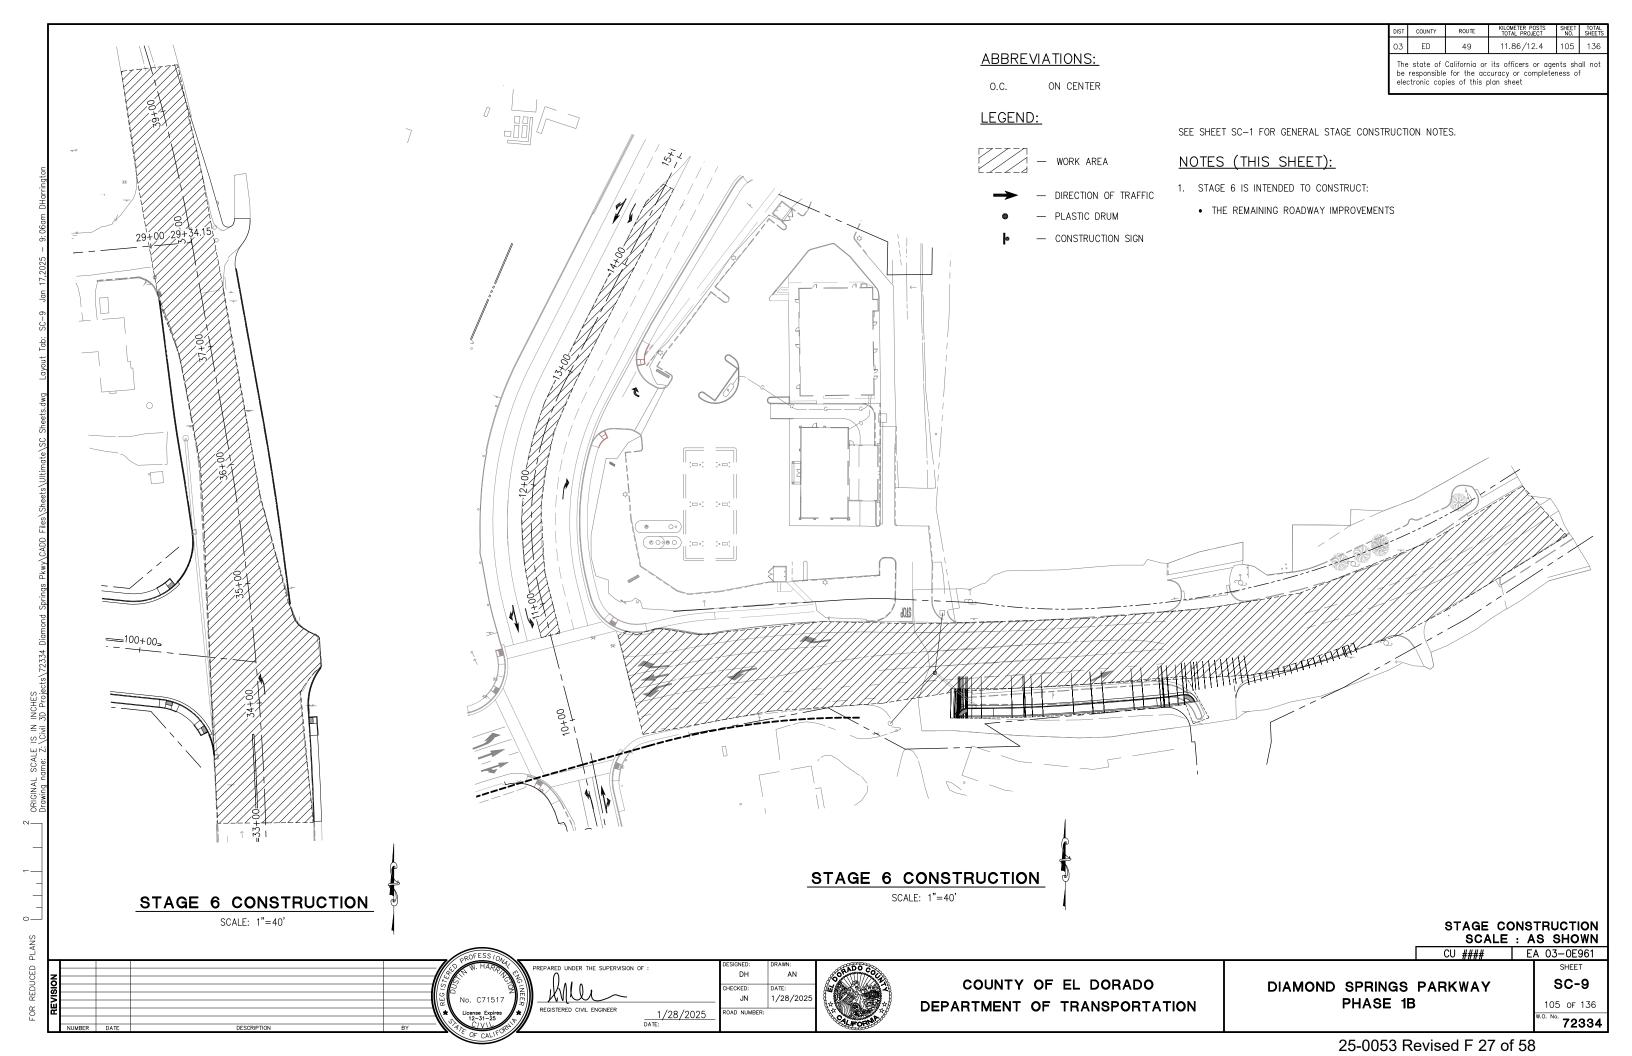

ABBREVIATIONS: The state of California or its officers or agents shall not be responsible for the accuracy or completeness of electronic copies of this plan sheet ON CENTER **LEGEND:** SEE SHEET SC-1 FOR GENERAL STAGE CONSTRUCTION NOTES. - WORK AREA NOTES (THIS SHEET): 1. STAGE 6 IS INTENDED TO CONSTRUCT: - DIRECTION OF TRAFFIC - PLASTIC DRUM • THE REMAINING ROADWAY IMPROVEMENTS CONSTRUCTION SIGN STAGE 6 CONSTRUCTION SCALE: 1"=60' STAGE CONSTRUCTION SCALE : AS SHOWN CU #### EA 03-0E961 EPARED UNDER THE SUPERVISION OF COUNTY OF EL DORADO SC-10 DIAMOND SPRINGS PARKWAY HECKED: 1/28/202 JN PHASE 1B 106 of 136 DEPARTMENT OF TRANSPORTATION 1/28/2025 DATE: 72334

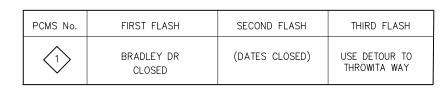

SIGN LEGEND

1 R11-2 "ROAD CLOSED"

② M4-10 "DETOUR" (ARROW)

(3) "ROAD CLOSED TO THRU TRAFFIC"

4 "TO THROWITA WAY"

CLOSURE AREA

DIRECTION OF TRAVEL


PCMS - PORTABLE CHANGABLE MESSAGE SIGN

PCMS No. (POSTED DURING CLOSURE PERIOD AND 7 DAYS IN ADVANCE)

TYPE III BARRICADE w/ FLASHING BEACON

TEMPORARY SIGN

ADVANCED WARNING SIGNS TO BE PLACED PER CALIFORNIA MANUAL ON TRAFFIC CONTROL DEVICES. EXACT LOCATION OF SIGNS, BARRICADES AND RAILING TO BE DETERMINED BY THE ENGINEER.

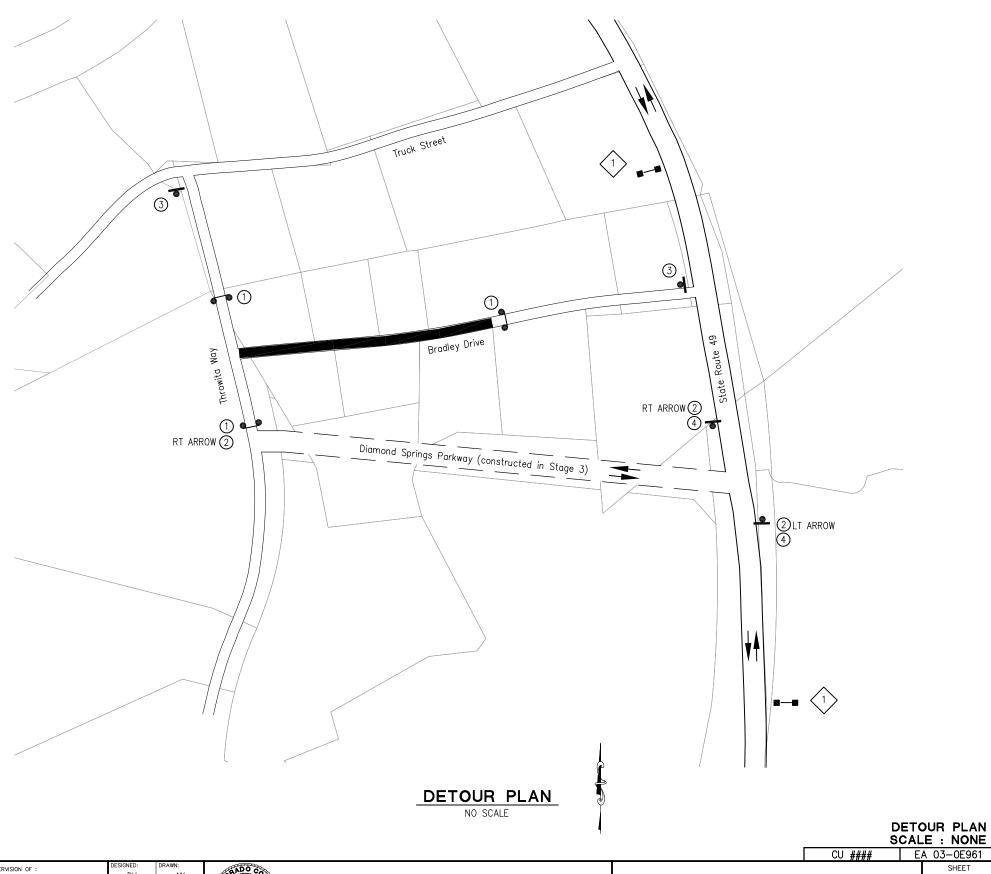

1/28/2025 DATE:

HECKED:

JN


OAD NUMBER:

1/28/202



COUNTY OF EL DORADO DEPARTMENT OF TRANSPORTATION DIAMOND SPRINGS PARKWAY PHASE 1B

DE-1 107 of 136 72334

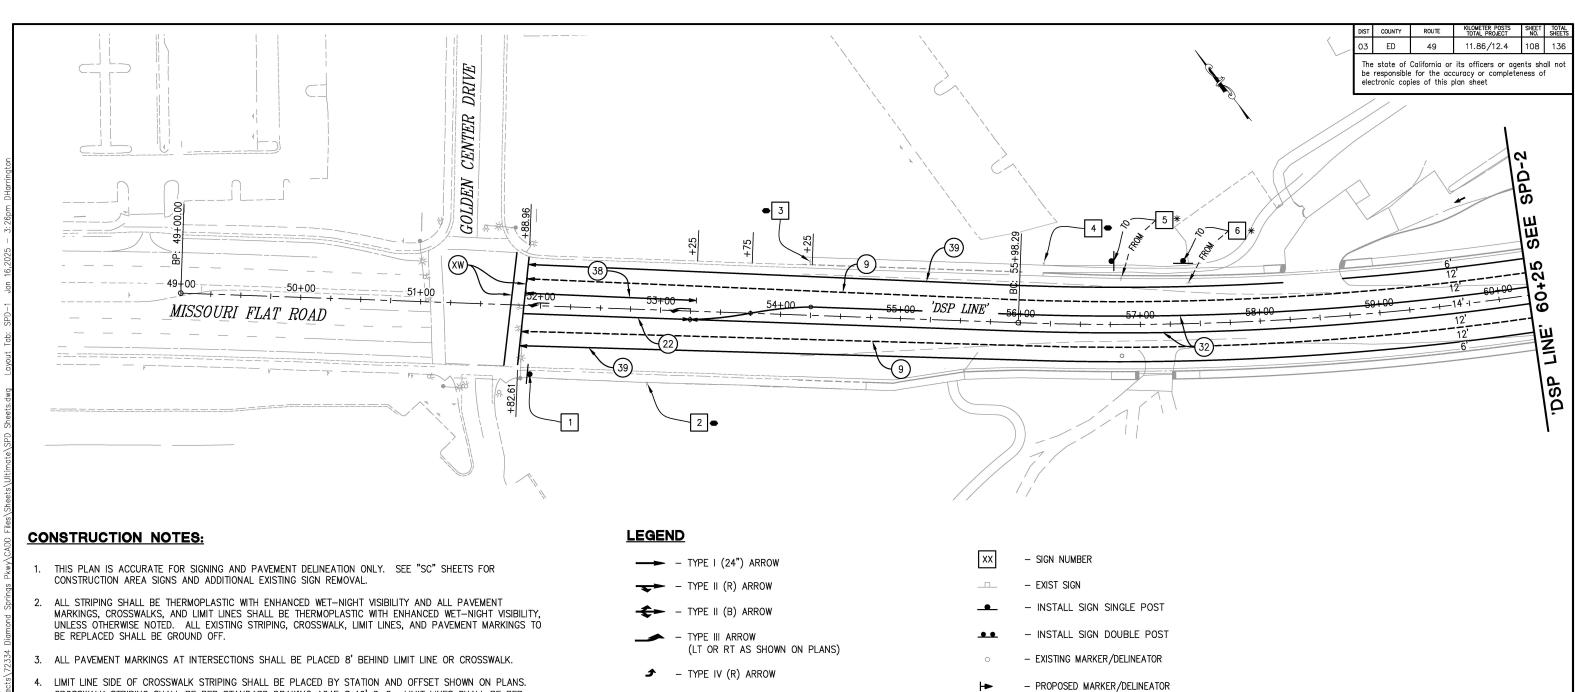

- CROSSWALK STRIPING SHALL BE PER STANDARD DRAWING A24F @ 10' C-C. LIMIT LINES SHALL BE PER RSP A24E.
- 5. ALL PAVEMENT MARKINGS ARE PER CALTRANS STANDARD PLANS.
- 6. LOCATIONS OF SIGNS SHOWN ARE APPROXIMATE. EXACT LOCATION TO BE DETERMINED BY THE ENGINEER IN THE FIELD.
- 7. VERIFY HORIZONTAL AND VERTICAL LOCATION OF EXISTING UTILITIES PRIOR TO SIGN POST INSTALLATION.
- 8. ALL CULVERT MARKERS SHALL BE PLACED PER "MARKER CULVERT" DETAIL. SEE DETAIL ON SPD-X SHEET.
- 9. ALL PAVEMENT MARKERS SHALL BE RETROREFLECTIVE-RECESSED UNLESS OTHERWISE NOTED.

- TYPE VI ARROW
- BC/EC/PCC
- ANGLE POINT
- LIMITS OF DESIGNATED STRIPES AND DETAILS
- BIKE LANE ARROW
- "LANE" PAVEMENT MARKING
- "BIKE" PAVEMENT MARKING
- STOP "STOP" PAVEMENT MARKING

- SIGN DETAIL NUMBER (SEE SHEET SPD-8)

- HIGHWAY POST MARKER

- CULVERT MARKER

- OBJECT MARKER (TYPE K-1)

- REMOVE EXISTING SIGN, USE DURING CONSTRUCTION

- RELOCATE ROADSIDE SIGN

RESET ROADSIDE SIGN

- EXISTING SIGN TO REMAIN

SIGNING & PAVEMENT DELINEATION

THIS SHEET ACCURATE FOR SIGNING AND PAVEMENT DELINEATION WORK ONLY

SCALE : 1" = 40' CU #### EA 03-0E961

SHEET


72334


DH HECKED: JN 1/28/202 1/28/2025 DATE:





COUNTY OF EL DORADO DEPARTMENT OF TRANSPORTATION DIAMOND SPRINGS PARKWAY PHASE 1B


SPD-1 108 of 136

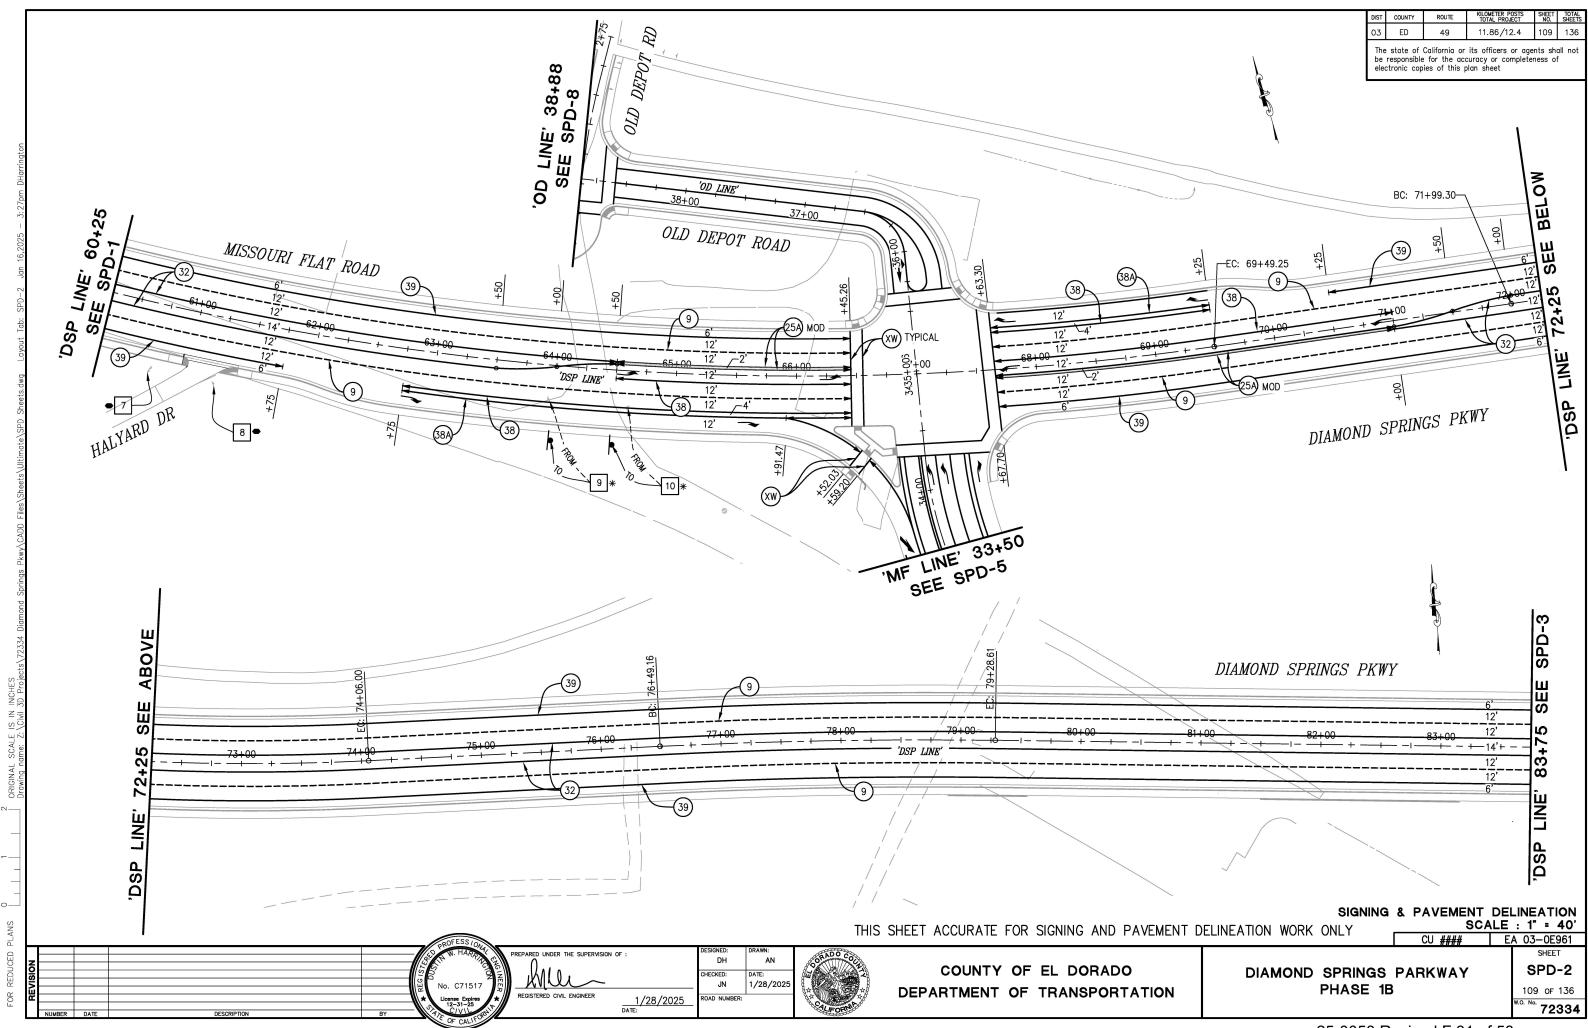


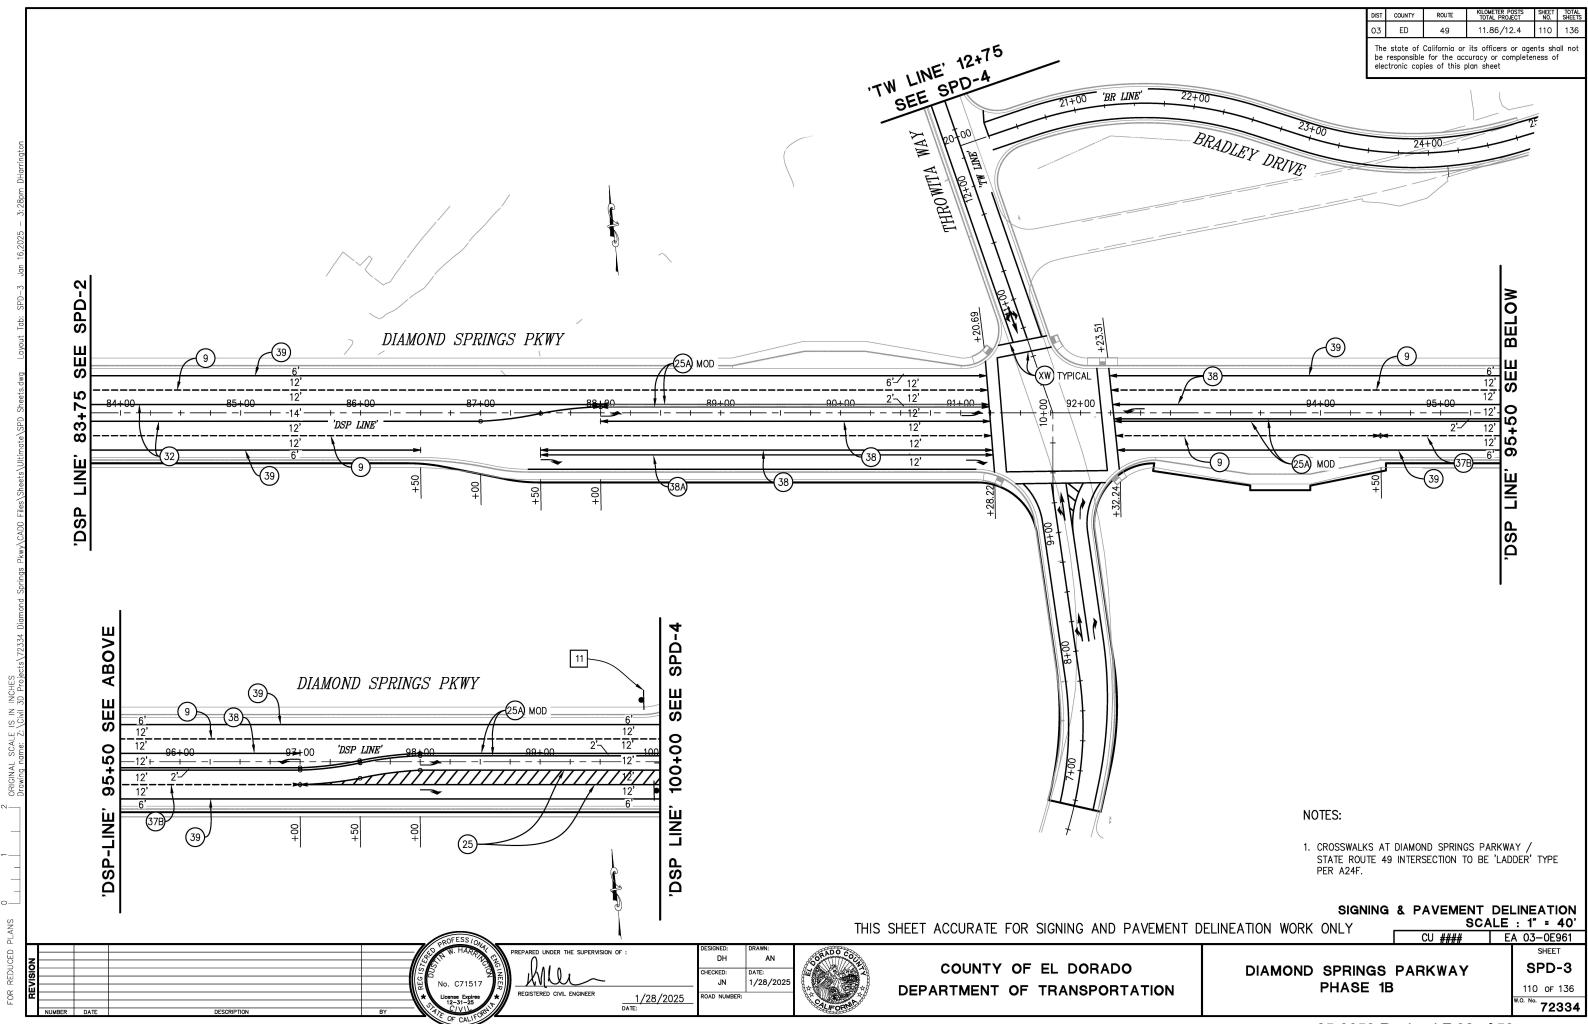

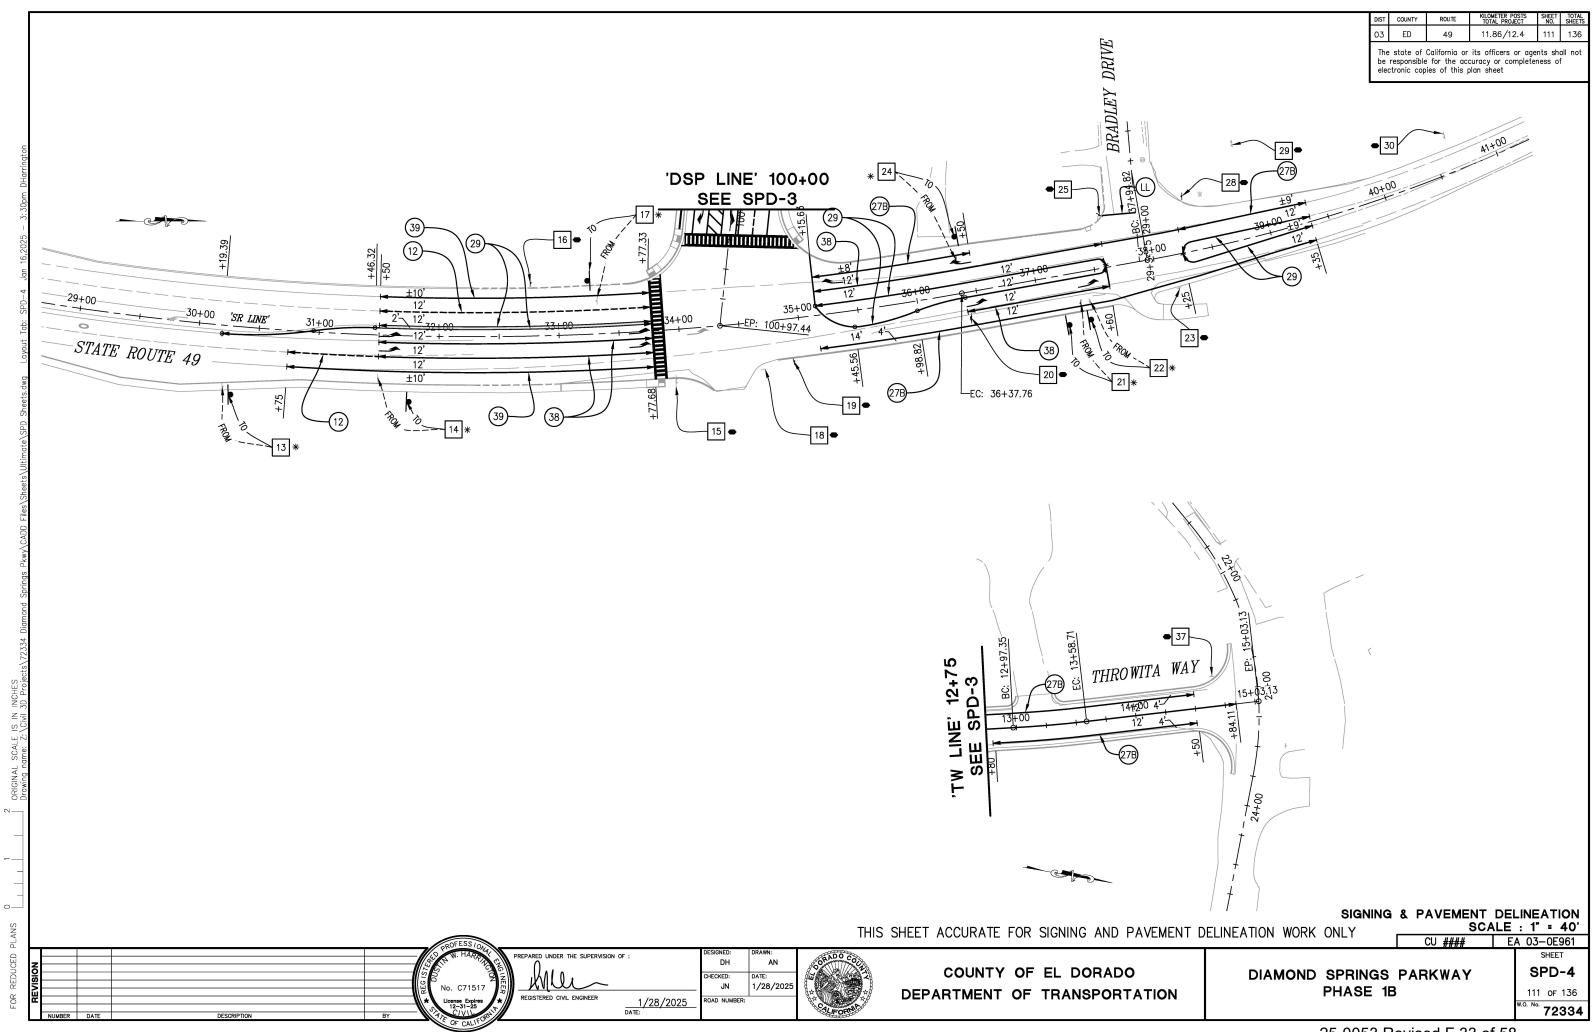

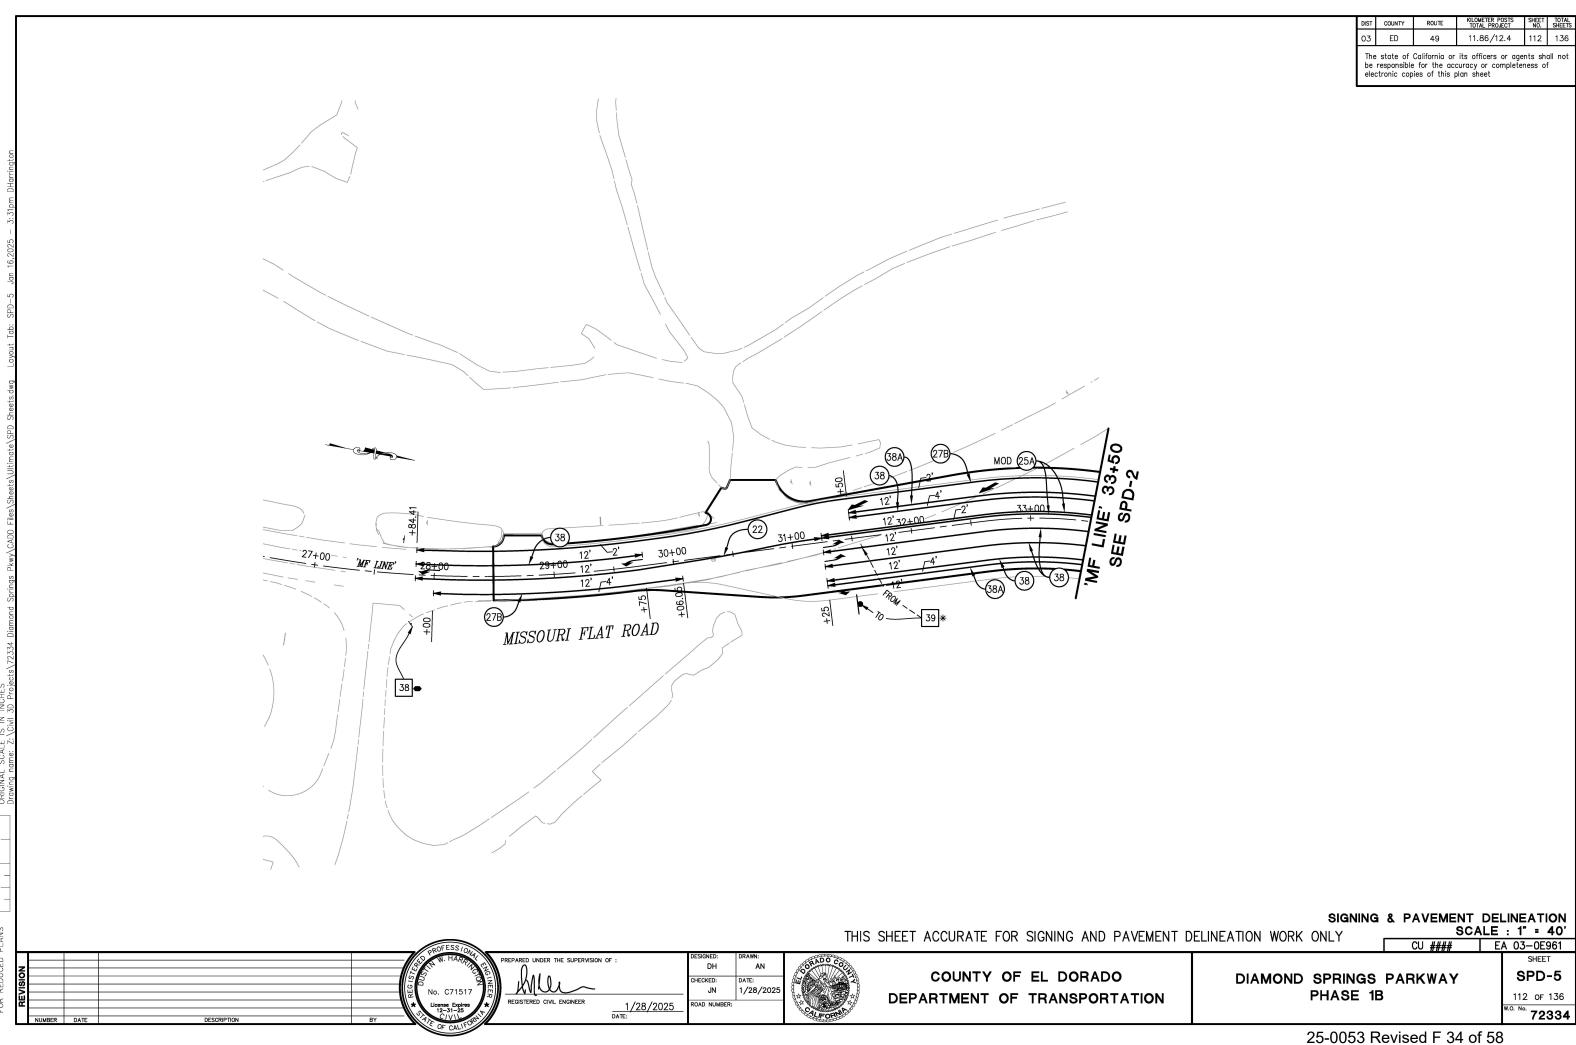

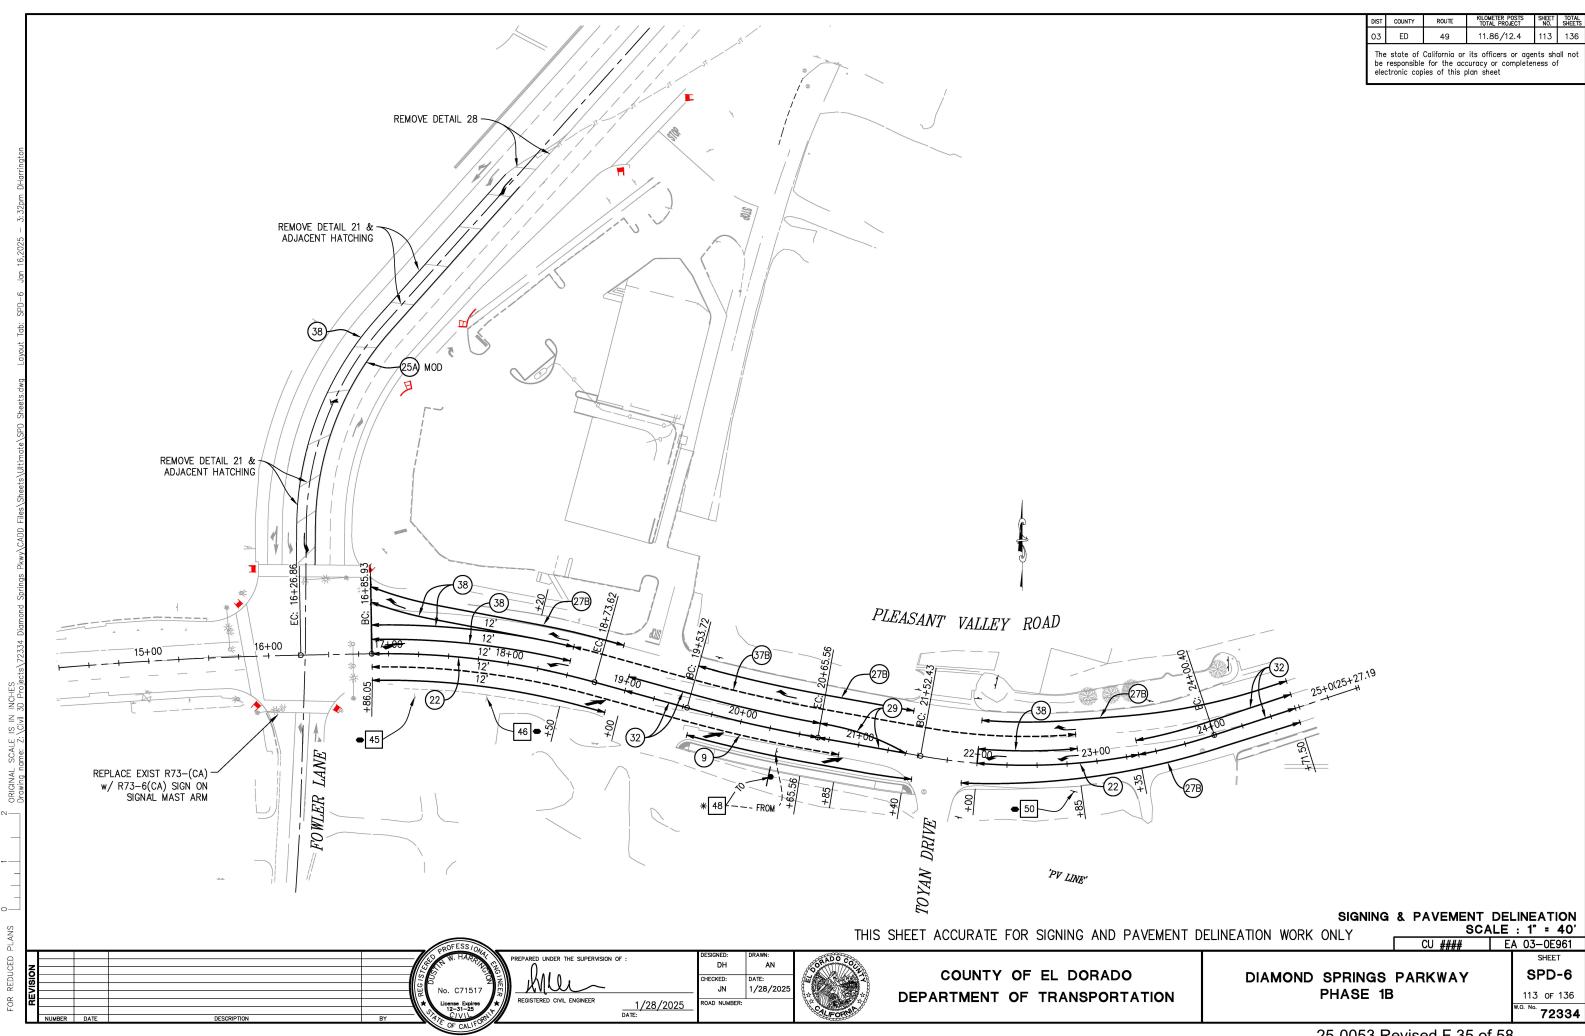

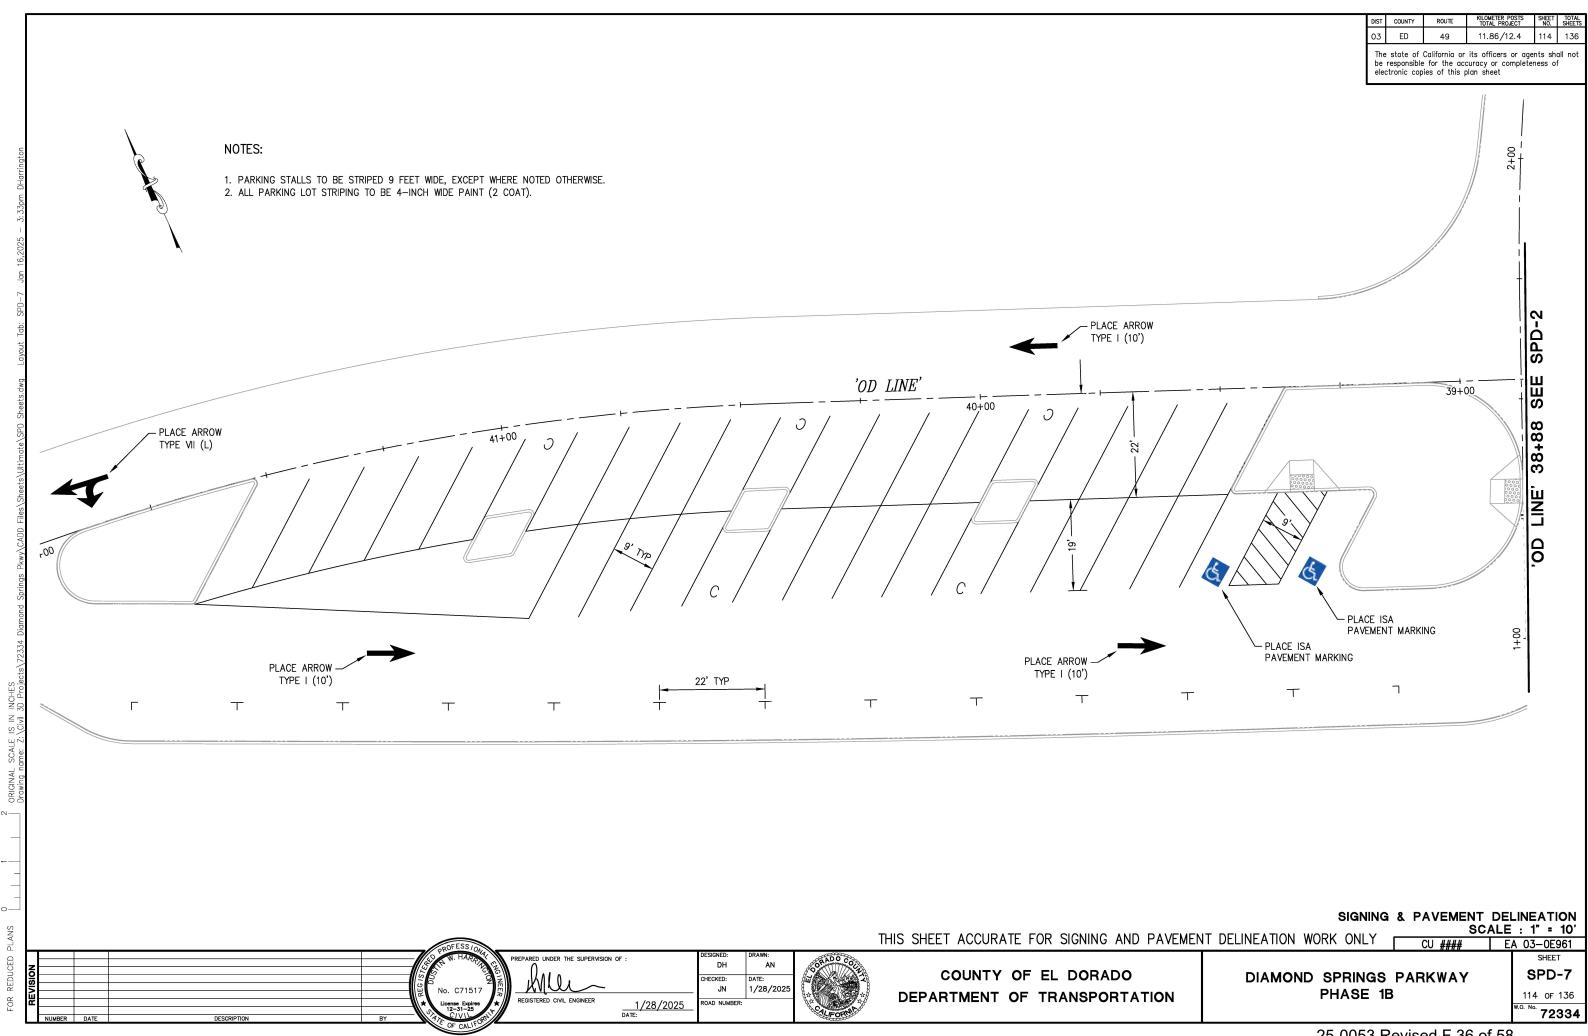

DIST	COUNTY	ROUTE	KILOMETER POSTS TOTAL PROJECT	SHEET NO.	TOTAL SHEETS	
03	ED	49	11.86/12.4	115	136	

The state of California or its officers or agents shall not be responsible for the accuracy or completeness of electronic copies of this plan sheet

			THERMOPLA	ASTIC TRAFFIC STRIPE					
			HIGH VISBILITY	THERMOPLASTIC	P	AVEMENT MARKER (RETRO	DREFLECTIVE-RECESSE	D)	
STANDARD PLAN NO.	FROM	то	6"-WHITE (LT)	6"-YELLOW (LT)	TYPE D (EA)	TYPE G (EA)	TYPE H (EA)	TYPE RY (EA)	
	'DSP LINE' 51+82.61-RT	DSP LINE' 66+45.36-RT	1,469			33			
	'DSP LINE' 51+88.96-LT	DSP LINE' 66+45.36-LT	1,449			32			
	'DSP LINE' 67+63.30-LT	DSP LINE' 91+20.69-LT	2,355			51			
DETAIL 40	'DSP LINE' 67+67.70-RT	DSP LINE' 91+28.22-RT	2,362			51			
DETAIL 12	'DSP LINE' 92+23.51-LT	DSP LINE' 100+24.18-LT	794			19			
	'DSP LINE' 92+32,24-RT	DSP LINE' 97+00-RT	471			12			
	'SR LINE' 30+75-RT	SR LINE' 31+50-RT	75			4			
	'SR LINE' 31+50-LT	SR LINE' 33+77.42-LT	226			7			
	'TW LINE' 6+70	TW LINE' 9+41.35		272					
DETAIL 21	'TW LINE' 10+64.62	TW LINE' 14+84.11		420					
	'BR LINE' 20+25	BR LINE' 25+00		475					
	'DSP LINE' 51+82.61-RT	DSP LINE' 53+25-RT		284	16				
	'MF LINE' 27+84.41-RT	MF LINE' 31+25-LT		682	32				
DETAIL 22	'MF LINE' 36+51.73	MF LINE' 38+59.71		416	22				
	'PV LINE' 16+86.05	PV LINE' 19+00		428	22				
	'PV LINE' 22+00	PV LINE' 24+71.50		428	22				
	'DSP LINE' 97+00-RT	DSP LINE' 100+21.76-RT		323				9	
DETAIL OF	'DSP LINE' 97+00-RT	DSP LINE' 100+21.76-RT		323				9	
DETAIL 25	'PV LINE' 16+86.05-LT	'PV LINE' 18+20-LT		139				9	
	'PV LINE' 16+86.05-LT	'PV LINE' 16+86.05-LT		142				9	
	'DSP LINE' 64+50-LT	DSP LINE' 66+45.26-LT		390			12		
	'DSP LINE' 67+45.26-RT	DSP LINE' 71+00-RT		710			18		
DETAIL 25B	'DSP LINE' 92+27.89-RT	DSP LINE' 100+20.63-LT		1,588			38		
	'MF LINE' 31+25-LT	MF LINE' 34+29.30-LT		608			16		
	'SR LINE' 35+15.63-LT	SR LINE' 36+50-LT	135						
	'SR LINE' 35+15.63-LT	SR LINE' 39+35-LT	424						
<u> </u>	'SR LINE' 38+25-LT	SR LINE' 39+35-LT	110						
<u> </u>	'TW LINE' 6+70-LT	TW LINE' 9+41.82-LT	273						
<u> </u>	'TW LINE' 6+70-RT	TW LINE' 9+40,29-RT	278						
	'TW LINE' 10+68-LT	TW LINE' 14+50-LT	383						
	'TW LINE' 10+62.40-RT	TW LINE' 11+90-RT	127						
	'TW LINE' 12+80-RT	TW LINE' 14+50-RT	171						
DETAIL 27B	'MF LINE' 28+00-RT	TW LINE' 14+50-RT	183						
	'MF LINE' 27+84.41-LT	TW LINE' 33+55-LT	576						
	'OD LINE' 34+66.16-RT	'OD LINE' 38+59.74-RT	317						
	'OD LINE' 34+66.16-LT	'OD LINE' 38+59.74-LT	277						
	'BR LINE' 20+25-LT	'BR LINE' 25+00-LT	475						
-	'BR LINE' 20+25-RT	'BR LINE' 25+00-RT	475						
-	'PV LINE' 16+86.05-RT	'PV LINE' 24+71.50-RT	789						
-	'PV LINE' 16+86.05-LT	'PV LINE' 24+71.50-LT	779						
	'DSP LINE' 88+00-LT	'DSP LINE' 91+23,79-LT		648	16				
	'DSP LINE' 88+00-LT	'DSP LINE' 91+23.79-LT		648	16				
	'SR LINE' 30+19.39-RT	'SR LINE' 33+77.48-LT		716	17				
<u> </u>	'SR LINE' 31+50-LT	'SR LINE' 33+77.48-LT		454	12				
-	'SR LINE' 35+15.63-LT	SR LINE' 37+60-LT		228	7				
DETAIL 29	'SR LINE' 35+15.63-RT	SR LINE' 37+60-RT		232	7				
<u> </u>	'OD LINE' 34+66.16	'OD LINE' 36+51.73		182	6				
-	'OD LINE' 34+66.16-RT	'OD LINE' 36+51.73-RT		196	6				
+	'PV LINE' 20+65.56	'PV LINE' 21+40		148	5				
-	'PV LINE' 20+65.56	'PV LINE' 21+40		152	5			 	
	1 V ENGL 20100.00	SUBTOTAL	14,973	11,232	211	208	84	36	
		TOTAL		6,205	211 208 84 455				

SIGNING & PAVEMENT DELINEATION QUANTITIES

THIS SHEET ACCURATE FOR SIGNING AND PAVEMENT DELINEATION WORK ONLY

SCALE : NONE

CU #### EA 03-0E961 SHEET

72334

SPD-8 115 of 136

DIAMOND SPRINGS PARKWAY PHASE 1B

DH

JN

OAD NUMBER:

1/28/202

HECKED:

1/28/2025 DATE:

PREPARED UNDER THE SUPERVISION OF

No. C71517

COUNTY OF EL DORADO DEPARTMENT OF TRANSPORTATION

DIST	COUNTY	ROUTE	KILOMETER POSTS TOTAL PROJECT	SHEET NO.	TOTAL SHEETS
03	ED	49	11.86/12.4	116	136

The state of California or its officers or agents shall not be responsible for the accuracy or completeness of electronic copies of this plan sheet

		THERMOPLAS	STIC TRAFFIC STRIP	=		
STANDARD			HIGH VISBILITY	THERMOPLASTIC		
PLAN NO.	FROM	то	6"-WHITE (LT)	8"-WHITE (LT)	TYPE D (EA)	TYPE G (EA)
	DSP LINE' 53+25-LT	'DSP LINE' 64+50-LT		1,688	63	
	DSP LINE' 53+25-RT	'DSP LINE' 64+50-RT		1,902	70	
DETAIL OO	DSP LINE' 71+00-LT	'DSP LINE' 88+00-LT		2,552	93	
DETAIL 32	DSP LINE' 71+00-RT	'DSP LINE' 88+00-RT		2,552	93	
	'PV LINE' 16+86.05	'PV LINE' 20+65.56		567	24	
	'PV LINE' 19+00-LT	'PV LINE' 20+65.56-LT		248	13	
	'DSP LINE' 51+82.61-LT	'DSP LINE' 53+25-LT		143		8
	'DSP LINE' 62+75-RT	'DSP LINE' 66+45.26-RT		370		17
	'DSP LINE' 64+50-RT	'DSP LINE' 66+45.26-RT		195		10
	'DSP LINE' 65+91.47-RT	'DSP LINE' 66+52.03-RT		69		4
<u> </u>	'DSP LINE' 66+59.20-RT	'MF LINE' 34+65.60-LT		73		4
	'DSP LINE' 67+67,70-LT	'DSP LINE' 69+25-LT		157		9
	'DSP LINE' 67+67.70-LT	'DSP LINE' 71+00-LT		332		16
	'DSP LINE' 87+50-RT	'DSP LINE' 91+20.69-RT		371		18
-	'DSP LINE' 88+00-RT	'DSP LINE' 91+20.69-RT		321		16
	'DSP LINE' 92+23,51-LT	'DSP LINE' 97+00-LT		477		22
	'SR LINE' 31+50-RT	'SR LINE' 77+68-RT		477		22
-	'SR LINE' 31+50-RT	'SR LINE' 33+77.68-RT		228		11
	'SR LINE' 31+50-RT	'SR LINE' 33+77.68-RT		228		11
DETAIL 38				310		15
	'SR LINE' 35+15.63-LT 'SR LINE' 36+37.76-RT	'SR LINE' 38+25-LT 'SR LINE' 37+60-RT		122		7
-	'TW LINE' 8+07-RT	'TW LINE' 9+40.29-RT		133		8
	'TW LINE' 9+00-RT	'TW LINE' 9+40.29-RT		45		3
	'MF LINE' 27+84.41-LT	'MF LINE' 29+75-LT		191		10
-	'MF LINE' 31+25-RT	'MF LINE' 34+25.83-RT		301		15
-	'MF LINE' 31+25-RT	'MF LINE' 34+25.83-RT		301		15
-	'MF LINE' 31+25-RT	'MF LINE' 34+25.83-RT		301		15
L	'PV LINE' 16+86.05-LT	'PV LINE' 18+50-LT		164		9
L	'PV LINE' 16+86.05-RT	'PV LINE' 20+85-RT		399		19
L	'PV LINE' 18+20-LT	'PV LINE' 22+85-LT		465		21
	'PV LINE' 22+00-LT	'PV LINE' 22+85-LT		85		6
	'PV LINE' 23+35-LT	'PV LINE' 24+71.50-LT		137		8
	'MF LINE' 30+06.05-RT	'MF LINE' 31+25-RT	121			
DETAIL 39A	'MF LINE' 30+06.05-RT	'MF LINE' 31+25-RT	121			
	'MF LINE' 31+50-LT	'MF LINE' 34+30.23-LT	288			
	'MF LINE' 31+50-LT	'MF LINE' 34+30.23-LT	288			
	'DSP LINE' 51+82.61-RT	'DSP LINE' 61+75-RT	993			
	'DSP LINE' 51+88.96-LT	'DSP LINE' 66+45.26-LT	1,456			
Γ	'DSP LINE' 62+75-RT	'DSP LINE' 66+45.26-LT	370			
	'DSP LINE' 67+45.26-LT	'DSP LINE' 69+25-LT	180			
Γ	'DSP LINE' 67+45.26-RT	'DSP LINE' 86+50-RT	1,905			
DETAIL 39	'DSP LINE' 70+25-LT	'DSP LINE' 91+20.69-LT	2,095			
r	'DSP LINE' 87+50-RT	'DSP LINE' 91+28.22-LT	378			
	'DSP LINE' 92+23.51-LT	'DSP LINE' 100+24.18-LT	801			
	'DSP LINE' 92+23.51-RT	'DSP LINE' 100+24.18-RT	801			
<u> </u>	'SR LINE' 30+75-RT	SR LINE' 33+77.68-RT	303			
	'SR LINE' 31+50-LT	SR LINE' 33+77.33-LT	227			
		SUBTOTAL	10,327	15,902		319
		TOTAL		229		319

REPARED UNDER THE SUPERVISION OF :

	PAVEMENT MARKINGS													
STANDARD DRAWING	DESCRIPTION	SPD-1	SPD-2	SPD-3	SPD-4	SPD-5	SPD-6	SPD-7	COUNT (TOTAL)	TOTAL AREA (SQFT)				
A24F	CROSSWALK (BASIC, 1' MARKING WIDTH)	184	665	1352		124			2325	2,325				
A24F	LIMIT LINE (BASIC, 1' MARKING WIDTH)			61		22	76	159	159					
A24D	YIELD		1						1	24				
A24E	KEEP				1				1	24				
A24E	CLEAR				1				1	27				
A24A	TYPE I ARROW		3						3	93				
A24B	TYPE II (L) ARROW		1	1	2				4	180				
A24B	TYPE II (R) ARROW								0	0				
A24B	TYPE II (B) ARROW		1	1	1				3	177				
A24B	TYPE III (L) ARROW	2	4	6	7	6		4	29	1,218				
A24B	TYPE III (R) ARROW		4	5	5	2		4	20	840				
A24B	TYPE VI ARROW					3		3	6	252				
	TOTAL													

SIGNING & PAVEMENT DELINEATION QUANTITIES

THIS SHEET ACCURATE FOR SIGNING AND PAVEMENT DELINEATION WORK ONLY

CU #### EA 03-0E961

SHEET SPD-9

DH CHECKED: JN

ROAD NUMBER:


1/28/2025 DATE:


DATE: 1/28/2025

COUNTY OF EL DORADO DEPARTMENT OF TRANSPORTATION

DIAMOND SPRINGS PARKWAY PHASE 1B

116 of 136 72334

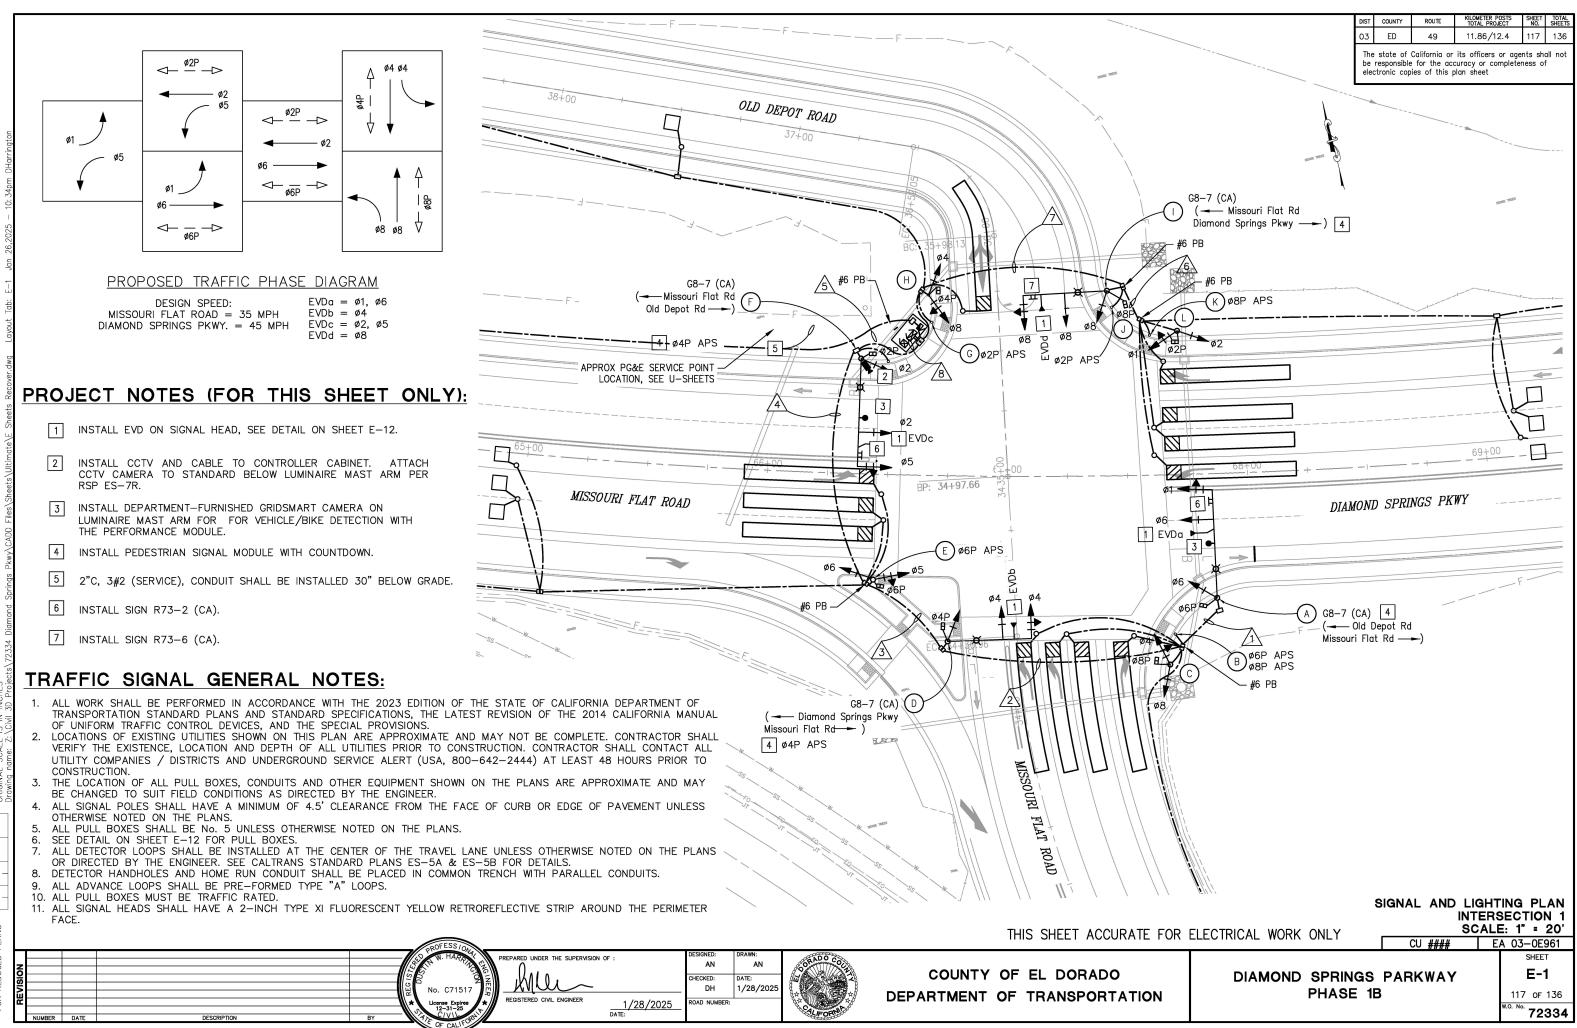

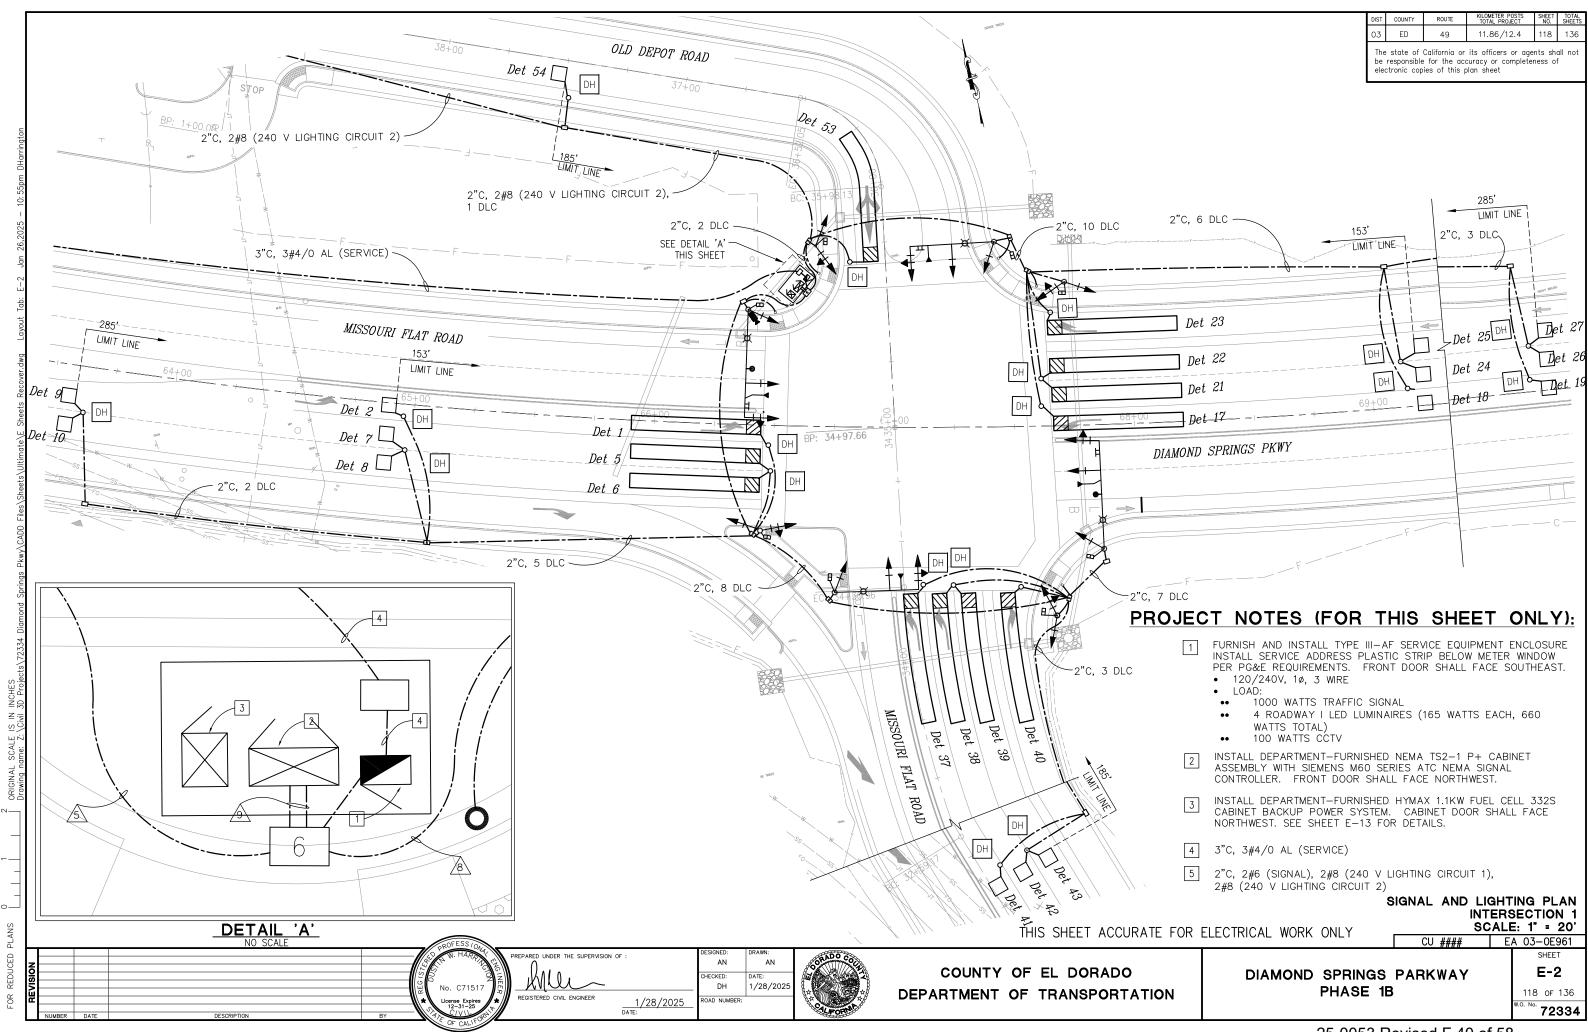

The state of California or its officers or agents shall not be responsible for the accuracy or completeness of electronic copies of this plan sheet

POLE AND EQUIPMENT SCHEDULE

9																
2		S	STANDARD			VEHICLE			PEDE	STRIAN SIGNAL MOUNTING		PBA	LED	LOCATIO	N	DELLIDIO I
,,2020	NO.	TYPE	SIG. MA	LUM. MA (FT)	ø	MAST ARM	ø	POLE	ø	POLE	ø	ARROW	LUMINAIRE	STATION **	OFFSET	REMARKS *
db. E - 5 odil 20	A	26-3-100	45	12	6	MAS MAS	6	SV-1-T	6	SP-1-T			ROADWAY I	'DSP' 67+85.82	51.76 RT	INSTALL GRIDSMART CAMERA ON LUMINAIRE MAST ARM. INSTALL R73-2 (CA) ON SIGNAL MAST ARM. INSTALL EVDG ON SIGNAL HEAD. INSTALL G8-7 (CA) ON STANDARD DIRECTLY ABOVE SIGNAL MAST ARM CONNECTION WITH STRAP & SADDLE BRACKET METHOD. F=13.6'
your	B	PBA									6 8	—		'DSP' 67+68.37	66.38 RT	INSTALL APS SIGN.
2	0	1-B					4 8	TV-2-T	8	SP-1-T				'DSP' 67+66.04	79.01 RT	
מבנים ויפרסאפוית		24-3-100	35	12	4	MAS-4B	4	SV-1-T	4	SP-1-T	4	-	ROADWAY I	'DSP' 67+76.09	69.02 RT	INSTALL EVDb ON SIGNAL HEAD. INSTALL G8-7 (CA) ON STANDARD DIRECTLY ABOVE SIGNAL MAST ARM CONNECTION WITH STRAP & SADDLE BRACKET METHOD. INSTALL APS SIGN. F=12'
1000	E	1-B					5 6	TV-2-T	6	SP-1-T	6	-		'DSP' 66+45.20	43.94 RT	INSTALL APS SIGN.
les (alleets (ott	F	26-3-100	45	12	2 5	MAS MAS	2	SV-1-T	2	SP-1-T	2		ROADWAY I	'DSP' 66+37.60	48 LT	INSTALL GRIDSMART CAMERA ON LUMINAIRE MAST ARM. INSTALL APS SIGN. INSTALL CCTV ON STANDARD. INSTALL EVDc ON SIGNAL HEAD. INSTALL R73-2 (CA) ON SIGNAL MAST ARM. INSTALL G8-7 (CA) ON STANDARD DIRECTLY ABOVE SIGNAL MAST ARM CONNECTION WITH STRAP & SADDLE BRACKET METHOD. F=14.4'
- חחאי	(G)	PBA									4	-		'DSP' 66+67.27	63.86 LT	INSTALL APS SIGN.
\ \ \ \ \ \ \ \ \ \ \ \ \ \ \ \ \ \ \	(Ξ)	1-B					4 8	TV-2-T	4	SP-1-T				'DSP' 66+65.72	75.17 LT	
regillings river	\odot	24-3-100	35	12	8	MAS-4B	8	SV-1-T	4	SP-1-T			ROADWAY I	'DSP' 67+42.44	77.17 LT	INSTALL EVDd ON SIGNAL HEAD. INSTALL R73-6 (CA) ON SIGNAL MAST ARM. INSTALL G8-7 (CA) ON STANDARD DIRECTLY ABOVE SIGNAL MAST ARM CONNECTION WITH STRAP & SADDLE BRACKET METHOD. F=17.3'
- CIGIL	\odot	PBA									2			'DSP' 67+44.41	70.29 LT	INSTALL APS SIGN.
(7/ c)	(8)	РВА					1				8	-		'DSP' 67+60.40	58.44 LT	INSTALL APS SIGN.
71010	L	1-B					2	TV-2-T	2	SP-1-T				'DSP' 67+72.20	59.92 LT	

*	OTHER REQUIREMENTS ARE COVERED BY NOTES, LEGEND, SPECIAL PROVISIONS AND
	STANDARD SPECIFICATIONS.
	FOR TYPE OF STANDARD AND VEHICLE SIGNAL MOUNTING, SEE CALTRANS STANDARD PLANS.

** FINAL LOCATION WILL BE DETERMINED BY THE ENGINEER.

CONDUCTOR & CONDUIT SCHEDULE												
						F	RUN No					
AWG SIZE OR CABLE TYPE	PHASE Ø	POLE OR CIRCUIT		<u>^2</u>	3	4	<u>\$</u>	<u>6</u>		8	9	
	1, 6, 6P	POLE (A)	1	1	1	1	1				1	
	6PBA, 8PBA	POLE B		1	1	1	1				1	
	4, 8, 8P	POLE C		1	1	1	1				1	
	4, 4P 4PBA	POLE D			1/1	1/1	1/1				1 1	
12/3	5, 6, 6P 6PBA	POLE E				1/1	1/1				1 1	
CONDUCTOR	2, 2P, 5 2PBA	POLE F					1/1				1 1	
SIGNAL CABLES	2PBA, 4PBA	POLE G								1	1	
ONDEES	4, 4P, 8	POLE (H)								1	1	
	8, 8P	POLE (1	1	1	
	2PBA	POLE J							1		1	
	8PBA	POLE (K)		\angle				1	1		1	
	1, 2, 2P	POLE (L)	\angle	/				1	1	1	1	
	TOTAL CABLES 12/3 CO	NDUCTORS	1	2/1	$\frac{3}{2}$	4/3	5 4	1/1	$\frac{2}{2}$	$\frac{3}{2}$	8 7	
#8	LIGHTING CIRCUIT 1 (24				2	2	2	2			2	
#6	CONTROLLER SERVICE (120V)									2	
	Det 1, 2					2	2				2	
	Det 5, 6, 7, 8, 9), 10				6	6				6	
TYPE	Det 17, 18, 19							3	3	3	3	
B DLC	Det 21, 22, 23, 24, 2							7	7	7	7	
	Det 37, 38, 39, 40, 4	1, 42. 43	7	7	7	7	7				7	
	Det 53, 54								2		2	
	TOTAL		7	7	7	15	15	10	12	10	25	
	GRIDSMART CAMERA CAE	BLE	2	2	2	2	4				4	
	EVD		1	1	2	2	3		1	1	4	
	CCTV CAMERA INTERCONNECT CA	AT 5 CABLE					1				1	
CONDUIT SIZE			3"	3"	4"	2-4"	2-4"	4"	4"	4"	3-4"	
% FILL			19	25	21	15	19	12	18	21	20	

NOTES:

- 1. GRIDSMART CAMERA CABLE PLACED IN 1-2"C BY ITSELF.
- CCTV CAMERA CAT 5 INTERCONNECT CABLE PLACED IN 1-2"C BY ITSELF.
 APS SIGN MUST BE R10-3eR OR R10-3eL.

SIGNAL AND LIGHTING PLAN INTERSECTION 1 SCALE : NONE

THIS SHEET ACCURATE FOR ELECTRICAL WORK ONLY

CU #### EA 03-0E961

REPARED UNDER THE SUPERVISION OF :

AN HECKED: DH 1/28/202 1/28/2025 DATE: ROAD NUMBER:





COUNTY OF EL DORADO DEPARTMENT OF TRANSPORTATION

DIAMOND SPRINGS PARKWAY PHASE 1B

E-3 119 of 136 72334

SHEET

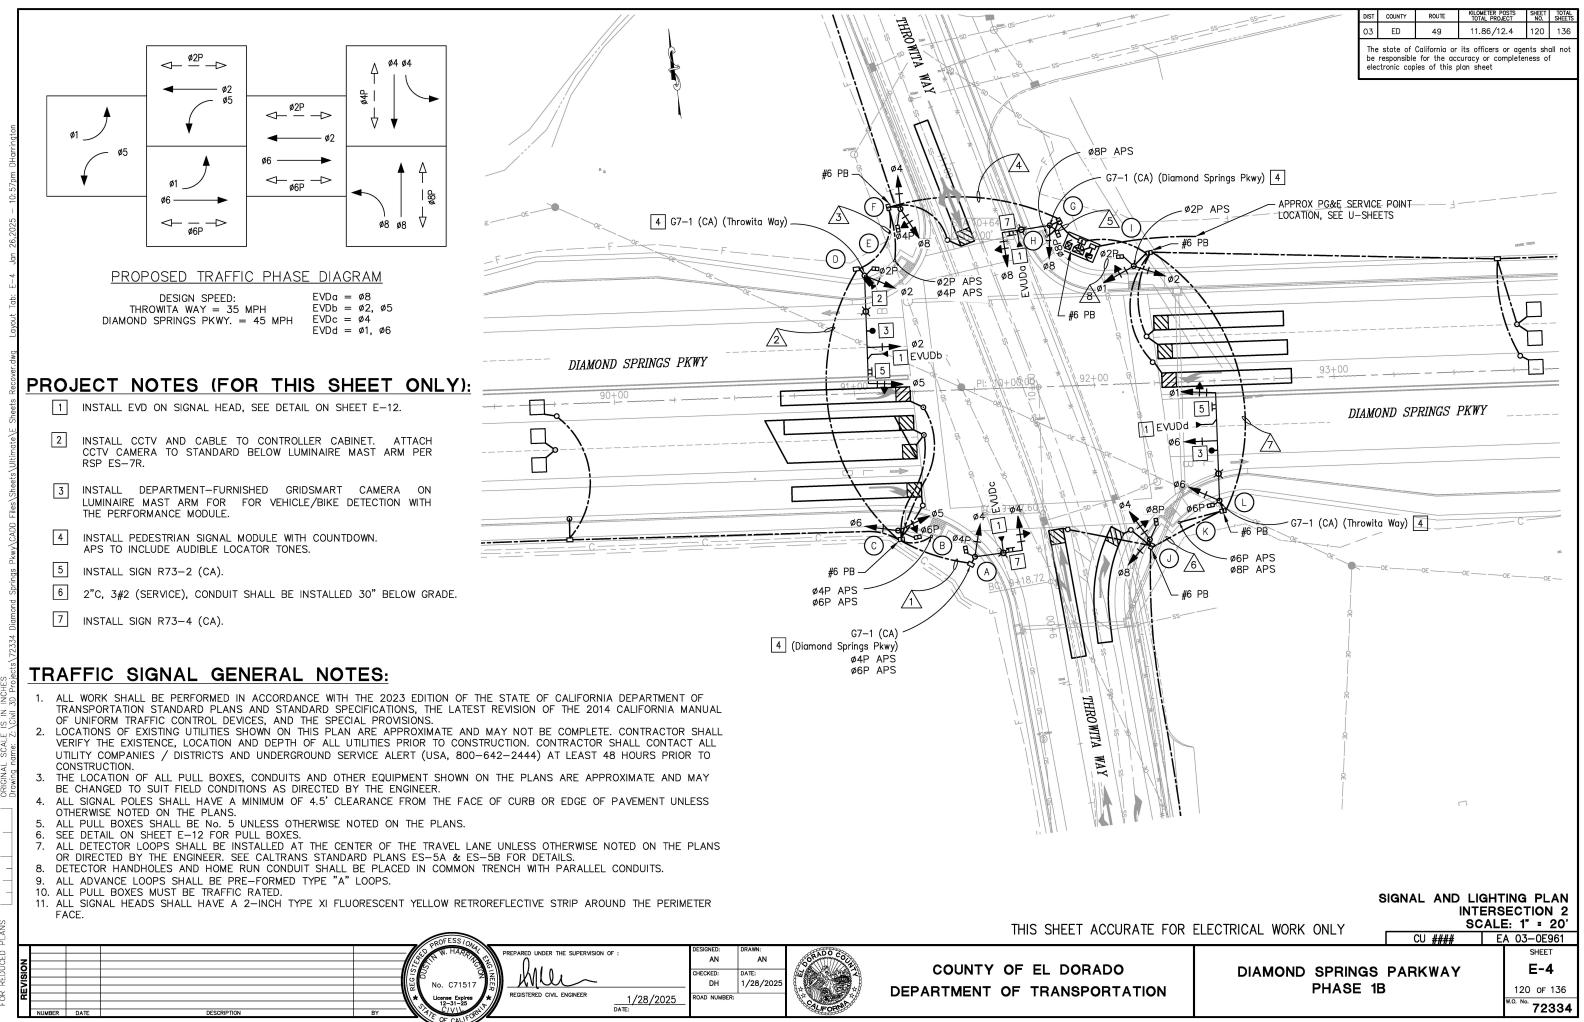

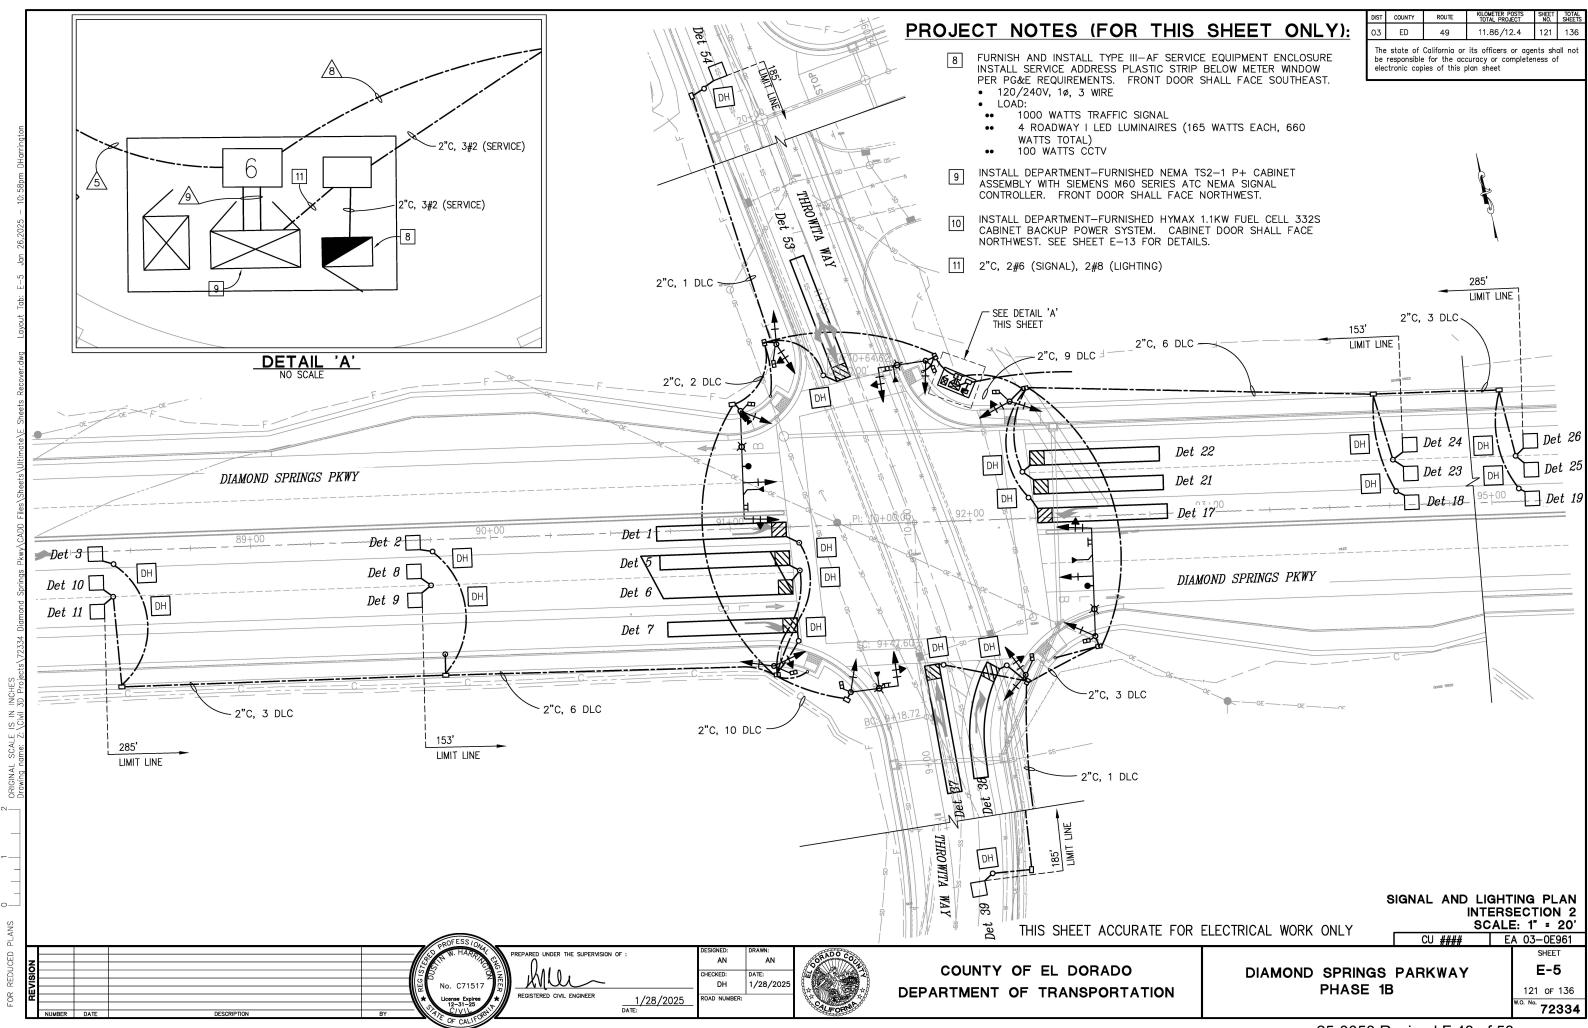

The state of California or its officers or agents shall not electronic copies of this plan sheet

POLE AND EQUIPMENT SCHEDULE PEDESTRIAN SIGNAL VEHICLE SIGNAL STANDARD LED LOCATION MOUNTING MOUNTING SIG. MA LUM. MA ø LUMINAIRE REMARKS * NO. MAST ARROW STATION ** OFFSET (FT) (FT) ARM INSTALL EVDc ON SIGNAL HEAD. INSTALL R73-4 (CA) ON SIGNAL MAST ARM. INSTALL G7-1 (CA) ON STANDARD DIRECTLY ROADWAY I 'DSP' 91+47.80 69.70 RT ABOVE SIGNAL MAST ARM CONNECTION WITH STRAP & SADDLE BRACKET METHOD. INSTALL APS SIGN. (A) 4 MAS-4B SV-1-T SP-1-T 19-2-100 (B) 'DSP' 91+30.00 60.59 RT INSTALL APS SIGN. PBA (C) 1-B 'DSP' 91+16.19 | 57.70 RT TV-2-TSP-1-T INSTALL GRIDSMART CAMERA ON LUMINAIRE MAST ARM. INSTALL MAS CCTV ON STANDARD. INSTALL EVDb ON SIGNAL HEAD. INSTALL (D) SP-1-T 26-3-100 SV-1-T ROADWAY | 'DSP' 91+06.00 | 49.01 LT | R73-2 (CA) ON SIGNAL MAST ARM. INSTALL G7-1 (CA) ON 45 12 MAS STANDARD DIRECTLY ABOVE SIGNAL MAST ARM CONNECTION WITH STRAP & SADDLE BRACKET METHOD. F=16.16' E PBA 'DSP' 91+18.79 | 54.74 LT | INSTALL APS SIGN. F 1-B TV-2-TSP-1-T 'DSP' 91+21.94 | 76.23 LT INSTALL EVDa ON SIGNAL HEAD. INSTALL R73-4 (CA) ON ROADWAY | 'OSP' 91+83.86 67.13 LT SIGNAL MAST ARM. INSTALL G7-1 (CA) ON STANDARD DIRECTLY (G) SP-1-T 17-2-100 MAS-4B SV-1-T 20 12 ABOVE SIGNAL MAST ARM CONNECTION WITH STRAP & SADDLE BRACKET METHOD. PBA \oplus 'DSP' 91+82.51 | 62.75 LT | INSTALL APS SIGN. 'DSP' 92+18.23 | 48.95 LT | INSTALL APS SIGN. TV-2-TSP-1-T 1-B \bigcirc TV-2-T SP-1-T 'DSP' 92+20.86 65.14 RT 1-B \mathbb{K} PBA 'DSP' 92+33.35 58.45 RT INSTALL APS SIGN. INSTALL GRIDSMART CAMERA ON LUMINAIRE MAST ARM. INSTALL CCTV ON STANDARD. INSTALL EVDd ON SIGNAL HEAD. INSTALL MAS ROADWAY | 'DSP' 92+50.45 | 50.00 RT | R73-2 (CA) ON SIGNAL MAST ARM. INSTALL G7-1 (CA) ON SP-1-T 26-3-100 45 12 SV-1-T STANDARD DIRECTLY ABOVE SIGNAL MAST ARM CONNECTION WITH MAS STRAP & SADDLE BRACKET METHOD. F=16'

*	OTHER REQUIREMENTS ARE COVERED BY NOTES, LEGEND, SPECIAL PROVISIONS AND
	STANDARD SPECIFICATIONS.
	FOR TYPE OF STANDARD AND VEHICLE SIGNAL MOUNTING, SEE CALTRANS STANDARD PLANS.

** FINAL LOCATION WILL BE DETERMINED BY THE ENGINEER.

	CONDUCT	OR & C	JUNC	JIT S	SCHE	DULE	=				
							RUN No			1	
AWG SIZE OR CABLE TYPE	PHASE Ø	POLE OR CIRCUIT	\triangle	<u>/2</u>	3	4	<u>\(\) \(\) \(\) \(\)</u>	<u>6</u>		8	9
	4, 4P 4PBA, 6PBA	POLE A	1	1	1	1	1				1
	5, 6, 6P 2, 2P, 5	POLE ©		1	1 1	1 1	1 1				1 1
/=	2PBA, 4PBA	POLE E				1	1				1
12/3 CONDUCTOR	4, 4P, 8 8, 8P	POLE G				1	1				1
SIGNAL CABLES	8PBA	POLE (H)					1				1
CABLES	1, 2, 2P 2PBA	POLE (1 1	1 1
	4, 8, 8P	POLE (K)						1		1	
	1, 6, 6P	POLE (L)							1	1	1
	TOTAL CABLES 12/3 CO		1	2/1	3 1	4/2	5 3	1	2/1	3/2	8 5
#8	LIGHTING (240V)			2	2	2	2		2	2	4
#6	CONTROLLER SERVICE (120V)									2
	Det 1, 2, 3			3	3	3	3	3			3
	Det 5, 6, 7, 8, 9,			7	7	7	7	7			7
TYPE	Det 17, 18, 19									3	3
B DLC	Det 21, 22, 23, 24, 2							7	7	6	6
DLC	Det 37, 38, 3 Det 53, 54	9				2	2	3	3	3	2
	TOTAL			10	10	12	12	13	3	12	24
	GRIDSMART CAMERA CAE		10	2	2	2	2	2	2	4	
	EVD	1	1	2	2	3		1	1	4	
	CCTV CAMERA INTERCONNECT CA	AT 5 CABLE			1	1	1		·	<u> </u>	1
CONDUIT SIZE			3"	4"	2-4"	2-4"	2-4"	4"	3"	4"	3-4"
% FILL			11	17	11	14	17	11	19	21	18

NOTES:

- GRIDSMART CAMERA CABLE PLACED IN 1-2"C BY ITSELF.
- CCTV CAMERA CAT 5 INTERCONNECT CABLE PLACED IN 1-2"C BY ITSELF.
- 3. APS SIGN MUST BE R10-3eR OR R10-3eL.

SIGNAL AND LIGHTING PLAN **INTERSECTION 2**

THIS SHEET ACCURATE FOR ELECTRICAL WORK ONLY

SCALE : NONE CU #### EA 03-0E961 SHEET

REPARED UNDER THE SUPERVISION OF

AN HECKED: DH 1/28/202 1/28/2025 DATE: OAD NUMBER



COUNTY OF EL DORADO DEPARTMENT OF TRANSPORTATION

DIAMOND SPRINGS PARKWAY PHASE 1B


E-6 122 OF 136 72334

PROJECT NOTES (FOR THIS SHEET ONLY):

- 1 INSTALL EVD ON SIGNAL HEAD, SEE DETAIL ON SHEET E-12.
- INSTALL CCTV AND CABLE TO CONTROLLER CABINET. ATTACH CCTV CAMERA TO STANDARD BELOW LUMINAIRE MAST ARM PER RSP ES-7R.
- INSTALL VIDEO DETECTION CAMERA PER MANUFACTURER SPECIFICATION. PROGRAM CAMERA FOR VIDEO DETECTION ZONES FOR EACH LANE AS SHOWN ON THE PLAN. ADJUST CAMERA AS
- INSTALL PEDESTRIAN SIGNAL MODULE WITH COUNTDOWN AND TOUCH-FREE PEDESTRIAN PUSH BUTTON. APS TO INCLUDE AUDIBLE
- INSTALL SIGN R73-2 (CA).
- 2"C, 3#2 (SERVICE), CONDUIT SHALL BE INSTALLED 30" BELOW GRADE.
- INSTALL SIGN R73-5 (CA).

TRAFFIC SIGNAL GENERAL NOTES:

- 1. ALL WORK SHALL BE PERFORMED IN ACCORDANCE WITH THE 2023 EDITION OF THE STATE OF CALIFORNIA DEPARTMENT OF TRANSPORTATION STANDARD PLANS AND STANDARD SPECIFICATIONS, THE LATEST REVISION OF THE 2014 CALIFORNIA MANUAL GT-1 (CA) (Diamond Springs Pkwy) OF UNIFORM TRAFFIC CONTROL DEVICES, AND THE SPECIAL PROVISIONS.
- LOCATIONS OF EXISTING UTILITIES SHOWN ON THIS PLAN ARE APPROXIMATE AND MAY NOT BE COMPLETE. CONTRACTOR SHALL VERIFY THE EXISTENCE, LOCATION AND DEPTH OF ALL UTILITIES PRIOR TO CONSTRUCTION. CONTRACTOR SHALL CONTACT ALL UTILITY COMPANIES / DISTRICTS AND UNDERGROUND SERVICE ALERT (USA, 800-642-2444) AT LEAST 48 HOURS PRIOR TO CONSTRUCTION. NOTE THAT CALTRANS IS NOT A MEMBER OF UNDERGROUND SERVICE ALERT
- THE LOCATION OF ALL PULL BOXES, CONDUITS AND OTHER EQUIPMENT SHOWN ON THE PLANS ARE APPROXIMATE AND MAY BE CHANGED TO SUIT FIELD CONDITIONS AS DIRECTED BY THE ENGINEER.
- ALL SIGNAL POLES SHALL HAVE A MINIMUM OF 4.5' CLEARANCE FROM THE FACE OF CURB OR EDGE OF PAVEMENT UNLESS OTHERWISE NOTED ON THE PLANS.
- ALL PULL BOXES SHALL BE No. 5 UNLESS OTHERWISE NOTED ON THE PLANS
- SEE DETAIL ON SHEET E-12 FOR PULL BOXES.
- ALL DETECTOR LOOPS SHALL BE INSTALLED AT THE CENTER OF THE TRAVEL LANE UNLESS OTHERWISE NOTED ON THE PLANS OR DIRECTED BY THE ENGINEER. SEE CALTRANS STANDARD PLANS ES-5A & ES-5B FOR DETAILS.
- DETECTOR HANDHOLES AND HOME RUN CONDUIT SHALL BE PLACED IN COMMON TRENCH WITH PARALLEL CONDUITS.
- 9. ALL ADVANCE LOOPS SHALL BE PRE-FORMED TYPE "A" LOOPS.
- 10. ALL PULL BOXES MUST BE TRAFFIC RATED.
- 11. PLACEMENT OF THE ACCESSIBLE PEDESTRIAN SIGNAL (APS) WILL BE MADE IN COORDINATION WITH THE LAYOUT SHEET AND THE APPROVAL OF THE ENGINEER.
- 12. LANDINGS WITH RETAINING CURBS SHOULD BE 10" MAX FROM THE FACE OF THE CURB TO THE FACE OF THE APS. LANDINGS WITHOUT A RETAINING CURB WILL HAVE APS PLACED AT THE BACK OF WALK.
- 13. THE APS SHALL BE PLACED SO THAT THE PATH OF THE PEDESTRIAN IS UNOBSTRUCTED.
- 14. A CALTRANS ENGINEER OR MEMBER OF ELECTRICAL MAINTENANCE MUST APPROVE THE LOCATION AND ORIENTATION OF THE SIGNAL CONTROLLER CABINET PRIOR TO WORK COMMENCING.
- 15. ALL SIGNAL HEADS SHALL HAVE A 2-INCH TYPE XI FLUORESCENT YELLOW RETROREFLECTIVE STRIP AROUND THE PERIMETER
- 16. FOR ACCURATE RIGHT OF WAY DATA, CONTACT RIGHT OF WAY ENGINEERING AT THE CALTRANS DISTRICT OFFICE.

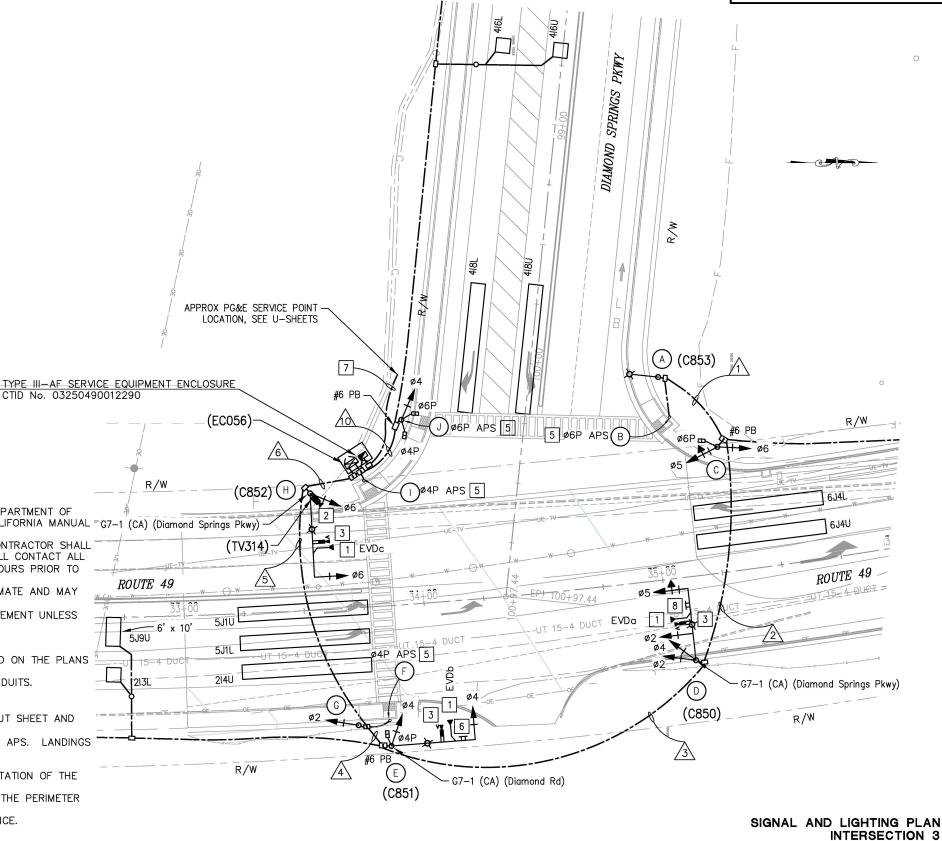

THIS SHEET ACCURATE FOR ELECTRICAL WORK ONLY

REPARED UNDER THE SUPERVISION OF

DH 1/28/2025 DATE:



1/28/202

COUNTY OF EL DORADO DEPARTMENT OF TRANSPORTATION DIAMOND SPRINGS PARKWAY PHASE 1B

E-7 123 of 136 72334


SCALE: 1" = 20'

EA 03-0E961

ED

The state of California or its officers or agents shall no be responsible for the accuracy or completeness of

electronic copies of this plan sheet

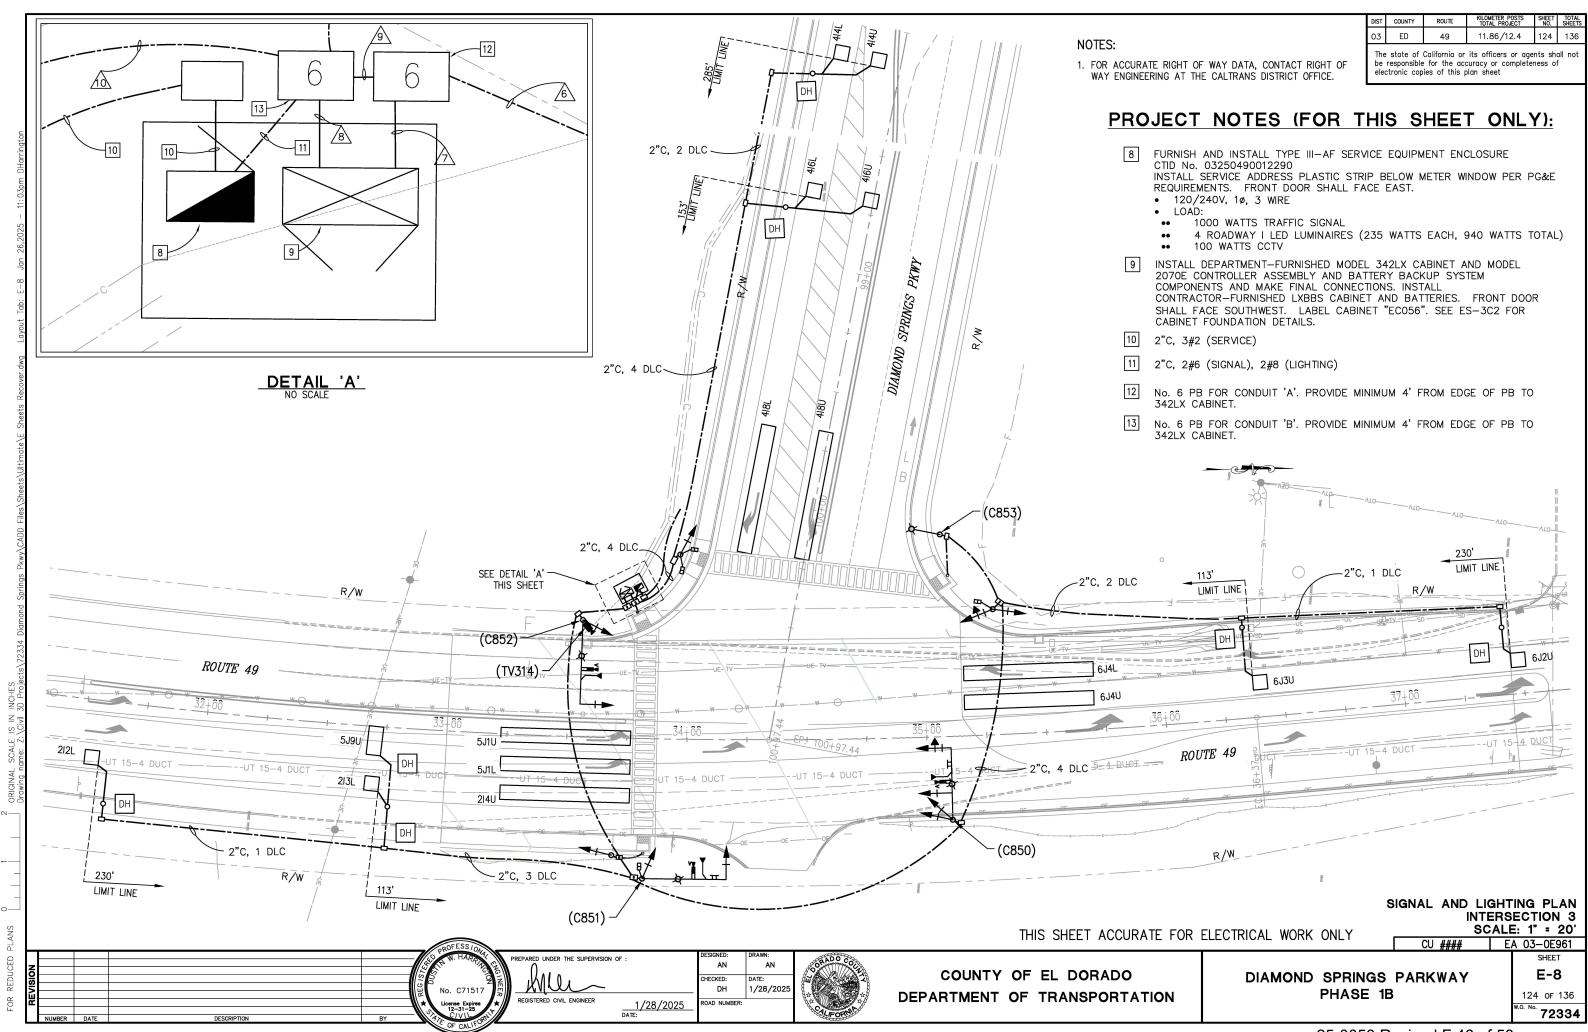

DIST	COUNTY	ROUTE	KILOMETER POSTS TOTAL PROJECT	SHEET NO.	TOTAL SHEETS
03	ED	49	11.86/12.4	125	136

The state of California or its officers or agents shall not be responsible for the accuracy or completeness of electronic copies of this plan sheet


	POLE AND EQUIPMENT SCHEDULE															
		S	TANDARD			VEHICLE MOUN			PEDE	STRIAN SIGNAL MOUNTING		РВА	LED LUMINAIRE	LOCATIO	N	REMARKS *
	10.	TYPE	SIG. MA (FT)	LUM. MA (FT)	ø	MAST ARM	ø	POLE	ø	POLE	ø	ARROW	LOMINAIRE	STATION **	OFFSET	REMARKS *
	A	24A-3-100		15									ROADWAY 2	'SR' 35+08.24	84.33 LT	NO SMA TO BE INSTALLED.
	В	PBA									8			'SR' 35+10.99	67.10 LT	INSTALL APS SIGN.
	0	1-B					7 8	TV-2-T	8	SP-1-T				'SR' 35+29.74	52.25 LT	
	D	19A-4-100	30	15	4 7	MAS MAS	2 4	SV-2-TD					ROADWAY 2	'SR' 35+09.66	34.69 LT	INSTALL VIDEO DETECTION CAMERA PER MANUFACTURER SPECIFICATION. INSTALL EVDO ON SIGNAL HEAD. INSTALL R73-5 (CA) ON SIGNAL MAST ARM. INSTALL G7-1 (CA) ON STANDARD DIRECTLY ABOVE SIGNAL MAST ARM CONNECTION WITH STRAP & SADDLE BRACKET METHOD. F=20'
	Ē	19A-3-100	30	15	2	MAS-4B	2	SV-1-T					ROADWAY 2	'SR' 33+82.54	58.37 RT	INSTALL VIDEO DETECTION CAMERA PER MANUFACTURER SPECIFICATION. INSTALL EVDB ON SIGNAL HEAD. INSTALL R73-2 (CA) ON SIGNAL MAST ARM. INSTALL G7-1 (CA) ON STANDARD DIRECTLY ABOVE SIGNAL MAST ARM CONNECTION WITH STRAP & SADDLE BRACKET METHOD.
	F	РВА									2	-		'SR' 33+82.62	47.25 RT	INSTALL APS SIGN.
	<u></u>	1-B					4 8	TV-2-T	2	SP-1-T				'SR' 33+69.76	48.89 RT	
	(H)	26A-3-100	45	15	8	MAS	8	SV-1-T	8	SP-1-T			ROADWAY 2	'SR' 33+55.11	48.67 LT	INSTALL VIDEO DETECTION CAMERA PER MANUFACTURER SPECIFICATION. INSTALL CCTV ON STANDARD. INSTALL EVDC ON SIGNAL HEAD. INSTALL G7-1 (CA) ON STANDARD DIRECTLY ABOVE SIGNAL MAST ARM CONNECTION WITH STRAP & SADDLE BRACKET METHOD.
(\bigcirc	PBA									2	-		'SR' 33+77.46	53.86 LT	INSTALL APS SIGN.
	(5)	1-B					2	TV-1-T	2	SP-1-T	8	-		'SR' 33+96.15	76.84 LT	INSTALL APS ON 1-B POLE.

LEGEND:

----- NEW CONDUCTORS

OTHER REQUIREMENTS ARE COVERED BY NOTES, LEGEND, SPECIAL PROVISIONS AND STANDARD SPECIFICATIONS. FOR TYPE OF STANDARD AND VEHICLE SIGNAL MOUNTING, SEE CALTRANS STANDARD PLANS.

** FINAL LOCATION WILL BE DETERMINED BY THE ENGINEER.

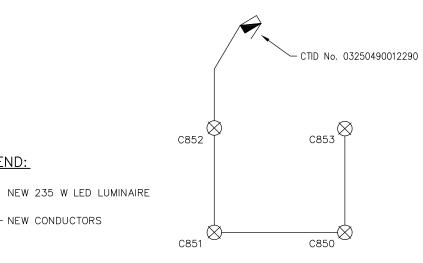

AN

OAD NUMBER:

HECKED: DH

CONDUCTOR & CONDUIT SCHEDULE RUN No. AWG SIZE OR CABLE TYPE POLE OR 6 $\sqrt{2}$ <u> 8</u> \bigcirc $\sqrt{3}$ $\sqrt{5}$ \triangle 4 PHASE Ø (FUTURE) POLE (A) POLE (B) 5, 6, 6P POLE (C) 2, 4, 5 POLE 12/3 CONDUCTOR POLE (E) POLE 4PBA SIGNAL CABLES POLE (G) POLE (H) 4PBA POLE 4, 6P 6PBA POLE (J) TOTAL CABLES 12/3 CONDUCTORS LIGHTING (240V) 2 2 2 #8 2 CONTROLLER SERVICE (120V) #6 212L, 213L, 5J9U 3 3 3 DETECTOR 414L, 414U, 416L, 416U CABLE 6J2U, 6J3U 2 2 (DLC) TOTAL 2 5 5 5 9 5 VIDEO DETECTION CAMERA CABLE 2 3 2 3 CCTV CAMERA CAT 8 CABLE CONDUIT 'A' 3" 3" 3" % FILL 0 15 15 24 12 17 5 4 CONDUIT 'B' 3" 3" 2-3" 2-3" 3" | 2-3" | 2-3" | 3" % FILL 6 10 16 23 16 19 0 25 | 19 | 9

NOTES:

- CONDUIT 'A' SHALL CONTAIN UNSPLICEABLE CABLE TYPES (DLC, CAT 8, COAXIAL, EVD) AND BE PLACED IN PARALLEL WITH CONDUIT 'B' WHERE APPLICABLE.
- CONDUIT 'B' SHALL CONTAIN SIMPLE CIRCUITS (LIGHTING, 12/3 CONDUCTOR SIGNAL CABLES, SERVICE) AND BE PLACED IN PARALLEL WITH CONDUIT 'A' WHERE APPLICABLE.
- 3. APS SIGN SHALL BE R10-3eR OR R10-3eL.

LIGHTING CIRCUIT DIAGRAM

CTID No. 03250490012290


THIS SHEET ACCURATE FOR ELECTRICAL WORK ONLY

SIGNAL AND LIGHTING PLAN **INTERSECTION 3** SCALE : NONE

> CU #### EA 03-0E961 SHEET

REPARED UNDER THE SUPERVISION OF

1/28/2025 DATE:

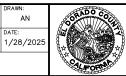

COUNTY OF EL DORADO DEPARTMENT OF TRANSPORTATION

DIAMOND SPRINGS PARKWAY PHASE 1B

E-9 125 of 136 72334

PROJECT NOTES (FOR THIS SHEET ONLY):		DIST COUNTY ROUTE KILOMETER POSTS SHEET TOTAL 0.3 ED 49 11.86/12.4 126 136 The state of California or its officers or agents shall not be responsible for the accuracy or completeness of electronic copies of this plan sheet
1 EXIST 3"C, 3#4/0 AL (SERVICE) & 4"C (TELEPHONE)		
2 INSTALL PB AT EXISTING SERVICE TERMINATION. CAP 4"C (TELEPHONE) SERVICE. SPLICE 3#4/0 AL (SERVICE)		
TO EXISTING WIRE. 3 3"C, 3#4/0 AL (SERVICE)		
4 2"C, 2#8 (240 V LIGHTING CIRCUIT 2)		
4 2 σ, 2πσ (21σ V ΕΙστιπίο σποστί 2)		
<u>LEGEND</u>		
DECORATIVE PARKING LOT LIGHT, HOLOPHANE GRANVILLE LED POST-TOP ACORN (MODEL No. GVD3-P50-40K-MVOLT-SPL-GL5-BK-XX-PN-TBK), OR APPROVED EQUAL. SEE SHEET E-14 FOR DETAILS.		
OR APPROVED EQUAL. SEE SHEET E-14 FOR DETAILS.		
	/	
	39700	38+00
OD LINE' - 41+00	40+00	
	STOP	4
4		
\$66	BP: 1+00.08 1	
43+00		. — F — — — —
		F
5S SS SS SS SS	MISSOURI FLAT ROAD	65+00
55 - 55	63+00 + 64+00 + 64+00	
FO FO	SS	
	THIS SHEET ACCURATE FOI	PARKING LOT LIGHTING PLAN SCALE: 1" = 20" CU #### EA 03-0E961
PREPARED UNDER THE	COUNTY OF EL DORADO	DIAMOND SPRINGS PARKWAY E-10
No. C71517	DH 1/28/2025 DEDARTMENT OF TRANSPORTATION	PHASE 1B 126 of 136 w.o. No. 72334
UMBER DATE DESCRIPTION BY	- Control of the cont	25-0053 Revised F 48 of 58

- ASSET TABLES ARE PROVIDED FOR REFERENCE ONLY AND ARE NOT A BID ITEM.
- 2. THE ENGINEER WILL SUPPLY REQUESTED INFORMATION IN THE SPACES PROVIDED FOR THE AS-BUILT RECORD.
- 3. COORDINATES MUST BE PROVIDED IN DECIMAL FORMAT TO SIX DECIMAL PLACES.

LEGEND:

- P = TRAFFIC SIGNAL (SIGNAL TYPE)
- S = SURVEILLANCE CAMERA CCTV (SIGNAL TYPE)
- U = VEHICLE DETECTION SYSTEMS CENSUS (SIGNAL TYPE)
- V = VEHICLE DETECTION SYSTEMS TMS (SIGNAL TYPE)
- Z = NO MVP PRESENT (MVP DISPOSITION)
- E = SIGNAL AND LIGHTING COMBO POLE (LIGHT TYPE)
- LED = LIGHT EMITTING DIODE (FIXTURE TYPE)

The state of California or its officers or agents shall not be responsible for the accuracy or completeness of electronic copies of this plan sheet

SIGNAL ASSET IN/MODIFY TABLE

ASSET No.	TMS ID	ASSET TYPE	SIGNAL TYPE	SHEET No.	MODIFY OR NEW	CTID	CABINET TYPE	INCLUDES MVP?	ASSET TOTAL WATTS	MOUNT TYPE	CABINET LATITUDE	CABINET LONGITUDE	COMMENTS
EC056	5314	TRAFFIC SIGNAL	Р	E-7,8,9	NEW	03250490012290	342LX	Z	1000	N/A			
TV314	5315	CCTV	S	E-7,8	NEW	03250490012290	342LX	Z	100	N/A			

LIGHTING ASSET IN/MODIFY TABLE

ASSET No.	SHEET No.	MODIFY OR NEW	CTID	LIGHT TYPE	POLE TYPE	BASE TYPE	MAST ARM LENGTH	FIXTURE TYPE	DESIGN FIXTURE WATTAGE	INSTALLED FIXTURE WATTAGE	LATITUDE	LONGITUDE	COMMENTS
C850	E-7,8	NEW	03250490012290	E	19A-4-100	FIXED	15	LED	235				
C851	E-7,8	NEW	03250490012290	E	19A-3-100	FIXED	15	LED	235				
C852	E-7,8	NEW	03250490012290	E	26A-3-100	FIXED	15	LED	235				
C853	E-7,8	NEW	03250490012290	E	24A-3-100	FIXED	15	LED	235				

SERVICE EQUIPMENT IN/MODIFY/OUT TABLE

CTID	SHEET No.	NEW MODIFY OR REMOVE?	MAINTENANCE RESPONSIBILITY	UTILITY ACCOUNT OWNER	SUBPANEL?	CABINET TYPE	PHASE/WIRE	INPUT VOLTAGE	OUTPUT VOLTAGE	TRANSFORMER STEP UP/DOWN & KVA	UTILITY CO.	METER No.	ACCOUNT No.	LATITUDE	LONGITUDE	COMMENTS
03250490012290	E-7,8,9	NEW	CALTRANS	EL DORADO COUNTY	N	III-AF	1/3	120/240	120/240	N/A	PGEC					

SIGNAL AND LIGHTING DETAILS

THIS SHEET ACCURATE FOR ELECTRICAL WORK ONLY

SCALE : NONE CU #### EA 03-0E961

DIAMOND SPRINGS PARKWAY PHASE 1B


E-11 127 of 136 72334

SHEET

REPARED UNDER THE SUPERVISION OF :

AN HECKED: 1/28/202 DH 1/28/2025 DATE: OAD NUMBER:



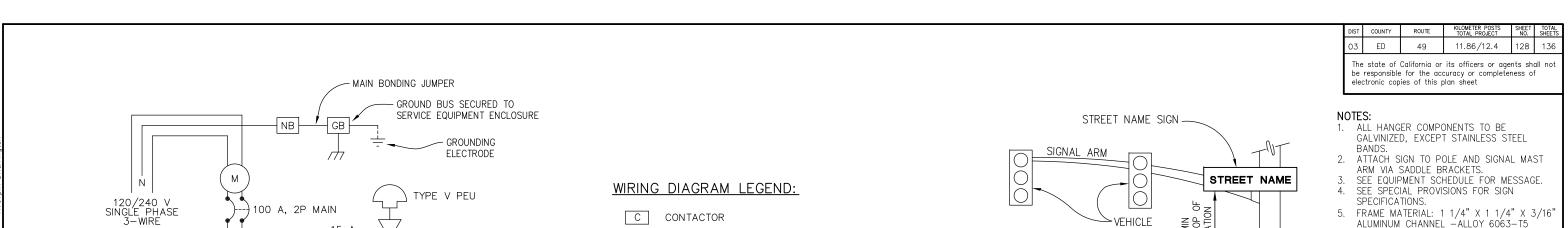


GROUND BUS

NEUTRAL BUS

METER SOCKET

NB

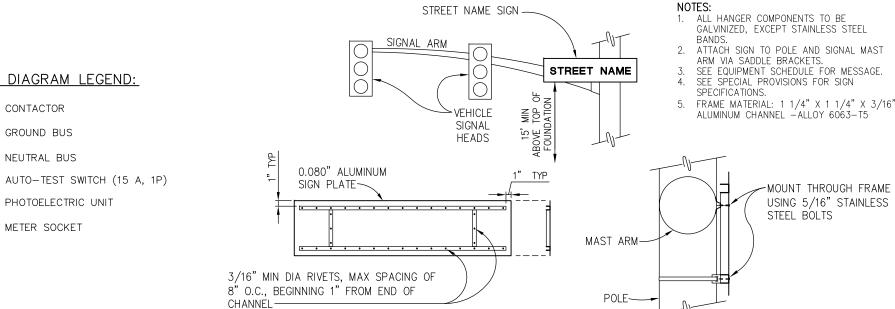

STREET NAME SIGN MOUNTING DETAIL

NO SCALE

INTERSECTION 1 SERVICE EQUIPMENT WIRING DIAGRAM

15 A, 2P

15 A, 2P

SIGNAL

CCTV

SPARE

50 A


15 A

20 A

NO SCALE

LIGHTING CIRCUIT 1 (240 V)

LIGHTING CIRCUIT 2 (240 V)

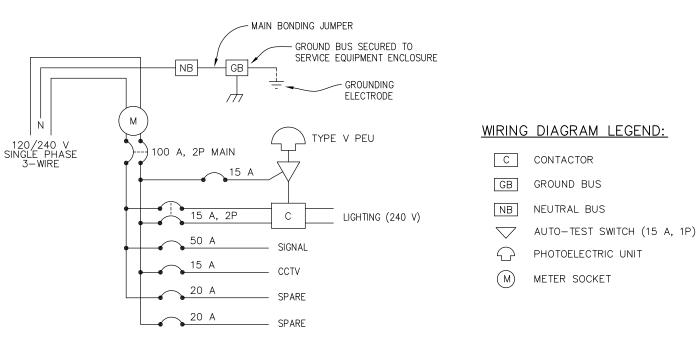

INTERSECTIONS 2 & 3 SERVICE EQUIPMENT WIRING DIAGRAM

NO SCALE

SIGNAL AND LIGHTING DETAILS SCALE : NONE

THIS SHEET ACCURATE FOR ELECTRICAL WORK ONLY

DIAMOND SPRINGS PARKWAY PHASE 1B

E-12 128 of 136 72334

SHEET


EA 03-0E961

EPARED UNDER THE SUPERVISION OF AN HECKED: 1/28/202 DH 1/28/2025 DATE: OAD NUMBER:




COUNTY OF EL DORADO DEPARTMENT OF TRANSPORTATION

CU ####

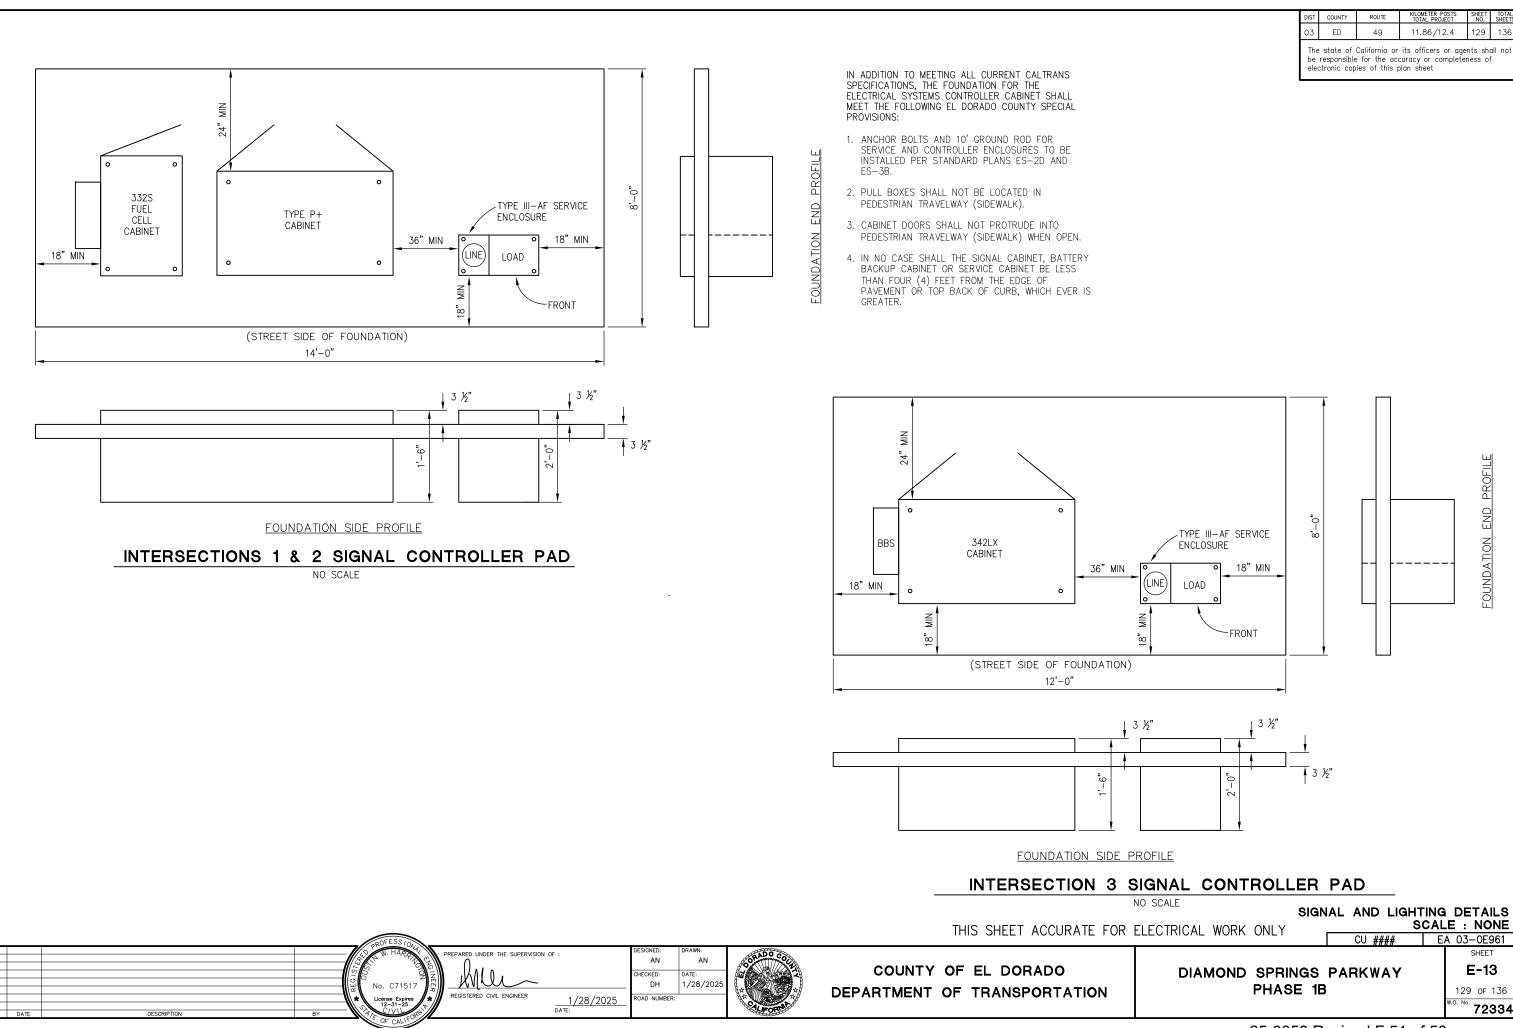


129 of 136 72334

The state of California or its officers or agents shall not be responsible for the accuracy or completeness of electronic copies of this plan sheet

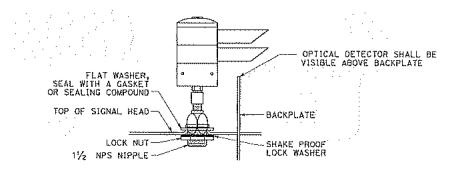


OPTICAL DETECTOR MOUNTING FOR EMERGENCY VEHICLE DETECTION

NO SCALE

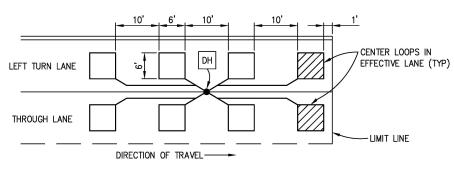


TYPICAL DETECTOR LOOP LAYOUT NO SCALE

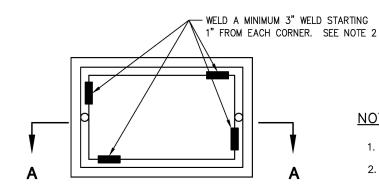

TOP VIEW

NOTES ON PULL BOXES:


- 1. FOR ADDITIONAL DETAILS, SEE STANDARD PLAN ES-8B.
- PULL BOXES SHALL NOT BE WELDED, RATHER SHALL USE SECURITY BITS (BRYCE FASTENERS PENTA PLUS 1/2-13 HI TORQUE P62 OR EQUAL).
- A PULL BOX FOR A POST OR A POLE STANDARD MUST BE LOCATED WITHIN 5 FEET OF THE STANDARD.

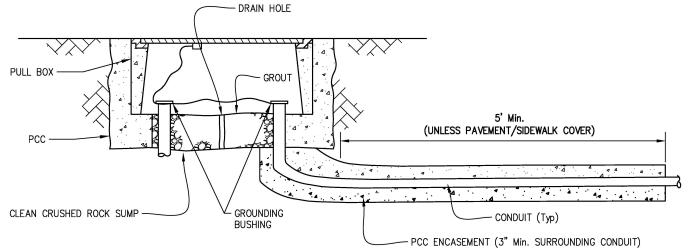

SECTION A-A

TRAFFIC PULL BOX

NO SCALE

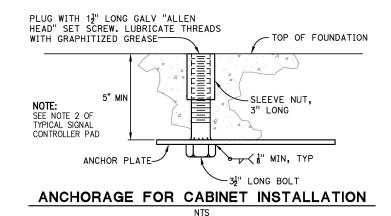

NOTE:
TYPE C RAMP SHOWN, OTHER
TYPES SIMILAR

TYPICAL PPB LOCATION DETAIL

NO SCALE

SIGNAL AND LIGHTING DETAILS SCALE : NONE

THIS SHEET ACCURATE FOR ELECTRICAL WORK ONLY

S DADKWAY

CU ####

DIAMOND SPRINGS PARKWAY PHASE 1B

E-14 130 of 136 w.o. No. 72334

SHEET

EA 03-0E961

NIMBER DATE

DESCRIPTION

ROPESS 10M

ROPE

PREPARED UNDER THE SUPERVISION OF :

AN

CHECKED:
DH

REGISTERED CIVIL ENGINEER


1/28/2025

RAN

RAN


CHECKED:
DH

ROAD NUMBER

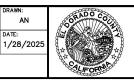


COUNTY OF EL DORADO
DEPARTMENT OF TRANSPORTATION

The state of California or its officers or agents shall not be responsible for the accuracy or completeness of electronic copies of this plan sheet

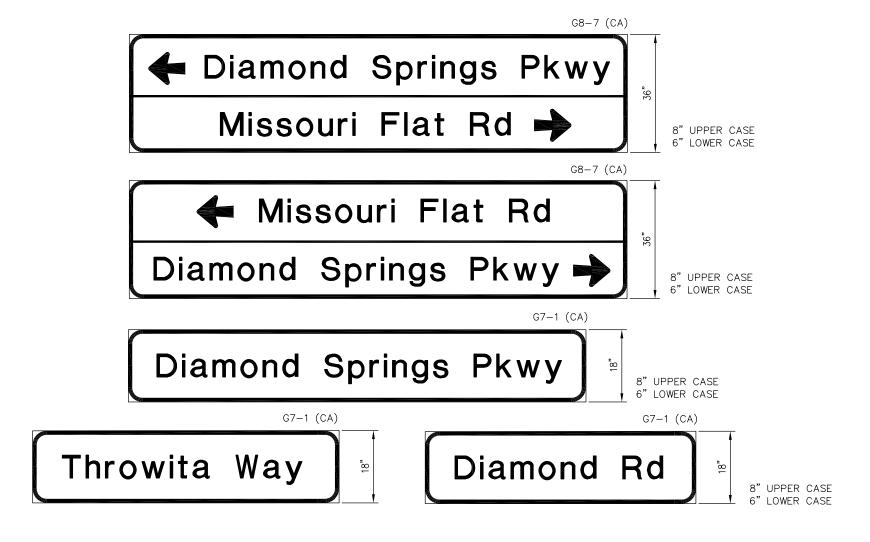

PARED UNDER THE SUPERVISION OF

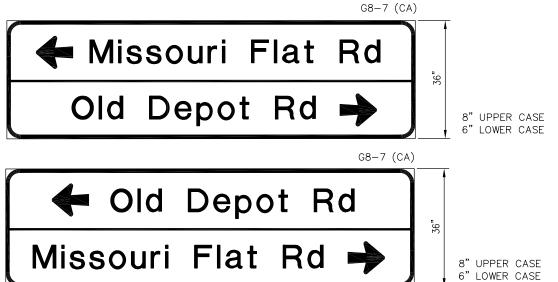

STREET NAME SIGN PANELS

HECKED:

DH

OAD NUMBER:

1/28/202

NO SCALE

THIS SHEET ACCURATE FOR ELECTRICAL WORK ONLY

COUNTY OF EL DORADO


DEPARTMENT OF TRANSPORTATION


SIGNAL AND LIGHTING DETAILS SCALE : NONE EA 03-0E961


DIAMOND SPRINGS PARKWAY PHASE 1B


E-15 131 of 136 72334

25-0053 Revised F 53 of 58

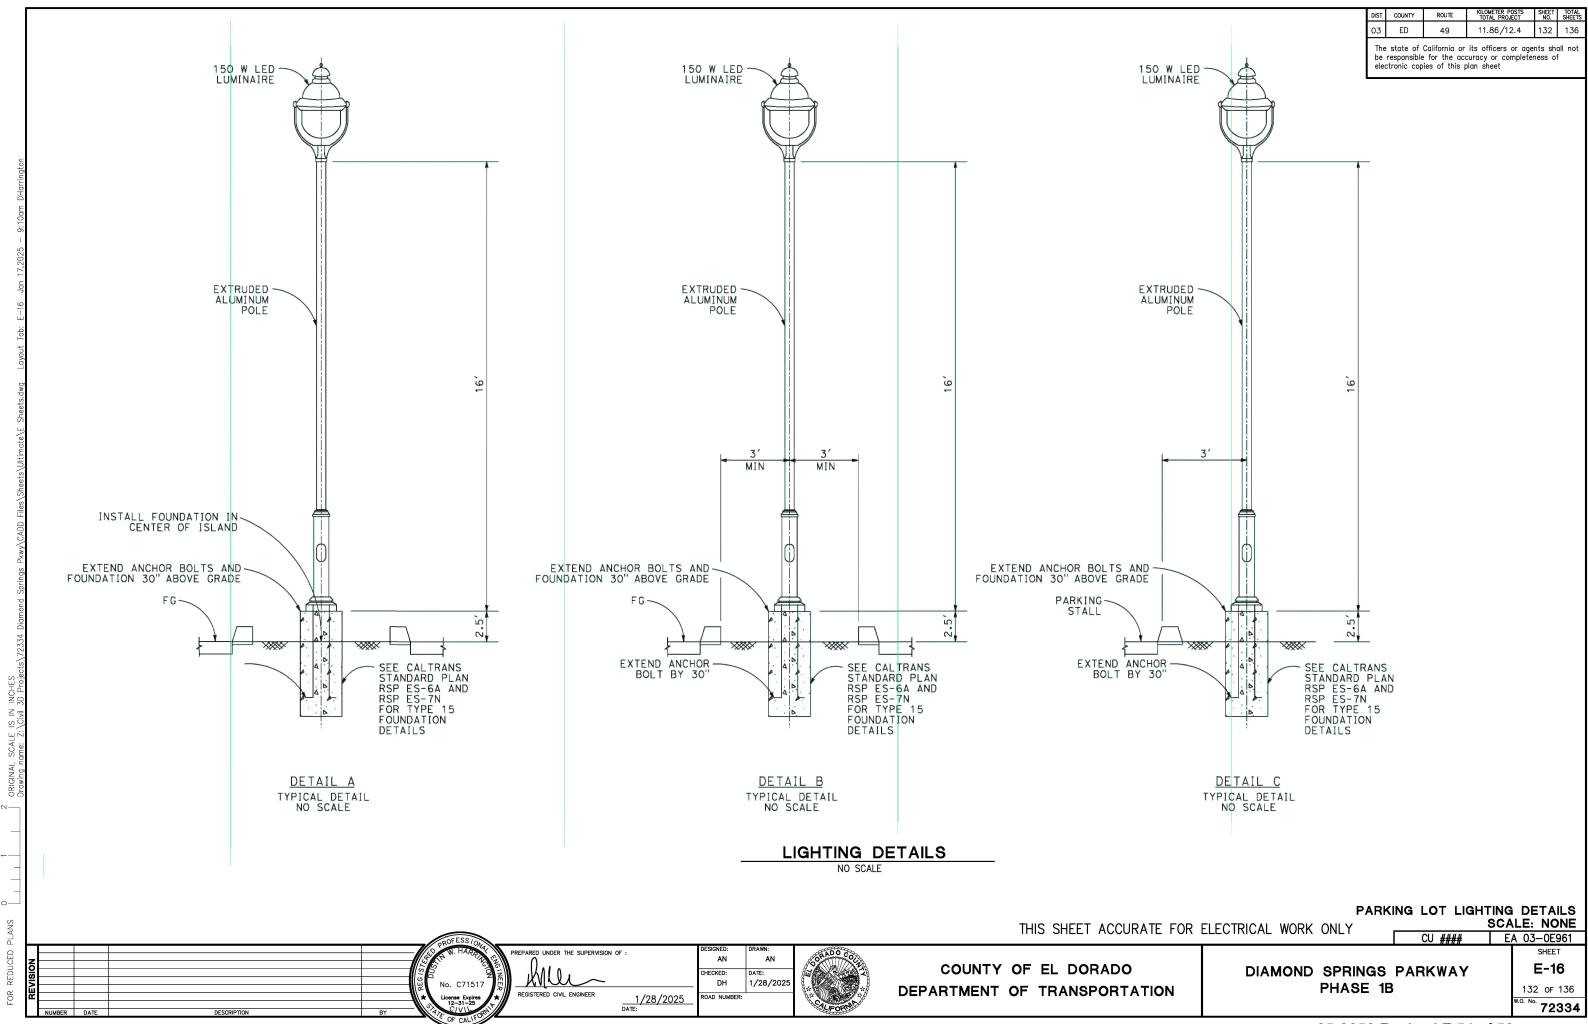


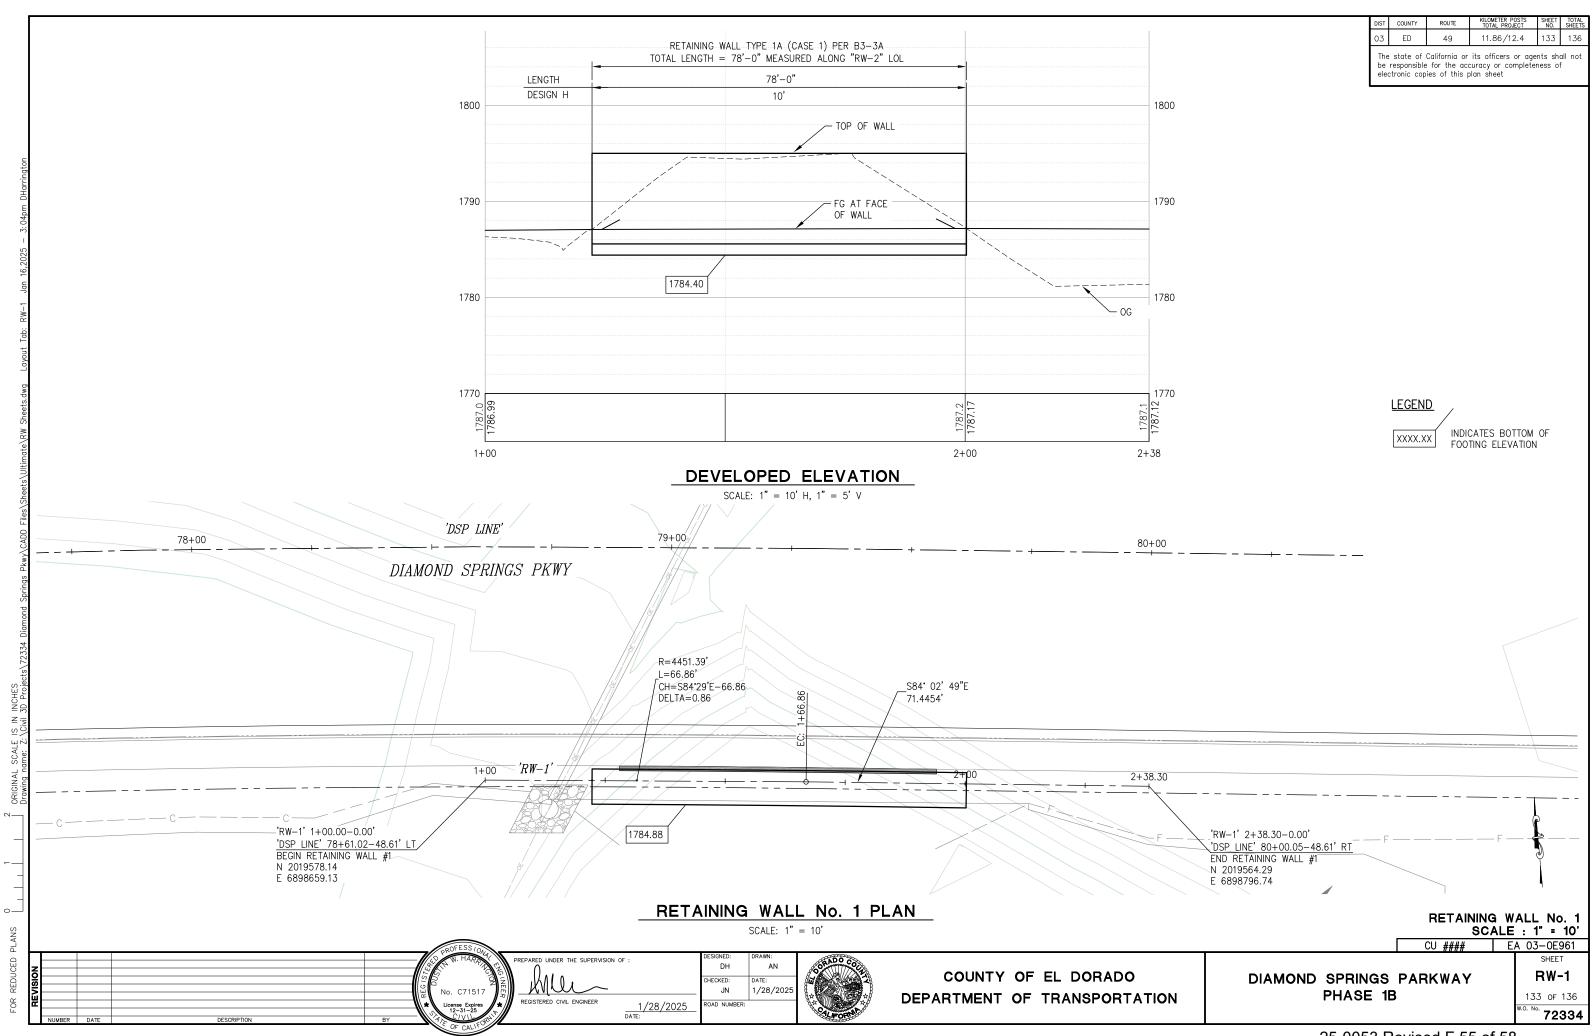

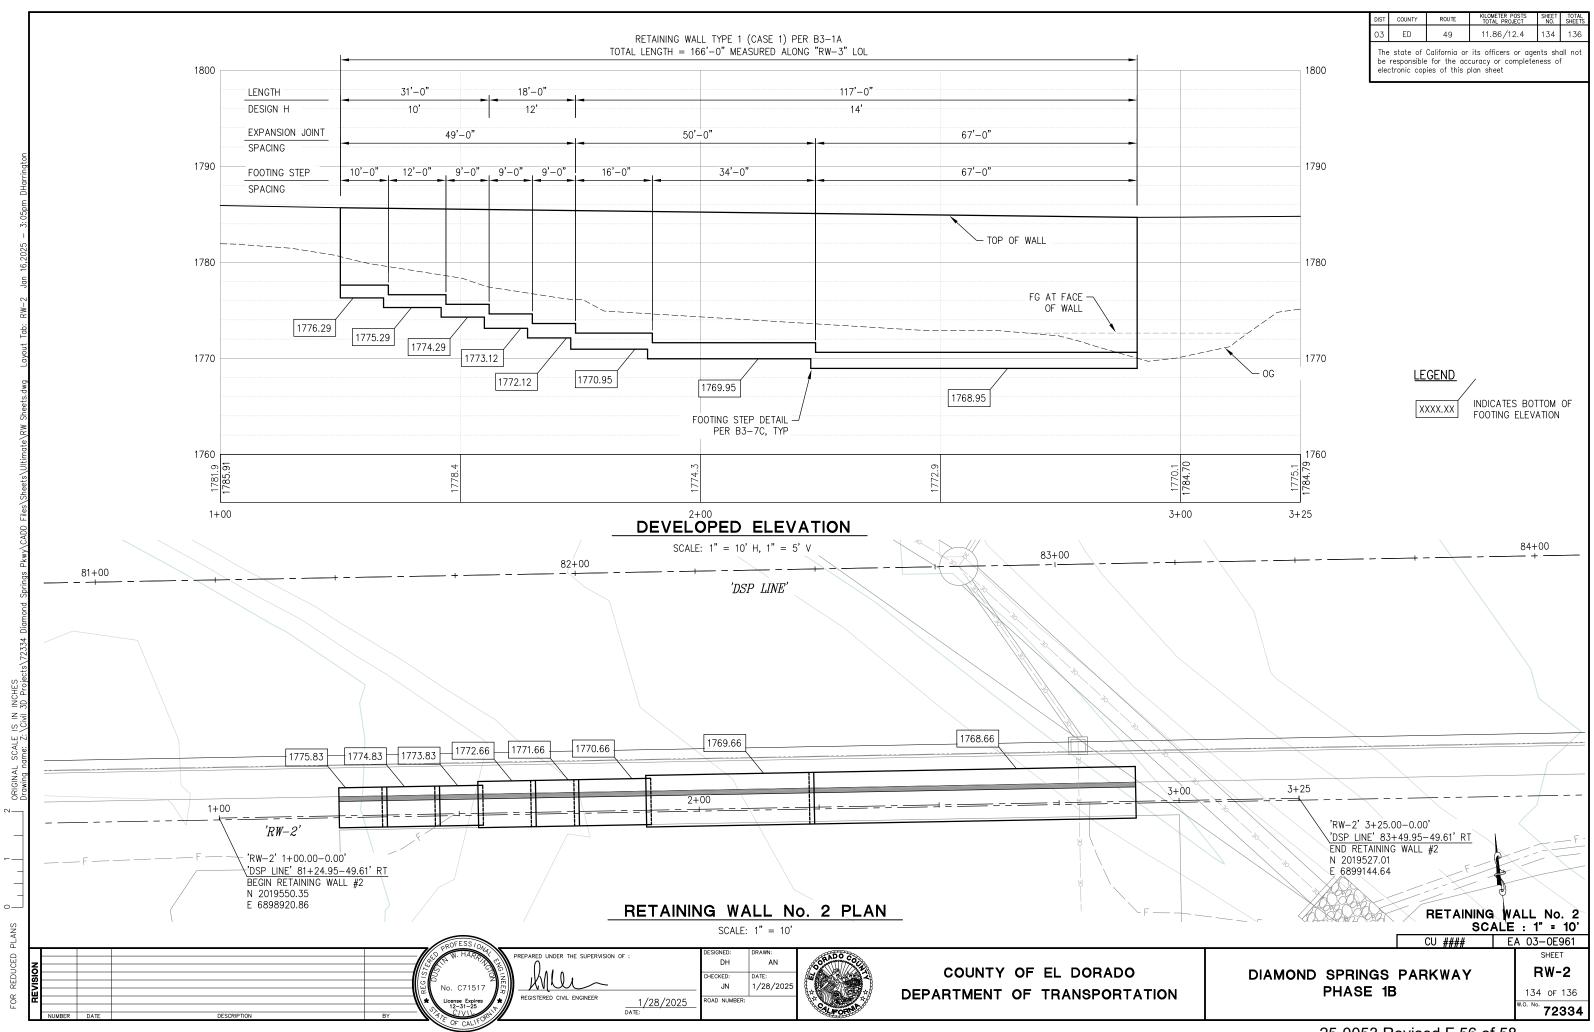

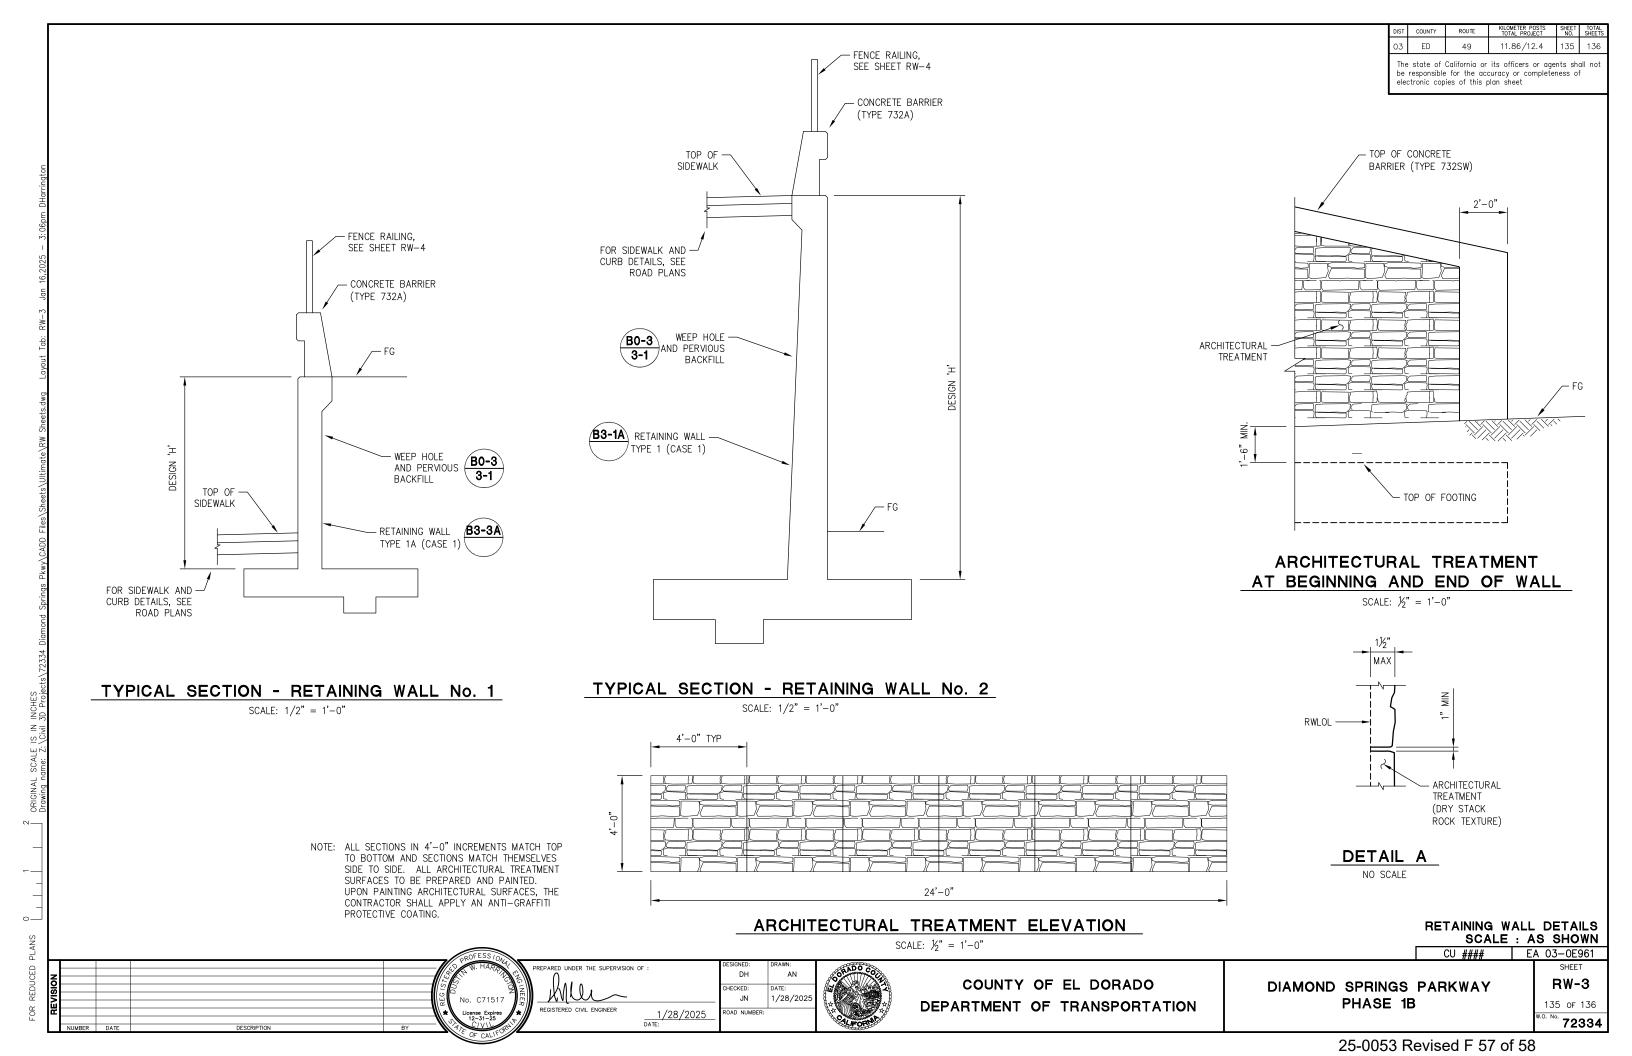

The state of California or its officers or agents shall not be responsible for the accuracy or completeness of electronic copies of this plan sheet

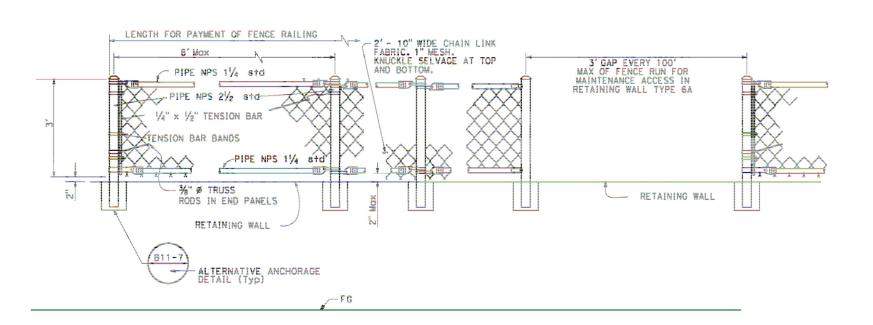

FENCE RAILING DETAIL

NO SCALE

RETAINING WALL DETAILS SCALE : NONE

CU #### EA 03-0E961 SHEET

DIAMOND SPRINGS PARKWAY
PHASE 1B

RW-4
136 OF 136
W.O. No. 72334

1/28/202