

HORIZONTAL DATUM

DENOTES TARGET LOCATION AND ELEVATION

BEARINGS, DISTANCES, STATIONING AND COORDINATES SHOWN ARE ON THE CALIFORNIA STATE COORDINATE SYSTEM, NAD 83 ZONE 2 (2007.00). DISTANCES SHOWN ARE GRID DISTANCES. DIVIDE DISTANCES SHOWN BY 0.9996402 TO OBTAIN GROUND DISTANCES.

VERTICAL DATUM

ELEVATIONS SHOWN HEREON ARE REFERENCED TO NGVD 1988 FROM GPS OBSERVATIONS

ALIGNMENT DATA						
NUMBER	LENGTH	RADIUS	LINE / CHORD DIRECTION & LENGTH DELTA			
L1	45.22		S 52° 19' 53" E			
L2	43.54		S 78° 30′ 40″ E			
L3	49.87		S 69° 33′ 06″ E			
L4	47.63		S 82° 43′ 00″ E			
L5	63.90		S 77° 01' 17" E			
C1	21.04	60.00	S 66° 58′ 24″ E - 20.94	20* 05' 46"		
L6	141.50		S 56° 55' 31" E			
C2	26.22	40.00	S 38° 08′ 38″ E – 25.76	37° 33' 45"		
L7	56.69		S 19° 21′ 46″ E			
С3	10.37	60.00	S 14° 24' 43" E - 10.36	09* 54' 06"		
L8	16.00		S 09° 27′ 40″ E			
C4	8.17	30.00	S 17* 15' 45" E - 8.14	15° 36' 10"		
L9	33.89		S 25° 03′ 50″ E			

CONTROL TABLE							
CONTROL NUMBER	NORTHING	EASTING	ELEVATION	DESCRIPTION			
30	2131608.70	7020943.45	5835.92	CP GC			
31	2131428.25	7020955.16	5840.90	CP GC			
32	2131427.41	7021019.61	5847.74	AUX CP GC32			

SURVEY CONTROL DIAGRAM SCALE : 1" = 40'

In a Manaro





EL DORADO COUNTY DEPARTMENT OF TRANSPORTATION


WENTWORTH SPRINGS ROAD at GERLE CREEK BRIDGE REPLACEMENT PROJECT


SHEET CD-1 2 or 13 77118

11-0005.2C.2

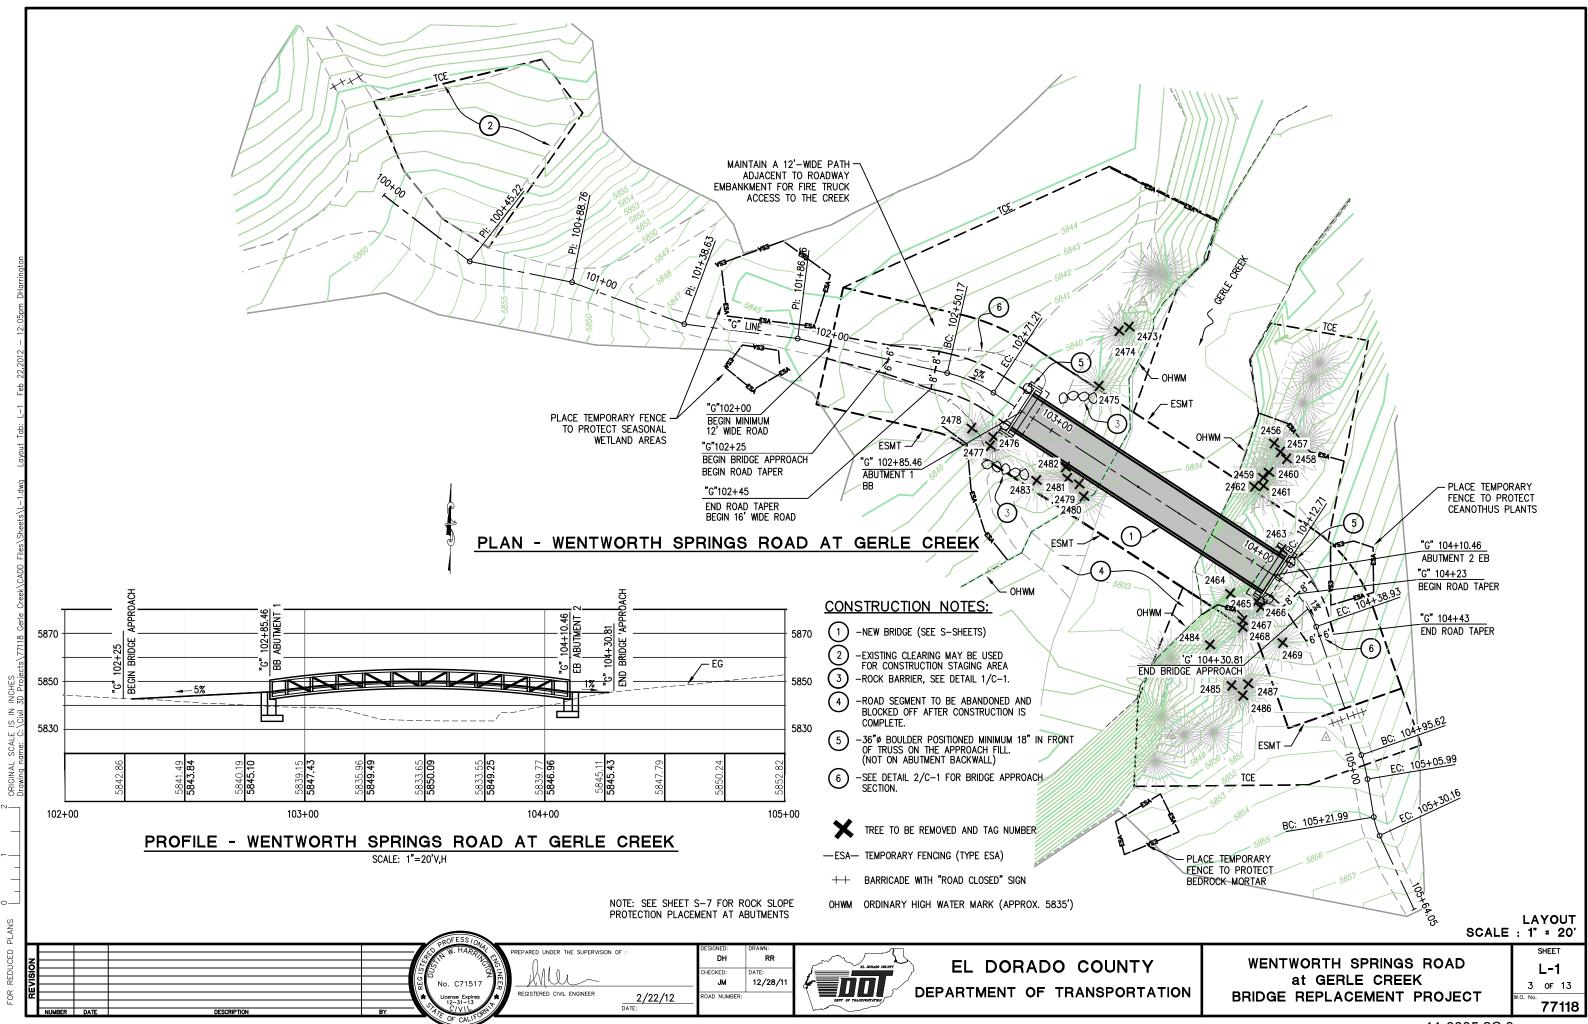

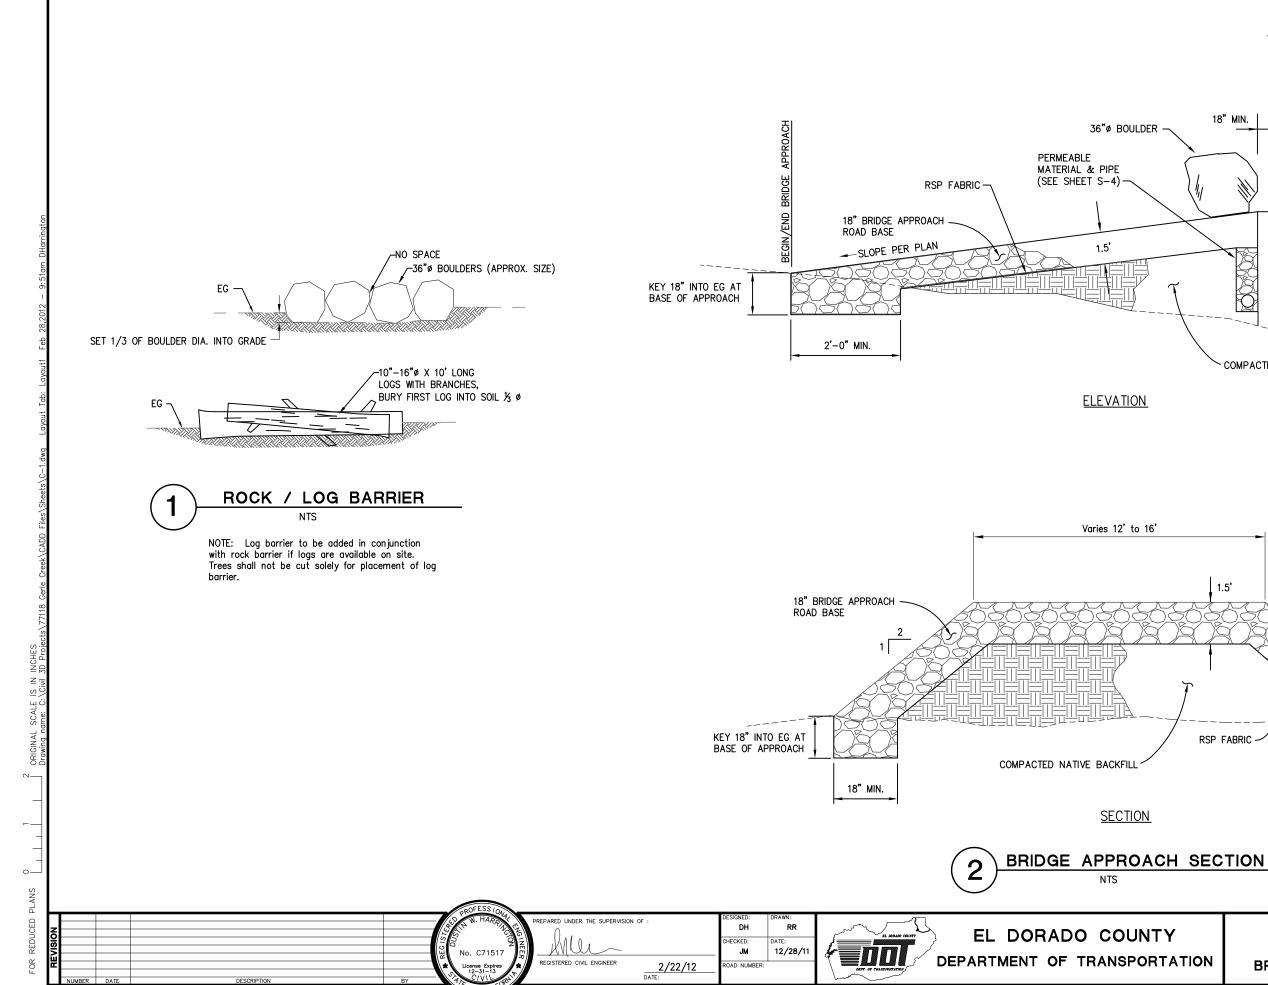

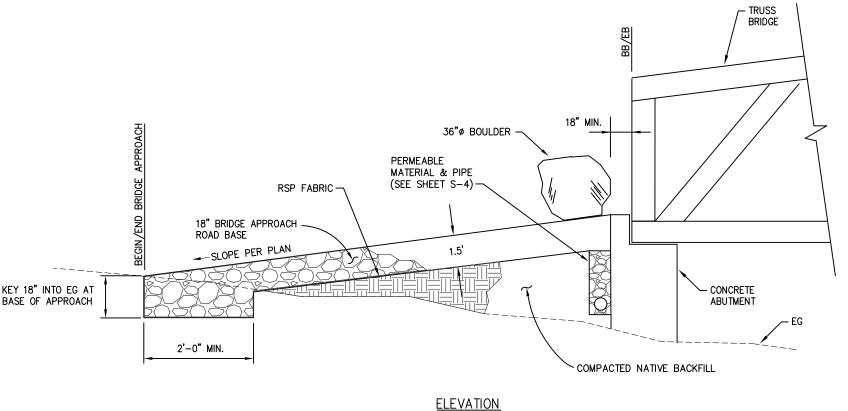

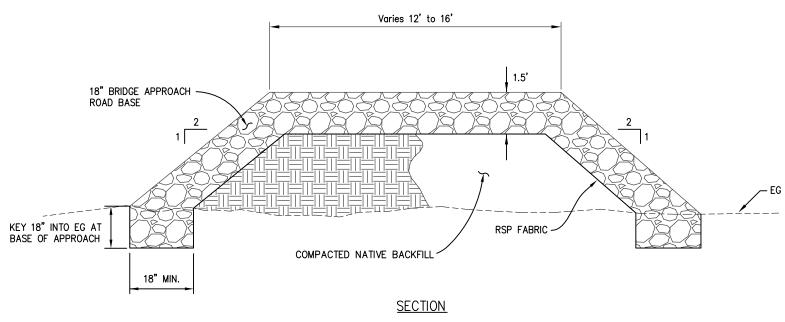



CONSTRUCTION DETAILS SCALE : NONE SHEET

WENTWORTH SPRINGS ROAD at GERLE CREEK BRIDGE REPLACEMENT PROJECT


4 of 13 77118

C-1

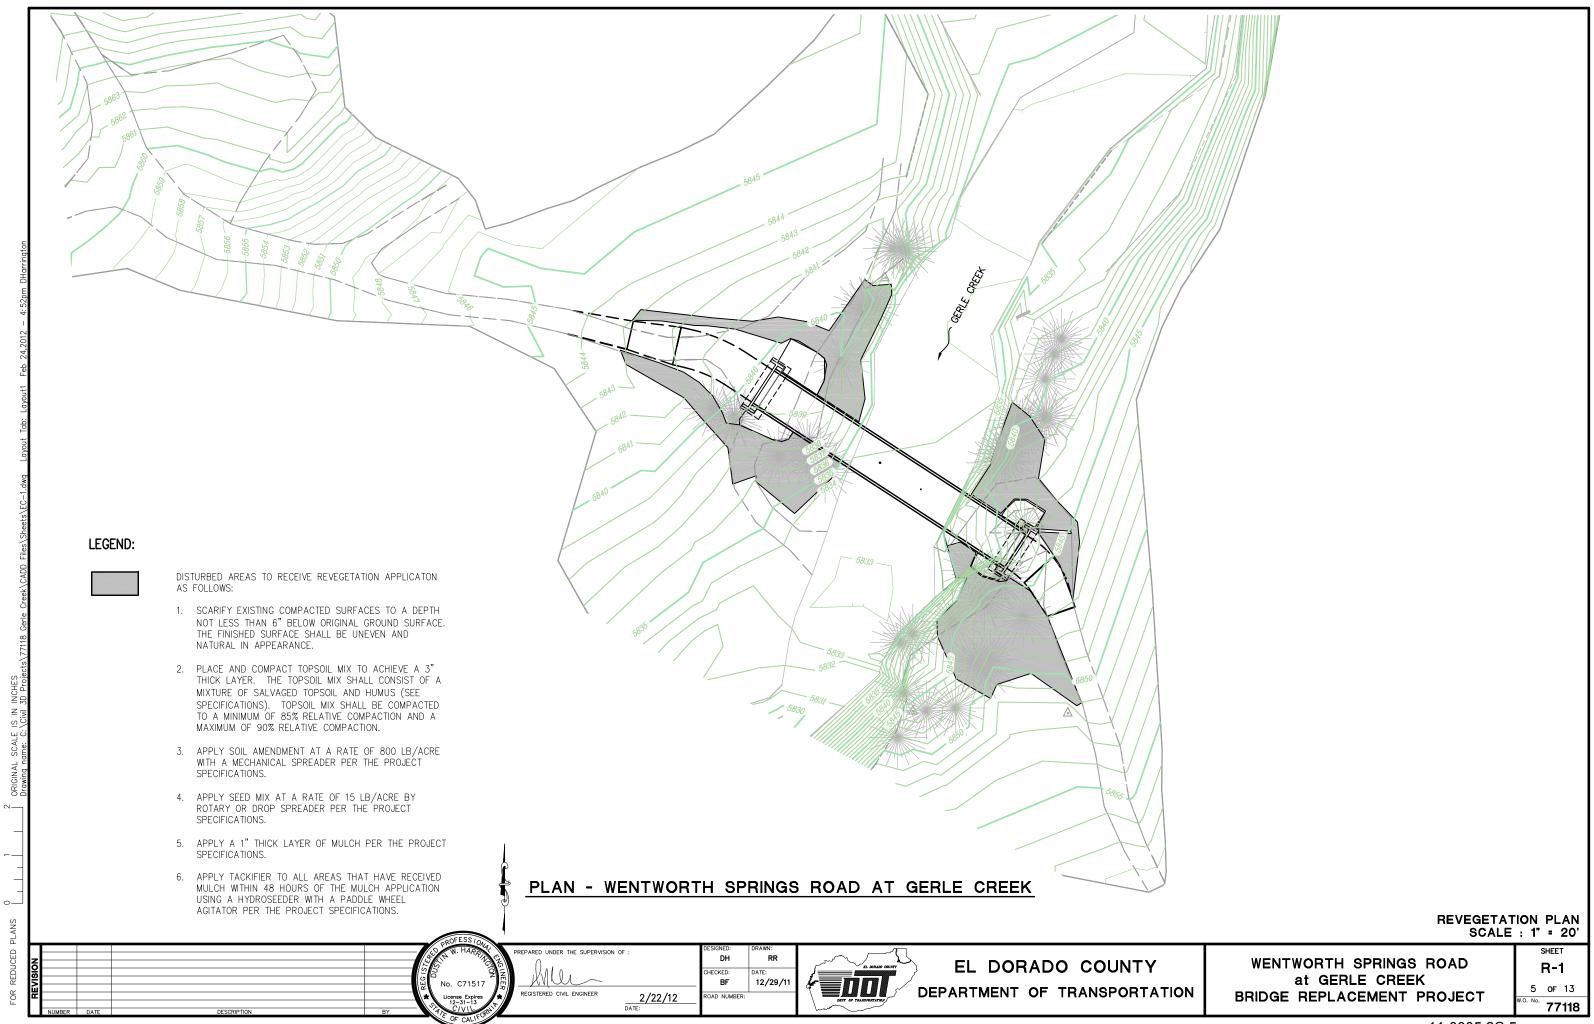

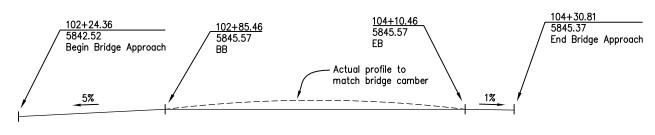


PROFILE GRADE 1" = 20'

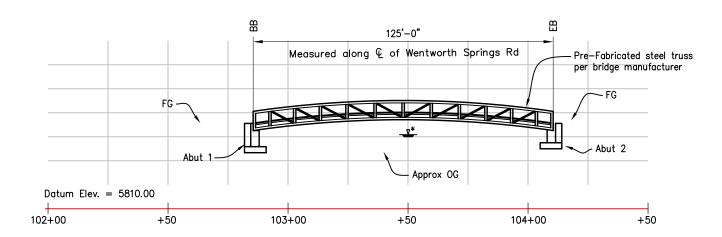


ELEVATION

1" = 20'

* Indicates 100-yr W.S.E. (5839.88)

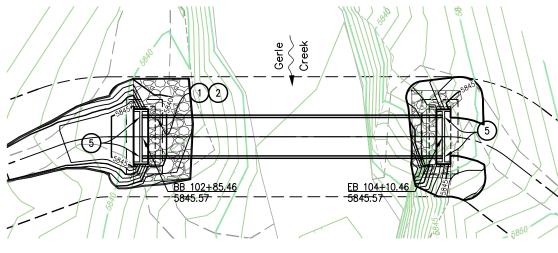



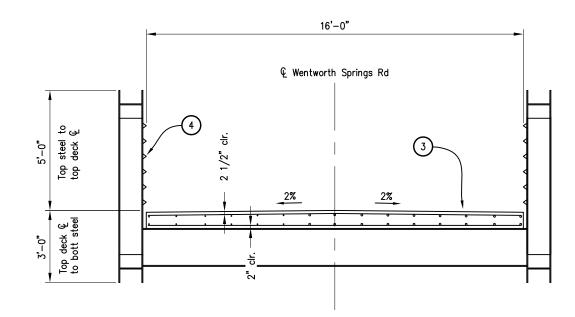

TYPICAL SECTION

1/2" = 1'

NOTES

1 Paint "Wentworth Springs Road"

2 Paint "Br. No. 25-0131"

Reinf. Concrete Slab Deck (design by bridge manufacturer).
All bridge deck reinforcing steel to be epoxy coated.

4 Angle Safety Rail

5 Object Marker (Type P), Mounted to Truss

INDEX TO PLANS

Sheet No.

S-1

S-2

Index to Plans

S-3

Foundation Plan

S-4

Abutment Layout

S-5

Abutment Details

S-6

Sidewall Details

S-7

Rock Slope Protection

Log of Test Borings

GENERAL PLAN

NUMBER DATE DESCRIPTION

DESIGNED: DRAWN:
DH. HARROUM PREPARED UNDER THE SUPERVISION OF:
DH. DH. DH.
CHECKED: RC 12/2/11
REGISTERED CIVIL ENGINEER 2/22/12
DATE:

DESIGNED: DRAWN:
DH. DH. DH.
CHECKED: RC 12/2/11
REGISTERED CIVIL ENGINEER 2/22/12
DATE:



EL DORADO COUNTY
DEPARTMENT OF TRANSPORTATION

WENTWORTH SPRINGS ROAD at GERLE CREEK BRIDGE REPLACEMENT PROJECT SHEET
S-1
6 OF 13
77118

GENERAL NOTES

DESIGN: AASHTO LRFD Bridge Design Specifications, 3rd Edition with

interims through 2006 and the Caltrans Amendments v3.06.01 except that the abutments are designed using Bridge Design

Specifications (LFD Version, April 2000).

SEISMIC DESIGN: CALTRANS Seismic Design Criteria (SDC), Version 1.4, June 2006.

DEAD LOAD: No allowance for future wearing surface.

LIVE LOADING: HL-93 and permit design load.

SNOW LOAD:

SEISMIC

LOADING: SDC ARS Curve for Soil Profile Type D

Site Specific Calculated Spectra Curve


West Tahoe - Dollar Point Fault, Magnitude = 7.0


REINFORCED

CONCRETE: Fy = 60 ksi

f'c = 3.6 ksin = 8

ACCELERATION RESPONSE SPECTRA CURVE

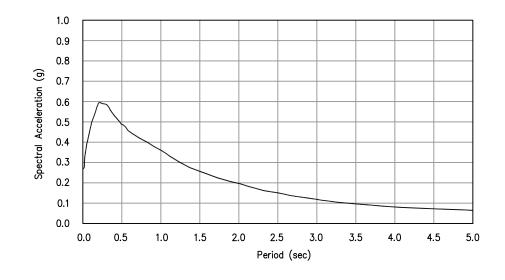

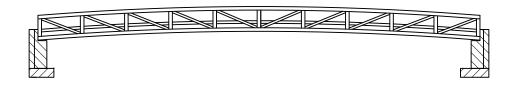

Abutment 1

Abutment 2

CONCRETE TYPE AND LIMITS

NO SCALE

Structural Concrete, Bridge

Structural Concrete, Bridge Footing

STANDARD PLANS DATED MAY 2006

A10A ACRONYMS AND ABBREVIATIONS (A-L) A10B ACRONYMS AND ABBREVIATIONS (M-Z)

A10C SYMBOLS (Sheet 1 of 2) SYMBOLS (Sheet 2 of 2) A10D

LIMITS OF PAYMENT FOR EXCAVATION AND BACKFILL - BRIDGE A62C BRIDGE DETAILS

B0-3

STANDARD PLAN SHEET No.

INDEX TO PLANS

2/22/12 DATE:



BRIDGE SUPPORT REACTIONS

Abut 1

200

107 (HL-93)

215 (P-15)

291 (Snow)

90

20 (Lateral)

6 (Uplift)

Loading Type

Vertical Dead Load

Vertical Live Loads

Seismic Load

Wind Loads

DH

RC

DAD NUMBER

12/2/11

HECKED:

Maximum Design Reactions (kips)

Abut 2

200

107 (HL-93)

215 (P-15)

291 (Snow)

90

20 (Lateral)

6 (Uplift)

EL DORADO COUNTY DEPARTMENT OF TRANSPORTATION

WENTWORTH SPRINGS ROAD at GERLE CREEK BRIDGE REPLACEMENT PROJECT

SHEET S-2 7 of 13 77118

