



at&t

SITE NUMBER: CVL03175 SITE NAME: PILOT HILL 2

3100 TRIPLE SEVEN RD
COOL, CA 95614

PROPRIETARY INFORMATION
THE INFORMATION CONTAINED IN THIS SET OF DRAWINGS IS PROPRIETARY BY NATURE. ANY USE OR DISCLOSURE OTHER THAN THAT WHICH RELATES TO PEEK SITE-COM IS STRICTLY PROHIBITED

CLIENT:



5001 EXECUTIVE PKWY
SAN RAMON, CA 94583

PROJECT INFORMATION:

PILOT HILL 2

3100 TRIPLE SEVEN RD
COOL, CA 95614

REV: DATE: DESCRIPTION: BY:

1	6-19-17	90% ZONING DOC'S	RB
2	8-14-17	100% ZONING DOC'S	RB

COORDINATING ENGINEER:

Peek Site-Com

12852 Earhart Ave. Suite 101
Auburn, California 95602
Phone (530) 885-6160

E-Mail info@peeksitecom.com

SEAL:



SITE #: CVL03175 CHK.: ... DRAWN BY: RB

SHEET TITLE: TITLE SHEET

SHEET NUMBER: T-1 REVISION: 0

TITLE SHEET

SHEET NUMBER: T-1 REVISION: 0

T-1 0

PROJECT INFORMATION

APPLICANT:
AT&T MOBILITY
5001 EXECUTIVE PKWY
SAN RAMON, CA 94583

CONSTRUCTION MANAGER:

PETE MANAS
EPIC WIRELESS
8700 AUBURN FOLSOM ROAD, SUITE 400
GRANITE BAY, CA 95746
(530) 383-5957

SITE SURVEY:

GEIL ENGINEERING
1226 HIGH STREET
AUBURN, CA 95603
(530) 885-0426

RF ENGINEER:

ASAD SHAHBAZ
MS455V@ATT.COM

RFDS VERSION/DATE:
1.00.00 / 04-13-17

ENGINEERING FIRM:

PEEK SITE-COM
12852 EARHART AVE SUITE 101
AUBURN, CA 95602
(530) 885-6160

SITE ACQUISITION & PLANNING:

JARED KEARSLEY
EPIC WIRELESS
8700 AUBURN FOLSOM ROAD, SUITE 400
GRANITE BAY, CA 95746
(916) 755-1326

CIVIL VENDOR:

VINCULUMS CONSTRUCTION MANAGER
KEN ABEL
KABEL@VINCULUMS.COM
(916) 844-4602

PROJECT TEAM

SITE NAME:

SITE NUMBER:

FA LOCATION#:

SITE ADDRESS:

ASSESSORS PARCEL NUMBER:

LATITUDE:

LONGITUDE:

SITE ELEVATION:

ZONING:

JURISDICTION:

COUNTY:

PROPERTY OWNER:

OWNER ADDRESS:

PILOT HILL 2

CVL03175

13787607

3100 TRIPLE SEVEN RD
COOL, CA 95614

071-032-15-100

38.88983°

-120.9976°

1,621' AMSL

RE-5

EL DORADO COUNTY

EL DORADO

KIRK BRELSFOR

3100 TRIPLE SEVEN RD
COOL, CA 95614

SHEET INDEX

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TITLE SHEET

GENERAL NOTES

SITE SIGNAGE

SITE SURVEY

EROSION CONTROL PLAN & DETAILS

GRADING NOTES & DETAILS

GRADING PLAN

OVERALL SITE PLAN

EQUIPMENT PLAN

ANTENNA PLAN

DETAILS

ELEVATIONS


ELEVATIONS

CODE COMPLIANCE

ALL WORK AND MATERIALS SHALL BE PERFORMED AND INSTALLED IN ACCORDANCE WITH THE CURRENT EDITIONS OF THE FOLLOWING CODES AS ADOPTED BY THE LOCAL GOVERNING AUTHORITIES. NOTHING IN THESE PLANS IS TO BE CONSTRUED TO PERMIT WORK NOT CONFORMING TO THESE CODES.

- 2016 CALIFORNIA BUILDING CODE
- 2016 CALIFORNIA FIRE CODE
- 2016 CALIFORNIA ELECTRICAL CODE
- 2016 CALIFORNIA PLUMBING CODE
- 2016 CALIFORNIA MECHANICAL CODE
- 2016 CALIFORNIA HEALTH AND SAFETY CODE

VICINITY MAP

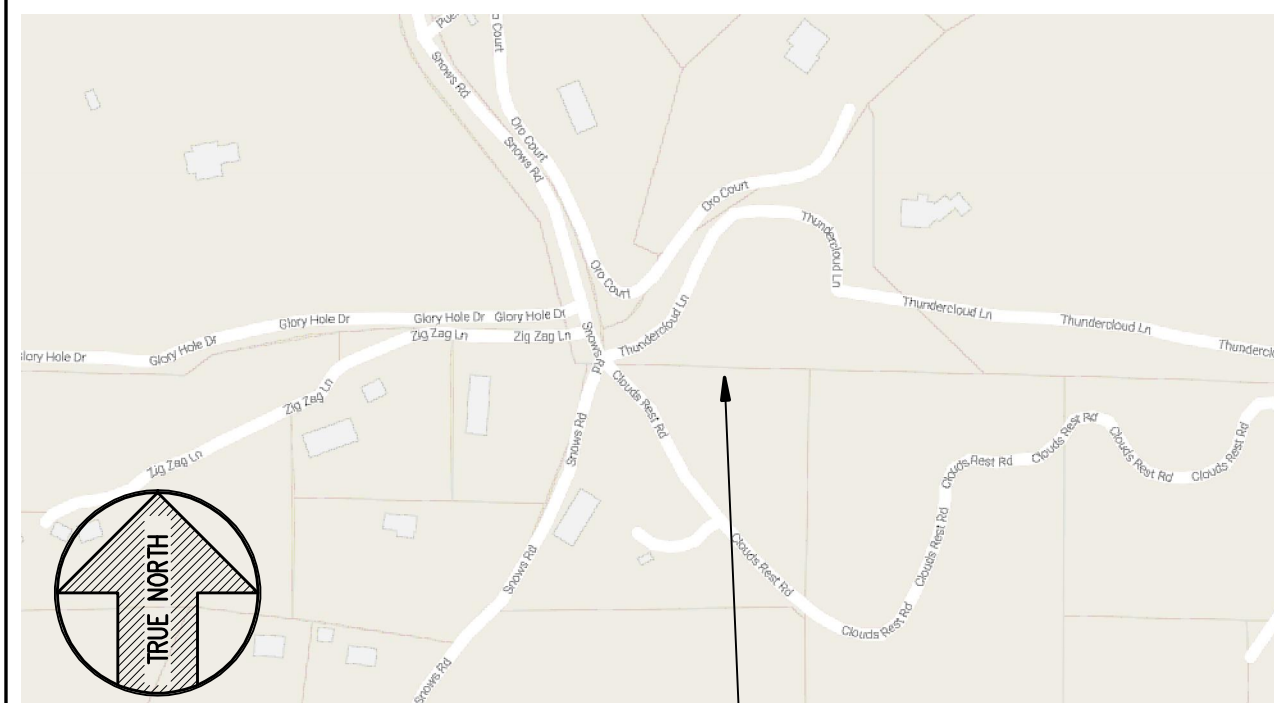

DIRECTIONS FROM AT&T

DIRECTIONS FROM AT&T'S OFFICE AT 5001 EXECUTIVE PARKWAY, SAN RAMON, CA 94583

- HEAD NORTHEAST ON BISHOP DR TOWARD SUNSET DR
- TURN RIGHT ONTO SUNSET DR
- USE THE RIGHT 2 LANES TO TURN RIGHT ONTO BOLLINGER CANYON RD
- USE THE RIGHT 2 LANES TO MERGE ONTO I-680 N VIA THE RAMP TO SACRAMENTO
- MERGE ONTO I-680 N
- KEEP LEFT TO STAY ON I-680 N
- KEEP LEFT AT THE FORK TO STAY ON I-680 N
- KEEP LEFT AT THE FORK TO CONTINUE ON I-680
- USE ANY LANE TO TAKE EXIT 71A TOWARD I-80 E/SACRAMENTO
- MERGE ONTO I-80 E
- KEEP LEFT AT THE FORK TO STAY ON I-80 E
- KEEP RIGHT AT THE FORK TO STAY ON I-80 E, FOLLOW SIGNS FOR RENO
- TAKE EXIT 119C FOR ELM AVE
- TURN LEFT ONTO ELM AVE (SIGNS FOR DOWNTOWN/AUBURN)
- TURN LEFT ONTO CA-49 S/EL DORADO ST/HIGH ST
- TURN RIGHT ONTO CA-193 E/CA-49 S/EL DORADO ST
- CONTINUE TO FOLLOW CA-193 E/CA-49 S
- TURN LEFT ONTO CA-193 E
- TURN RIGHT ONTO TRIPLE 7 RD

PROJECT DESCRIPTION

AT&T PROPOSES TO CONSTRUCT A NEW UNMANNED TELECOMMUNICATIONS FACILITY. AT&T WILL INSTALL:

- (1) NEW 12' WIDE GRAVEL ACCESS ROAD
- (1) NEW 36'X36' LEASE AREA
- (1) NEW 6' CHAIN LINK FENCE
- (1) NEW 12' WIDE DOUBLE ACCESS GATE
- (1) NEW CELL BLOCK FOUNDATION
- (1) NEW 113' MONOPINE (TOP OF BRANCHES @ ±120')
- (1) NEW PRE-FAB "WIC" LIGHT WEIGHT EQUIPMENT SHELTER WITH ANCILLARY INTERIOR EQUIPMENT
- (1) NEW GPS ANTENNA
- (1) NEW 35KW PROPANE GENERATOR
- (1) LP PROPANE TANK (500 GALLON)
- (12) NEW ANTENNAS
- (6) NEW RRUS-11, (10) NEW RRUS-32 & (3) NEW RRUS-12
- (4) NEW SURGE SUPPRESSORS
- (2) FUTURE 4' M/W DISH

OCCUPANCY & CONST. TYPE

OCCUPANCY: U (UNMANNED)

CONSTRUCTION TYPE: V-B

SPECIAL INSPECTIONS

*SEE SPECIAL INSPECTION FORM

- POST-INSTALLED ANCHORS
- HIGH STRENGTH BOLTING

Attachment 1
Site 1 Cool (formerly Pilot Hill 2)

ACCESSIBILITY REQUIREMENTS:
THIS FACILITY IS UNMANNED AND NOT FOR HUMAN HABITATION, HANDICAPPED ACCESS REQUIREMENTS ARE NOT REQUIRED IN ACCORDANCE WITH THE 2016 CALIFORNIA BUILDING CODE, CHAPTER 11B, EXCEPTION SECTION 11B-203.5

APPROVALS

APPROVED BY: INITIALS: DATE:

AT&T:		
VENDOR:		
R.F.:		
LEASING/LANDLORD:		
ZONING:		
CONSTRUCTION:		
POWER/TELCO:		
PG&E:		

GENERAL CONTRACTOR NOTES

DO NOT SCALE DRAWINGS

THESE DRAWINGS ARE FORMATTED TO BE FULL SIZE 24"X36". CONTRACTOR SHALL VERIFY ALL PLANS AND EXISTING DIMENSIONS AND CONDITIONS ON THE JOBSITE AND SHALL IMMEDIATELY NOTIFY THE ARCHITECT/ENGINEER IN WRITING OF ANY DISCREPANCIES BEFORE PROCEEDING WITH THE WORK OR MATERIAL ORDERS OR BE RESPONSIBLE FOR THE SAME.



GENERAL CONSTRUCTION NOTES:

1. DRAWINGS ARE NOT TO BE SCALED, WRITTEN DIMENSIONS TAKE PRECEDENCE, AND THIS SET OF PLANS IS INTENDED TO BE USED FOR DIAGRAMMATIC PURPOSES ONLY, UNLESS NOTED OTHERWISE. THE GENERAL CONTRACTOR'S SCOPE OF WORK SHALL INCLUDE FURNISHING ALL MATERIALS, EQUIPMENT, LABOR, AND ANYTHING ELSE DEEMED NECESSARY TO COMPLETE INSTALLATIONS AS DESCRIBED HEREIN.
2. PRIOR TO THE SUBMISSION OF BIDS, THE CONTRACTORS INVOLVED SHALL VISIT THE JOB SITE AND FAMILIARIZE THEMSELVES WITH ALL CONDITIONS AFFECTING THE PROPOSED PROJECT, WITH THE CONSTRUCTION AND CONTRACT DOCUMENTS, FIELD CONDITIONS AND CONFIRM THAT THE PROJECT MAY BE ACCOMPLISHED AS SHOWN PRIOR TO PROCEEDING WITH CONSTRUCTION. ANY ERRORS, OMISSIONS, OR DISCREPANCIES ARE TO BE BROUGHT TO THE ATTENTION OF THE ARCHITECT/ENGINEER.
3. THE GENERAL CONTRACTOR SHALL RECEIVE WRITTEN AUTHORIZATION TO PROCEED WITH CONSTRUCTION PRIOR TO STARTING WORK ON ANY ITEM NOT CLEARLY DEFINED BY THE CONSTRUCTION DRAWINGS/ CONTRACT DOCUMENTS.
4. THE CONTRACTOR SHALL SUPERVISE AND DIRECT THE PROJECT DESCRIBED HEREIN. THE CONTRACTOR SHALL BE SOLELY RESPONSIBLE FOR ALL CONSTRUCTION MEANS, METHODS, TECHNIQUES, SEQUENCES AND PROCEDURES AND FOR COORDINATING ALL PORTIONS OF THE WORK UNDER THE CONTRACT.
5. THE CONTRACTOR SHALL INSTALL ALL EQUIPMENT AND MATERIALS ACCORDING TO MANUFACTURER'S/ VENDOR'S SPECIFICATIONS UNLESS NOTED OTHERWISE OR WHERE LOCAL CODES OR ORDINANCES TAKE PRECEDENCE.
6. ALL WORK PERFORMED ON PROJECT AND MATERIALS INSTALLED SHALL BE IN STRICT ACCORDANCE WITH ALL APPLICABLE CODES, REGULATIONS, AND ORDINANCES. CONTRACTOR SHALL GIVE ALL NOTICES AND COMPLY WITH ALL LAWS, ORDINANCES, RULES, REGULATIONS AND LAWFUL ORDERS OF ANY PUBLIC AUTHORITY, MUNICIPAL AND UTILITY COMPANY SPECIFICATIONS, AND LOCAL AND STATE JURISDICTIONAL CODES BEARING ON THE PERFORMANCE OF THE WORK.
7. GENERAL CONTRACTOR SHALL PROVIDE AT THE PROJECT SITE A FULL SET OF CONSTRUCTION DOCUMENTS UPDATED WITH THE LATEST REVISIONS AND ADDENDUMS OR CLARIFICATIONS FOR THE USE BY ALL PERSONNEL INVOLVED WITH THE PROJECT.
8. THE STRUCTURAL COMPONENTS OF THIS PROJECT SITE/ FACILITY ARE NOT TO BE ALTERED BY THIS CONSTRUCTION PROJECT UNLESS NOTED OTHERWISE.
9. DETAILS INCLUDED HEREIN ARE INTENDED TO SHOW END RESULT OF DESIGN. MINOR MODIFICATIONS MAY BE REQUIRED TO SUIT JOB CONDITIONS OR SITUATIONS, AND SUCH MODIFICATIONS SHALL BE INCLUDED AS PART OF THE SCOPE OF WORK.
10. SEAL PENETRATIONS THROUGH FIRE-RATED AREAS WITH U.L. LISTED OR FIRE MARSHALL APPROVED MATERIALS IF APPLICABLE TO THIS FACILITY AND OR PROJECT SITE.
11. PROVIDE A PORTABLE FIRE EXTINGUISHER WITH A RATING OF NOT LESS THAN 2-A OR 2-A10BC WITHIN 75 FEET TRAVEL DISTANCE TO ALL PORTIONS OF THE PROJECT AREA DURING CONSTRUCTION.
12. THE CONTRACTOR SHALL MAKE NECESSARY PROVISIONS TO PROTECT EXISTING IMPROVEMENTS, EASEMENTS, PAVING, CURBING, ETC. DURING CONSTRUCTION. UPON COMPLETION OF WORK, CONTRACTOR SHALL REPAIR ANY DAMAGE THAT MAY HAVE OCCURRED DUE TO CONSTRUCTION ON OR ABOUT THE PROPERTY.
13. CONTRACTOR SHALL SEE TO IT THAT GENERAL WORK AREA IS KEPT CLEAN AND HAZARD FREE DURING CONSTRUCTION AND DISPOSE OF ALL DIRT, DEBRIS, RUBBISH AND REMOVE EQUIPMENT NOT SPECIFIED AS REMAINING ON THE PROPERTY. PREMISES SHALL BE LEFT IN CLEAN CONDITION AND FREE FROM PAINT SPOTS, DUST, OR SMUDGES OF ANY NATURE.
14. THE ARCHITECTS/ENGINEERS HAVE MADE EVERY EFFORT TO SET FORTH IN THE CONSTRUCTION AND CONTRACT DOCUMENTS THE COMPLETE SCOPE OF WORK. CONTRACTORS BIDDING THE JOB ARE NEVERTHELESS CAUTIONED THAT MINOR OMISSIONS OR ERRORS IN THE DRAWINGS AND OR SPECIFICATIONS SHALL NOT EXCUSE SAID CONTRACTOR FROM COMPLETING THE PROJECT AND IMPROVEMENTS IN ACCORDANCE WITH THE INTENT OF THESE DOCUMENTS. THE BIDDER SHALL BEAR THE RESPONSIBILITY OF NOTIFYING (IN WRITING) THE ARCHITECT/ENGINEER OF ANY CONFLICTS, ERRORS, OR OMISSIONS PRIOR TO THE SUBMISSION OF CONTRACTOR'S PROPOSAL. IN THE EVENT OF DISCREPANCIES THE CONTRACTOR SHALL PRICE THE MORE COSTLY OR EXTENSIVE WORK, UNLESS DIRECTED OTHERWISE.

ABBREVIATIONS

ABV.	ABOVE	L.F.	LINEAR FEET (FOOT)
ADD'L	ADDITIONAL	MAX.	MAXIMUM
A.G.L.	ABOVE GROUND LEVEL	M.B.	MACHINE BOLT
ALUM.	ALUMINUM	MECH.	MECHANICAL
APPROX.	APPROXIMATELY	MFR.	MANUFACTURER
AWG.	AMERICAN WIRE GAUGE	MIN.	MINIMUM
BLDG.	BUILDING	MISC.	MISCELLANEOUS
BLK.	BLOCKING	MTL	METAL
CAB.	CABINET	(N)	NEW
CONC.	CONCRETE	NO. (#)	NUMBER
CONN.	CONNECTION(OR)	N.T.S.	NOT TO SCALE
CONST.	CONSTRUCTION	O.C.	ON CENTER
CONT.	CONTINUOUS	P/C	PRECAST CONCRETE
DBL.	DOUBLE	PPC	POWER PROTECTION CABINET
DEPT.	DEPARTMENT	P.S.F.	POUNDS PER SQUARE FOOT
D.F.	DOUGLAS FIR	P.S.I.	POUNDS PER SQUARE INCH
DIA.	DIAMETER	P.T.	PRESSURE TREATED
DIM.	DIMENSION	QTY.	QUANTITY
EA.	EACH	RAD. (R)	RADIUS
EL.	ELEVATION	REF.	REFERENCE
ELEC.	ELECTRICAL	REINF.	REINFORCEMENT(ING)
EMT.	ELECTRICAL METALLIC TUBING	REQ'D	REQUIRED
ENG.	ENGINEER	RGS	RIGID GALVANIZED STEEL
EQ.	EQUAL	SCH.	SCHEDULE
(E)	EXISTING	SHT.	SHEET
EXT.	EXTERIOR	SPEC.	SPECIFICATIONS
FAB.	FABRICATION	SQ.	SQUARE
F.A.	FINISHED FLOOR	S.S.	STAINLESS STEEL
F.B.	FINISHED GRADE	STD.	STANDARD
FT. (')	FOOT (FEET)	STL	STEEL
FTG.	FOOTING	STRUC.	STRUCTURAL
GA.	GAUGE	TEMP.	TEMPORARY
GALV.	GALVANIZE(D)	T.O.A.	TOP OF ANTENNAS
G.F.I.	GROUND FAULT CIRCUIT INTERRUPTER	T.O.F.	TOP OF FOUNDATION
GPS	GLOBAL POSITIONING SYSTEM	T.O.P.	TOP OF PLATE (PARAPET)
GRND.	GROUND(ING)	T.O.W.	TOP OF WALL
HT.	HEIGHT	TYP.	TYPICAL
ICGB.	ISOLATED COPPER GROUND BUS	U/G	UNDER GROUND
IN. (")	INCH(ES)	V.I.F.	VERIFY IN FIELD
INT.	INTERIOR	W	WIDE (WIDTH)
L.B.	LAG BOLTS	W/	WITH
		WT.	WEIGHT

SYMBOLS LEGEND

	WOOD FENCE
	CHAIN LINK FENCE
	HIDDEN LINE
	COAX/POWER/FIBER CONDUIT
	PROPERTY LINE
	ELEVATION DATUM
	EARTH
	CONCRETE
	SAND
	GRATE PLATFORM
	GRAVEL
	FRP (FIBERGLASS REINFORCED PLASTIC)
	NEW DC SURGE SUPPRESSOR
	NEW ANTENNA
	NEW RRU

PROPRIETARY INFORMATION

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CLIENT:


5001 EXECUTIVE PKWY
SAN RAMON, CA 94583

PROJECT INFORMATION:
PILOT HILL 2
3100 TRIPLE SEVEN RD
COOL, CA 95614

REV: = DATE: _____ DESCRIPTION: _____ BY: _____	
1	6-19-17 90% ZONING DOC'S RB
2	8-14-17 100% ZONING DOC'S RB

COORDINATING ENGINEER:

Peek Site-Com
12852 Earhart Ave. Suite 101
Auburn, California 95602
Phone (530) 885-6160
E-Mail info@peeksitecom.com

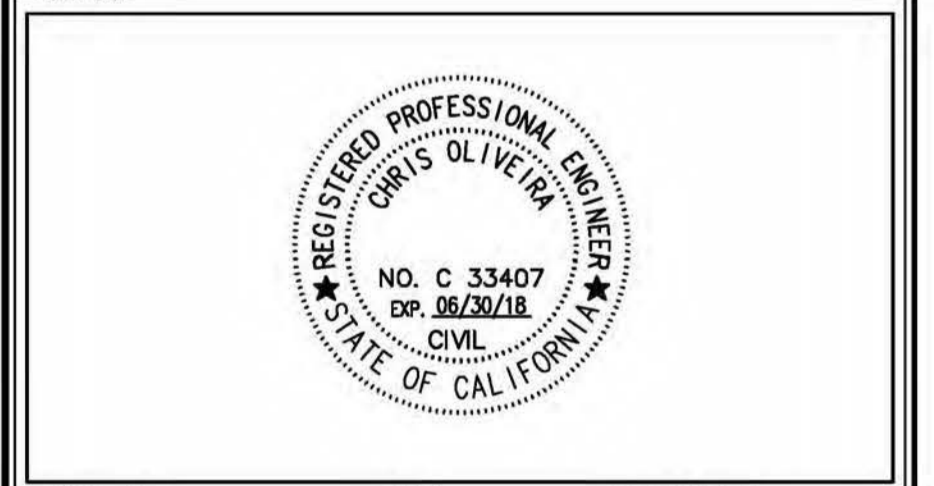

SEAL: _____

SITE #: CVL03175	CHK.: ...	DRAWN BY: RB
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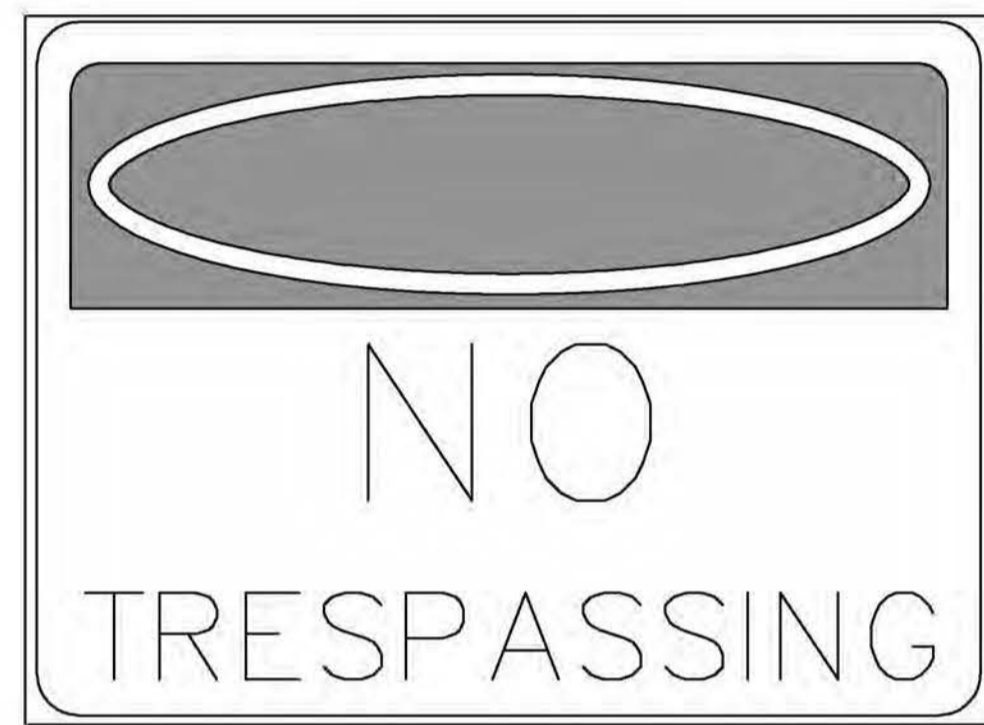
GENERAL NOTES

SHEET NUMBER: _____ REVISION: _____

GN-1 0

This Site Operated by:
AT&T MOBILITY
 2600 CAMINO RAMON, 4W850 N
 SAN RAMON, CA 94583
 IN CASE OF FIRE AND THE NEED FOR SHUTDOWN
 TO DEACTIVATE ANTENNAS CALL
 THE FOLLOWING NUMBER:
 For 24 Hour Emergency Contact and Access Please Call:
 (800) 832-6662
 Reference Site#: CVL03175
 Site Address: 3100 Triple Seven Rd. Cool, CA 95614


FENCED COMPOUND SIGNAGE



FENCED COMPOUND SIGNAGE



DOOR/EQUIPMENT SIGN

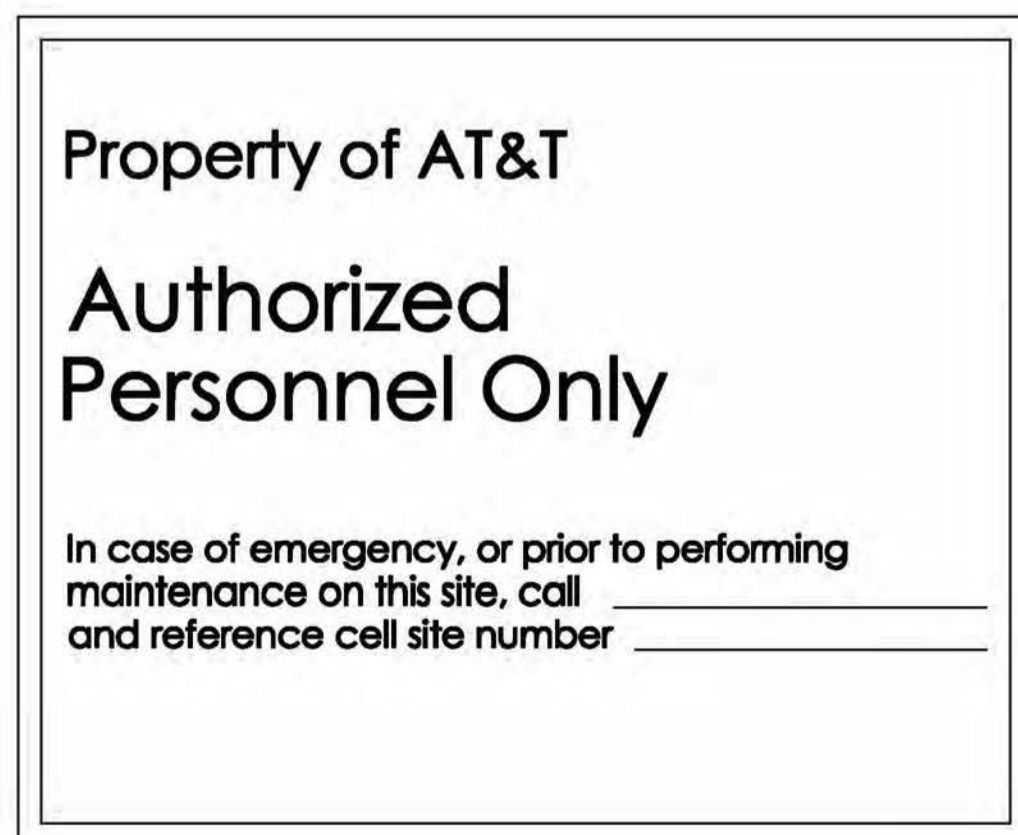

SHELTER/CABINET DOORS SIGNAGE

INFORMATION

AT&T MOBILITY OPERATES TELECOMMUNICATION ANTENNAS AT THIS LOCATION. REMAIN AT LEAST 3 FEET AWAY FROM ANY ANTENNA AND OBEY ALL POSTED SIGNS.

CONTACT THE OWNER(S) OF THE ANTENNA(S) BEFORE WORKING CLOSER THAN 3 FEET FROM THE ANTENNA(S)

CONTACT AT&T MOBILITY AT 800-368-2822 PRIOR TO PERFORMING ANY MAINTENANCE OR REPAIRS NEAR AT&T MOBILITY ANTENNAS.

THIS IS SITE # CVL03175

CONTACT THE MANAGEMENT OFFICE IF THIS DOOR/HATCH/GATE IS FOUND UNLOCKED.

INFORMACION

EN ESTA PROPIEDAD SE UBICAN ANTENAS DE TELECOMUNICACIONES OPERADAS POR AT&T. FAVOR MANTENER UNA DISTANCIA DE NO MENOS DE 3 PIES Y OBEDECER TODOS LOS AVISOS.

COMUNIQUESE CON EL PROPIETARIO O LOS PROPIETARIOS DE LAS ANTENNAS ANTES DE TRABAJAR O CAMINAR DE MENOS DE 3 PIES DE LA ANTENA.

COMUNIQUESE CON AT&T MOBILITY 800-368-2822 ANTES DE REALIZAR CUALQUIER MANTENIMIENTO O REPARACION DE LAS ANTENNAS DE AT&T MOBILITY.

ESTA ES LA ESTACION BASE NUMERO CVL03175

FAVOR COMUNICARSE CON LA OFICINA DE LA ADMINISTRACION DEL EDIFICIO SI ESTA PUERTA O CIERRE SE ENCUENTRA SIN CERRADO

INFORMATION SIGN 1-1

INFORMATION

ACTIVE ANTENNAS ARE MOUNTED

ON THE OUTSIDE FACE OF THIS BUILDING

INFORMATION SIGN 1-2

ON THIS STRUCTURE

STAY BACK A MINIMUM OF 3 FEET FROM THESE ANTENNAS

CONTACT AT&T MOBILITY AT 800-368-2822 & FOLLOW THEIR INSTRUCTIONS PRIOR TO PERFORMING ANY MAINTENANCE OR REPAIRS CLOSER THAN 3 FEET FROM THE ANTENNAS

THIS IS AT&T MOBILITY SITE # CVL03175

INFORMATION SIGN 1-2

at&t

INFORMATION SIGN 1-3

1-1/2"

2"

24"

STAY BACK 3 FEET FROM ANTENNA

INFORMATION SIGN 1-4

- CONTRACTOR SHALL INSTALL ALL INFORMATION SIGNAGE IN ACCORDANCE W/ AT&T WIRELESS DOCUMENT #03-0074, RF EXPOSURE POLICY AND RF SAFETY COMPLIANCE PROGRAM, LATEST EDITION.
- FABRICATION:
 - *SIGN 1-1: ENTRANCE DOOR, SEE DETAIL 1A, THIS SHEET
 - SIGN 1 IS TO BE MADE ON THE 50 MIL ALUMINUM SHEETING (SIZE 8 INCHES BY 12 INCHES) W/ (4) 1/4 INCH MOUNTING HOLES, ONE EACH CORNER OF THE SIGN FOR MOUNTING W/ HARDWARE W/ THE WRAPS. THE MAIN BACKGROUND COLOR IS THE BE WHITE FRONT & BACK W/ BLACK LETTERING
 - THE INFORMATION BAND SHALL BE 1.2 INCH SOLID GREEN BAND W/ 0.5 INCH HIGH BLACK LETTERING. THE BODY OF THE TEXT SHALL BE IN BLACK LETTERING W/ 0.2 INCH HIGH LETTERS. THE REF LINE SHALL BE IN 1/8 INCH LETTERS.
 - THE PLACEMENT OF TEXT SHALL BE DONE IN A MANNER THAT WILL PERMIT EASY READING FROM A DISTANCE OF APPROXIMATELY 6 FEET IN FRONT OF THE SIGN.
 - ALL PAINT WILL BE BAKER W/ ENAMEL W/ UV PROTECTIVE COATING OVER THE FACE OF THE SIGN.

- *SIGN 1-2 POLE, SEE DETAIL 1B, THIS SHEET.
- SIGN 2 MUST BE A NON METALLIC LABEL W/ AN ADHESIVE BACKING, THE LABEL SHALL BE MADE USING VINYL OR SIMILAR WEATHERPROOF MATERIAL, THE LABEL SHALL BE APPROXIMATELY 5X7 INCHES W/ A WHITE BACKGROUND AND BLACK LETTERING. THE GREEN BAND SHALL BE 1.375 INCH IN HEIGHT & THE LETTERING SHALL BE BLACK W/ 0.75 INCH HIGH LETTERS. THE TEXT LETTERING SHALL BE BLACK W/ 1/8 INCH HIGH LETTERS. UV PROTECTION SHALL BE PLACED OVER THE FRONT OF THE LABEL.
- *SIGN 1-3: BACK OF ANTENNAS, SEE DETAIL 1C & 3, THIS SHEET
- *SIGN 3 IS A 1 INCH X 2 INCH PANEL THAT CAN BE APPLIED TO THE BACK OR SIDE OF AN ANTENNA TO IDENTIFY IT AS AN AT&T ANTENNA.
- *SIGN 1-4: SIDE OF ANTENNAS, SEE DETAIL 1D & 3, THIS SHEET
- SIGN 4 IS MADE FROM TRANSPARENT MATERIAL 1-1/2 INCHES WIDE & 24 INCHES LONG. THE LETTERING IS TO BE BLACK W/ 1/2 INCH LETTERING IN A VERTICAL COLUMN. THE SPACING BETWEEN WORDS MUST BE SUCH THAT IT IS EASILY READ & FILLS THE LENGTH OF THE SIGN

INFORMATION SIGNAGE

- NOTE:
- CONTRACTOR SHALL INSTALL ALL INFORMATION SIGNAGE IN ACCORDANCE W/ AT&T WIRELESS DOCUMENT #03-0074, RF EXPOSURE POLICY AND RF SAFETY COMPLIANCE PROGRAM, LATEST EDITION.
 - CONTRACTOR SHALL CONTACT AT&T R-RFSC FOR INFORMATION ON MPE LEVELS AND INSTRUCTIONS ON LEVEL AND LOCATION OF SIGNAGE.

WARNING

Beyond This Point you are entering a controlled area where RF Emissions exceed the FCC Controlled Exposure limits

Failure to obey all posted signs and site guidelines could result in serious injury

Ref: FCC 47CFR 1.1307(b)

CAUTION

Beyond This Point you are entering a controlled area where RF Emissions may exceed the FCC Controlled Exposure limits

Obey all posted signs and site guidelines for working in an RF environment

Ref: FCC 47CFR 1.1307(b)

NOTICE

Beyond This Point you are entering an area where RF Emissions may exceed the FCC General Population Exposure Limits

Follow all posted signs and site guidelines for working in an RF environment

Ref: FCC 47CFR 1.1307(b)

CAUTION AND WARNING SIGN

NOTICE SIGN

SIGNAGE AND STRIPING INFORMATION

- THE FOLLOWING INFORMATION IS A GUIDELINE W/ RESPECT TO PREVAILING STANDARDS LIMITING HUMAN EXPOSURE TO RADIO FREQUENCY ENERGY AND SHOULD BE USED AS SUCH. IF THE SITE'S EMF REPORT OR ANY LOCAL, STATE OR FEDERAL GUIDELINES OR REGULATIONS SHOULD BE IN CONFLICT W/ ANY PART OF THESE NOTES OR PLANS, THE MORE RESTRICTIVE GUIDELINE OR REGULATION SHALL BE FOLLOWED AND OVERRIDE THE LESSER.
- THE PUBLIC LIMIT OF RF EXPOSURE ALLOWED BY AT&T IS 1MWCM² AND THE OCCUPATIONAL LIMIT OF RF EXPOSURE ALLOWED BY AT&T IS 5MWCM²
- IF THE BOTTOM OF THE ANTENNA IS MOUNTED (8) EIGHT FEET ABOVE THE GROUND OR WORKING PLATFORM LINE OF THE PERSONAL COMMUNICATION SYSTEM (PCS) AND DOES NOT EXCEED THE PUBLIC LIMIT OF RF EXPOSURE LIMIT THEN NO STRIPING OR BARRICADES SHOULD BE NEEDED.
- IF THE PUBLIC LIMIT OF RF EXPOSURE ON THE SITE IS EXCEEDED AND THE AREA IS PUBLICLY ACCESSIBLE (E.G. ROOF ACCESS DOOR THAT CANNOT BE LOCKED, OR FIRE EGRESS) THEN BOTH BARRICADES AND STRIPING SHALL BE PLACED AROUND THE ANTENNAS. THE EXACT EXTENT OF THE BARRICADES AND STRIPING SHALL BE DETERMINED BY THE EMF REPORT FOR THE SITE DONE BEFORE OR SHORTLY AFTER COMPLETION OF SITE CONSTRUCTION. USE THE PLANS AS A GUIDELINE FOR PLACEMENT OF SUCH BARRICADES AND STRIPING.
- IF THE PUBLIC LIMIT OF RF EXPOSURE ON THE SITE IS EXCEEDED AND THE AREA IS PUBLICLY ACCESSIBLE (E.G. ROOF ACCESS DOOR THAT CANNOT BE LOCKED, OR FIRE EGRESS) THEN BOTH BARRICADES AND STRIPING SHALL BE PLACED AROUND THE ANTENNAS. THE EXACT EXTENT OF THE BARRICADES & STRIPING SHALL BE DETERMINED BY THE EMF REPORT FOR THE SITE DONE BEFORE OR SHORTLY AFTER COMPLETION OF SITE CONSTRUCTION. USE THE PLANS AS A GUIDELINE FOR PLACEMENT OF SUCH BARRICADES AND STRIPING.
- ALL TRANSMIT ANTENNAS REQUIRE A THREE LANGUAGE WARNING SIGN WRITTEN IN ENGLISH, SPANISH, AND CHINESE. THIS SIGN SHALL BE PROVIDED TO THE CONTRACTOR BY THE AT&T CONSTRUCTION PROJECT MANAGER AT THE TIME OF CONSTRUCTION. THE LARGER SIGN SHALL BE PLACED IN PLAIN SIGHT AT ALL ROOF ACCESS LOCATIONS AND ON ALL BARRICADES. THE SMALLER SIGN SHALL BE PLACED ON THE ANTENNA ENCLOSURES IN A MANNER THAT IS EASILY SEEN BY ANY PERSON ON THE ROOF. WARNING SIGNS SHALL COMPLY W/ ANSI C95.2 COLOR, SYMBOL, AND CONTENT CONVENTIONS. ALL SIGNS SHALL HAVE AT&T'S NAME AND THE COMPANY CONTACT INFORMATION (E.G. TELEPHONE NUMBER) TO ARRANGE FOR ACCESS TO THE RESTRICTED AREAS. THIS TELEPHONE NUMBER SHALL BE PROVIDED TO THE CONTRACTOR BY THE AT&T CONSTRUCTION PROJECT MANAGER AT THE TIME OF CONSTRUCTION.
- PHOTOS OF ALL STRIPING, BARRICADES & SIGNAGE SHALL BE PART OF THE CONTRACTORS CLOSE OUT PACKAGE & SHALL BE TURNED INTO THE AT&T CONSTRUCTION PACKAGE & SHALL BE TURNED INTO THE AT&T CONSTRUCTION PROJECT MANAGER AT THE END OF CONSTRUCTION. STRIPING SHALL BE DONE W/ FADE RESISTANT YELLOW SAFETY PAINT IN A CROSS-HATCH PATTERN AS DETAILED BY THE CONSTRUCTION DRAWINGS. ALL BARRICADES SHALL BE MADE OF AN RF FRIENDLY MATERIAL SO AS NOT TO BLOCK OR INTERFERE W/ THE OPERATION OF THE ANTENNAS. BARRICADES SHALL BE PAINTED W/ FADE RESISTANT YELLOW SAFETY PAINT. THE CONTRACTOR SHALL PROVIDE ALL RF FRIENDLY BARRICADES NEEDED, & SHALL PROVIDE THE AT&T CONSTRUCTION PROJECT MANAGER W/ A DETAILED
- SHOP DRAWING OF EACH BARRICADE. UPON CONSTRUCTION COMPLETION.

GENERAL NOTES

PROPRIETARY INFORMATION
 THE INFORMATION CONTAINED IN THIS SET OF DRAWINGS IS PROPRIETARY BY NATURE. ANY USE OR DISCLOSURE OTHER THAN THAT WHICH RELATES TO PEEK SITE-COM IS STRICTLY PROHIBITED


5001 EXECUTIVE PKWY
 SAN RAMON, CA 94583

PROJECT INFORMATION:
PILOT HILL 2
 3100 TRIPLE SEVEN RD
 COOL, CA 95614

REV:	DATE:	DESCRIPTION:	BY:
1	6-19-17	90% ZONING DOC'S	RB
2	8-14-17	100% ZONING DOC'S	RB

COORDINATING ENGINEER:

Peek Site-Com
 12852 Earhart Ave. Suite 101
 Auburn, California 95602
 Phone (530) 885-6160
 E-Mail info@peeksitecom.com

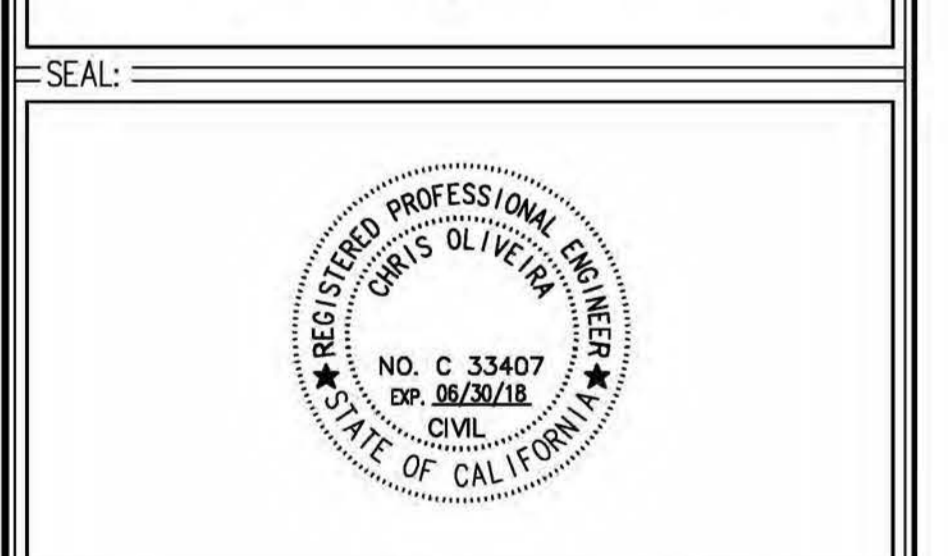

SITE #: CVL03175
 CHK.: ...
 DRAWN BY: RB


SHEET TITLE: **SITE SIGNAGE**

SHEET NUMBER: **GN-2** REVISION: **0**

DATE OF SURVEY: 04-28-17
 SURVEYED BY OR UNDER DIRECTION OF: KENNETH D. GEIL, R.C.E. 14803
 LOCATED IN THE COUNTY OF EL DORADO, STATE OF CALIFORNIA
 BEARINGS SHOWN ARE BASED UPON MONUMENTS FOUND AND RECORD INFORMATION. THIS IS NOT A BOUNDARY SURVEY.
 ELEVATIONS SHOWN ON THIS PLAN ARE BASED UPON U.S.G.S. N.A.V.D. 88 DATUM. ABOVE MEAN SEA LEVEL.
 N.G.V.D. 1929 CORRECTION: SUBTRACT 2.68' FROM ELEVATIONS SHOWN.
 CONTOUR INTERVAL: 1 FT.
 CONTRACTOR IS RESPONSIBLE TO VERIFY LEASE AREA PRIOR TO CONSTRUCTION.
 ASSESSOR'S PARCEL NUMBER: 071-032-15-100

A.T. & T. Mobility
 Project No./Name: CVL03175 / PILOT HILL 2
 Project Site Location: 3100 Triple Seven Road, Cool, CA 95614, El Dorado County
 Date of Observation: 04-28-17
 Equipment/Procedure Used to Obtain Coordinates: Trimble Geo XT post processed with Pathfinder Office software.
 Type of Antenna Mount: Proposed Monopine Tower
 Coordinates (Center Lease Area)
 Latitude: N 38°53'23.38" (NAD83) N 38°53'23.74" (NAD27)
 Longitude: W 120°59'51.29" (NAD83) W 120°59'47.49" (NAD27)
 ELEVATION of Ground at Structure (NAVD88) 1621' AMSL

Lease Area Description
 All that certain lease area being a portion of Parcel "2" as is shown on that certain Parcel Map, filed for record in Book 9 of Parcel Maps, Page 98, El Dorado County Records, located in the County of El Dorado, State of California, and being a portion of the South 1/2 of Section 9, Township 12 N., Range 9 E., M.D.B. & M, and being more particularly described as follows:
 Commencing at the Southwest corner of the aforementioned Parcel 2; thence along the southwesterly boundary thereof North 50°02'12" West, 434.70 feet; thence leaving said Southwesterly boundary North 39°57'48" East, 186.68 feet to the True Point of Beginning; thence from said point of beginning North 54°53'37" West, 36.00 feet; thence North 35°06'23" East, 36.00 feet; thence South 54°53'37" East, 36.00 feet; thence South 35°06'23" West, 36.00 feet to the point of beginning.
 Together with a non-exclusive easement for access and utility purposes, purposes fifteen feet in width, the centerline of which is more particularly described as follows: Beginning at a point which bears South 35°06'23" West, 18.00 feet from the East most corner of the above described lease area; thence from said point of beginning South 55°32'41" East, 35.93 feet to the point of curvature of a tangent curve, concave to the northwest, having a radius of 25.00 feet and a central angle of 156°23'38"; thence Southeast along said curve, a distance of 68.24 feet, curving to the right; thence North 79°09'03" West, 22.87 feet; thence South 88°56'55" West, 201.09 feet; thence South 85°14'30" West, 118.17 feet; thence North 79°24'18" West, 81.37 feet more or less to the Southwesterly boundary of the aforementioned Parcel 2, said point also being the beginning of an existing 60' easement for road and utility purposes as shown on the plat filed in Book 29 of Parcel Maps, Page 4 El Dorado County Records; thence along said easement to the public right of way commonly known as State Highway 193.
 Also together with a non-exclusive easement for utility purposes, purposes six feet in width, the centerline of which is more particularly described as follows: Beginning at the North most corner of the above described lease area and running thence North 27°20'51" West 150.0 feet more or less to an existing utility service connection location.



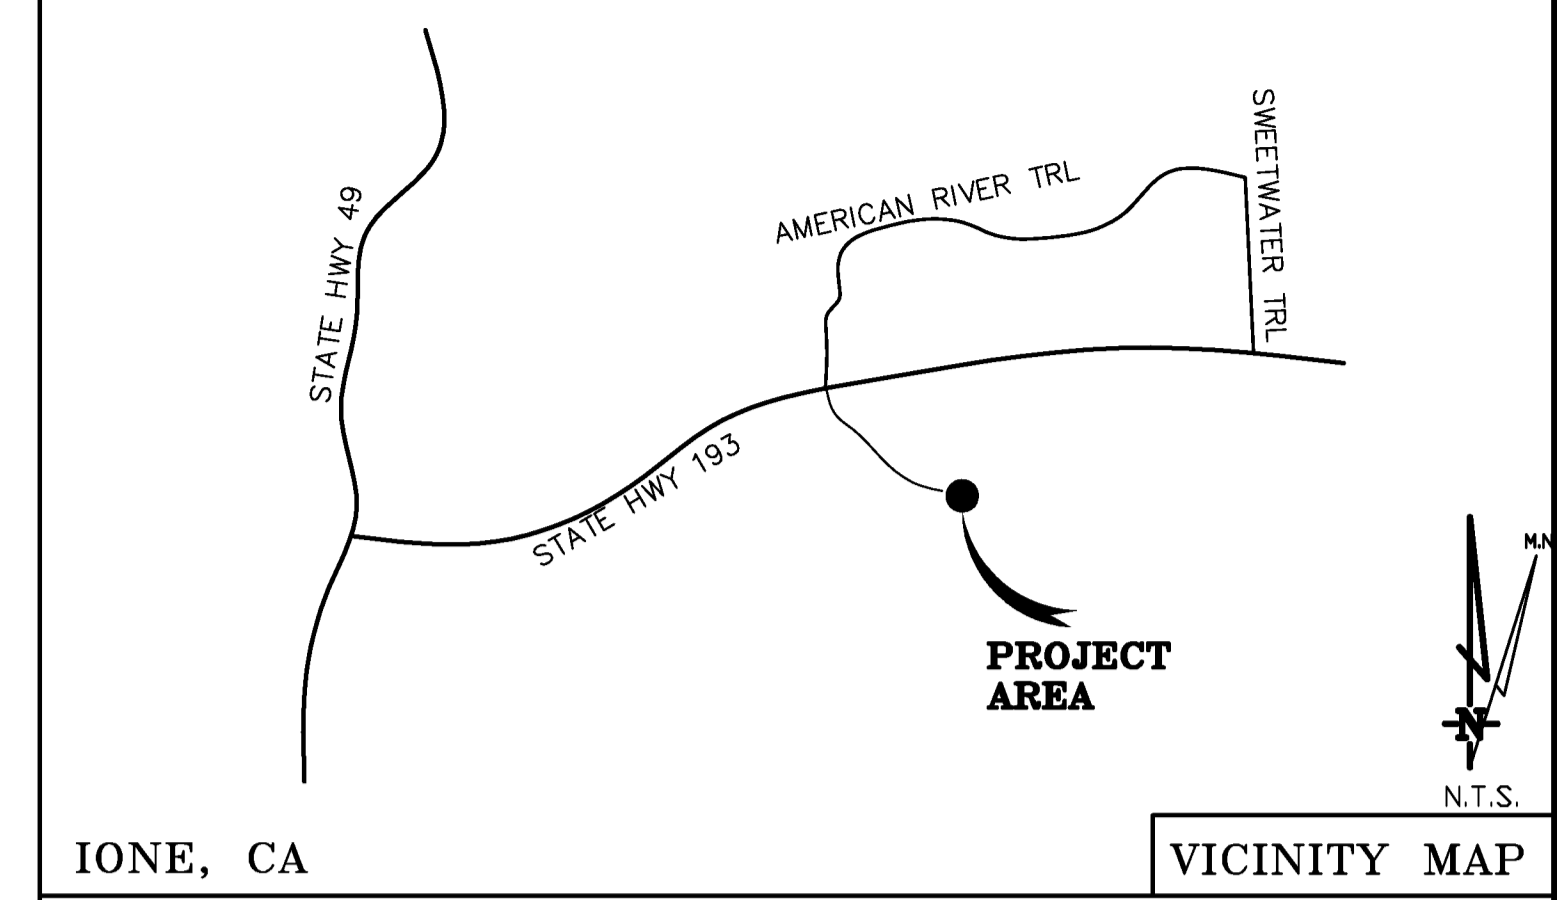


THESE DRAWINGS AND/OR THE ACCOMPANYING SPECIFICATION AS INSTRUMENTS OF SERVICE, ARE THE EXCLUSIVE PROPERTY OF GEIL ENGINEERING AND THEIR USE AND PUBLICATION SHALL BE RESTRICTED TO THE ORIGINAL SITE AND CARRIER FOR WHICH THEY ARE PREPARED. REUSE, REPRODUCTION OR PUBLICATION BY ANY METHOD, IN WHOLE OR IN PART, IS PROHIBITED EXCEPT BY WRITTEN PERMISSION FROM GEIL ENGINEERING. TITLE TO THESE PLANS AND/OR SPECIFICATIONS SHALL REMAIN WITH GEIL ENGINEERING WITHOUT PREJUDICE AND VISUAL CONTACT WITH THEM SHALL CONSTITUTE PRIMA FACIE EVIDENCE OF ACCEPTANCE OF THESE RESTRICTIONS.
 BOUNDARY SHOWN IS BASED ON MONUMENTATION FOUND AND RECORD INFORMATION. THIS IS NOT A BOUNDARY SURVEY. THIS IS A SPECIALIZED TOPOGRAPHIC MAP WITH PROPERTY LINES AND EASEMENTS BEING A GRAPHIC DEPICTION BASED ON INFORMATION GATHERED FROM VARIOUS SOURCES OF RECORD AND AVAILABLE MONUMENTATION FOUND DURING THE FIELD SURVEY. NO EASEMENTS WERE RESEARCHED OR PLOTTED. PROPERTY LINES AND LINES OF TITLE WERE NOT INVESTIGATED NOR SURVEYED. NO PROPERTY MONUMENTS WERE SET.

DEPT	APPROVED	DATE
ARC		
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EE\IN		
OPS		
EE\OUT		

Surveys

GEIL ENGINEERING
 ENGINEERING • SURVEYING • PLANNING
 1526 HIGH STREET
 OAKLAND, CALIFORNIA 94612
 Phone: (415) 868-1100
 Fax: (415) 868-1100

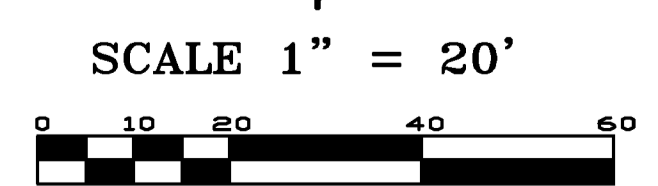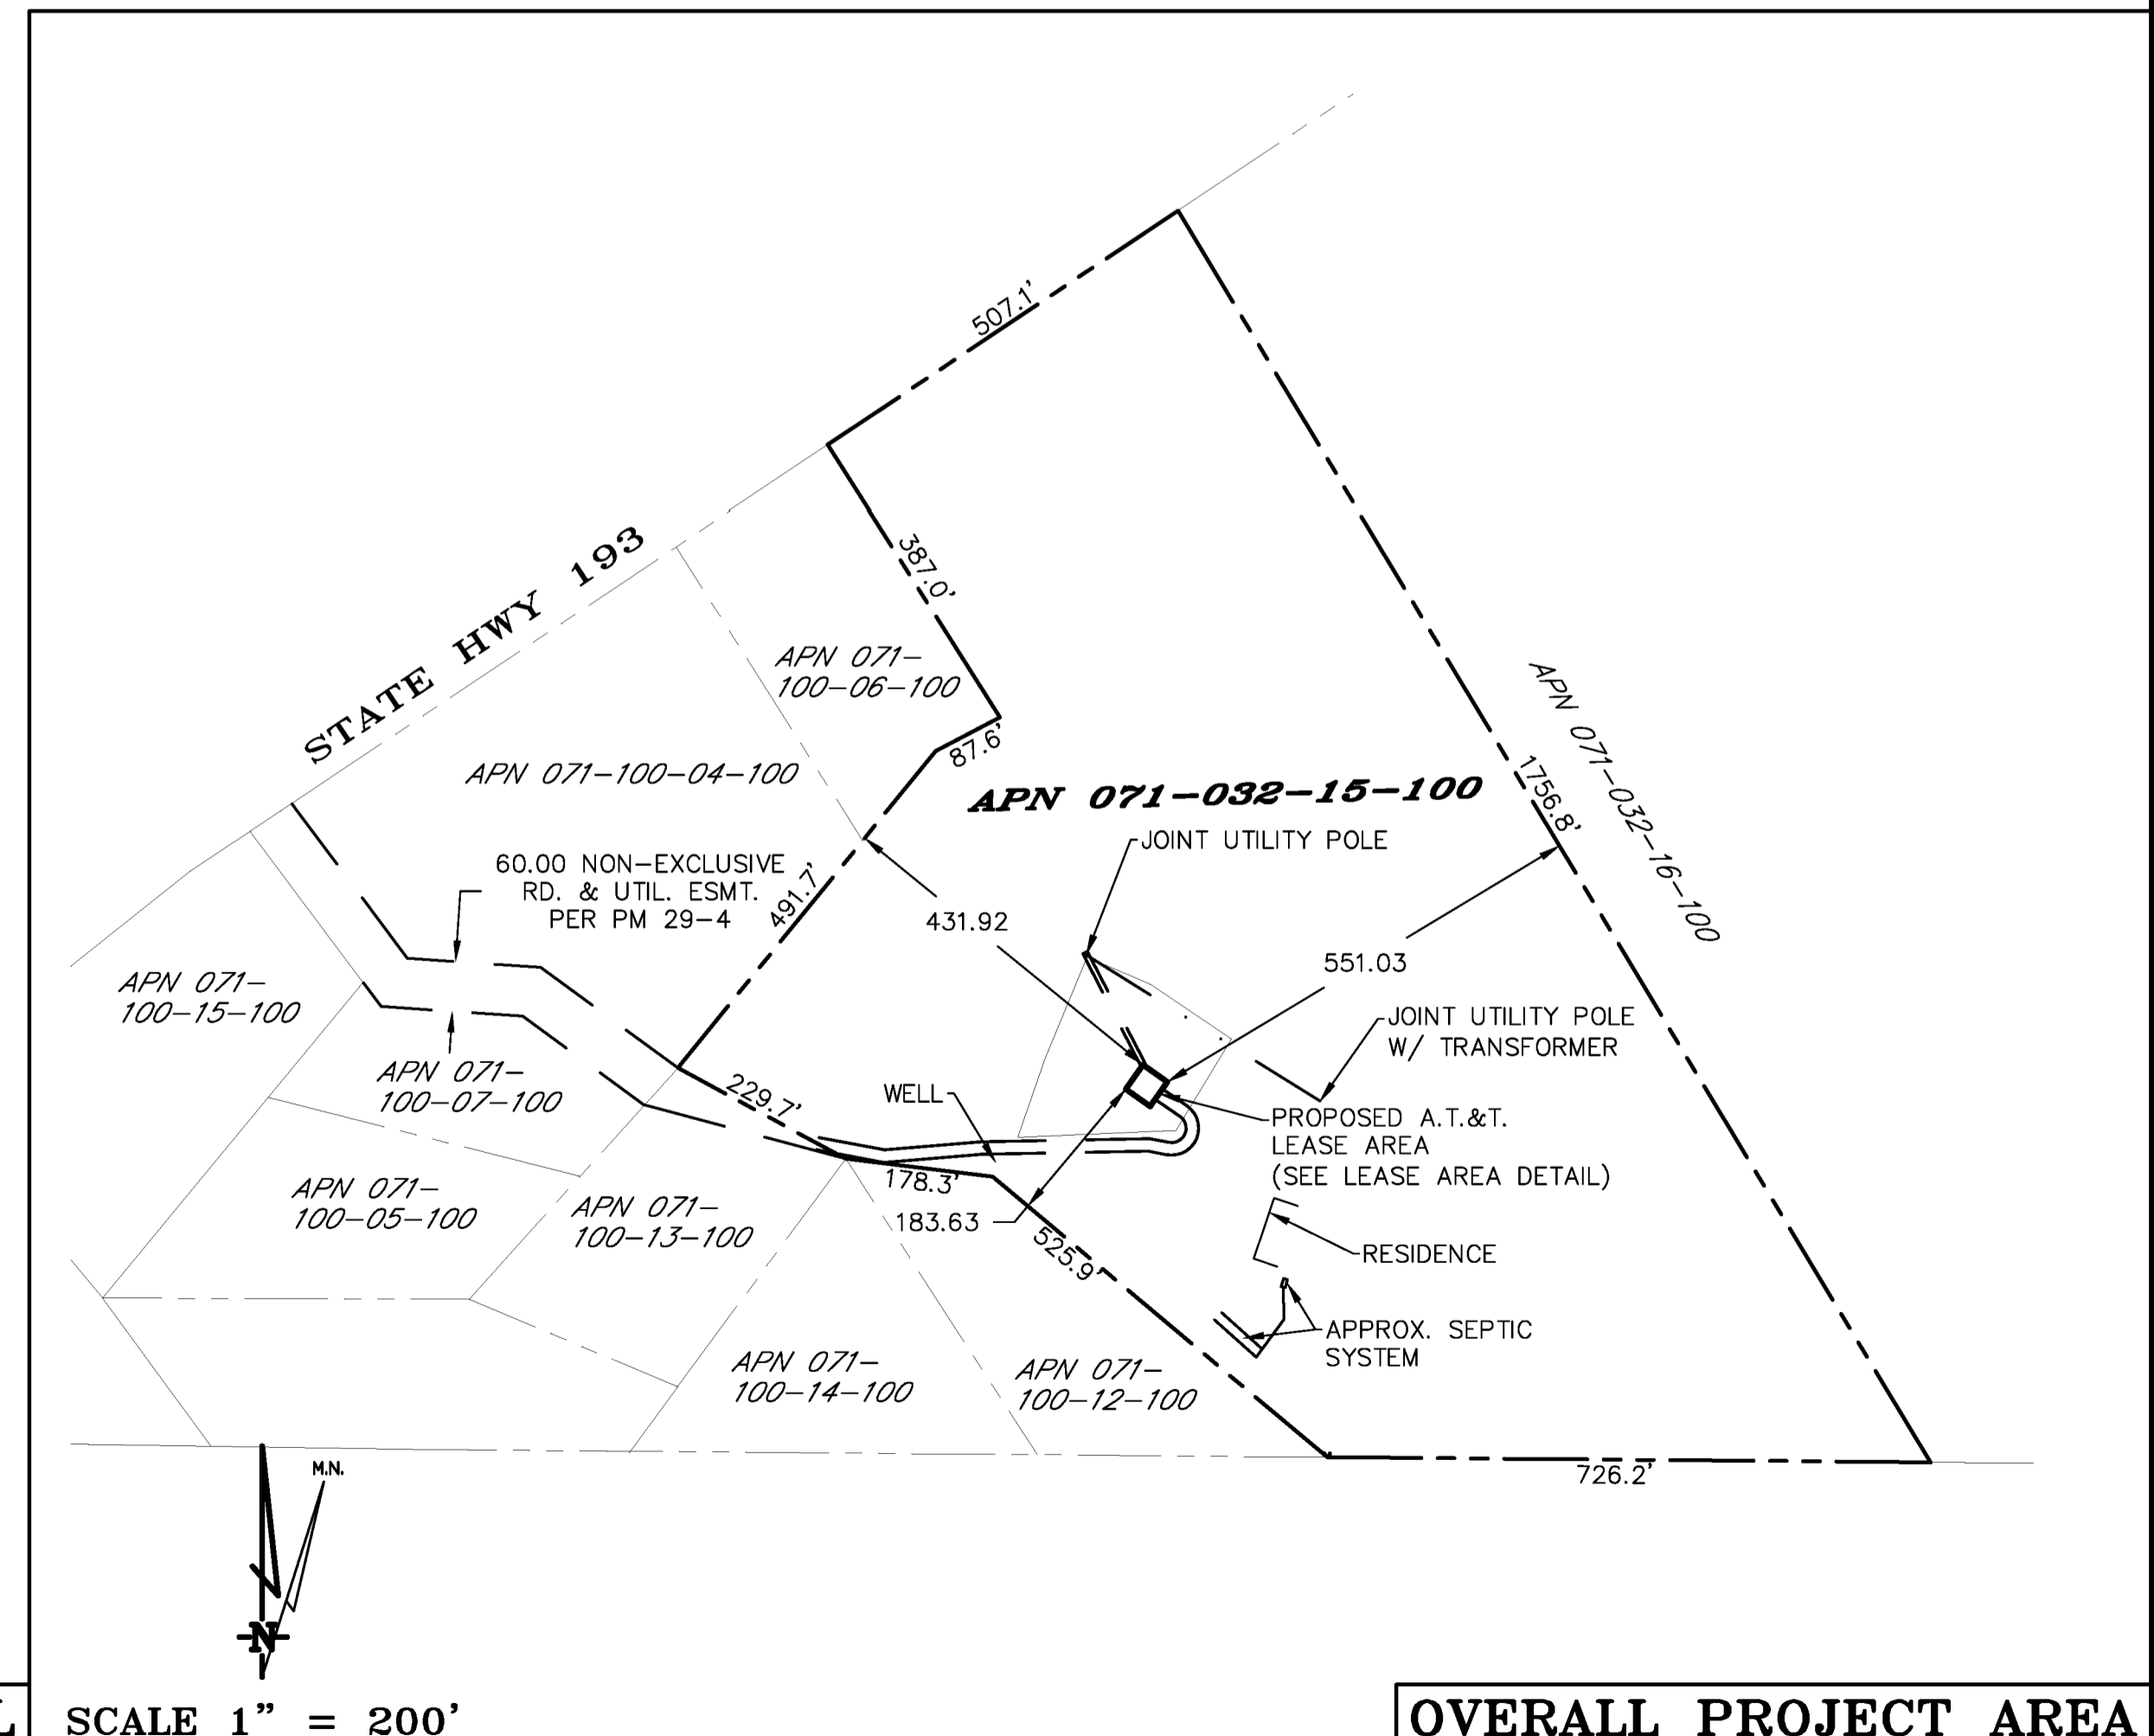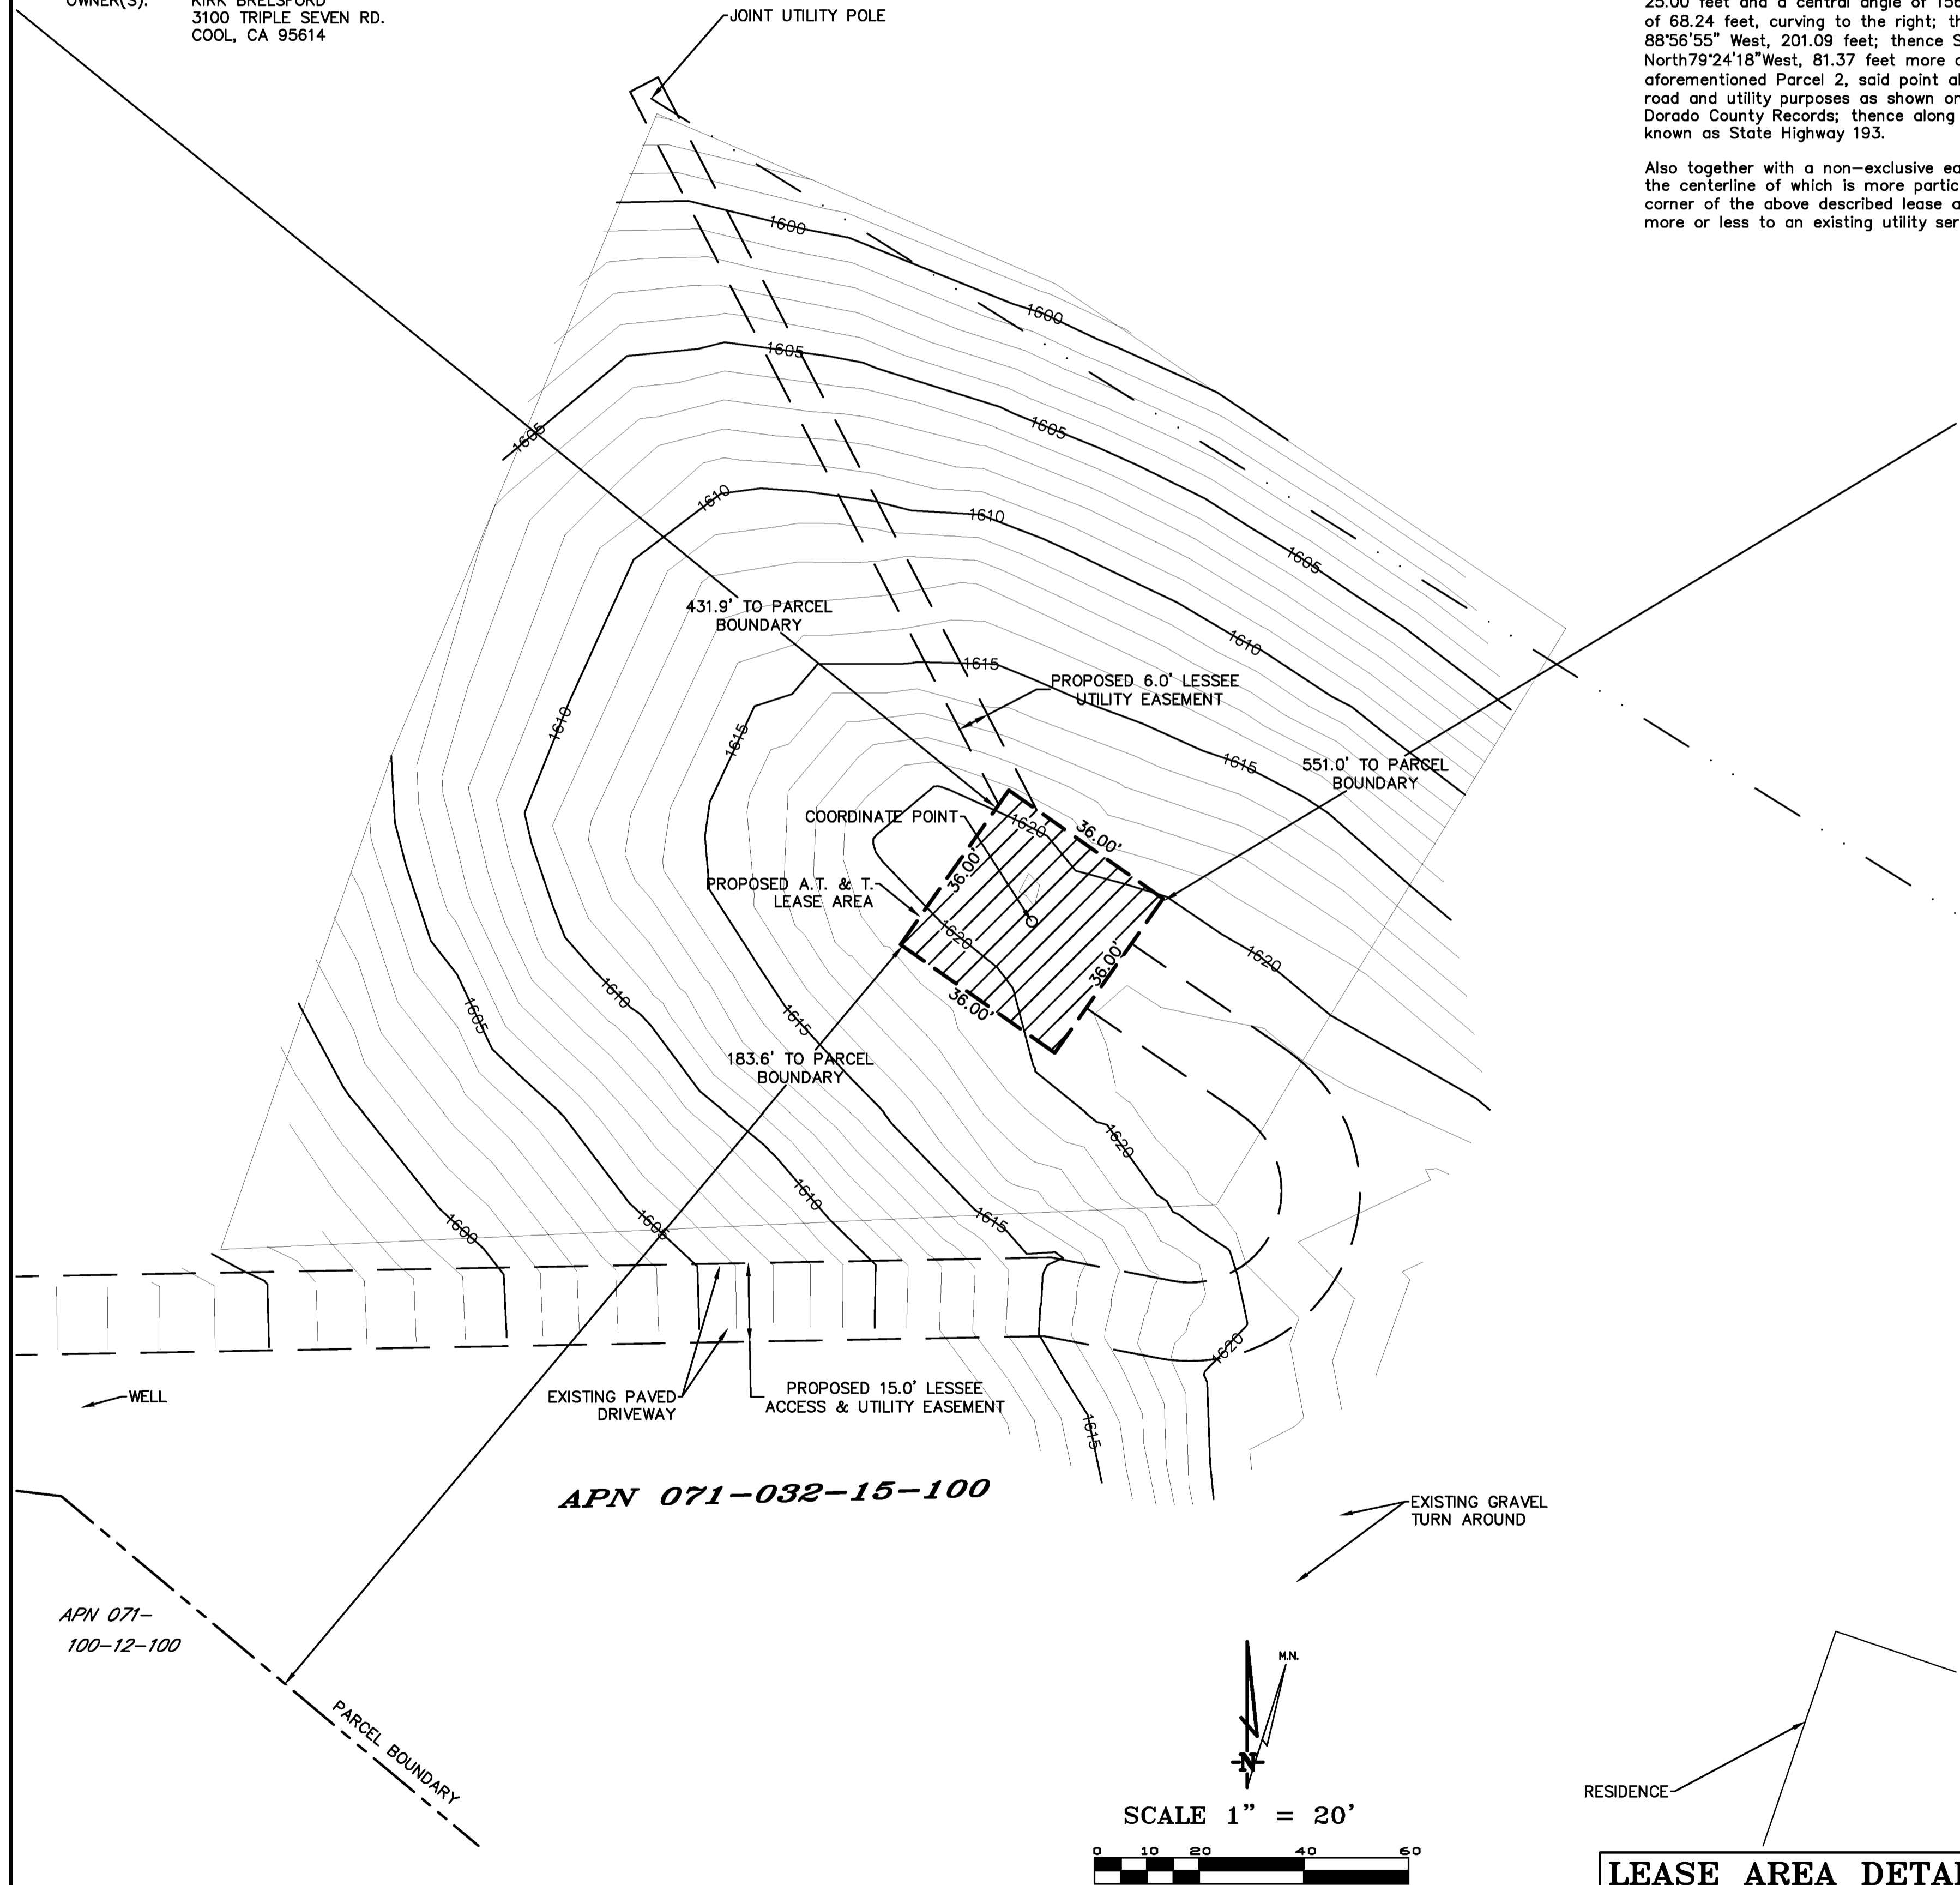

LEASE AREA DETAIL

SCALE 1" = 200'

OVERALL PROJECT AREA

at&t
 MOBILITY

CVL03175 Pilot Hill
 3100 Triple Seven Road
 Cool, CA 95614
 PILOT PLAN AND
 SITE TOPOGRAPHY


REVISIONS	REV	DATE	DESCRIPTION
04-29-17			Preliminary Drawing
	REV		
	REV		
	REV		
	REV		

Sheet
C-1

GRADING STANDARDS

1. GENERAL. UNLESS OTHERWISE RECOMMENDED IN THE APPROVED SOILS ENGINEERING OR ENGINEERING GEOLOGY REPORT, GRADING ACTIVITIES SHALL CONFORM TO THE PROVISIONS OF THIS SECTION.
 - A. CUT SLOPE. THE SLOPE OF CUT SURFACES SHALL BE NO STEEPER THAN IS SAFE FOR THE INTENDED USE AND SHALL BE NO STEEPER THAN 1 UNIT VERTICAL IN 2 UNITS HORIZONTAL (50% SLOPE) UNLESS THE PERMITEE FURNISHES A SOILS ENGINEERING OR AN ENGINEERING GEOLOGY REPORT, OR BOTH, STATING THAT THE SITE HAS BEEN INVESTIGATED AND GIVING AN OPINION THAT A CUT AT A STEEPER SLOPE WILL BE STABLE AND NOT CREATE A HAZARD TO PROPERTY OR THE ENVIRONMENT.
 - B. FILL SLOPE AND PREPARATION
 - (1) PREPARATION OF GROUND. THE GROUND SURFACE SHALL BE PREPARED TO RECEIVE FILL BY REMOVING VEGETATION, NON-COMPLYING FILL, TOPSOIL AND OTHER UNSUITABLE MATERIALS SCARIFYING TO PROVIDE A BOND WITH THE NEW FILL.
 - (2) FILL MATERIAL. AMOUNT OF ORGANIC MATERIAL DETRIMENTAL TO STRUCTURAL INTEGRITY SHALL NOT BE PERMITTED IN FILLS, EXCEPT AS PERMITTED BY THE BUILDING OFFICIAL, NO ROCK OR SIMILAR IRREDUCIBLE MATERIAL WITH A MAXIMUM DIMENSION GREATER THAN 12 INCHES (0.31 M) SHALL BE BURIED OR PLACED IN FILLS.
 - (3) EXCEPTION. THE BUILDING OFFICIAL MAY PERMIT PLACEMENT OF LARGER ROCK WHEN THE SOILS ENGINEER PROPERLY DEVISES A METHOD OF PLACEMENT, AND CONTINUOUSLY INSPECTS ITS PLACEMENT AND APPROVES THE FILL STABILITY. THE FOLLOWING CONDITIONS SHALL ALSO APPLY:
 - (a) PRIOR TO ISSUANCE OF THE GRADING PERMIT, POTENTIAL ROCK DISPOSAL AREAS SHALL BE SHOWN ON THE GRADING PLAN.
 - (b) ROCK SIZES GREATER THAN 12 INCHES (0.31 M) IN MAXIMUM DIMENSION SHALL BE 10 FEET (3.05 M) OR MORE BELOW GRADE, MEASURED VERTICALLY.
 - (c) ROCKS SHALL BE PLACED SO AS TO ASSURE FILLING OF ALL VOIDS WITH WELL-GRADED SOIL.
 - (4) COMPACTION. ALL FILLS SHALL BE COMPACTED TO A MINIMUM OF 90 PERCENT OF MAXIMUM DRY DENSITY WITH SUFFICIENT TESTING FOR DOCUMENTATION OF COMPLIANCE WITH THIS STANDARD.
 - (5) SLOPE. THE SLOPE OF FILL SURFACES SHALL BE NO STEEPER THAN IS SAFE FOR THE INTENDED USE. FILL SLOPES SHALL BE NO STEEPER THAN 1 UNIT VERTICAL IN 2 UNITS HORIZONTAL (50% SLOPE).
 - C. SETBACKS
 - a. GENERAL. CUT AND FILL SLOPES SHALL BE SET BACK FROM SITE BOUNDARIES IN ACCORDANCE WITH THIS SECTION. SETBACK DIMENSIONS SHALL BE HORIZONTAL DISTANCES MEASURED PERPENDICULAR TO THE SITE BOUNDARY.
 - b. TOP OF CUT SLOPE. THE TOP OF CUT SLOPES SHALL NOT BE MADE NEARER TO A SITE BOUNDARY LINE THAN A MINIMUM OF 2 FEET. THE SETBACK MAY NEED TO BE INCREASED FOR ANY REQUIRED INTERCEPTOR DRAINS.
 - c. TOE OF FILL SLOPE. THE TOE OF FILL SLOPE SHALL BE MADE NOT NEARER TO THE SITE BOUNDARY LINE THAN MINIMUM OF 2 FEET. WHERE A FILL SLOPE IS TO BE LOCATED NEAR THE SITE BOUNDARY AND THE ADJACENT OFFSITE PROPERTY IS DEVELOPED, SPECIAL PRECAUTIONS SHALL BE INCORPORATED IN THE WORK AS THE BUILDING OFFICIAL DEEMS NECESSARY TO PROTECT THE ADJOINING PROPERTY FROM DAMAGE AS A RESULT OF SUCH GRADING. THESE PRECAUTIONS MAY INCLUDE BUT ARE NOT LIMITED TO:
 - (1) ADDITIONAL SETBACKS.
 - (2) PROVISION FOR RETAINING, OR SLOUGH WALLS.
 - (3) MECHANICAL OR CHEMICAL TREATMENT OF THE FILL SLOPE SURFACE TO MINIMIZE EROSION.
 - (4) PROVISIONS FOR THE CONTROL OF SURFACE WATERS.
 - d. MODIFICATION OF SETBACKS. THE BUILDING OFFICIAL MAY APPROVE ALTERNATE SETBACKS. THE BUILDING OFFICIAL MAY REQUIRE AN INVESTIGATION AND RECOMMENDATION BY A QUALIFIED ENGINEER OR ENGINEERING GEOLOGIST TO DEMONSTRATE THAT THE INTENT OF THIS SECTION HAS BEEN SATISFIED.
2. MAINTENANCE REQUIRED. THE PROPERTY OWNER SHALL BE RESPONSIBLE FOR ADEQUATELY MAINTAINING ALL DRAINAGE FACILITIES INSTALLED PURSUANT TO THIS SECTION.
3. GRADING INSPECTION
 - A. GENERAL. GRADING OPERATIONS FOR WHICH A PERMIT IS REQUIRED SHALL BE SUBJECT TO INSPECTION BY THE BUILDING OFFICIAL.
 - B. PERMITEE. THE PERMITEE SHALL BE RESPONSIBLE FOR THE WORK TO BE PERFORMED IN ACCORDANCE WITH THE APPROVED PLANS AND SPECIFICATIONS AND IN CONFORMANCE WITH THE PROVISIONS OF THIS CODE, AND THE PERMITEE SHALL ENGAGE CONSULTANTS, IF REQUIRED, TO PROVIDE PROFESSIONAL INSPECTIONS ON A TIMELY BASIS. THE PERMITEE SHALL ACT AS A COORDINATOR BETWEEN THE CONSULTANTS, THE CONTRACTOR AND THE BUILDING OFFICIAL. IN THE EVENT OF CHANGED CONDITIONS, THE PERMITEE SHALL BE RESPONSIBLE FOR INFORMING THE BUILDING OFFICIAL OF SUCH CHANGE AND SHALL PROVIDE REVISED PLANS FOR APPROVAL.
 - C. BUILDING OFFICIAL. THE BUILDING OFFICIAL SHALL INSPECT THE PROJECT AT THE VARIOUS STAGES OF WORK REQUIRING APPROVAL TO DETERMINE THAT ADEQUATE CONTROL IS BEING EXERCISED BY THE PROFESSIONAL CONSULTANTS.
 - D. NOTIFICATION OF NONCOMPLIANCE. IF, IN THE COURSE OF FULFILLING THEIR RESPECTIVE DUTIES UNDER THIS CHAPTER, THE CIVIL ENGINEER, THE SOILS ENGINEER OR THE ENGINEERING GEOLOGIST FINDS THAT THE WORK IS NOT BEING DONE IN CONFORMANCE WITH THIS CHAPTER OR THE APPROVED GRADING PLANS, THE DISCREPANCIES SHALL BE REPORTED IMMEDIATELY IN WRITING TO THE PERMITEE AND TO THE BUILDING OFFICIAL.
 - E. TRANSFER OF RESPONSIBILITY. IF THE CIVIL ENGINEER, THE SOILS ENGINEER, OR THE ENGINEERING GEOLOGIST OF RECORD IS CHANGED DURING GRADING, THE WORK SHALL BE STOPPED UNTIL THE REPLACEMENT HAS AGREED IN WRITING TO ACCEPT THEIR RESPONSIBILITY WITHIN THE AREA OF TECHNICAL COMPETENCE FOR APPROVAL UPON COMPLETION OF THE WORK. IT SHALL BE THE DUTY OF THE PERMITEE TO NOTIFY THE BUILDING OFFICIAL IN WRITING OF SUCH CHANGE PRIOR TO THE RE-COMMENCEMENT OF SUCH GRADING.
4. EROSION AND SEDIMENTATION CONTROL
 - A. ADMINISTRATION
 - (1) THE EROSION AND SEDIMENT CONTROL PROVISIONS OF THIS SECTION SHALL BE APPLICABLE TO ALL FACILITIES AND ACTIVITIES UNDER THE SUPERVISION OF THE DIRECTOR OF THE DEPARTMENT OF PUBLIC WORKS.
 - (2) THE ADMINISTRATION OF THIS SECTION, AS IT AFFECTS COUNTY FACILITIES AND ACTIVITIES, IS THE RESPONSIBILITY OF THE DIRECTOR OF THE DEPARTMENT OF PUBLIC WORKS.
 - (3) THE ADMINISTRATION OF THIS SECTION AS IT AFFECTS OTHER BUILDING, GRADING, AND RELATED ACTIVITIES IS THE RESPONSIBILITY OF THE CHIEF BUILDING OFFICIAL.
 - (4) ANY SOILS OR GEOLOGIC REPORTS PREPARED FOR ANY PROJECT WHERE A GRADING PERMIT IS SUBMITTED AS A PART OF A TENTATIVE SUBDIVISION MAP APPLICATION, OR RELATED ENVIRONMENTAL DOCUMENT, SHALL BE PLACED IN THE RECORDS OF THE CHIEF BUILDING OFFICIAL.
 - B. EROSION AND SEDIMENTATION CONTROL. THESE MINIMUM EROSION AND SEDIMENTATION CONTROL STANDARDS SHALL APPLY TO ALL PROJECTS REQUIRING BUILDING, GRADING, AND DEVELOPMENT PERMITS, AND COUNTY OF MENDOCINO PUBLIC WORKS ACTIVITIES, TO PREVENT SEDIMENTATION OR DAMAGE TO ONSITE AND OFFSITE PROPERTY. THESE STANDARDS SHALL BE INCORPORATED INTO THE PROJECT DESIGN AND SHALL BE ADHERED TO DURING PROJECT CONSTRUCTION:
- (1) GENERAL GUIDELINES
 - (a) MINIMIZE SOIL EXPOSURE DURING THE RAINY SEASON BY PROPER TIMING OF GRADING AND CONSTRUCTION.
 - (b) RETAIN TREES AND NATURAL VEGETATION TO STABILIZE HILLSIDES, RETAIN MOISTURE, REDUCE EROSION, MINIMIZE SILTATION AND NUTRIENT RUNOFF AND PRESERVE SCENIC QUALITIES.
 - (c) VEGETATE AND MULCH DENUDED AREAS TO PROTECT THEM FROM WINTER RAINS.
 - (d) DIVERT RUNOFF AWAY FROM STEEP, DENUDED SLOPES OR OTHER CRITICAL AREAS WITH BARRIERS, BERMS, DITCHES OR OTHER FACILITIES.
 - (e) LIMIT CONSTRUCTION, CLEARING OF VEGETATION AND DISTURBANCE OF THE SOIL TO AREAS OF PROVEN STABILITY. MITIGATE GEOLOGIC HAZARDS AND ADVERSE SOIL CONDITIONS WHEN THEY ARE ENCOUNTERED.
 - (f) REDUCE SEDIMENT TRANSPORT OFF THE SITE TO THE MAXIMUM EXTENT FEASIBLE THROUGH THE USE OF BEST MANAGEMENT PRACTICES (BMPs).

- (g) PROPOSE A NEW OR MODIFIED EROSION AND SEDIMENT CONTROL TECHNIQUE IF THE TECHNIQUE IS PREFERRED AND MEETS THE INTENT OF THESE REGULATIONS. OBTAIN APPROVAL FROM THE COUNTY PRIOR TO IMPLEMENTATION.
 - (h) CONDUCT FREQUENT SITE INSPECTIONS TO ENSURE THAT CONTROL MEASURES ARE WORKING PROPERLY AND TO CORRECT PROBLEMS AS NEEDED.
 - (i) EMPLOY OTHER MEANS OF EROSION AND SEDIMENT CONTROL AS REQUIRED BY THE CHIEF BUILDING OFFICIAL OR DIRECTOR OF THE DEPARTMENT OF PUBLIC WORKS AS APPLICABLE.
- (2) SEDIMENT CONTROL
- (a) USE SEDIMENT BASINS, SILT TRAPS, OR SIMILAR MEASURE TO RETAIN SEDIMENT TRANSPORTED BY RUNOFF WATER ONSITE.
 - (b) COLLECT AND DIRECT SURFACE RUNOFF AT NON-EROSIVE VELOCITIES TO THE COMMON NATURAL WATERCOURSE OF THE DRAINAGE AREA.
 - (c) AVOID CONCENTRATING SURFACE WATER ANYWHERE EXCEPT SWALES OR WATERCOURSES.
 - (d) PREVENT MUD FROM BEING TRACKED ONTO THE PUBLIC ROADWAY BY TRAVELING OVER A TEMPORARY GRAVEL CONSTRUCTION ENTRANCE OR WASHING OFF VEHICLE TIRES BEFORE ENTERING A PUBLIC OR PRIVATE DRIVEWAY.
- (3) SLOPE CONSTRUCTION
- (a) MINIMIZE LENGTH AND STEEPNESS OF SLOPES BY BENCHING, TERRACING OR CONSTRUCTING DIVERSION STRUCTURES.
 - (b) PRESERVE, MATCH, OR BLEND CUTS AND FILLS WITH THE NATURAL CONTOURS AND UNDULATIONS OF THE LAND.
 - (c) ROUND SHARP ANGLES AT THE TOP AND SIDES OF CUT AND FILL SLOPES.
 - (d) MAINTAIN CUT AND FILL SLOPES AT LESS THAN TWO-TO-ONE (2:1, RUN:RISE) SLOPE UNLESS A GEOLOGICAL AND ENGINEERING ANALYSIS INDICATES THAT STEEPER SLOPES ARE SAFE AND EROSION AND SEDIMENT CONTROL MEASURES CAN SUCCESSFULLY PREVENT EROSION.
- (4) PROTECTION OF WATERCOURSES AND DRAINAGE INLETS
- (a) PREPARE DRAINAGEWAYS TO HANDLE CONCENTRATED OR INCREASED RUNOFF FROM DISTURBED AREAS BY USING APPROPRIATE LINING MATERIALS OR ENERGY ABSORBING DEVICES TO REDUCE THE VELOCITY OF RUNOFF WATER.
 - (b) TRAP SEDIMENT-LADEN RUNOFF IN BASINS TO ALLOW SOIL PARTICLES TO SETTLE OUT BEFORE FLOWS ARE RELEASED TO RECEIVING WATERS, STORM DRAINS, STREETS OR ADJACENT PROPERTY. THIS STANDARD IS NOT MANDATORY FOR GRADING THE SITE IS FULLY WINTERIZED AND STABILIZED PRIOR TO AND WHEN CONDUCTED BETWEEN APRIL 15 AND OCTOBER 15. REMOVE TRAPPED SEDIMENT TO A SUITABLE LOCATION ON-SITE OR AT A DISPOSAL SITE APPROVED BY THE COUNTY.
 - (c) DO NOT GRADE OR DRIVE EQUIPMENT IN A STREAMSIDE MANAGEMENT OR OTHER WET AREAS EXCEPT AS ALLOWED THROUGH THE COUNTY STREAMSIDE MANAGEMENT AREA ORDINANCE.
 - (d) DEPOSIT OR STORE EXCAVATED MATERIALS AWAY FROM WATERCOURSES.
 - (e) PROTECT ALL EXISTING OR NEWLY INSTALLED STORM DRAINAGE STRUCTURES FROM SEDIMENT CLOGGING.
 - (f) USE STRAW BALES, FILTER FABRIC WRAPS AND DRAINAGE INLET PROTECTIONS IN A MANNER THAT DOES NOT CAUSE ADDITIONAL EROSION OR FLOODING OF A ROADWAY.
- (5) DISPOSAL OF EXCAVATED MATERIALS
- (a) STOCKPILE TOPSOIL ON THE SITE FOR USE ON AREAS TO BE REVEGETATED.
 - (b) PLACE STOCKPILED SOIL IN LOCATIONS, SO THAT IF EROSION OCCURS, IT WILL NOT CONTRIBUTE TO OFFSITE SEDIMENT DISCHARGE.
 - (c) PROTECT STOCKPILED SOIL PROMPTLY THROUGH THE USE OF APPROPRIATE BMPs TO REDUCE THE RISK OF EROSION AND SEDIMENT TRANSPORT. APPLY MULCH OR OTHER PROTECTIVE COVERINGS ON STOCKPILED MATERIAL THAT WILL BE EXPOSED THROUGH THE WINTER SEASON.
 - (d) DISPOSE OF EXCAVATED MATERIAL NOT USED AT THE SITE AT A LOCATION APPROVED BY THE COUNTY.
- (6) DUST CONTROL
- (a) ALL CONSTRUCTION AREAS, INCLUDING DISPOSAL SITES, SHALL BE TREATED AND MAINTAINED AS NECESSARY TO MINIMIZE THE EMISSION OF DUST. MAINTENANCE SHALL BE CONDUCTED AS NECESSARY TO PREVENT A NUISANCE TO OFFSITE PROPERTIES.
 - (b) ALL CONSTRUCTION SITES, INCLUDING DRIVEWAYS, SHALL BE MAINTAINED AS NECESSARY TO MINIMIZE THE EMISSION OF DUST AND PREVENT THE CREATION OF A NUISANCE TO ADJACENT PROPERTIES.
- (7) REVEGETATION
- (a) APPLY TEMPORARY SEEDING AND MULCHING TO DENUDED AREAS PRIOR TO OCTOBER 15 UNLESS THE PROJECT IS CONDITIONED OTHERWISE.
 - (b) ESTABLISH A PERMANENT VEGETATIVE COVER ON DENUDED AREAS NOT OTHERWISE STABILIZED. PERMANENT VEGETATION GROUND COVER MUST CONTROL SOIL EROSION SATISFACTORILY AND SURVIVE SEVERE WEATHER CONDITIONS.
 - (c) RETAIN A VEGETATIVE BARRIER WHENEVER POSSIBLE AROUND PROPERTY BOUNDARIES.
 - (d) USE SELF-SUSTAINING, NON-INVASIVE PLANTS THAT REQUIRE LITTLE OR NO MAINTENANCE AND DO NOT CREATE AN EXTREME FIRE HAZARD.
 - (e) USE NATIVE PLANT SPECIES WHENEVER FEASIBLE.

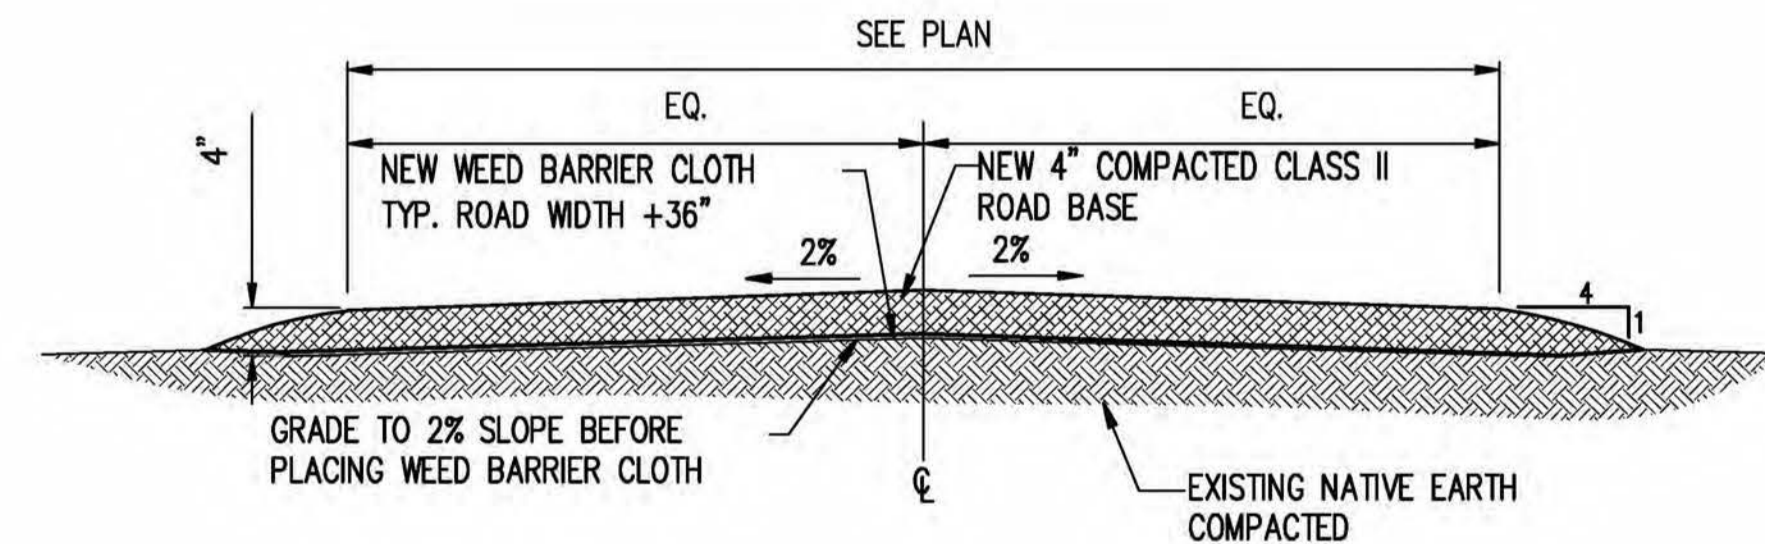


TYP. GRAVEL ROAD SECTION

SCALE: N.T.S. 1

PROPRIETARY INFORMATION
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CLIENT:



5001 EXECUTIVE PKWY
 SAN RAMON, CA 94583

PROJECT INFORMATION:

PILOT HILL 2
 3100 TRIPLE SEVEN RD
 COOL, CA 95614

REV.	DATE	DESCRIPTION	BY
1	6-19-17	90% ZONING DOC'S	RB
2	8-14-17	100% ZONING DOC'S	RB

COORDINATING ENGINEER:

Peek Site-Com



12852 Earhart Ave. Suite 101
 Auburn, California 95602
 Phone (530) 885-6160
 E-Mail info@peeksitecom.com

SEAL:



SITE #: CVL03175 CHK.: ... DRAWN BY: RB

SHEET TITLE:

GRADING NOTES & DETAILS

SHEET NUMBER: C-3 REVISION: 0

PROPRIETARY INFORMATION
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3100 TRIPLE SEVEN RD
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1	6-19-17	90% ZONING DOC'S	RB
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COORDINATING ENGINEER:

Peek Site-Com

12852 Earhart Ave. Suite 101
 Auburn, California 95602
 Phone (530) 885-6160
 E-Mail info@peeksitecom.com

SEAL:




SITE #:	CHK.:	DRAWN BY:
CVL03175	...	RB

SHEET TITLE:


GRADING PLAN

SHEET NUMBER: REVISION:


C-4 0

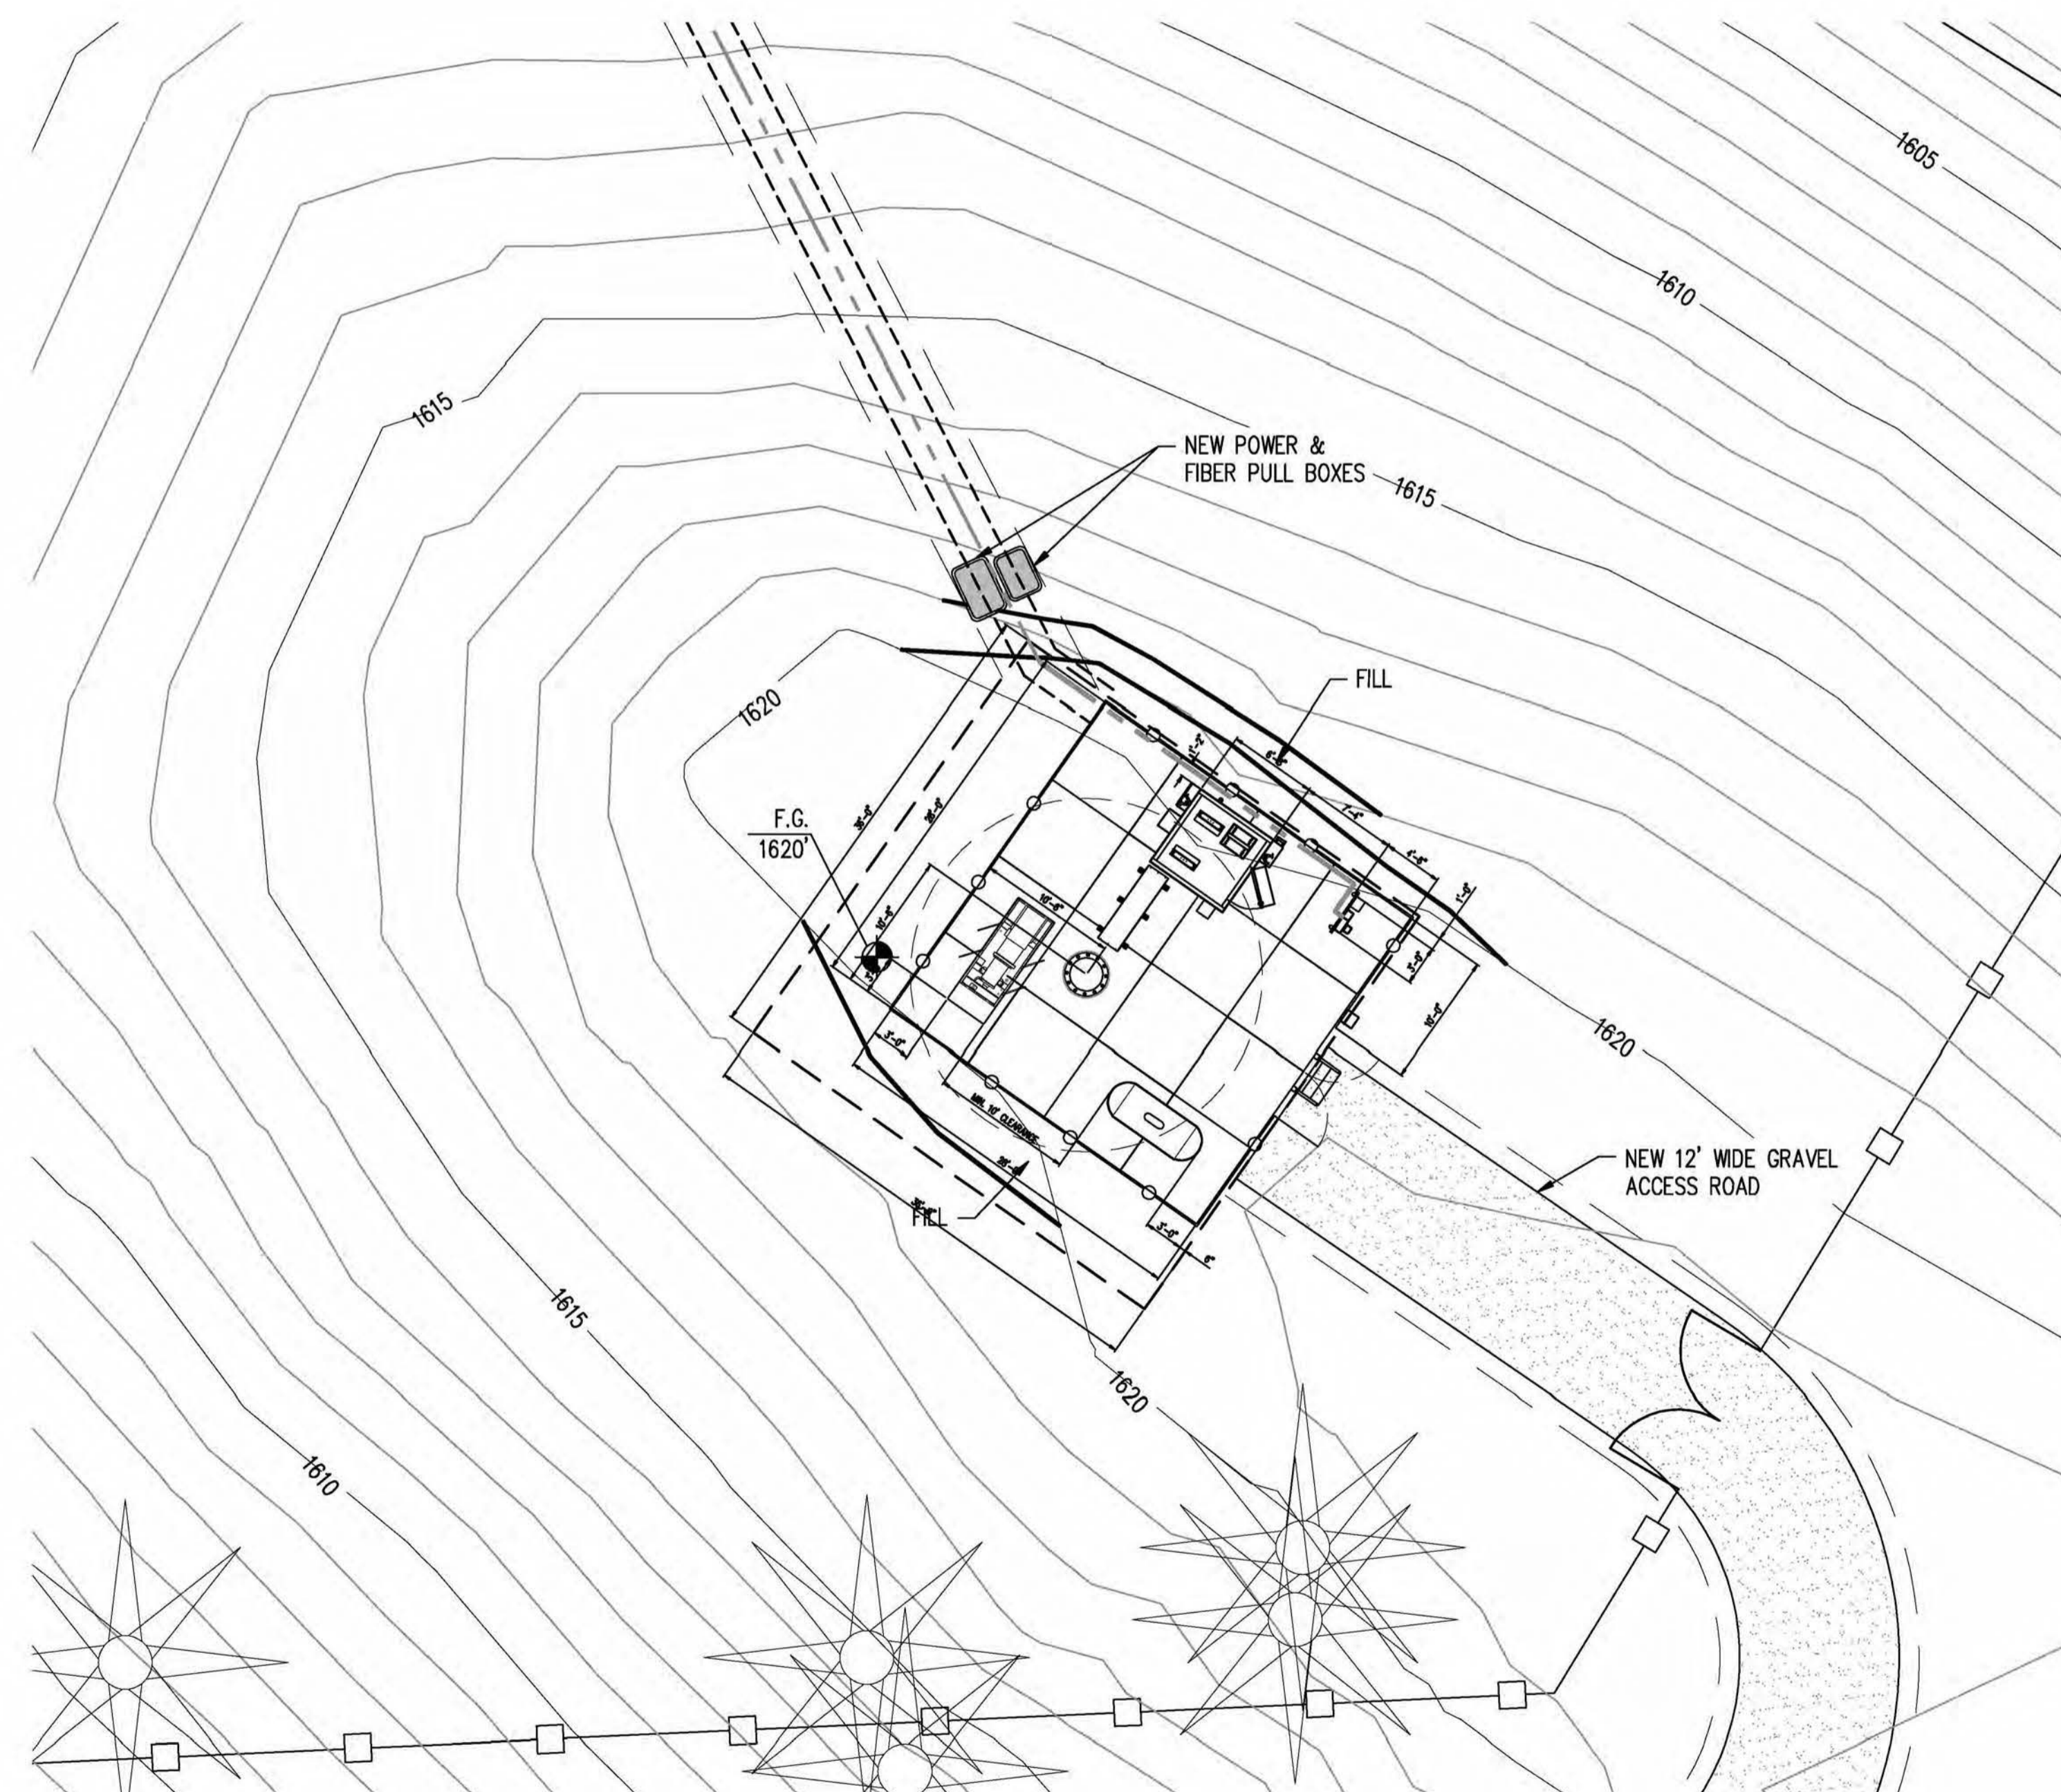

PRELIMINARY GRADING PLAN

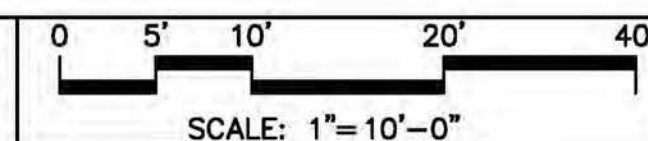


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5001 EXECUTIVE PKWY
 SAN RAMON, CA 94583

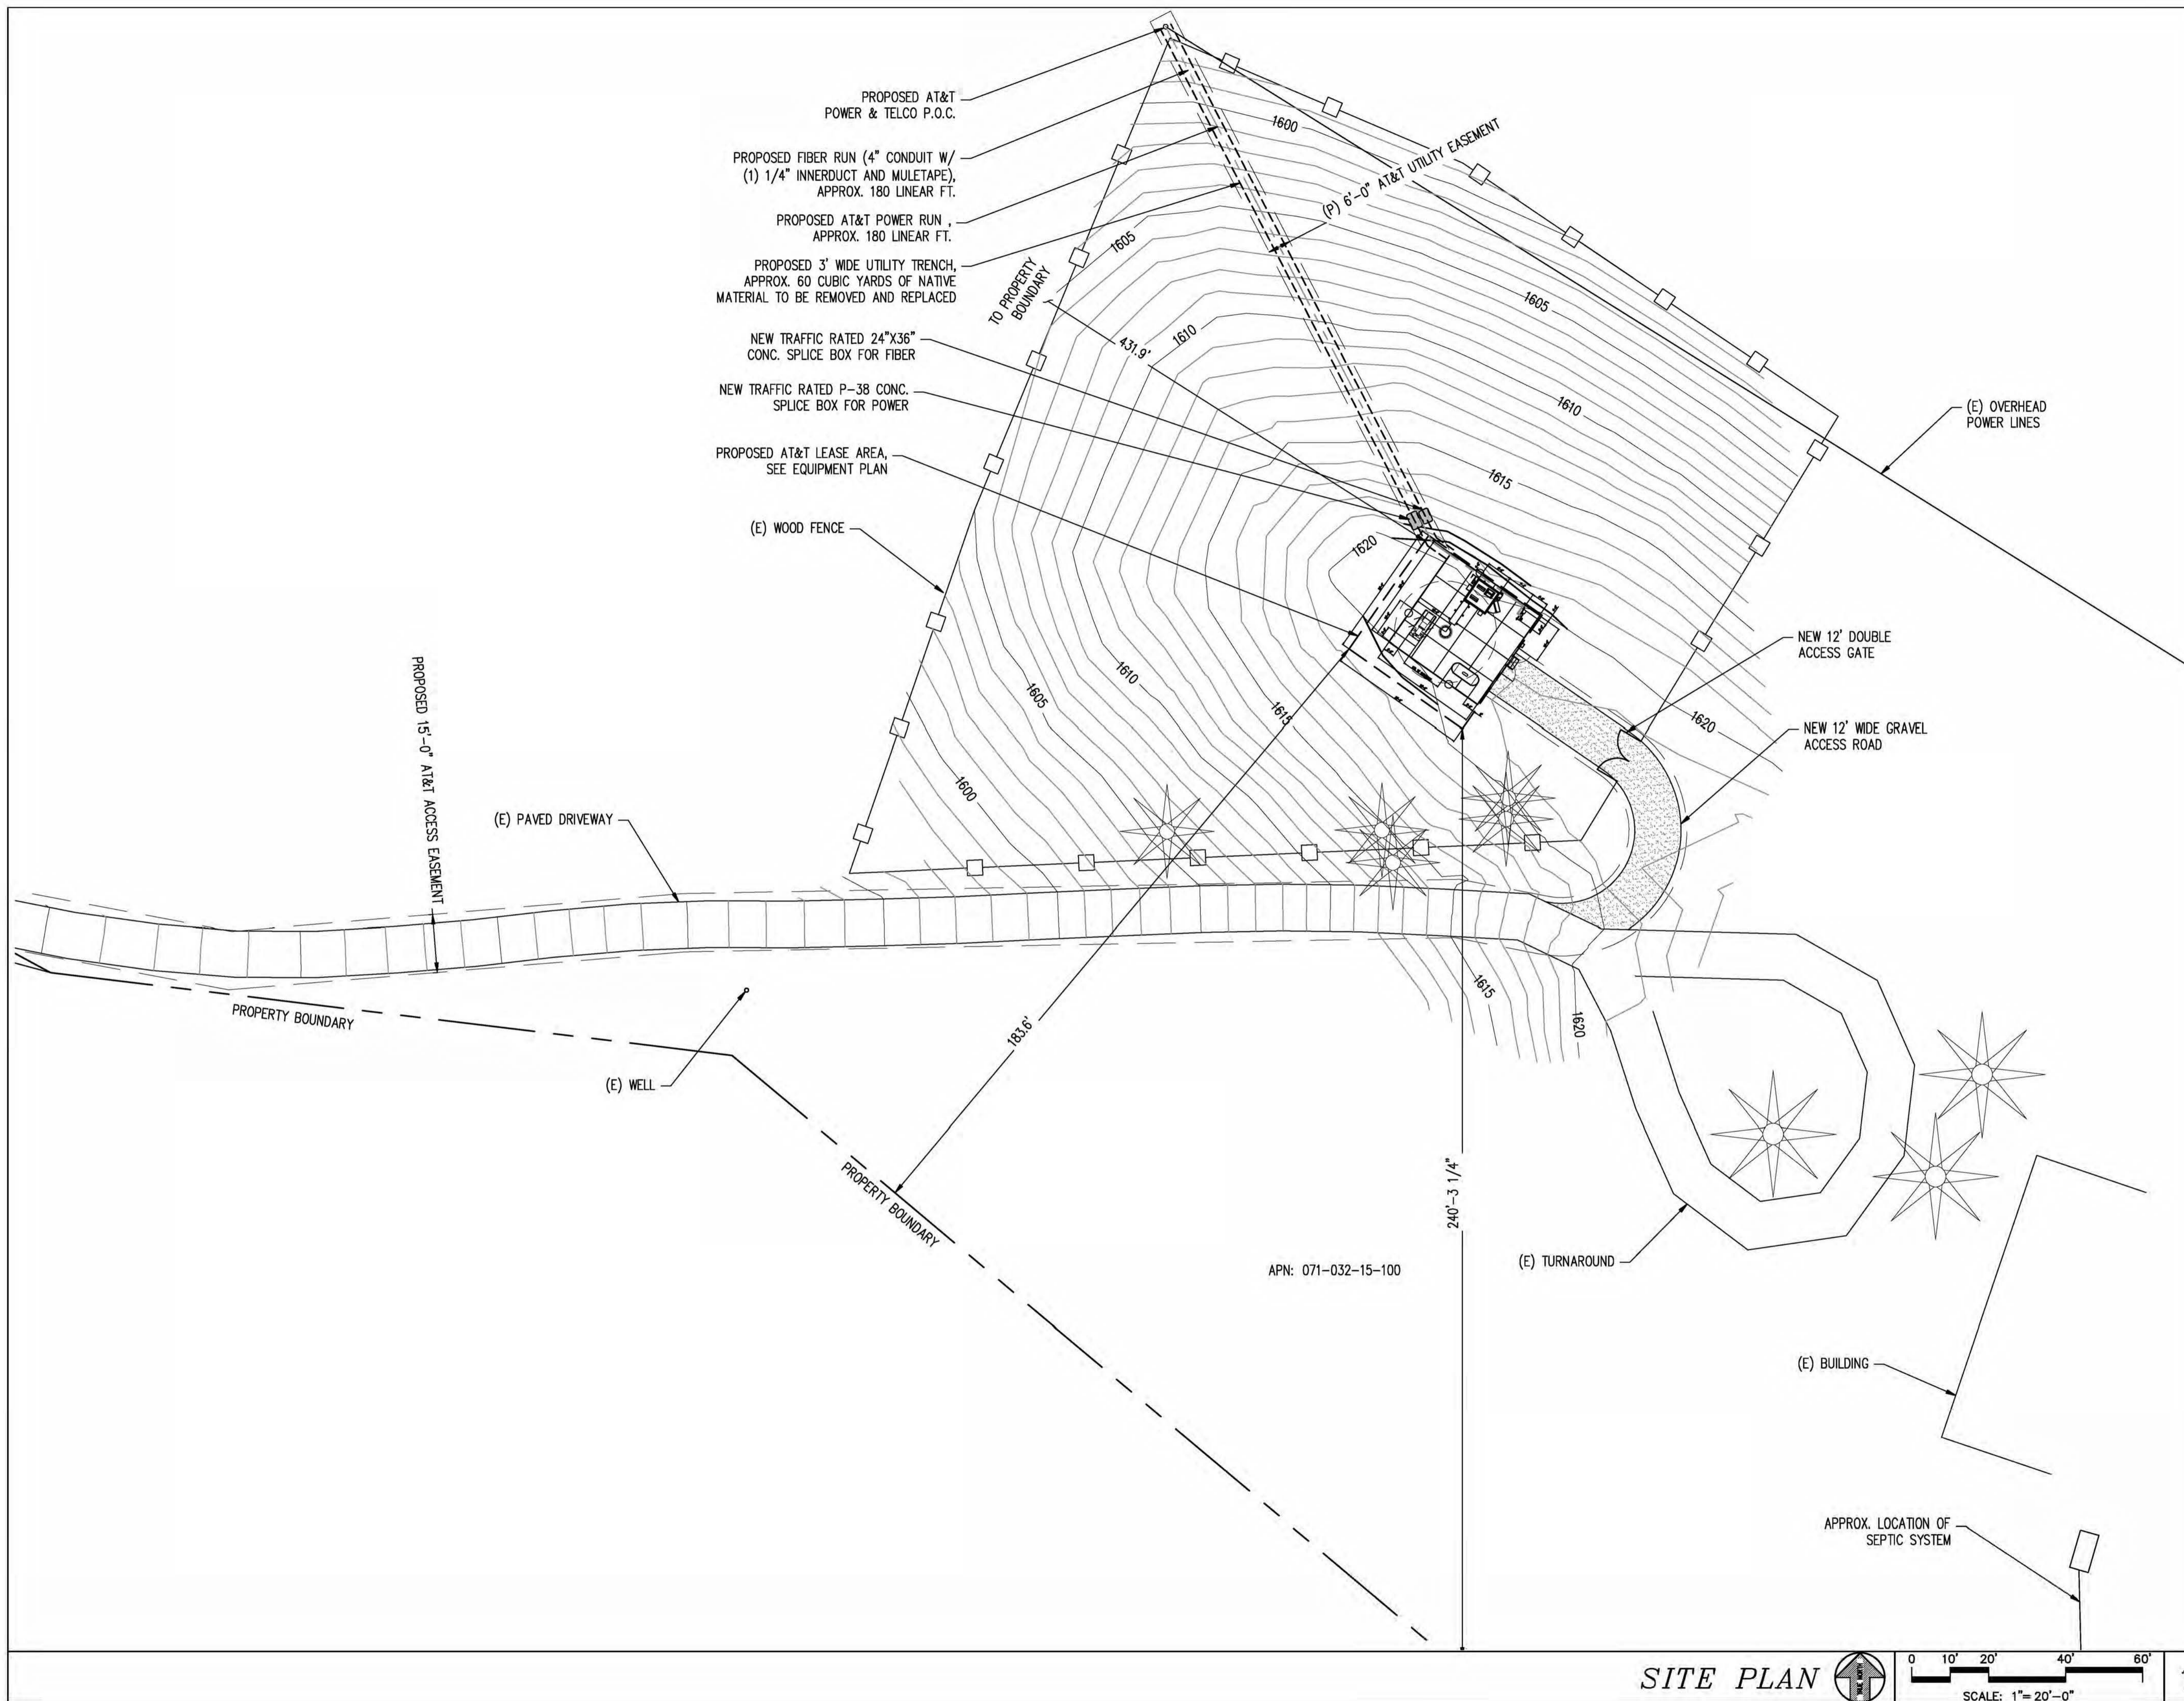PROJECT INFORMATION:

PILOT HILL 2
 3100 TRIPLE SEVEN RD
 COOL, CA 95614

REV.	DATE	DESCRIPTION	BY
1	6-19-17	90% ZONING DOC'S	RB
2	8-14-17	100% ZONING DOC'S	RB

COORDINATING ENGINEER:

Peek Site-Com
 12852 Earhart Ave. Suite 101
 Auburn, California 95602
 Phone (530) 885-6160
 E-Mail info@peeksitecom.com

SEAL:


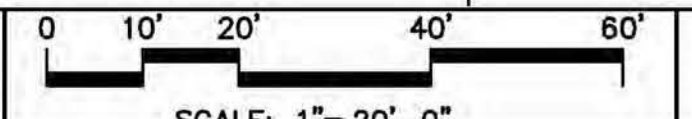


SITE #	CHK.	DRAWN BY:
CVL03175	...	RB

SHEET TITLE:

SITE PLAN

SHEET NUMBER: **A-1** REVISION: **0**

SITE PLAN 

 1

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2	8-14-17	100% ZONING DOC'S	RB

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SITE #: _____ CHK.: _____ DRAWN BY: _____

CVL03175 ... RB

SHEET TITLE:

EQUIPMENT PLAN

SHEET NUMBER: _____ REVISION: _____


A-2 0



KEY NOTES

1. NEW 6'-8"x6'-8" LIGHTWEIGHT PRE-FAB "MC" EQUIPMENT SHELTER
2. (1) NEW GPS ANTENNA
3. NEW 200A ELEC. PANEL, PROVIDED WITH SHELTER
4. TELCO BOX, PROVIDED WITH SHELTER
5. NEW D/C POWER PLANT, PROVIDED WITH SHELTER
6. NEW 23" FIF RACK, PROVIDED WITH SHELTER, TYP. OF (2)
7. NEW HEAVY DUTY METAL CABLE TRAY LID W/ CONC. SLEEPERS EVERY 4'
8. NEW MONOPINE
9. NEW 500 GAL LP PROPANE TANK ON NEW CONC. SLAB
10. NEW 35 KW GENERAC BACK-UP GENERATOR
11. NEW 6'-0" CHAIN LINK FENCE W/ VINYL SLATS
12. NEW 8' WIDE DOUBLE ACCESS GATE
13. NEW GRAVEL ROAD
14. NEW U/G POWER AND TELCO CONDUITS
15. NEW CAMLOCK GENERATOR INTERFACE
16. NEW TRAFFIC RATED 24"x36" CONC. SPLICE BOX FOR FIBER
17. NEW TRAFFIC RATED P-38 CONC. SPLICE BOX FOR POWER
18. NEW UTILITY RACK
19. NEW 2A:20BC RATED FIRE EXTINGUISHER IN WEATHER RESISTANT CABINET
20. 24" MAX BRANCH DIAMETER AT BASE OF POLE
21. NEW HVAC, PROVIDED WITH SHELTER
22. NEW OUTDOOR LIGHTS PROVIDED WITH SHELTER, W/ TIMER AND MOTION SENSOR
23. NEW CELL BLOCK FOUNDATION
24. NEW AT&T 36"x36" LEASE AREA
25. NEW FIRE DEPT. KNOX BOX
26. NEW CARRIER CONTACT SIGNAGE AT GATE
27. NEW CIENA WITHIN FIF RACK
28. NEW 200A METER MAIN
29. NEW SOUND BLANKET BBC-13X, 1.2 LBS. PSF MIN. OR EQUAL SOUND BLANKET AT INTERIOR SIDE OF FENCE

EQUIPMENT PLAN

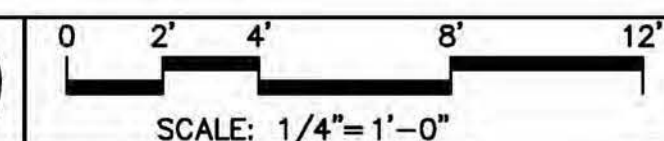

SCALE: 1/4" = 1'-0"

1

RF SCHEDULE

SECTOR/POS.	ANTENNA MODEL	RAD CENTER	PHYSICAL AZIMUTH	RRU	TMA	FIBER LENGTH	COAX LENGTH	COAX DIA.	NO.
A/1	QS6656-3	± 110'	90°	(1) RRUS-11 & (1) RRUS-32 B2	N/A	± 160'	± N/A	N/A	-
A/2	QS6658-3	± 110'	90°	(1) RRUS-11, (1) RRUS-12 & (1) RRUS-32 B66	N/A	± 160'	± N/A	N/A	-
A/3	HBSA-M65R-KU-H6	± 100'	90°	(1) RRUS-32 B30	N/A	± 170'	± N/A	N/A	-
A/4	HBSA-M65R-KU-H6	± 100'	90°	(1) RRUS-32 B30	N/A	± 170'	± N/A	N/A	-
B/1	QS6656-3	± 110'	330°	(1) RRUS-11 & (1) RRUS-32 B2	N/A	± 160'	± N/A	N/A	-
B/2	QS6658-3	± 110'	330°	(1) RRUS-12 & (1) RRUS-32 B66	N/A	± 160'	± N/A	N/A	-
B/3	HBSA-M65R-KU-H6	± 100'	330°	(1) RRUS-11	N/A	± 170'	± N/A	N/A	-
B/4	HBSA-M65R-KU-H6	± 100'	330°	(1) RRUS-32 B30	N/A	± 170'	± N/A	N/A	-
C/1	QS6656-3	± 110'	210°	(1) RRUS-11 & (1) RRUS-32 B2	N/A	± 160'	± N/A	N/A	-
C/2	QS6658-3	± 110'	210°	(1) RRUS-12 & (1) RRUS-32 B66	N/A	± 160'	± N/A	N/A	-
C/3	HBSA-M65R-KU-H6	± 100'	210°	(1) RRUS-11	N/A	± 170'	± N/A	N/A	-
C/4	HBSA-M65R-KU-H6	± 100'	210°	(1) RRUS-32 B30	N/A	± 170'	± N/A	N/A	-

RF SCHEDULE

SCALE: N.T.S. 1

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SAN RAMON, CA 94583

PROJECT INFORMATION:

PILOT HILL 2

3100 TRIPLE SEVEN RD
COOL, CA 95614

REV: DATE: DESCRIPTION: BY:

1	6-19-17	90% ZONING DOC'S	RB
2	8-14-17	100% ZONING DOC'S	RB

COORDINATING ENGINEER:

Peek Site-Com

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Auburn, California 95602
Phone (530) 885-6160

E-Mail info@peeksitecom.com

SEAL:



SITE #: CHK.: DRAWN BY:


CVL03175 ... RB

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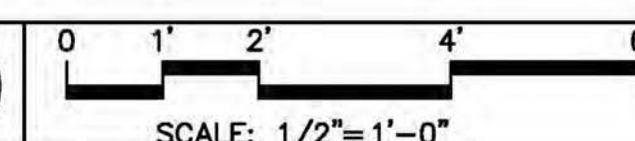
ANTENNA PLAN

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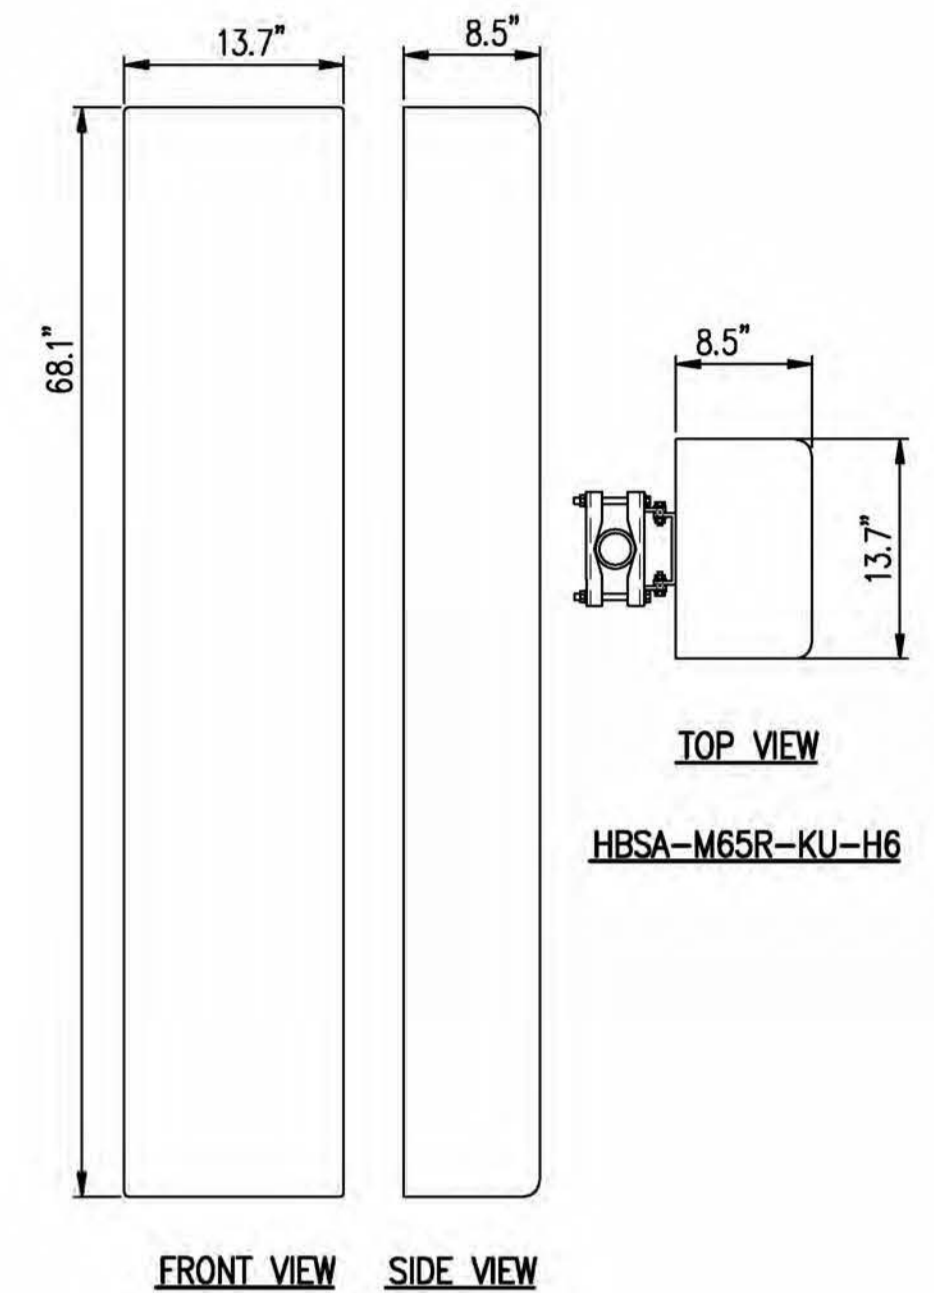
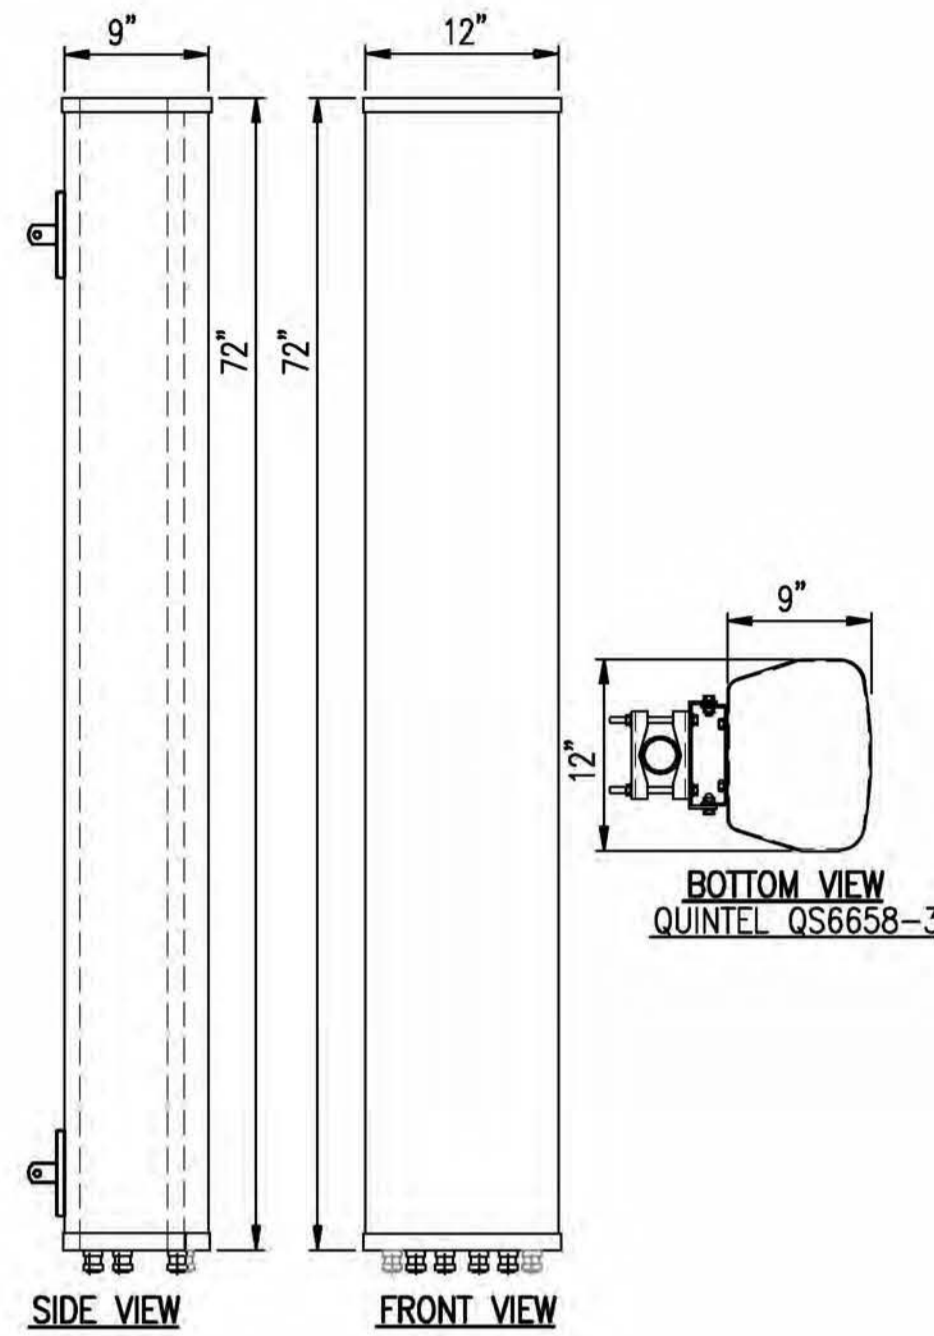
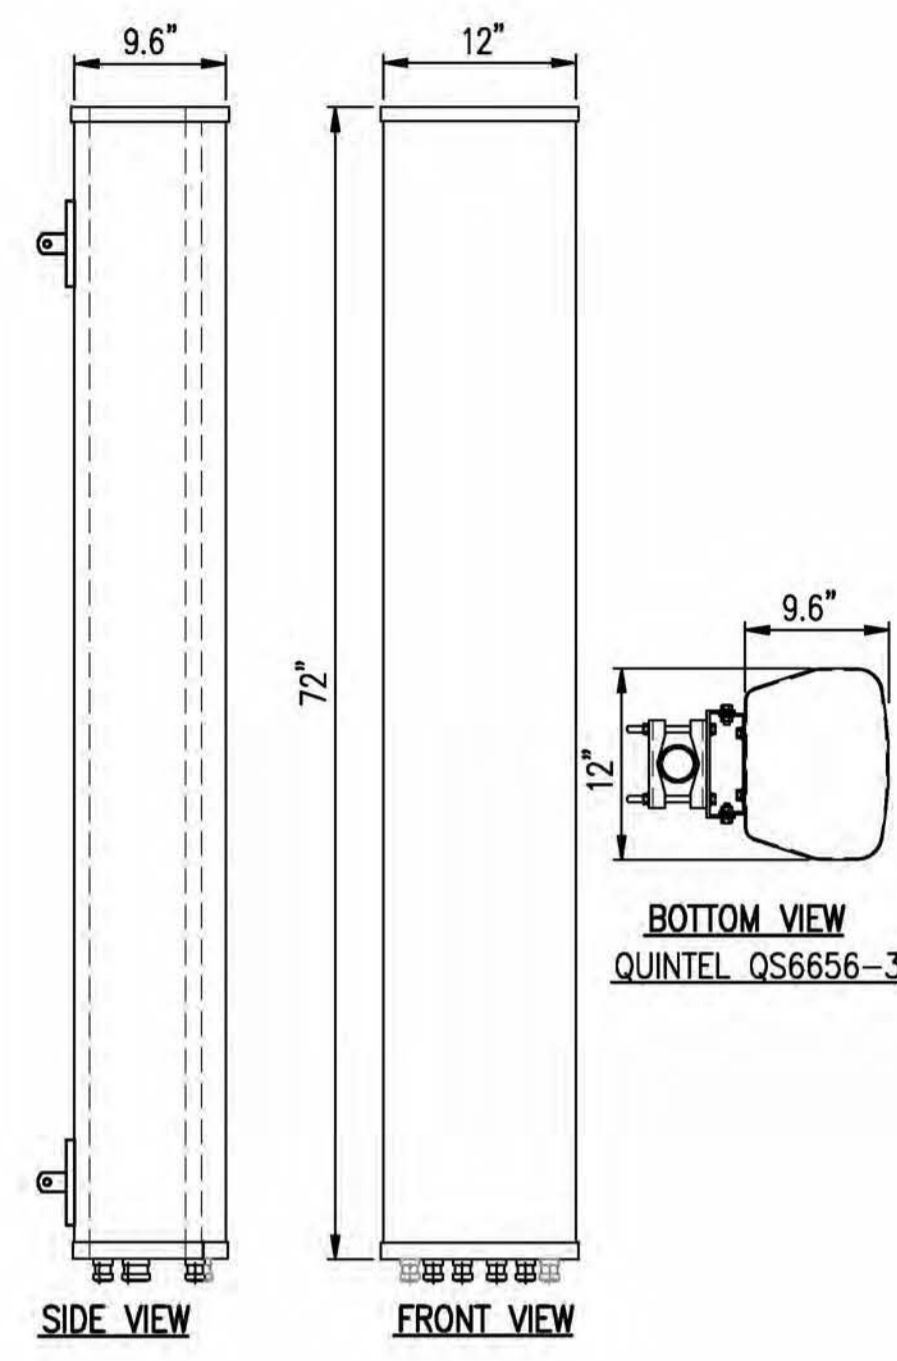
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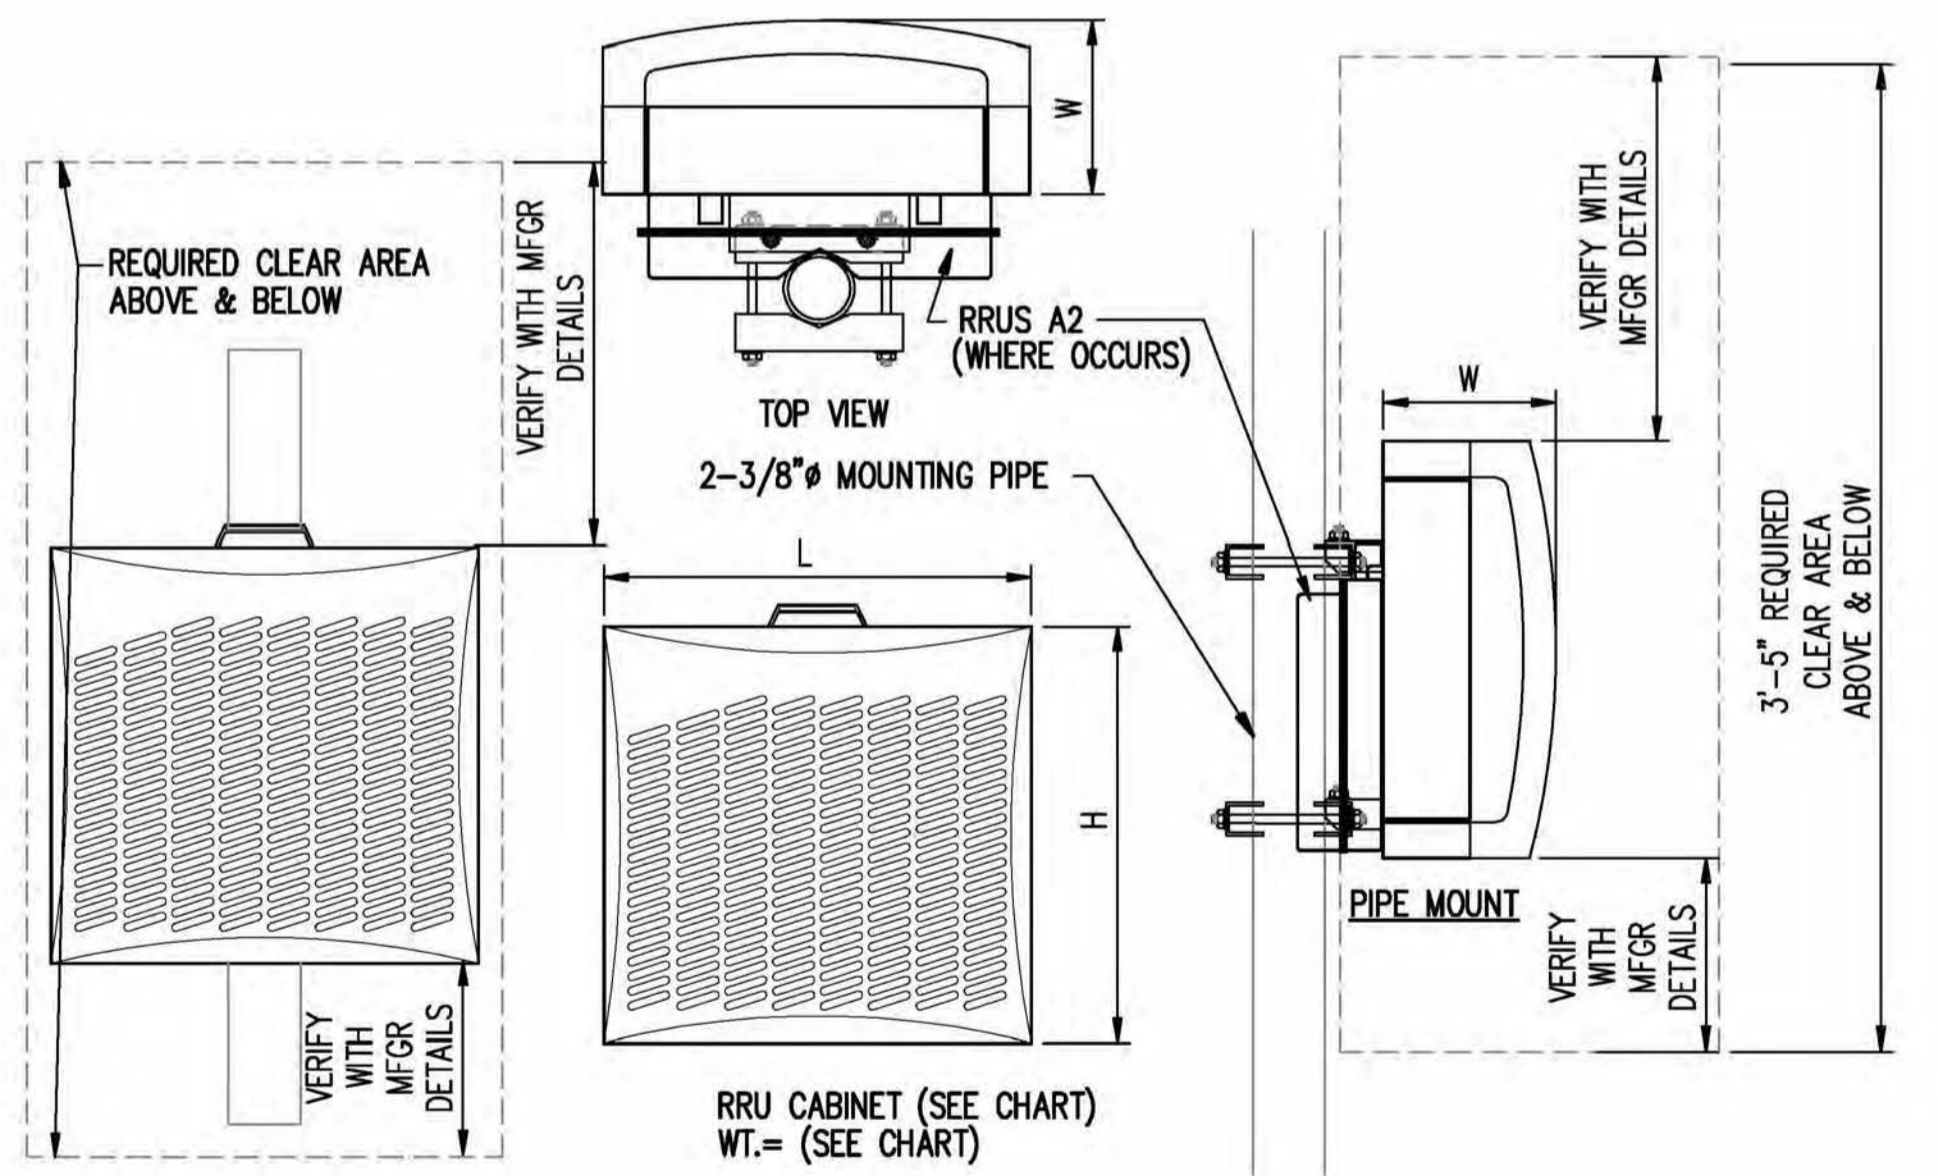
ANTENNA PLAN



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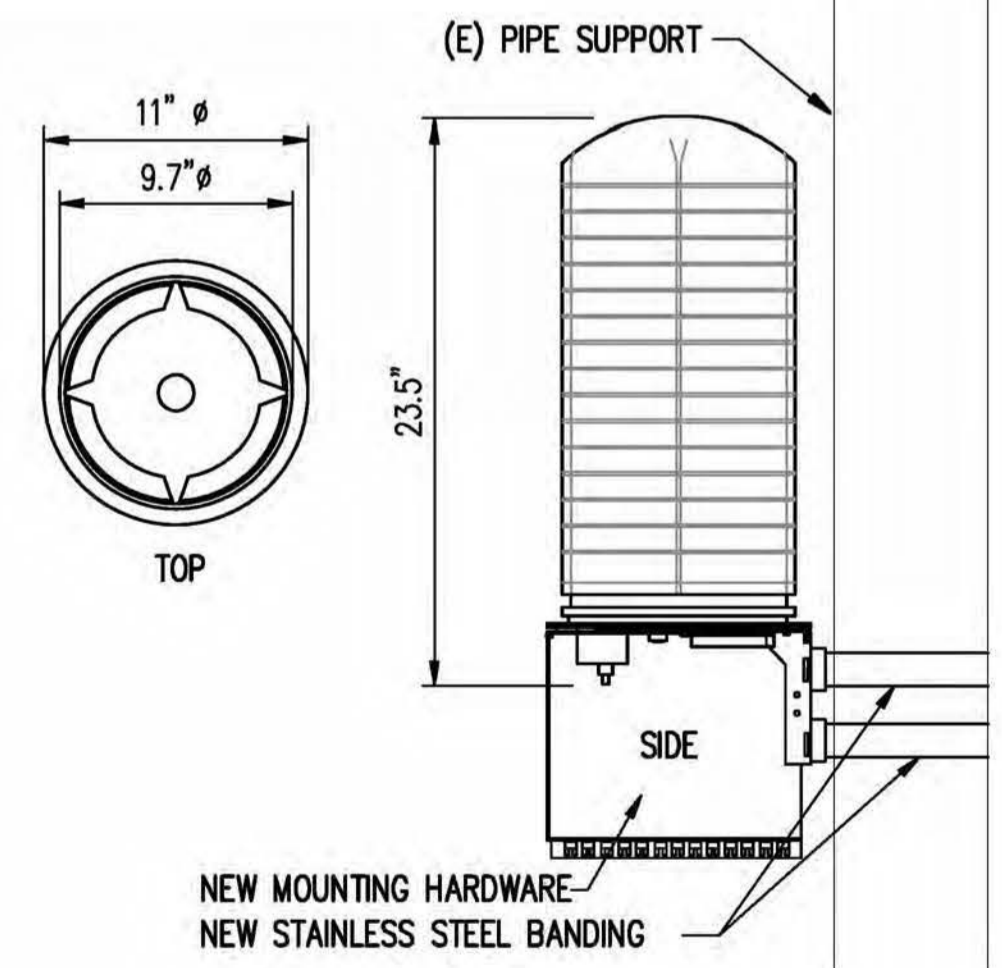
ANTENNA DETAIL SCALE: N.T.S. 1

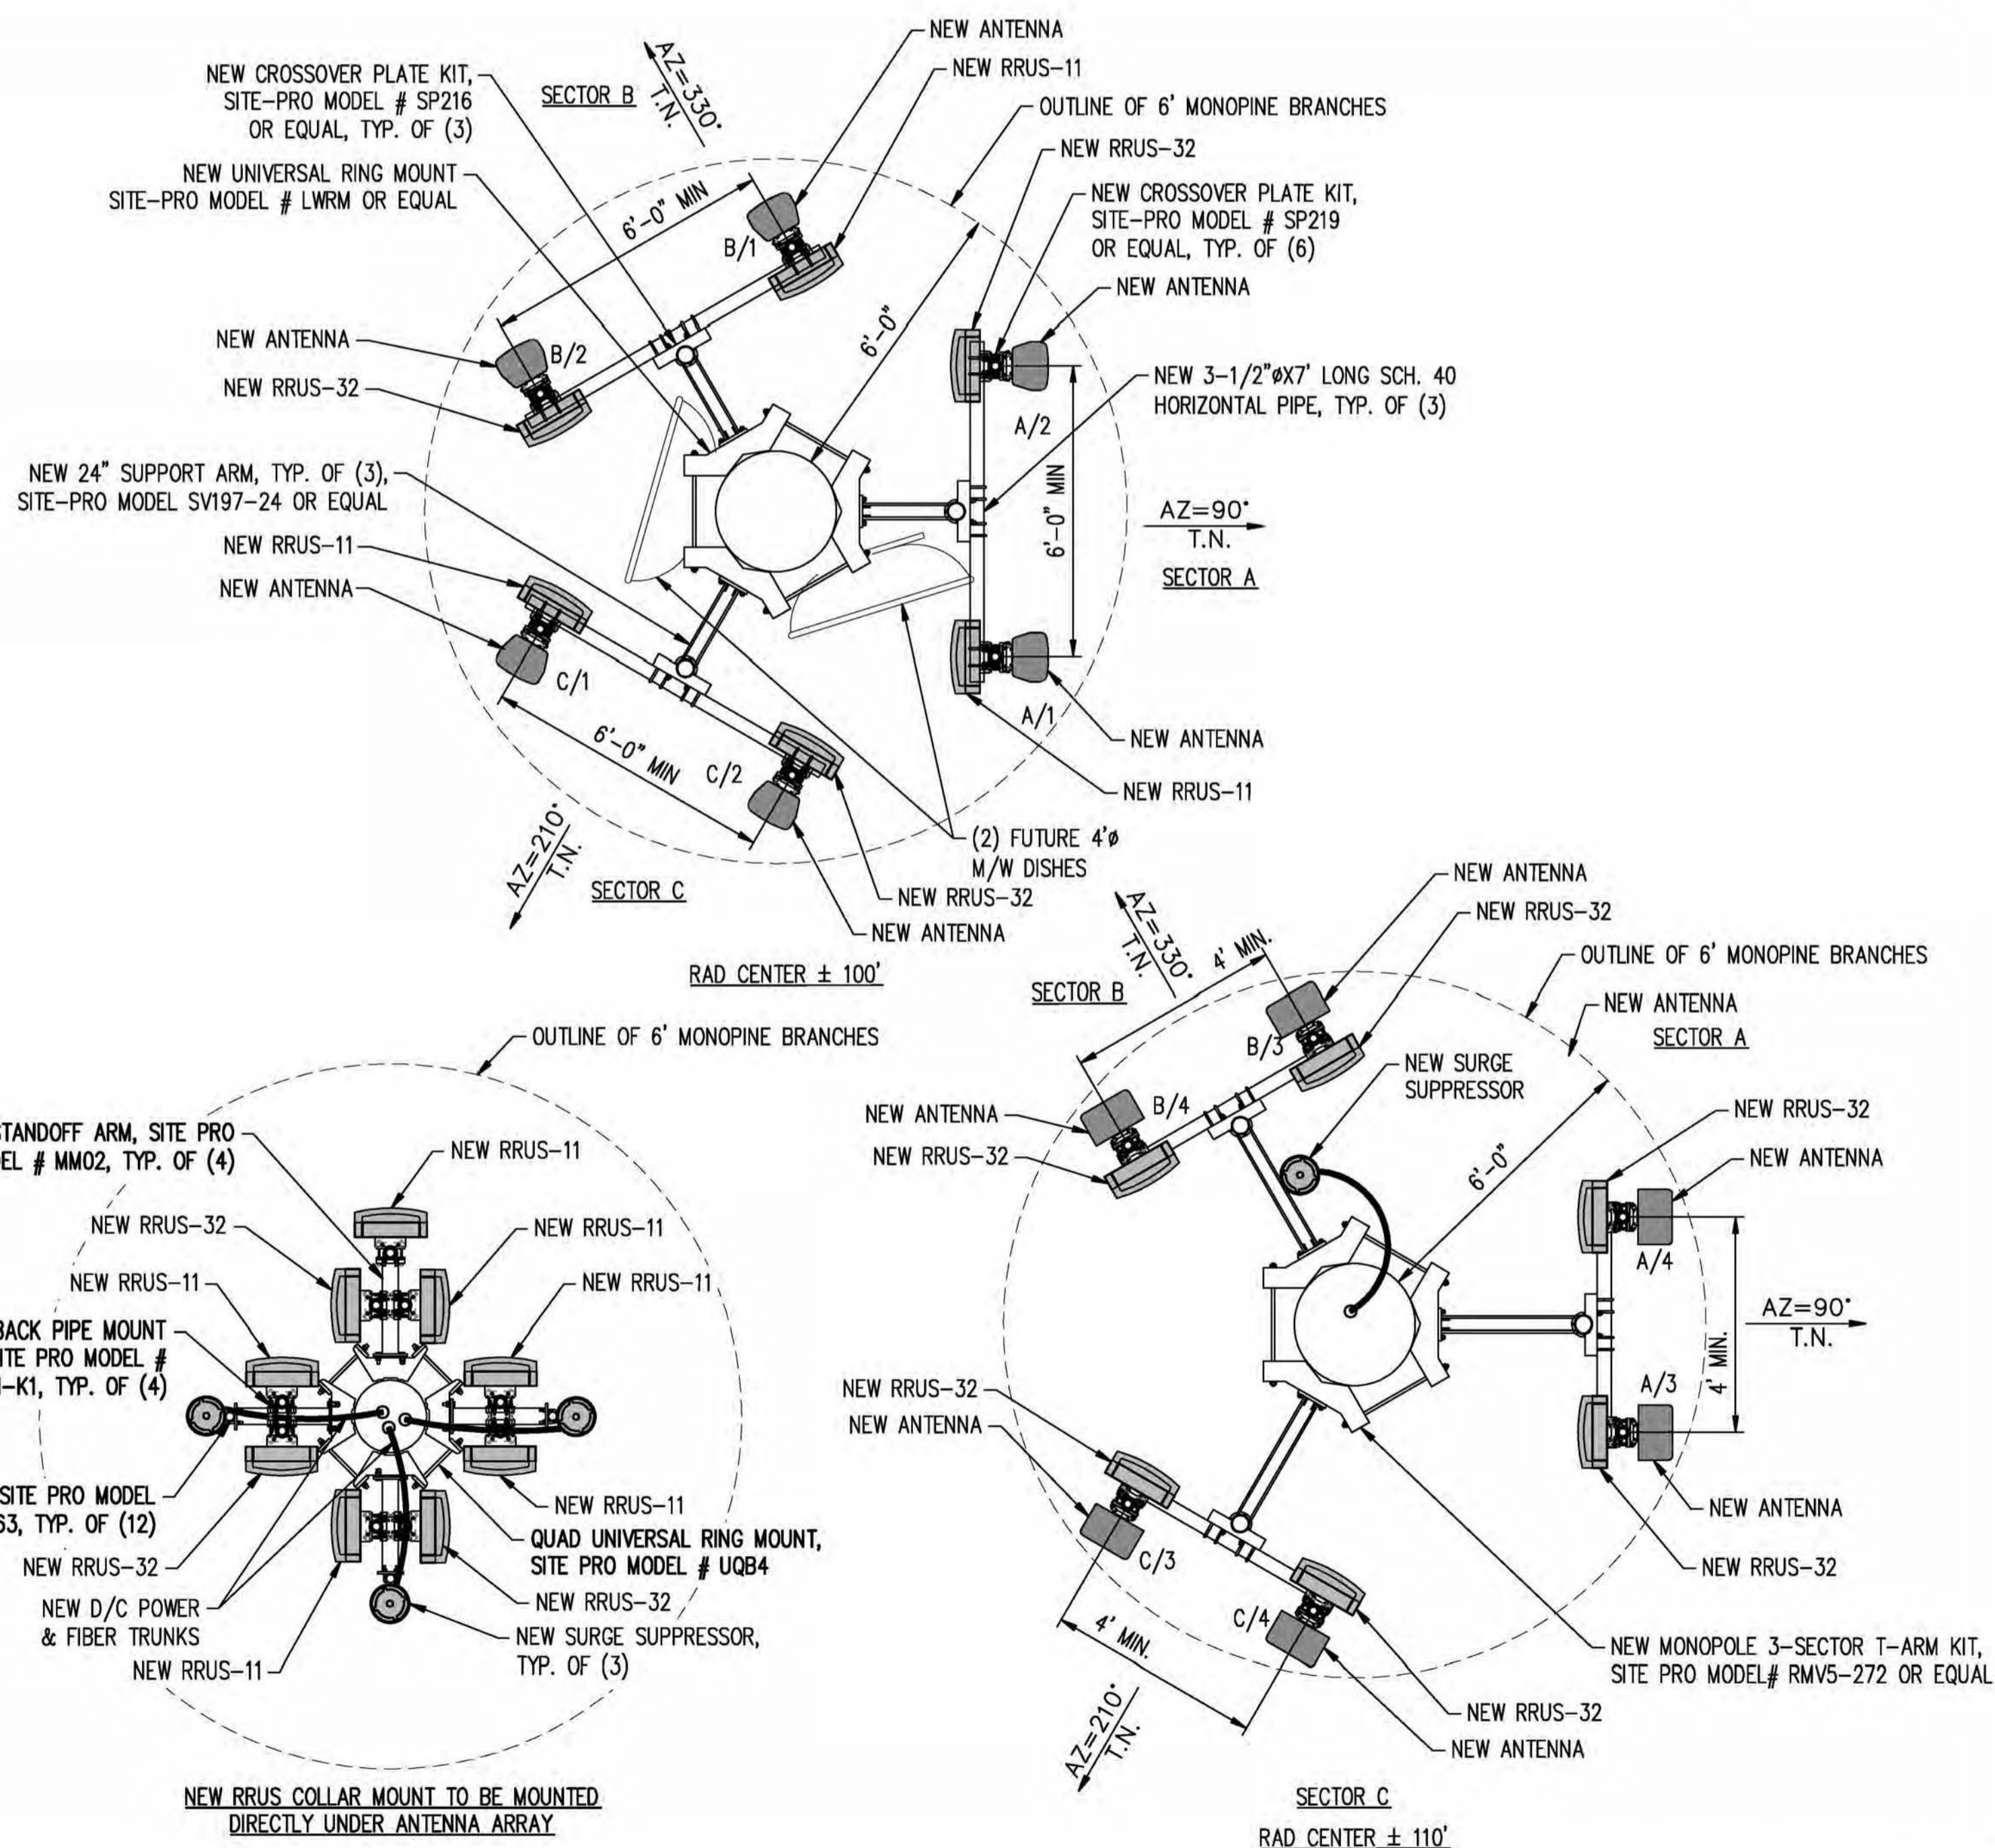

TYPE	LENGTH	HEIGHT	WIDTH	WEIGHT
RRU-11	17.8"	17.3"	7.19"	50 LBS
RRUS-E2	20.4"	18.5"	7.5"	50 LBS
RRUS-32	29.9"	13.3"	9.5"	60 LBS
RRU-12	20.4"	18.5"	7.5"	50 LBS
A2	12.8"	15"	3.5"	21 LBS

NOTE: SEE RF SHEET FOR RRU PLACEMENT

RRU DETAIL SCALE: N.T.S. 3



SURGE SUPPRESSOR DETAIL SCALE: N.T.S. 2

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SAN RAMON, CA 94583

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3100 TRIPLE SEVEN RD
COOL, CA 95614

REV: = DATE: = DESCRIPTION: = BY: =

REV	DATE	DESCRIPTION	BY
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2	8-14-17	100% ZONING DOC'S	RB

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Auburn, California 95602
Phone (530) 885-6160
E-Mail info@peeksitecom.com

SEAL:

SITE #: CVL03175 CHK.: ... DRAWN BY: RB

SHEET TITLE: **DETAILS**

SHEET NUMBER: **A-3.1** REVISION: **0**

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SEAL:



SITE #: = CHK.: = DRAWN BY: =

CVL03175 ... RB

SHEET TITLE: =

ELEVATIONS

SHEET NUMBER: = REVISION: =

A-4 0

NOTE:

- BROADLEAF BRANCHES SHOWN ARE FOR ILLUSTRATIVE PURPOSES ONLY AND ARE NOT TO SCALE.
- TRUNK TO BE PAINTED KELLEY MOOR LOG CABIN BROWN OR EQUAL.
- ANTENNAS TO BE CONCEALED WITH ANTENNAS SOCKS
- RRUS TO BE PAINTED BROWN

- TOP OF MONOPINE BRANCHES @ ±120' AGL
- OVERALL HEIGHT OF MONOPINE & TOP OF AT&T ANTENNAS @ ±113' AGL

- AT&T RAD CENTER @ ±110' AGL

- AT&T RAD CENTER @ ±100' AGL

- BOTTOM OF AT&T ANTENNAS @ ±97' AGL

- NEW AT&T ANTENNA, TYP. OF (4) PER SECTOR FOR A TOTAL OF (12)
- NEW RRU, TYP. OF (18) & (3) FUTURE RRU'S, MOUNTED ON RRU COLLAR MOUNT BELOW ANTENNAS

- NEW SURGE SUPPRESSOR, TYP. OF (3) (2) FUTURE 4' M/W DISHES

- FUTURE ANTENNAS BY OTHER CARRIERS

- RAD CENTER OF FUTURE MICROWAVE DISH @ ±92'-6" AGL

- RAD CENTER OF FUTURE ANTENNAS BY OTHER CARRIER @ ±85' AGL

- RAD CENTER OF FUTURE ANTENNAS BY OTHER CARRIER @ ±70' AGL

- START OF MONOPINE BRANCHES @ ±22' AGL

- TOP OF CHAIN LINK FENCE @ ±8' AGL

- TOP OF PRE-CAST CELL BLOCK FOUNDATION @ ±2' AGL

- FINISH GRADE @ 0' AGL

- NEW MONOPINE
- NEW D/C & FIBER TRUNK
- NEW LIGHTWEIGHT PRE-FAB SHELTER
- NEW 6' CHAIN LINK FENCE W/ PRIVACY SLATS
- NEW GRADE (E) GRADE

- TOP OF MONOPINE BRANCHES @ ±120' AGL
- OVERALL HEIGHT OF MONOPINE & TOP OF AT&T ANTENNAS @ ±113' AGL

- AT&T RAD CENTER @ ±110' AGL

- AT&T RAD CENTER @ ±100' AGL

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- RAD CENTER OF FUTURE ANTENNAS BY OTHER CARRIER @ ±70' AGL

- START OF MONOPINE BRANCHES @ ±20' AGL


- TOP OF CHAIN LINK FENCE @ ±8' AGL

- TOP OF PRE-CAST CELL BLOCK FOUNDATION @ ±2' AGL

- FINISH GRADE @ 0' AGL


- NEW MONOPINE
- NEW D/C & FIBER TRUNK
- NEW LIGHTWEIGHT PRE-FAB SHELTER
- NEW GPS ANTENNA
- NEW 6' CHAIN LINK FENCE W/ PRIVACY SLATS
- (E) GRADE

SOUTHWEST ELEVATION

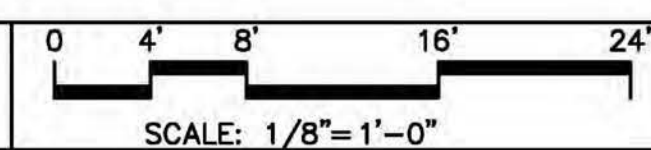



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SOUTHEAST ELEVATION

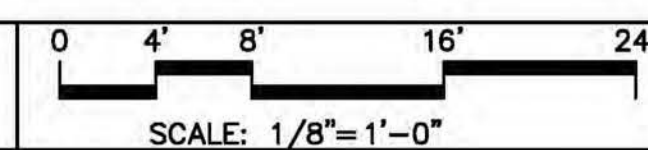


1

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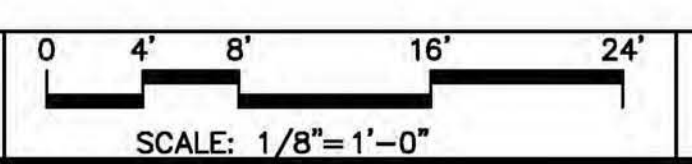


NORTHEAST ELEVATION

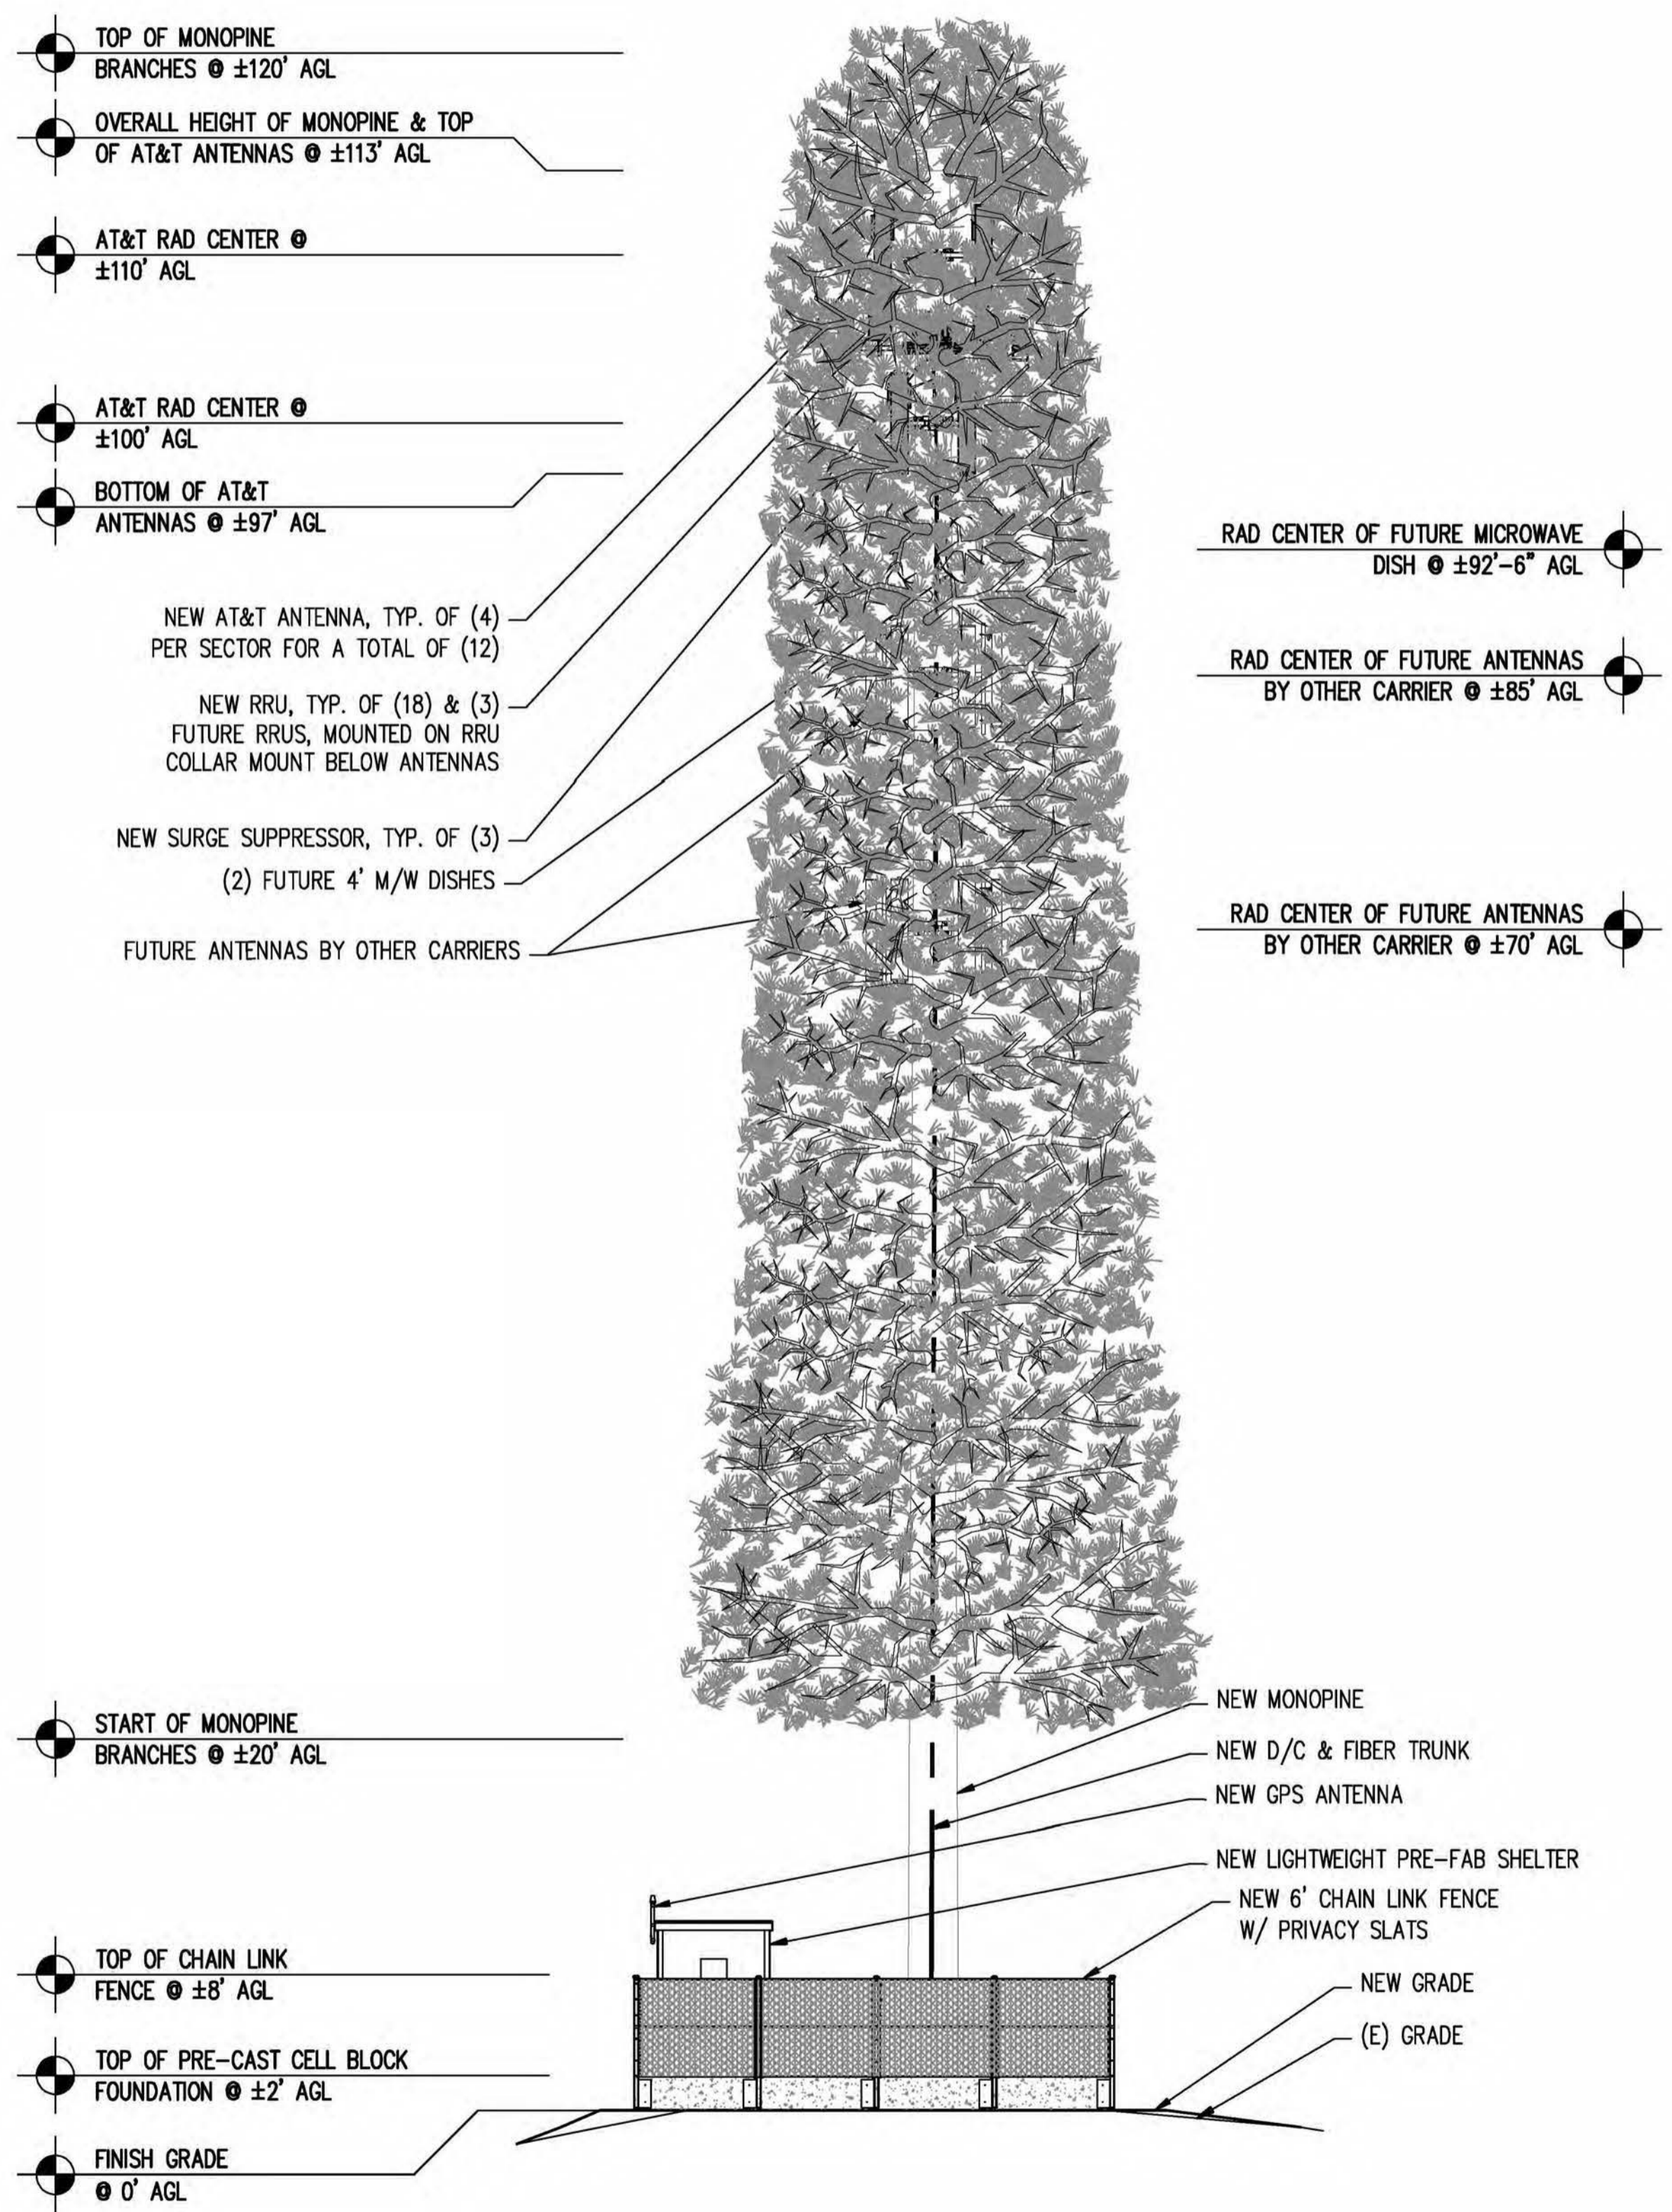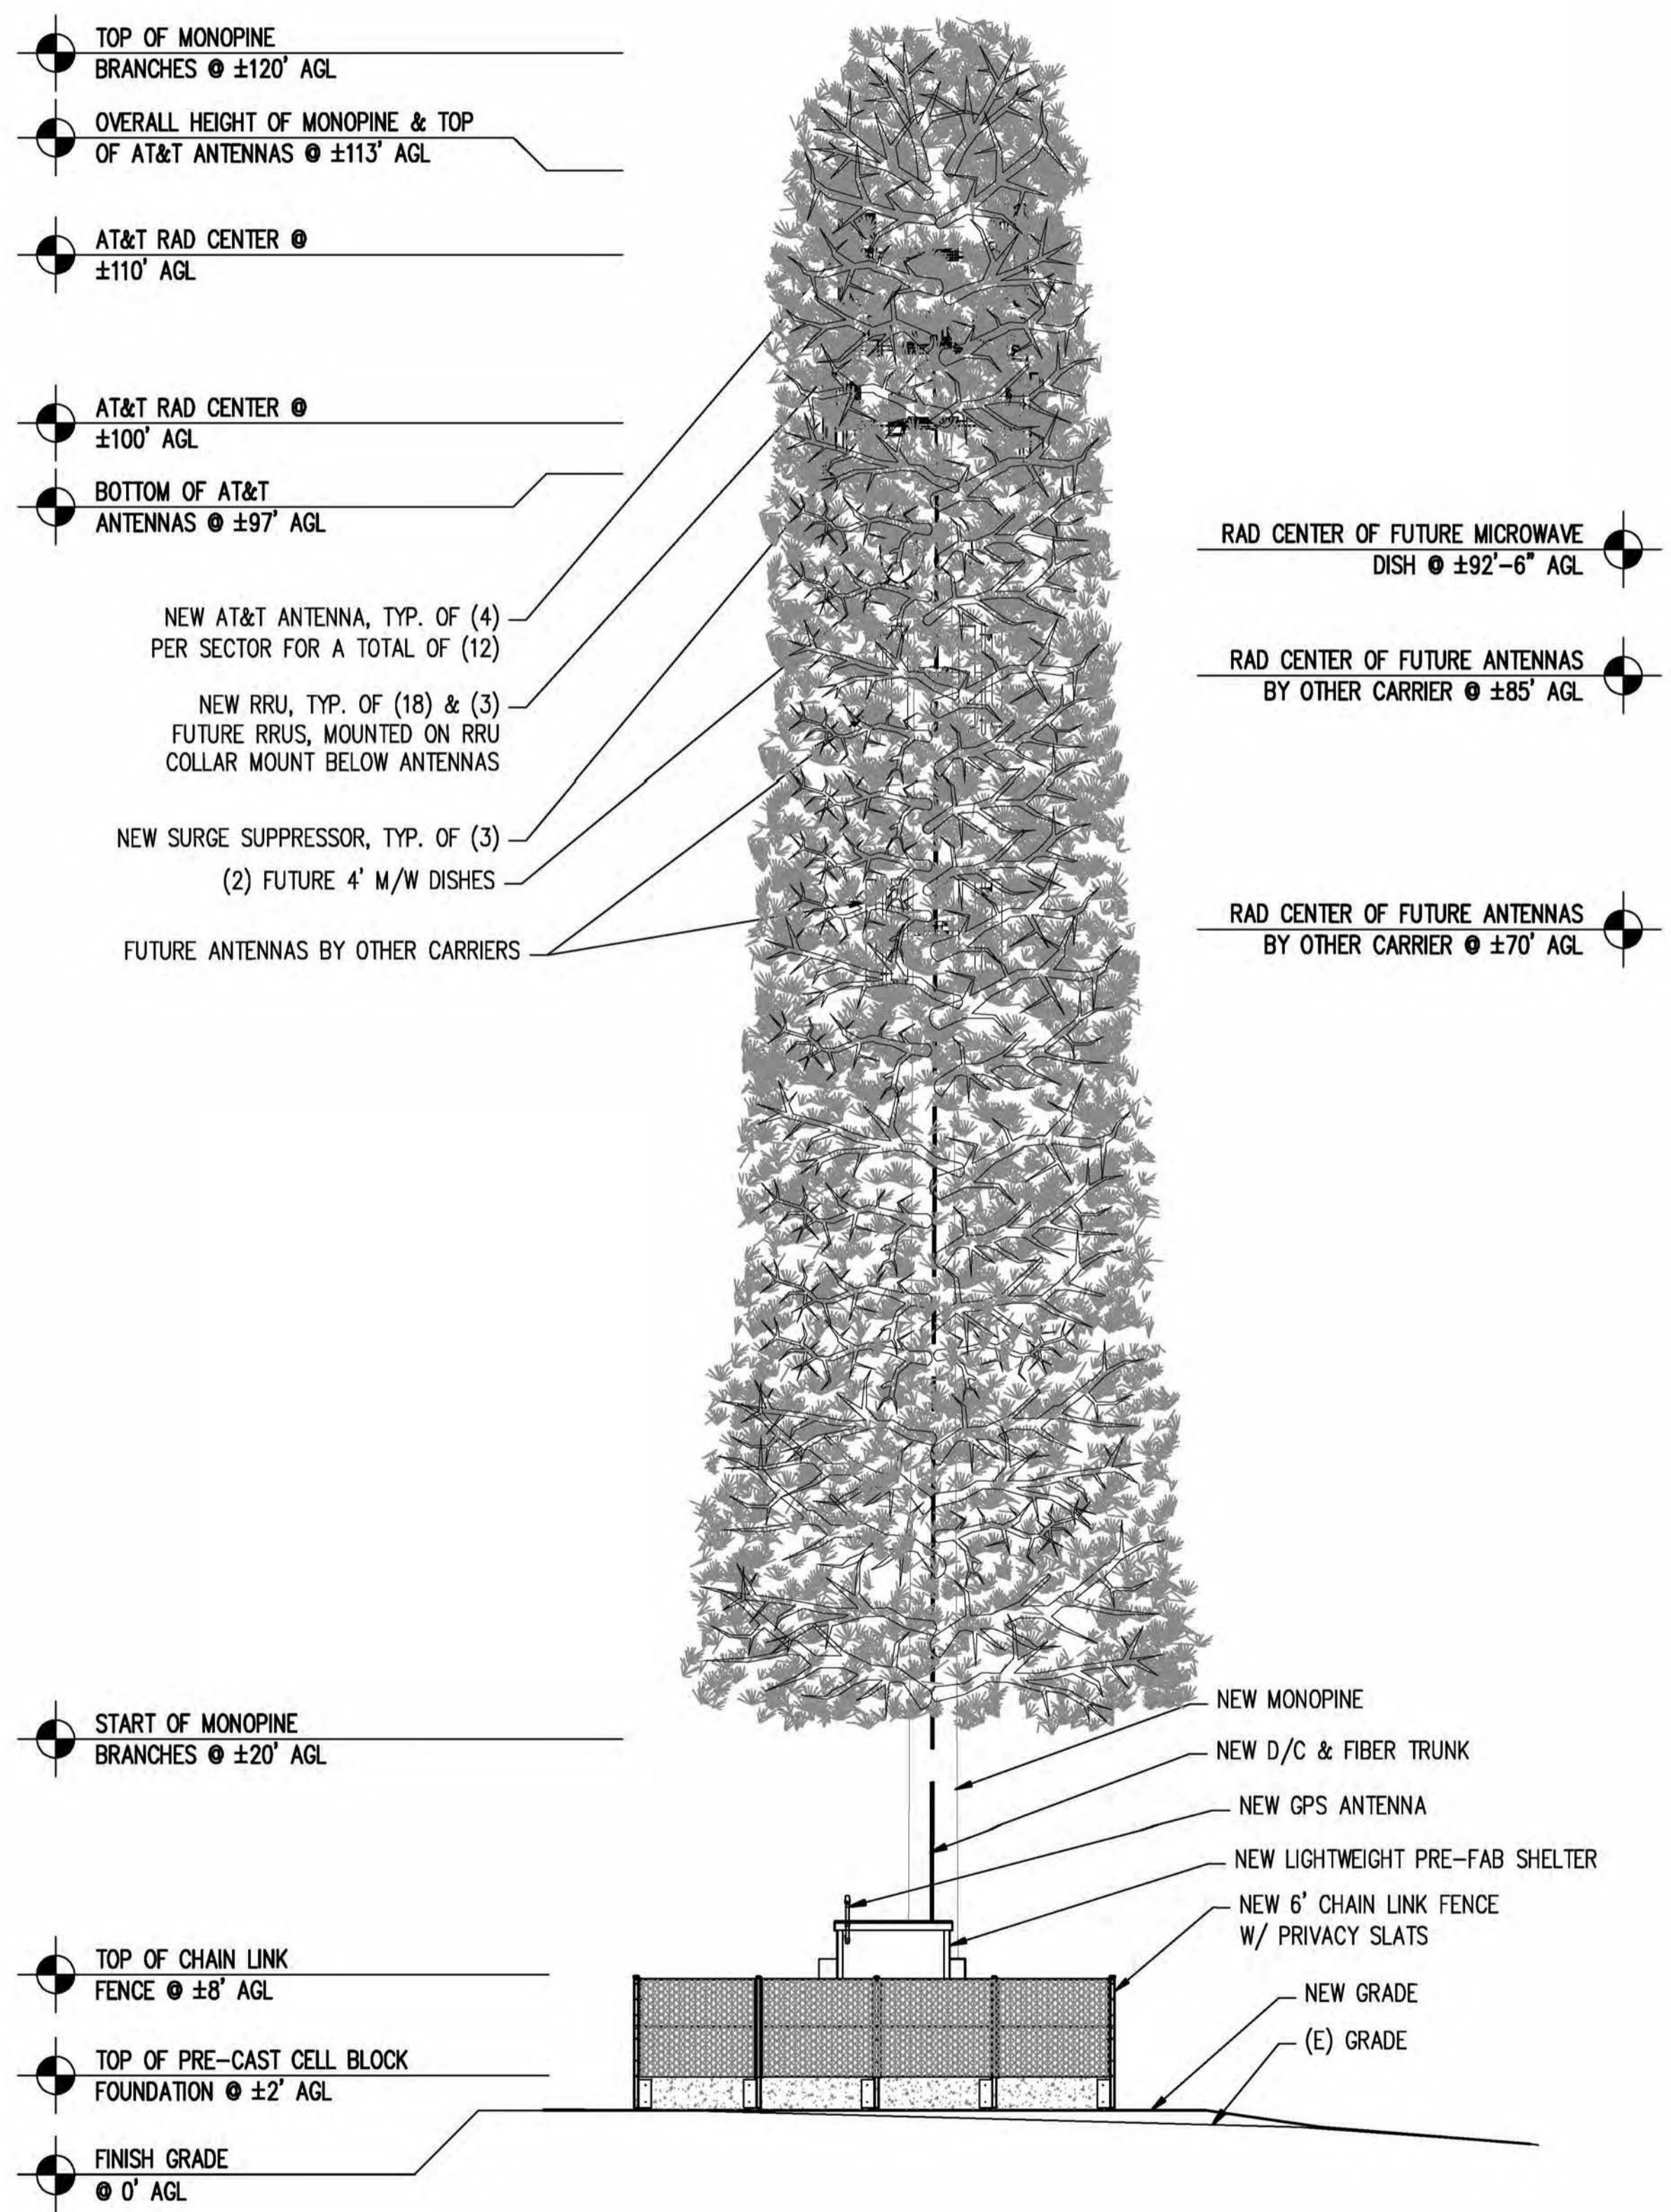

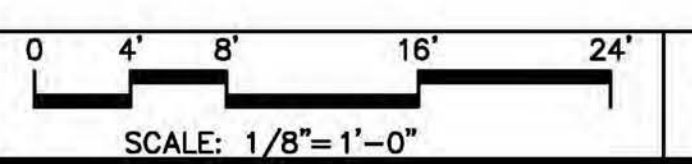2


NORTHWEST ELEVATION



1

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 SAN RAMON, CA 94583

PROJECT INFORMATION:

PILOT HILL 2
 3100 TRIPLE SEVEN RD
 COOL, CA 95614


REV: DATE: DESCRIPTION: BY:

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Peek Site-Com
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 Auburn, California 95602
 Phone (530) 885-6160
 E-Mail info@peeksitecom.com

SEAL:



SITE #: CVL03175 CHK.: ... DRAWN BY: RB

SHEET TITLE: **ELEVATIONS**

SHEET NUMBER: **A-4.1** REVISION: **0**


CVL03175 Zoning Propagation Map

June 13, 2017

Attachment 2

Site 1 Cool (formerly Pilot Hill 2)18-1225 | 14 of 32


Existing LTE 700 Coverage (RC = 108')

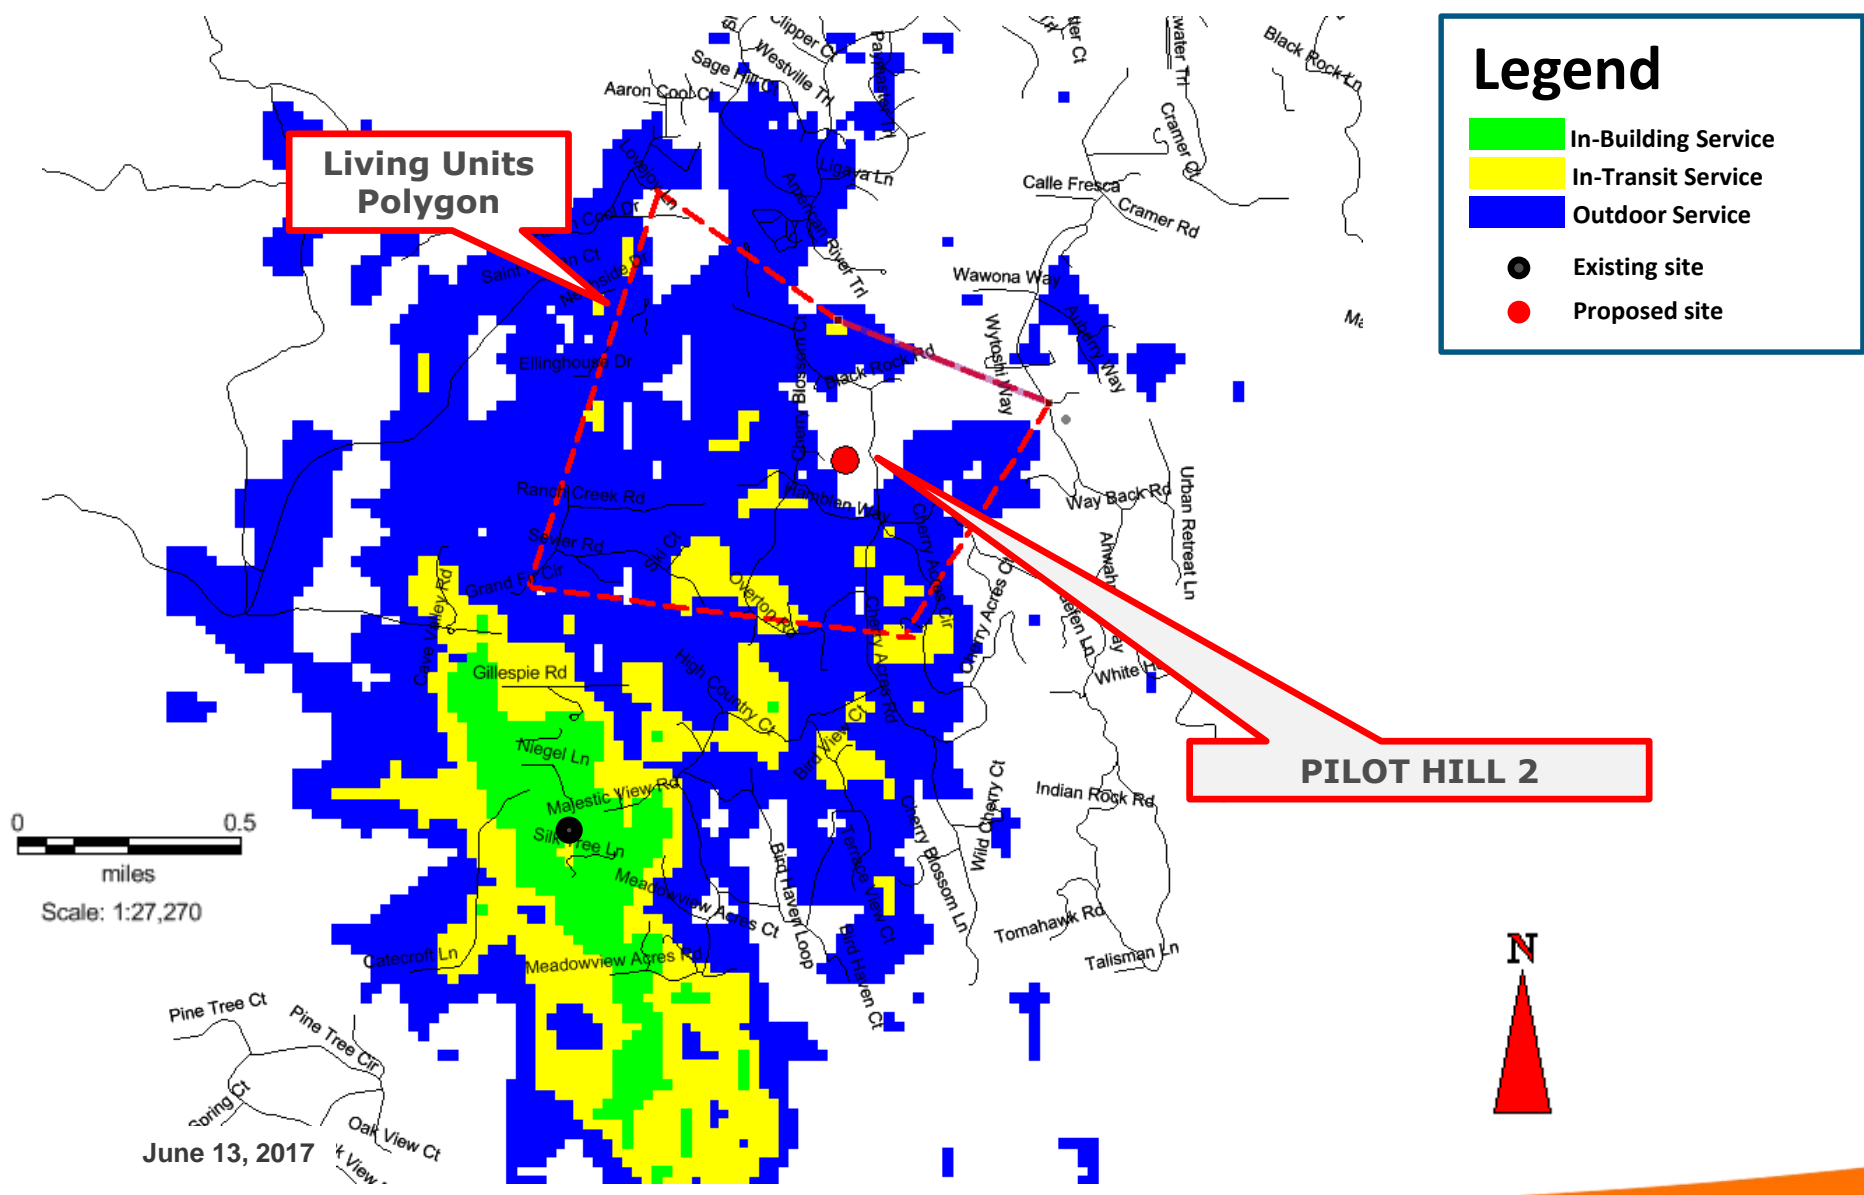


Legend

- In-Building Service
- In-Transit Service
- Outdoor Service
- Existing site
- Proposed site

Proposed LTE 700 Coverage (RC = 108')

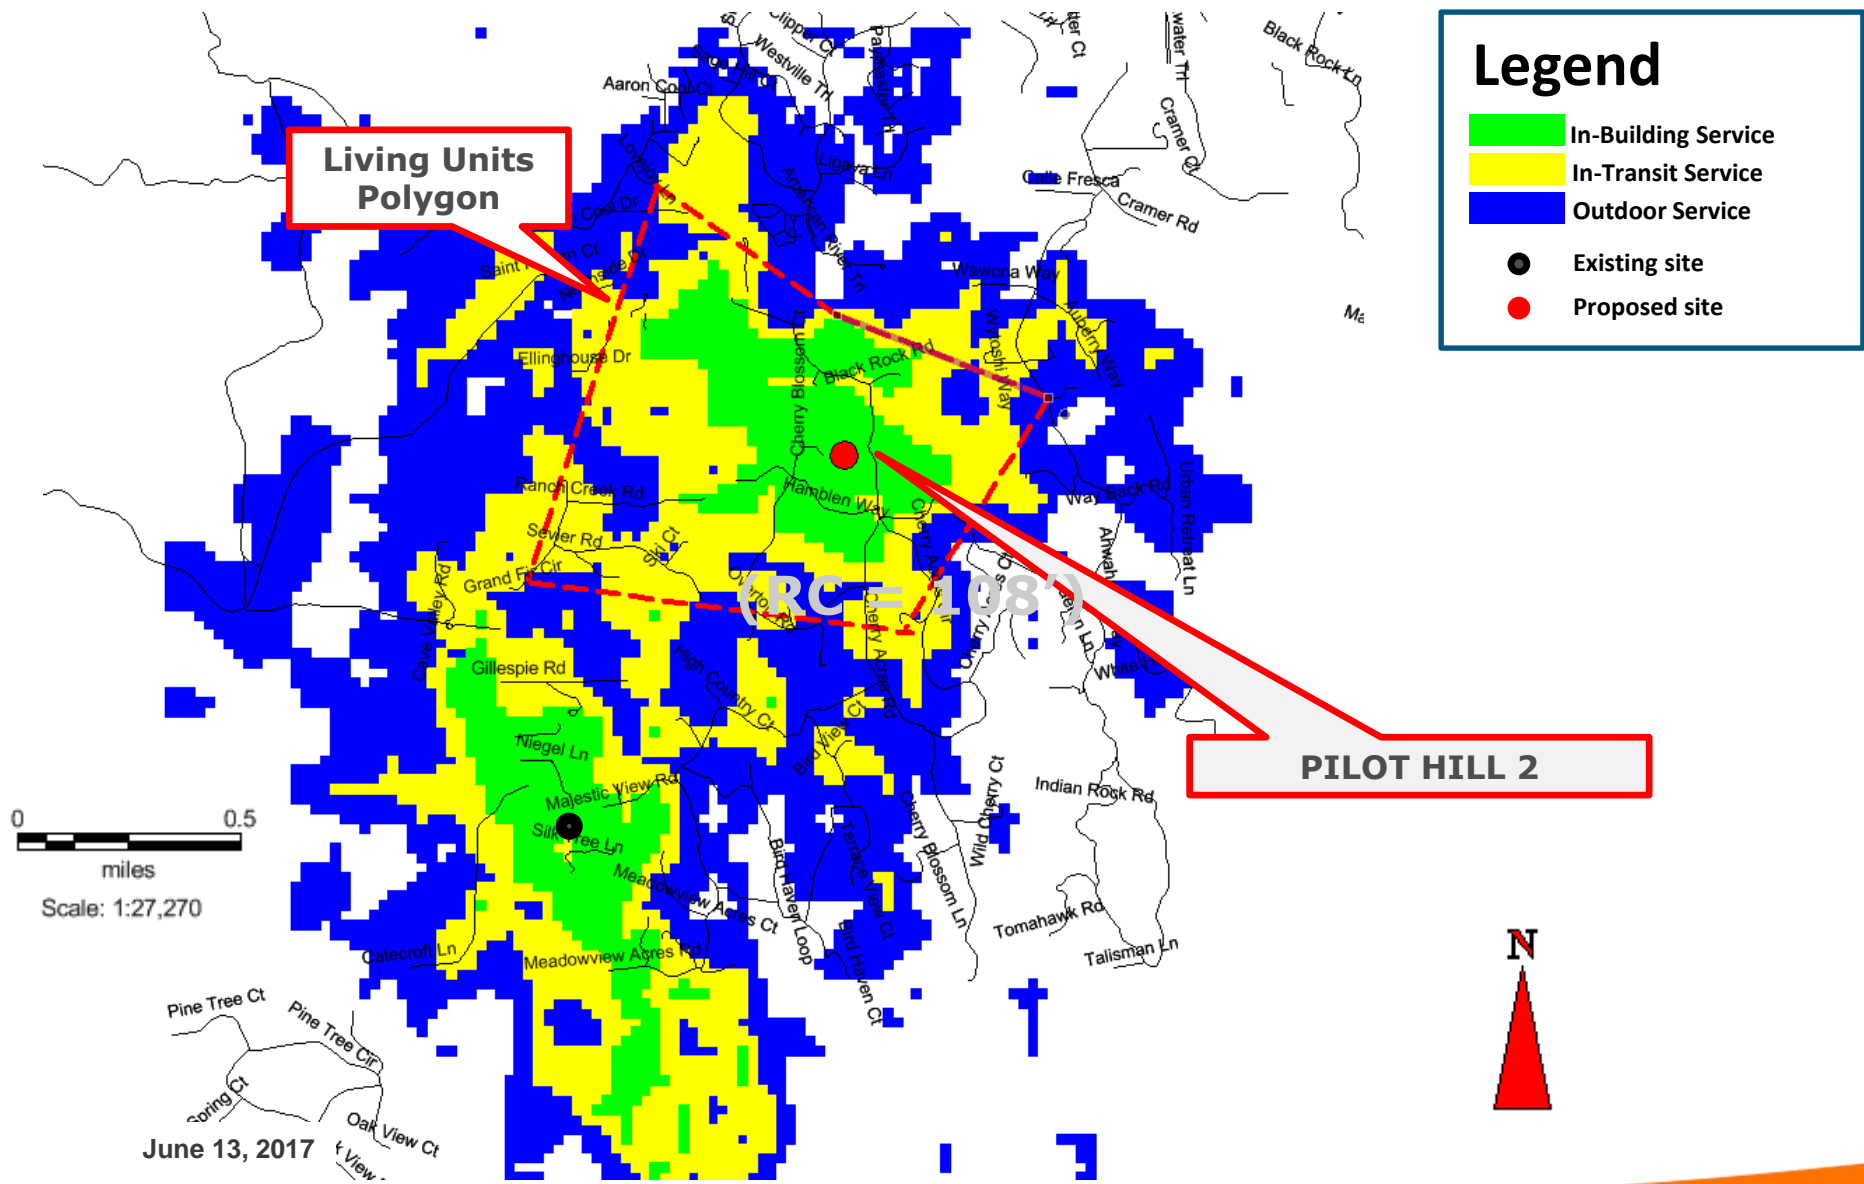

Search Ring's Description and Objectives:

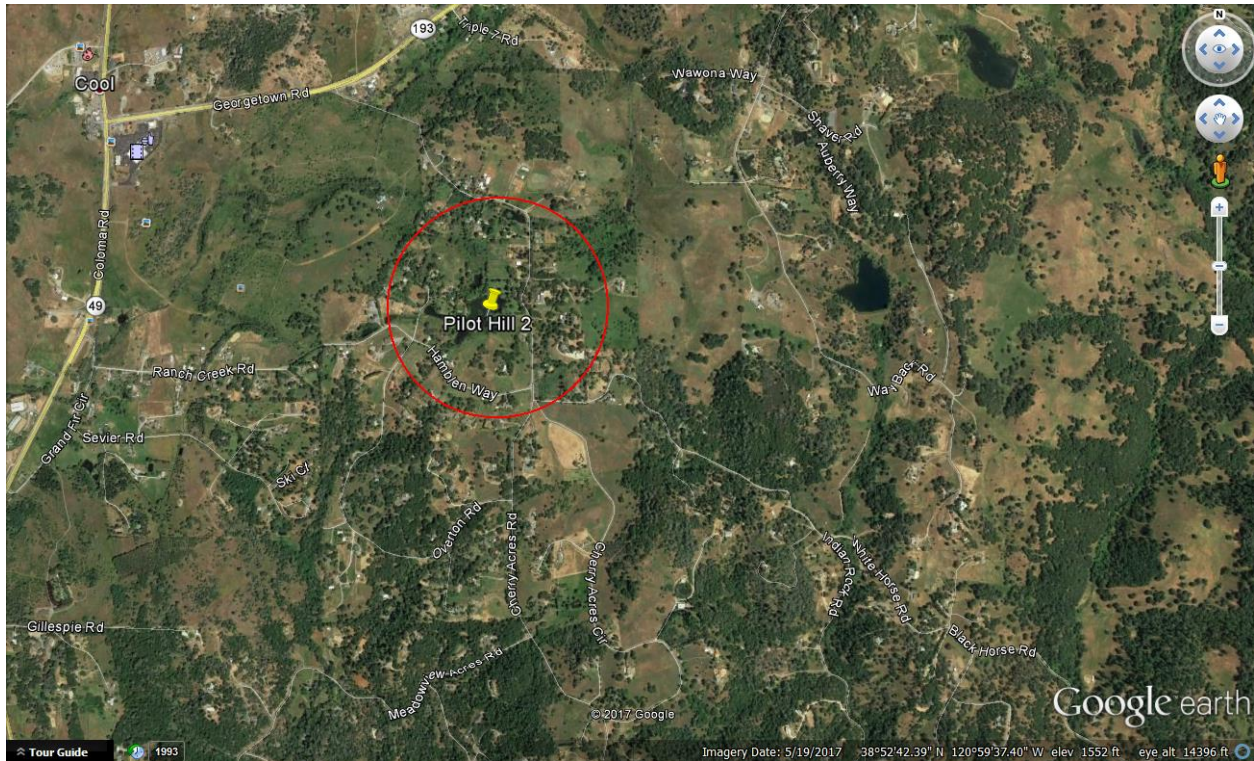


AT&T Mobility is proposing to build and maintain an unmanned wireless telecommunication facility consisting of a 36' x 36', 1,296 square foot enclosed compound (lease area). The compound will include a 120 foot Stealth Monopine tower, one equipment shelter, one 35kw standby propane generator, and one 500 gallon propane tank. This facility will be located at 3100 Triple Seven Road, Cool, within El Dorado County's jurisdiction in a 25.037 acre RE-5 zone. The site is approximately 870 feet south of Knickerbocker Creek and the area consists of oak trees, evergreen trees, and rolling hills with rocky terrain.

AT&T's objective for the Pilot Hill 2 site is to provide wireless hi-speed broadband internet to a minimum of 197 LU's and cellular services to the nearby residences. This site is to provide hi-speed internet and enhanced cellular coverage & capacity to the Cool and Cherry Acres community, surrounding the search ring, which is a relatively dense underserved areas. The site location's elevation is approximately 1,621 feet while the surrounding community's elevation averages around 1,500 feet, giving the homes within the community great potential for line of site to the tower. After running a coverage simulation at the site location, AT&T is anticipating meeting their FCC objective for this search ring by covering approximately 197 homes.


Attachment 3 Site 1 Cool (formerly Pilot Hill 2)

Potential Co-locations:

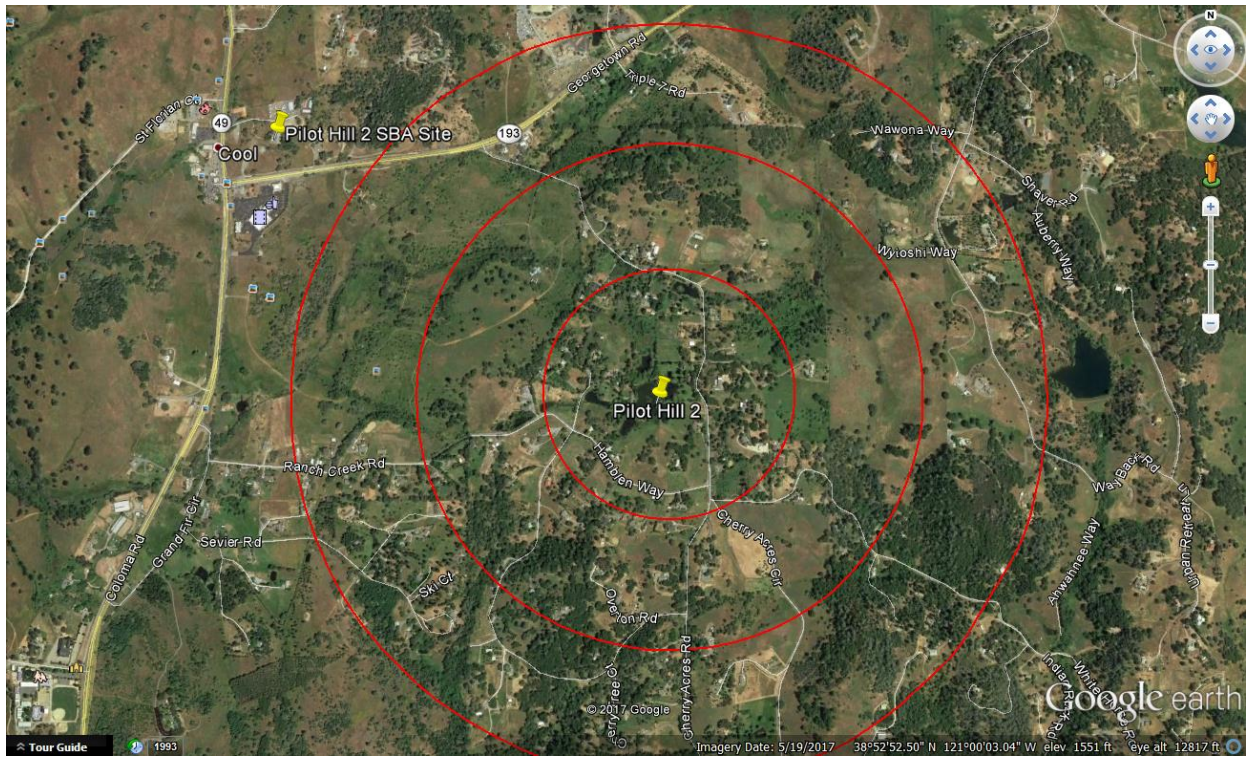

The nearby SBA Wireless Facility located at 1050 Northside Drive, Cool, was initially considered for a co-location proposal. However, running the coverage simulation at the available antenna height of 40 feet, AT&T discovered that they would lose a considerable amount of living units. This would have also resulted in AT&T failing to meet its FCC mandate for coverage for the Cool Community.

Alternative Site Analysis pursuant to 17.14.210 (B) (1):

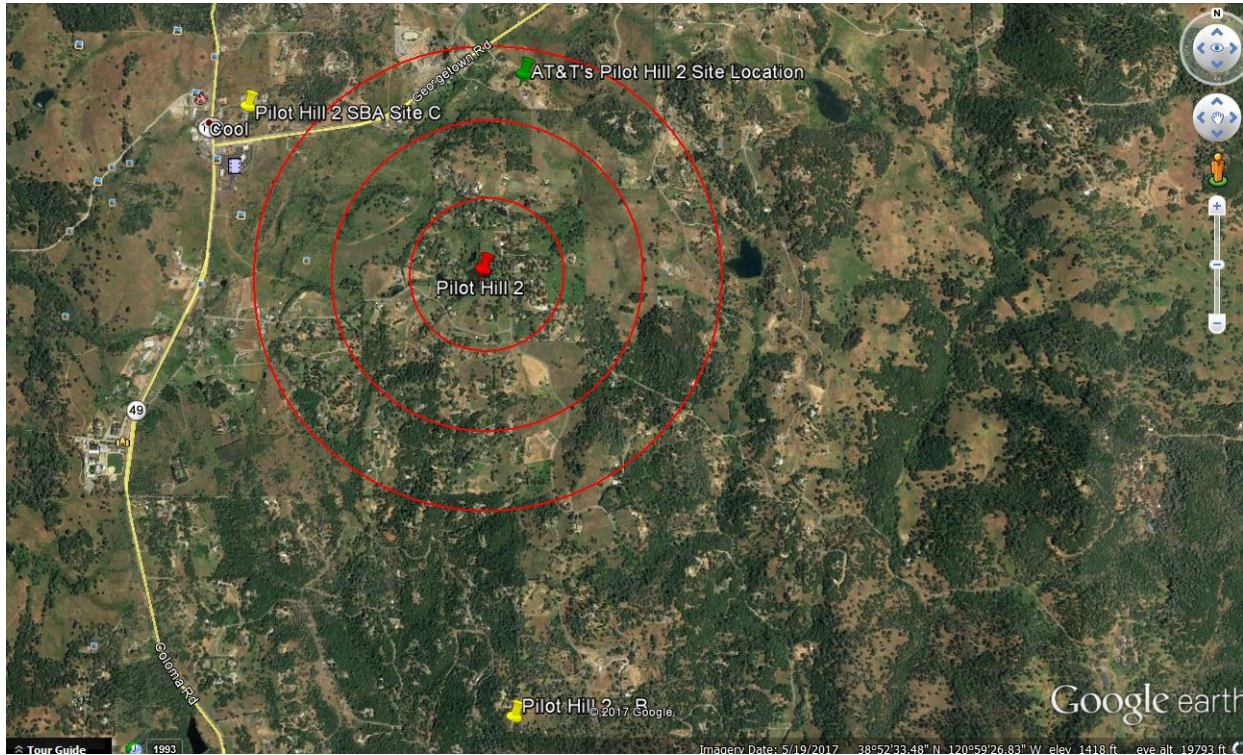

Above is a map showing the Search Ring (center is the red pin), Proposed Site (green pin) and the two alternative sites (yellow pins) that were considered for placement of the telecommunications facility. Epic Wireless was forced to search well beyond AT&T's Search Ring due to the restrictions within the Cherry Acres Home Owners Association.

Each Alternative Site is discussed below:

Pilot Hill 2 Alternative Candidate B:

Address: 2225 Terrace View Court, Cool, CA 95614

Latitude/Longitude: 38.860233, -120.997694

Proposal – New Tower



Considerations:

Candidate B is located approximately 1.25 miles south of the center of AT&T's search ring. The proposed tower would be located on a 6 acre, RE-5 zoned property owned by Brian Cummings. The property is located at the end of Terrace View Court and the site was proposed in the center of the property. Candidate B was chosen as AT&T's second preferred candidate as the RF Engineer's simulation yielded fewer LU's than the subject site located at 3100 Triple Seven Road (Subject Parcel).

Pilot Hill 2 Alternative Candidate C:

1050 Northside Drive, Cool, CA 95614

Latitude/Longitude: 38.888289, -121.014101

Proposal – Co-Location




Considerations:

The nearby SBA Wireless Facility located at 1050 Northside Drive, Cool, was initially considered for a co-location proposal. However, running the coverage simulation at the available antenna height of 40 feet, AT&T discovered that they would lose a considerable amount of living units. This would have also resulted in AT&T failing to meet its FCC mandate for coverage for the Cool Community.

Actual View of the Proposed Location:


The proposed lease area is located centrally in the subject property. The site will not interfere with the existing use of the property. Access will be directly off of Triple Seven Road. The site is elevated above the surrounding area and has great potential for line of site to the communities down below the subject parcel.



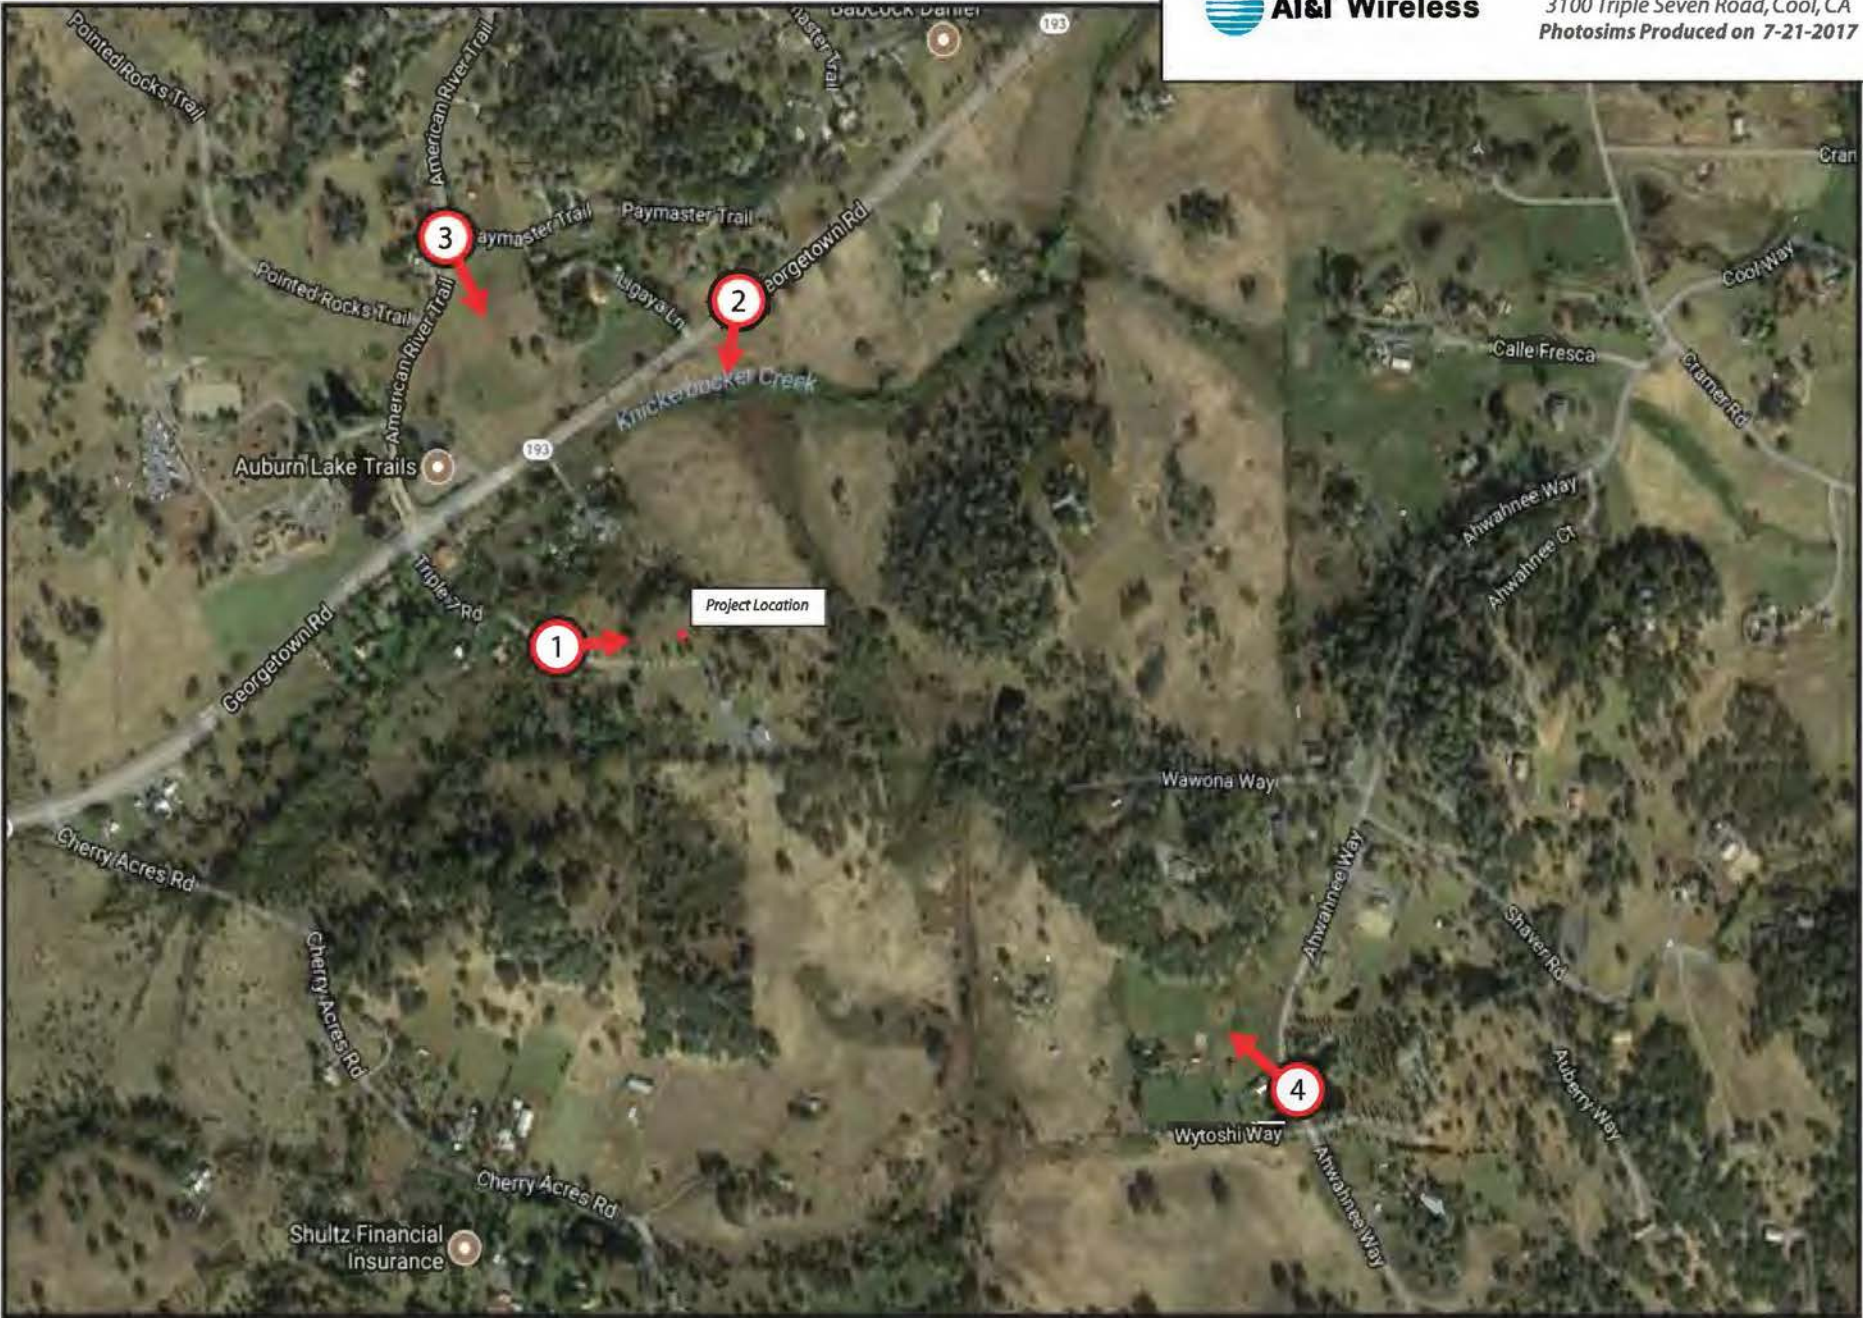

Attachment 4
Site 1 Cool (formerly Pilot Hill 2)

Existing

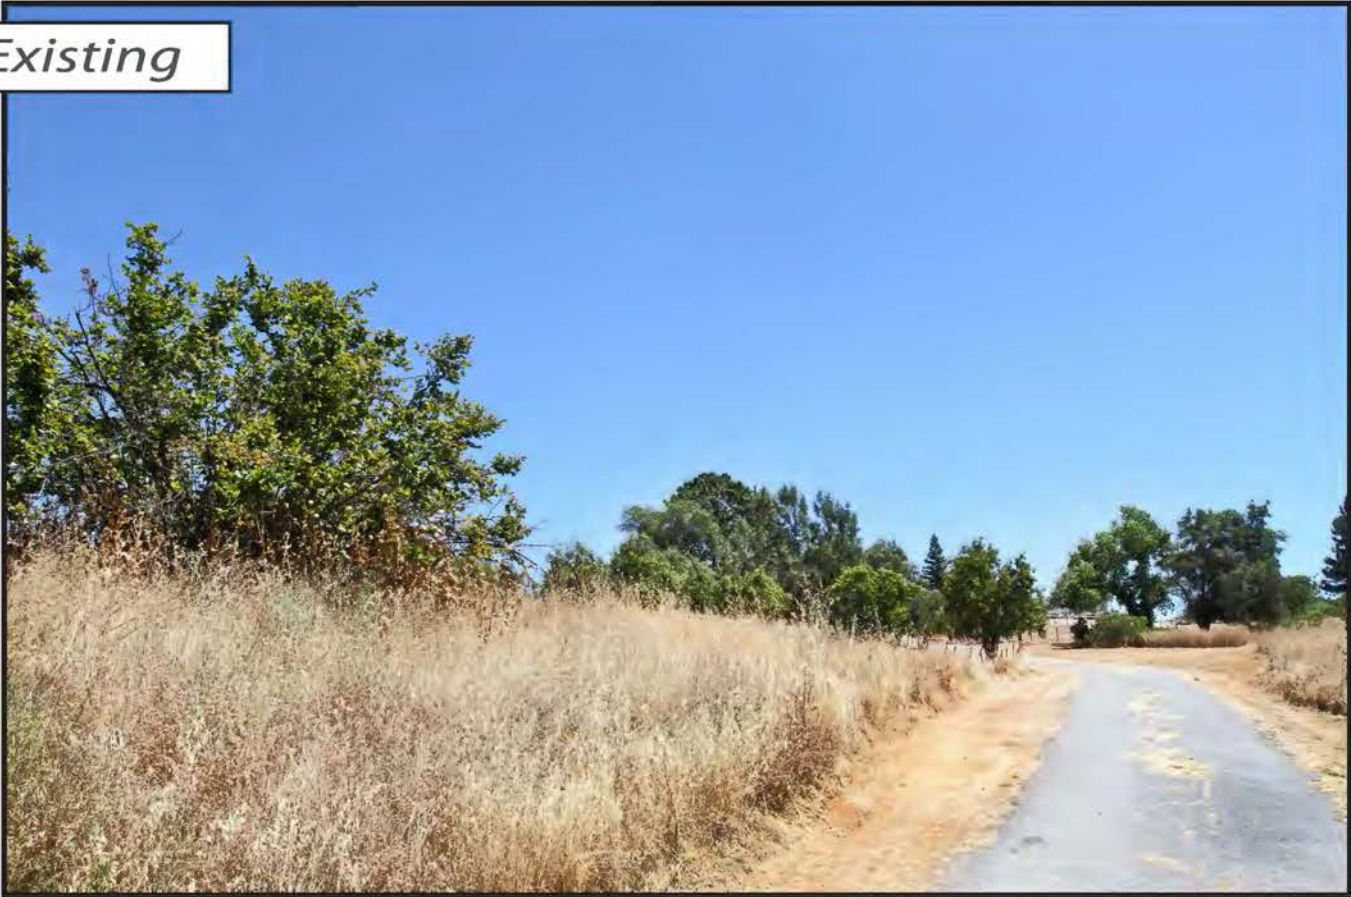


Proposed



view from Triple Seven Road looking east at site

Existing

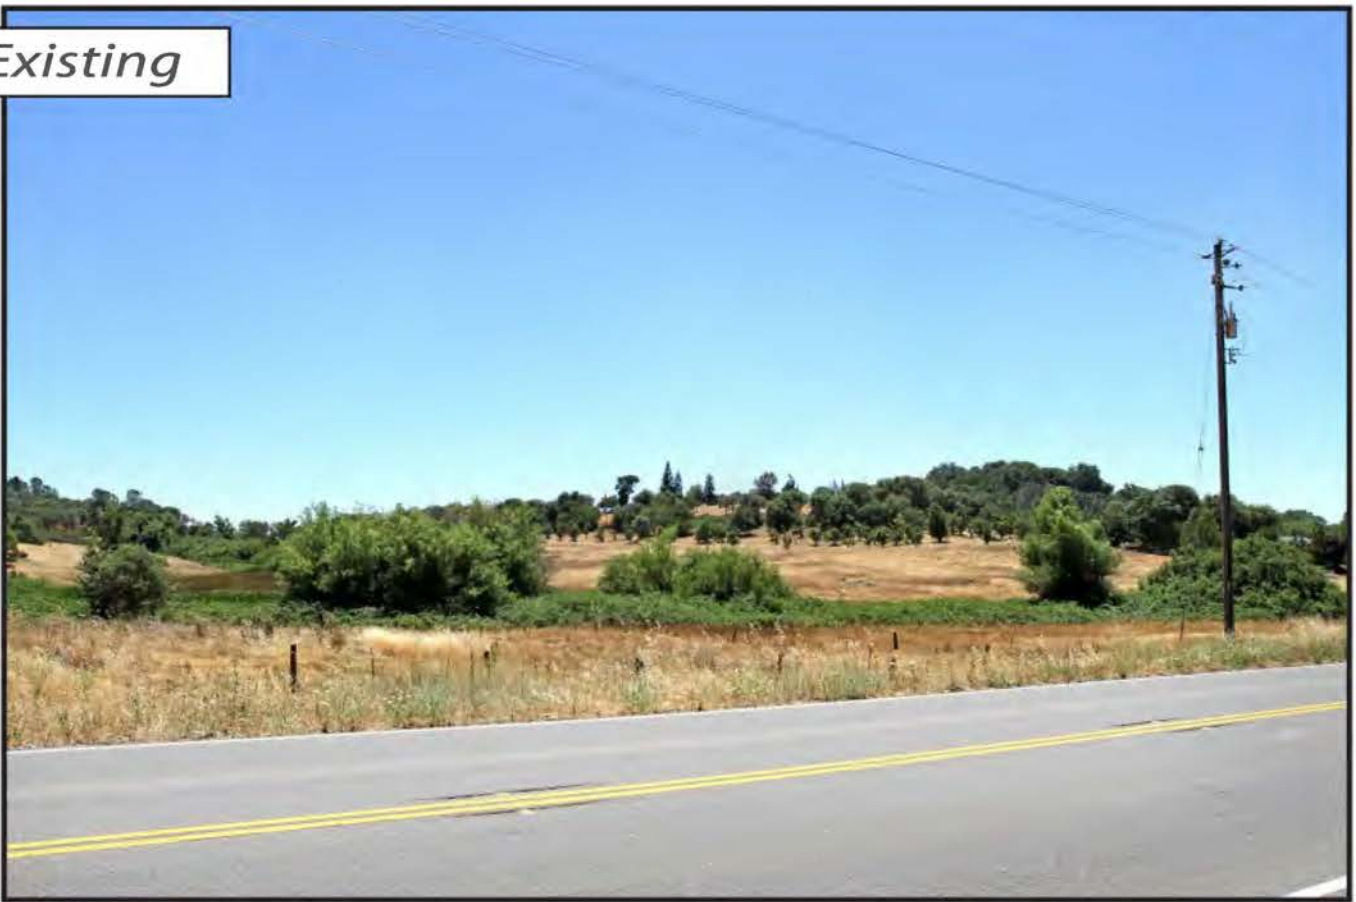

Proposed



view from Georgetown Road looking southwest at site



CVL03175 Pilot Hill 2
3100 Triple Seven Road, Cool, CA
Photosims Produced on 7-21-2017




Existing



Proposed



view from Paymaster Trail looking southeast at site

 **AT&T Wireless**

CVL03175 Pilot Hill 2
3100 Triple Seven Road, Cool, CA
Photosims Produced on 7-21-2017

AdvanceSim
Photo Simulation Solutions
Contact (925) 202-8507

Existing




Proposed



view from Ahwahnee Way looking northwest at site

AdvanceSim
Photo Simulation Solutions
Contact (925) 202-8507

 **AT&T Wireless**
CVL03175 Pilot Hill 2
3100 Triple Seven Road, Cool, CA
Photosims Produced on 7-21-2017

Sound Specifications:

- Emergency Generator Model: SG035 Generac
 - Average decibel (dBA) level at 23 feet = 64.9 dBA
- HVAC Model: ASDCA48
 - Average decibel (dBA) level at 50 feet = 57 dBA

Sound Specifications while taking the Sound Blanket into consideration:

- Emergency Generator Model: SG035 Generac
 - Average decibel (dBA) level at 23 feet = 58.11 dBA
- HVAC Model: ASDCA48
 - Average decibel (dBA) level at 50 feet = 46.36 dB

Findings:

1. Distance to the Nearest Property Line = 183'+/-
 - a. Generator Decibel level at 183' = 40.1 dBA
 - b. HVAC Decibel level at 183' = 35.09 dBA
2. Distance to the Nearest Residence = 600'+/-
 - a. Generator Decibel level at 600' = 29.78 dBA
 - b. HVAC Decibel level at 600' = 24.78 dBA

Conclusion:

After calculating all decibel levels at each nearby residence’s property line and actual residence, the onsite Emergency Backup Generator and HVAC systems are within El Dorado County’s noise level standards according to El Dorado County Title 130 Zoning and Noise Ordinance, Chapter 130.37 – Noise Standards.

Table 1 – Eldorado County Table 130.37.060.1
Noise Level Performance Standards for Noise Sensitive Land Uses
Affected by Non-Transportation Sources

Noise Level Descriptor	Daytime 7 a.m. – 7 p.m.		Evening 7 p.m. – 10 p.m.		Night 10 p.m. – 7 a.m.	
	Community / Rural Centers	Rural Regions	Community / Rural Centers	Rural Regions	Community / Rural Centers	Rural Regions
Hourly Leq, dBA	55	50	50	45	45	40
Maximum Level, dBA	70	60	60	55	55	50



Radio Frequency Emissions Compliance Report For AT&T Mobility

Site Name: Pilot Hill 2	Site Structure Type: Monopine
Address: 3100 Triple Seven Road Cool, California	Latitude: N38-53-22.80
Report Date: July 22, 2017	Longitude: W120-59-49.80
	Project: New Build

General Summary

AT&T Mobility has contracted Waterford Consultants, LLC to conduct a Radio Frequency Electromagnetic Compliance assessment of the proposed Pilot Hill 2 site located at 3100 Triple Seven Road, Cool, California. This report contains information about the radio telecommunications equipment to be installed at this site and the surrounding environment with regard to RF Hazard compliance. This assessment is based on installation designs and operational parameters provided by AT&T Mobility.

The compliance framework is derived from the Federal Communications Commission (FCC) Rules and Regulations for preventing human exposure in excess of the applicable Maximum Permissible Exposure (“MPE”) limits. At any location at this site, the power density resulting from each transmitter may be expressed as a percentage of the frequency-specific limits and added to determine if 100% of the exposure limit has been exceeded. The FCC Rules define two tiers of permissible exposure differentiated by the situation in which the exposure takes place and/or the status of the individuals who are subject to exposure. General Population / Uncontrolled exposure limits apply to those situations in which persons may not be aware of the presence of electromagnetic energy, where exposure is not employment-related, or where persons cannot exercise control over their exposure. Occupational / Controlled exposure limits apply to situations in which persons are exposed as a consequence of their employment, have been made fully aware of the potential for exposure, and can exercise control over their exposure. Based on the criteria for these classifications, the FCC General Population limit is considered to be a level that is safe for continuous exposure time. The FCC General Population limit is 5 times more restrictive than the Occupational limits.

Frequency (MHz)	<i>Limits for General Population/ Uncontrolled Exposure</i>		<i>Limits for Occupational/ Controlled Exposure</i>	
	Power Density (mW/cm ²)	Averaging Time (minutes)	Power Density (mW/cm ²)	Averaging Time (minutes)
30-300	0.2	30	1	6
300-1500	f/1500	30	f/300	6
1500-100,000	1.0	30	5.0	6

f=Frequency (MHz)

In situations where the predicted MPE exceeds the General Population threshold in an accessible area as a result of emissions from multiple transmitters, FCC licensees that contribute greater than 5% of the aggregate MPE share responsibility for mitigation.

Attachment 6 Site 1 Cool (formerly Pilot Hill 2)

Based on the computational guidelines set forth in FCC OET Bulletin 65, Waterford Consultants, LLC has developed software to predict the overall Maximum Permissible Exposure possible at any particular location given the spatial orientation and operating parameters of multiple RF sources. These theoretical results represent worst-case predictions as emitters are assumed to be operating at 100% duty cycle.

For any area in excess of 100% General Population MPE, access controls with appropriate RF alerting signage must be put in place and maintained to restrict access to authorized personnel. Signage must be posted to be visible upon approach from any direction to provide notification of potential conditions within these areas. Subject to other site security requirements, occupational personnel should be trained in RF safety and equipped with personal protective equipment (e.g. RF personal monitor) designed for safe work in the vicinity of RF emitters. Controls such as physical barriers to entry imposed by locked doors, hatches and ladders or other access control mechanisms may be supplemented by alarms that alert the individual and notify site management of a breach in access control. Waterford Consultants, LLC recommends that any work activity in these designated areas or in front of any transmitting antennas be coordinated with all wireless tenants.

Analysis

AT&T Mobility proposes the following installation at this location:

- Install twelve (12) new antennas
- Install six (6) new RRUS-11
- Install ten (10) new RRUS-32
- Install three (3) new RRUS-12

The antennas will be mounted on a new 122-foot monopine erected for this purpose with centerlines at 100 and 108 feet above ground level. The antennas will be oriented toward 90, 330 and 210 degrees. The Effective Radiated Power (ERP) in any direction from all AT&T Mobility operations will not exceed 26,556 Watts. Other appurtenances such as GPS antennas, RRUs and hybrid cable are not sources of RF emissions. From this site, AT&T Mobility will enhance voice and data services to surrounding areas in licensed 700, 1900, 2100 and 2300 MHz bands. No other antennas are known to be operating in the vicinity of this site.

Power density decreases significantly with distance from any antenna. The panel-type antennas to be employed at this site are highly directional by design and the orientation in azimuth and mounting elevation, as documented, serve to reduce the potential to exceed MPE limits at any location other than directly in front of the antennas. For accessible areas at ground level, the maximum predicted power density level resulting from all AT&T Mobility operations is 0.7985% of the FCC General Population limits (0.1597% of the FCC Occupational limits). Incident at adjacent buildings depicted in Figure 1, the maximum predicted power density level resulting from all AT&T Mobility operations is 0.1425% of the FCC General Population limits (0.0285% of the FCC Occupational limits). The proposed operation will not expose members of the General Public to hazardous levels of RF energy and will not contribute to existing cumulative MPE levels on walkable surfaces at ground or at adjacent buildings by 5% of the General Population limits.

Within the proposed compound surrounding the tower, the maximum predicted power density level resulting from all AT&T Mobility operations is 0.0240% of the FCC Occupational limits (0.1200% of the FCC General Population limits). Waterford Consultants, LLC recommends posting contact information signage at the compound gate. RF alerting signage (Caution) should be posted at the base of the proposed tower to inform authorized climbers of potential conditions near the antennas. These recommendations are depicted in Figure 2.

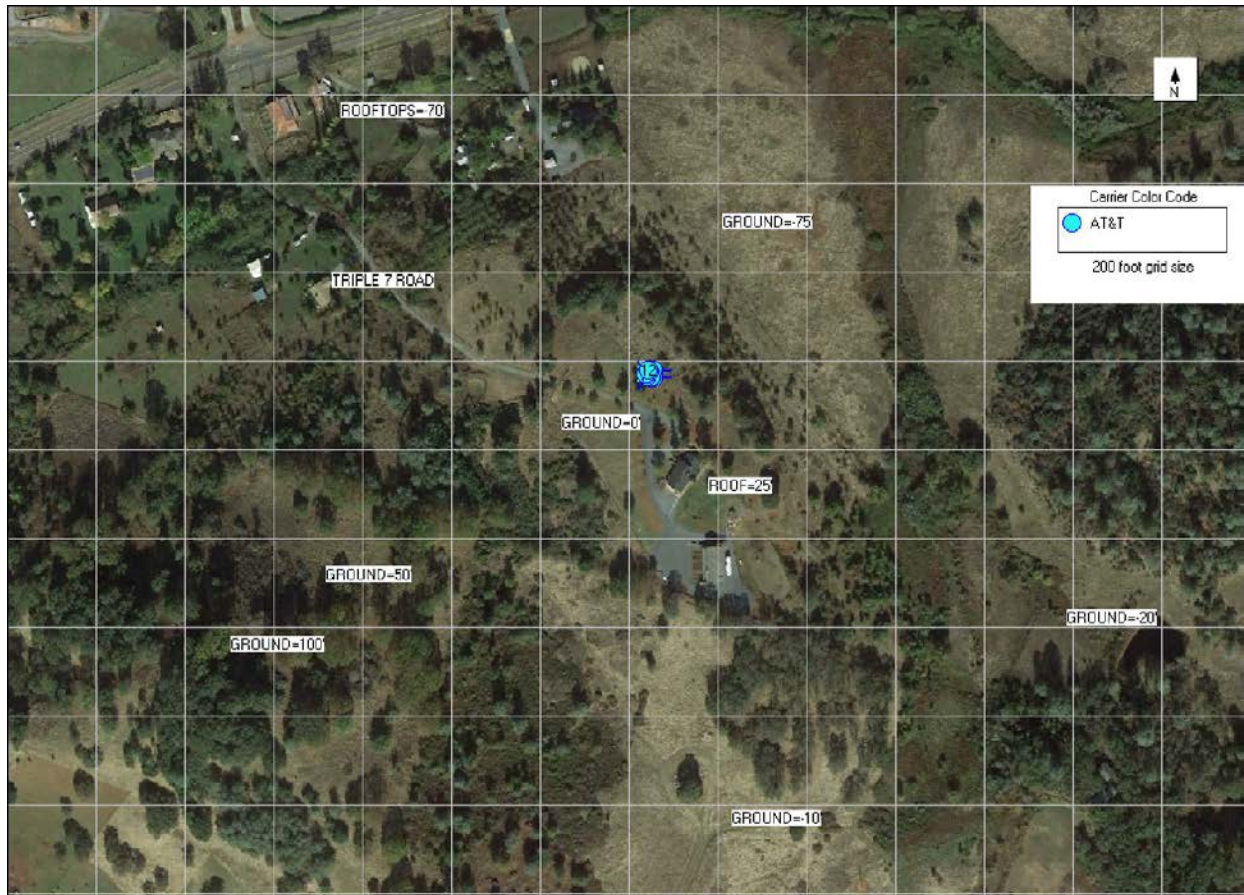


Figure 1: Antenna Locations

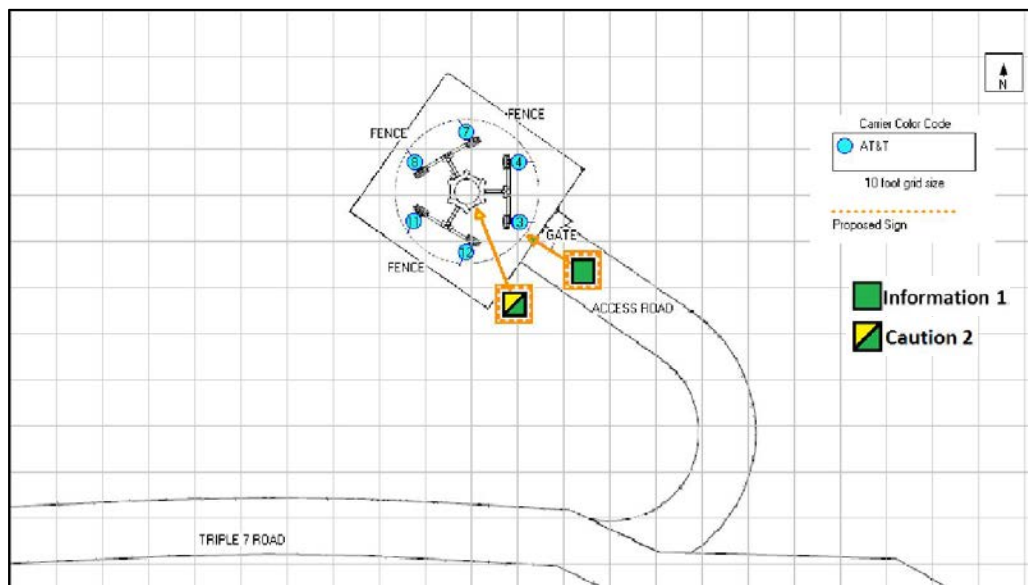


Figure 2: Mitigation Recommendations

Compliance Statement

Based on information provided by AT&T Mobility, predictive modeling and the mitigation action to be implemented by AT&T Mobility, the installation proposed by AT&T Mobility at 3100 Triple Seven Road, Cool, California will be compliant with Radiofrequency Radiation Exposure Limits of 47 C.F.R. § 1.1307(b)(3) and 1.1310. RF alerting signage and restricting access to the tower to authorized climbers that have completed RF safety training is required for Occupational environment compliance.

Certification

I, Steven N. Baier-Anderson, am the reviewer and approver of this report and am fully aware of and familiar with the Rules and Regulations of both the Federal Communications Commissions (FCC) and the Occupational Safety and Health Administration (OSHA) with regard to Human Exposure to Radio Frequency Radiation, specifically in accordance with FCC's OET Bulletin 65. I have reviewed this Radio Frequency Exposure Assessment report and believe it to be both true and accurate to the best of my knowledge.

