

PACRETERNS FRAM.
PEEK SITE-COM.
12852 EARMART AVE SUITE 101
AUBUSH, CA 95602
(530) 883-6160

SITE NAME: SITE NUMBER: FA LOCATIONA

STE MONESS

PROJECT INFORMATION

APPLICANT: ATAT MOBILITY SOOT EXECUTIVE PRINT SAN RAMON, CA 94583

CONSTRUCTION MANAGER.
PETE MANAS
EPIC MRECESS
EPIC MRECESS
FOC AUBURN FOLSON ROAD, SUITE 400
GRANTE BAY, CA 95746
(\$30) 383-5957

SITE NUMBER: CVL03629 SITE NAME: ZEE ESTATES

CATE LANE 1,000' SOUTH EAST OF THE INTERSECTION OF GATE LANE AND SALMON FALLS ROAD PILOT HILL. CA 95664 APN: 104-370-24-100

TITLE SHEET

SITE SIGNAGE

SITE SURVEY

SITE SURVEY

EROSION CONTROL PLAN & DETAILS

GN-2 C-1

C-2 C-3

SHEET INDEX

CAMENT BAY, CA. 92746 (CAS) 253-55575 ST. 9375.957 ST. 9375.97 ST.	### 155 ST. ACOUSTINA & PLANNING. ### 15 AC. CL \$5746 ### 15 AC. CL \$57		164-370-74-100 34-69647 -120,011005 1-52,011005 1-52,0160		C-5 A-1 A-2 A-3 A-4	C-4 GRADING NOTES & DETAILS C-5 PRELIMINARY GROUNDING PLAN A-1 OVERALL SITE PLAN A-2 EQUIPMENT PLAN A-3 ANTENNA PLAN & OETAILS A-4 ELEVATIONS	
CODE COMPLIANCE	VICI	NITY MAP	DIRECTIONS FI	ROM	AT&T	PROJECT DESCRI	PTION
LL MORK AND MATERIALS SHALL BE PERFORMED AND INSTALLED IN CORPORACE WITH THE CURRENT CONTINUES OF THE FOLLOWING CODES AS COPIED BY THE LOCAL CONTINUES AUTHORISES, MOTHORIS IN THESE FRANS IS BE CONSTRUED IN PREMIT WORM AND COMPONING TO THESE CODES 2016 CALFERNA BIRLIANG CODE 2016 CALFORNA FILE CODE 2016 CALFORNA FILE MORE 2016 CALFORNA FILE		SITE LOCATION	DIRECTIONS FROM ATAI'S OFFICE AT SOUL DECURING PARKWAY, SAN RAMON, CA. 94583. 1. HEAD MORTHEAST ON BISHOP OR TOWARD SINIST OR 2. TUBY RIGHT ONTO SINIST OR 3. USE THE RIGHT 2 LANSS TO RUPH RIGHT CHTO BOULDINGER CANYON RD 4. USE THE RIGHT 2 LANSS TO RUPH RIGHT CHTO BOULDINGER CANYON RD 4. USE THE RIGHT 2 LANSS TO RUPH RIGHT CHTO BOULDINGER CANYON RD 4. USE THE RIGHT 2 LANSS TO REPORT ON THE RAMP TO SACRAMENTO 5. KREEP LETT AT THE FORK TO STAY ON 1—880 N 6. KEEP LETT AT THE FORK TO STAY ON 1—80 CASCRAMENTO 10. MERGE CONTO 1—80 C 11. KEEP LETT AT THE FORK TO CONTRULE ON 1—80 E/SACRAMENTO 12. KEEP LETT AT THE FORK TO CONTRULE ON 1—80 BUSINESS/SACRAMENTO/SOUTH LANSE 13. FREEWAY, FOLLOW SCHIS FOR INTERSTATE 80 BUSINESS/SACRAMENTO/SOUTH LANSE 14. TAHOE 15. CONTINUE ONTO US-30 E 16. TAKE 2011 303 TORNARD EL DOPADO HILLS BLYD 16. TAKE 2011 303 TORNARD EL DOPADO HILLS BLYD 17. MERGE CANTO LANDOR FOR THE STAY ON 10 SALMON FALLS RD TO GATE LIN 18. MERGE CANTO LANDOR FOR THE STAY 19. CONTINUE ONTO SALMON FALLS RD 20. CONTINUE ONTO SALMON FALLS RD 21. TURN ROCHT ONTO CALL IN LINE 22. TURN ROCHT ONTO CALL IN LINE 23. TURN ROCHT ONTO CALL IN LINE 24. TURN ROCHT ONTO CALL IN LINE 25. TURN ROCHT ONTO CALL IN LINE 26. TURN ROCHT ONTO CALL IN LINE 27. TURN ROCHT ONTO CALL IN LINE 28. TURN ROCHT ONTO CALL IN LINE 29. LINES ROCHT ONTO CALL IN LINE 29. TURN ROCHT ONTO CAL		A TATE PROPOSES TO CONSTRUCT A NEW UNWANNED TELECOMMUNICATIONS FACULTY ATAT WILL INSTALL ((1) NEW 15" WIDE CRAVEL ACCESS ROAD (() NEW 30"AST FENEZO LEASE AREA (() NEW 15" WIDE GOUBLE ACCESS ROAD (() NEW 12" WICE GOUBLE ACCESS RATE (() NEW 13" WICE REPORT EQUIPMENT SHELTER WICH FOLLOW TO THE CONTROL (() NEW 25 NEW PROPAME CANNEATOR (() NEW 25 NEW PROPAME CANNEATOR (() NEW 15 NEW ROAD-11, () NEW RRUS-12, (12) NEW RRUS-32 (4) NEW SURGE SUPPRESSORS (2) FUTURE 4" M/W DISH		
OCCUPANCY & CONST. TY	PE SPECIAL	INSPECTIONS	APPROV				
OCCUPANCY: U (URMANNED)	SEE SPECIAL INSPECTION FORM	-	APPROVED BY:	INITIALS:	DATE:		
CONSTRUCTION TYPE: Y-B	POST-INSTALLED ANCHORS HIGH STRENGTH BOLTING		VEHDOR:			GENERAL CONTRACT	OR NOTES
ACCESSIBILITY REQUIREMENTS: THIS FACULTY IS UNMAINED AND NOT FOR HUMAN HABITATION, HAVEA	Exhibit	F Cec Estates	R.F.: LEASING/LANDLORD: ZONING: CONSTRUCTION:			ON NOT SCALE DRAININGS THESE CRAININGS ARE ORNAATED TO BE FULL 52E 24*305*, CONTRACTOR SHALL VERBY ALL PLANS AND EXISTING COMPOSION AND CONSTRUCTOR OF THE ASSETT IN WHITE OF ANY DISCREPANCES BITTOE PROCEEDING WITH THE WORK OR WALERIAL ORDERS OR BE	(811)
ACCESS REQUIREMENTS ARE NOT REQUIRED IN ACCORDANCE WITH THE CAUFORNIA BUILDING CODE, CHAPTER 118, EXCEPTION SECTION 118-20	2016	***************************************	POWER/TELCO: PG&E:			RESPONSIBLE FOR THE SAME.	THE WAY
					L		

PROJECT TEAM

CATE LANE LOOF SQUIM EAST OF THE MITERSCOON OF CATE
LANE AND SAUGN FALLS 19040
PLOT HEL. CA 95984

PROPRIETARY INFORMATION

THE INFORMATION CONTAINED IN THIS SET OF DRAWINGS IS PROPRIETARY BY NATURE, ANY USE OR DISCLOSURE OTHER THAN THAT WHICH RELATES TO PECK SITE-COM IS STRICTLY PROHIBITED



5001 EXECUTIVE PKWY SAN RAMON, CA 94583

PROJECT INFORMATION;

ZEE ESTATES

CATE LANE 1,000" SOUTH EAST OF THE INTERSECTION OF GATE LANE AND SALMON FALLS ROAD


L		PLOT HILL, CA 95664	
REV:	= DATE: ====	DESCRIPTION:	
1	6-29-17	90% ZONING DOC'S	
1	6-3-17	90% YONING DOC'S	
2	8-9-17	100% ZONING DOC'S	
Г			
_			
_			
Г			
_	·		
-			
_			

Peek Site-Com 12852 Earhart Ave. Sulte 101 Auburn, California 95602

Phone (530) 885-6160 E-Mail info@peeksitecom.com

DRAWN BY: =SHEET TITLE: ===

TITLE SHEET

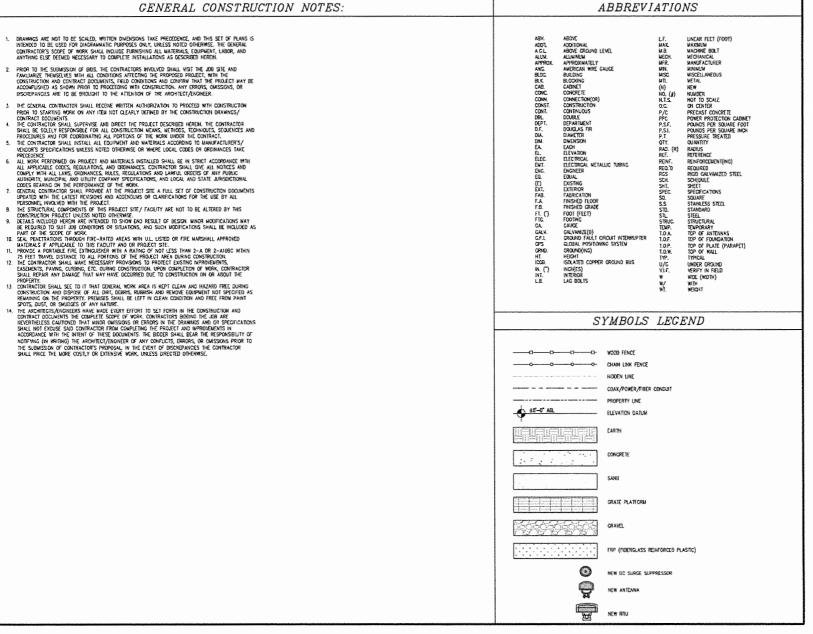

PROPRIETARY INFORMATION THE INFORMATION CONTAINED IN THIS SET OF DRAWINGS IS PROPRIETARY BY NATURE. ANY USE OR DISCLOSURE OTHER THAN THAT WHICH RELATES TO PEEK SITE-COM IS STRICTLY PROHIBITED CLIENT: 5001 EXECUTIVE PKWY SAN RAMON, CA 94583 PROJECT INFORMATION: ZEE ESTATES CATE LANE 1,000" SOUTH EAST OF THE INTERSECTION OF GATE LANE AND SALMON FALLS ROAD PROT HELL, CA 95664 DESCRIPTION: == 1 6-29-17 90% ZONING DOC'S RB 1 8-3-17 90% ZONING DOC'S ALP 2 8-9-17 100% ZONING DOC'S ALP COORDINATING ENGINEER: Peek Site-Com 12852 Earhart Ave. Suite 101 Auburn, California 95602 Phone (530) 885-6160 E-Mall info@peaksitecom.com SEAL: STE A = __ CHK.: ___ DRAWN BY: = CVL03629 RB SHEET TITLE: GENERAL NOTES




This Site Operated by:

AT&T MOBILITY 2600 CAMINO RAMON, 4M550 N SAN RAMON, CA 94583 IN CASE OF RRE AND THE NEED FOR SHUTDOWN TO DEACTIVATE ANTENNAS CALL THE FOLLOWING MUMBER: For 24 Hour Emergency Contact and Access Please Call: (800) 832-6662

Reference Site#: CYLO3629 Site Address: 860 GATE LN. PILOT HitL. CA 95684

FENCED COMPOUND SIGNAGE

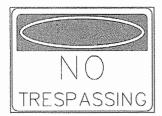

FENCED COMPOUND SIGNAGE

Compactor Sinel Poine, 41 information sound: In accordance of Ata?
 Realess colonial rea-cola. If devolve pract ind if safety compliance process.
 Spok 1-2 fole, 52 retal. If, that safety incompliance process.

FABRICATION

INFORMATION]

THE MENTS THE THE PART THE MET WITHOUT AN THE LECTION SCHOOL IN SCHOOL STREET WITHOUT AN THE LECTION SCHOOL STREET, WITHOUT AND THE WITHOUT AND THE ALL PROPERTY OF AN ADMINISTRATION OF THE PARTY OF AND THE ALL PROPERTY OF THE PARTY OF THE

CAME THE BEST OF THE MEMORY STORE WHEN

SOURCE AND MERCET AT ESS. THE MAY PROPERTY AND THE PROPER

CHANGE HE BROWNERS STICK F BY SUSPICIONAL BY SAN FRANCE

(NFORMACION)

EXPRINGED OF MEMORIAN S (MEMORIAL DE PASSE) NAS MUNICIPALIS COR DE IMPARTAMO O FOR MANAGEMENTS DE PASS EXPRENDENTES COR DE IMPARTAMO O FOR MANAGEMENTS DE PASS EXPRENDENTES COR DE IMPARTAMO O FOR MANAGEMENTS DE PASS EXPRENDENTES COR DE IMPARTAMO O FOR MANAGEMENTS DE PASS EXPRENDENTES COR DE IMPARTAMO O FOR MANAGEMENTS DE PASS EXPRENDENTES COR DE IMPARTAMO O FOR MANAGEMENTS DE PASS EXPRENDENTES COR DE IMPARTAMO O FOR MANAGEMENTS DE PASS EXPRENDENTES COR DE IMPARTAMO O FOR MANAGEMENTS DE PASS EXPRENDENTES COR DE IMPARTAMO O FOR MANAGEMENTS DE PASS EXPRENDENTES COR DE IMPARTAMO O FOR MANAGEMENTS DE PASS EXPRENDENTES COR DE IMPARTAMO O FOR MANAGEMENTS DE PASS EXPRENDENTES COR DE PASSE DE PASSE DE PASS EXPRENDENTES COR DE PASSE DE PASSE DE PASS EXPRENDENTES DE PASSE DE PAS

COLUMN COLUMN SAI ANNUAL MIS-AM-INST AND IN MAJOR COLUMN SAMPAGENT & RESIDENCE OF LAS MISSAS SE ASSESSMENT

FARM COMMISSION CON LA SPONN ME LA MINISTRACION ME, CORON SI CON PLOTA DI COMPLUTO, DE DICLOTRA AN COMPANY.

INFORMATION SIGN 1-1

PSCH I-E ENTRINCE DOOR SEE EITHAL 1A, IMS SHEE! SON I IS TO BE NIGED ON THE 50 NA ALMANNA SHETTING (STE & HOLES BY 12 HOLES) BY (4) 1/4 NOI HUMALTING HOLES, ONE LOCK CONTRO OF IME SON TOR HUMATING BY MARDINNE BY IT, WAMES IN E MAIN BACKETOWNO CECCO IS THE SEE MATE FRONT &

LETTERS. THE RET LINE SHALL HE IN 1/9 MICH LETTERS.

THE PLACEMENT OF TEXT SHALL BE SOME IN A MAINTER THAT WILL PERMIT EASY READING THOM A CISTANCE OF APPROXIMATELY 6 FILET IN FRONT OF THE SOM.

INFORMATION O DI THE OUTSIDE PACE OF THE BLAZE

INFORMATION SIGN 1-2

1390 1-3: BACK OF ANTENNAS, SIT DETAIL IC & 3, THS SPEET "SICN 3 IS A 1 INCH X 2 INCH PARKL THAT CAN BE APPLIED TO THE BACK OR SIDE OF AN ANTENNA TO EXENTER IT AS AN ATERT ANIBANA.

49OH 1-4: SIX OF ANTONAS, SIX DETAIL TO IN 3, THIS SHIFT

SON A IS MADE FROM TRANSPARENT MATERIAL 1-1/2 INCIES NOT & 24 HOUS LONG. THE LETTERING IS TO BE BLACK W/ 1/2 BIDN LETTERING IN A VERTICAL COLLARY. THE SPACING SETHEDN WORDS MUST BE SIXEN BHAT IT IS EASLY READ & FILES THE LENGTH OF THE SIGN

SICHACE AND STRIPING RECENATION

€atat :

1-1/2

INFORMATION SIGN 1-3

INFORMATION SIGN 1-4

- THE FOLLOWING INFORMATION IS A CRICILLE MY REPYCET TO PREVIABLE STRUCTURES LIMITING HANNIN EPPOSITIET TO RADIO FREADENT DISTRICT MOD DICALD RELIGIOUS AS SIGN. IF THE STITE SHE WELLOCK, STATE OF RETURN LIMITINGS OF REPAIRS ON ADJUSTED IN COLUMN TO MERILANCES SHOULDES IN COMMUNITY MY MAY PART OF YELLY WORKS ON HANNI, THE MUSIC RESTRICTING CARRILLING ON REGILATION SHELLY OF FRUIDANCES AND CONSTRUCTING CARRILLING ON REGILATION SHELLY OF FRUIDANCES AND CONSTRUCTIONS.
- f the botton of the antidola is nounted (b) eight feet above the ground or nondho Platforn like of the percola, commacation firston (PCS) and does not exceed the Public limit of by exposize limit then no strongs or rappically syclud be needed.
- IF THE PUBLIC LIMIT OF ST EXPOSURE ON THE STIE IS EXCEEDED AND THE AREA IS PUBLICLY AND SECURITY OF ACCESS CONTROL BY LESS AND SECURITY OF A PROPERTY OF ACCESSING LEG TO ACCESS CONTROL BY ACCESS CONTROL BY ACCESS AND SERVED SOUL BY PLACED ACCESSION OF ACCESSION AND SERVED SOUL BY PLACED ACCESSION OF ACCESSION AND SERVED SOUL BY ACCESSION OF ACCESSION AND SERVED SOUL BY ACCESSION OF ACC
- F HE PAIRS UM O' HE D'ORGES ON THE SITE IS DICTIVID AND THE AME IS PAIRS.

 ACTUSSILE (E.E. ROY ACCESS DORS THE AMEDITE (LOVID), ON THE (DESSES) THE FORM

 ACCESSALE (E.E. ROY ACCESS DORS THE AMEDITE (LOVID), ON THE (DESSES) THE FORM

 BANGACES AND SERVING SHALL RE PAIRS AMOND THE AMEDITES HE THAT IS THE FORM SHALL BE AMEDITED AT THE FORM SHALL BE CAUSED.

 BANGACES AND SERVING SHALL RE PAIRS AND SHALL BE AMEDITED AT THE COMPLETE OF SHE CONSIDERITY, OF THE PAIRS AS A DURING FOR PAIRS THAT AND SHALL BE ASSESSED.
- ALL TRANSACT ANTENNAS REGLARE A TYPIE LANGLACE WARRING SON MITTEN IN ENGLISH SPANSAL AND DENESE, THIS SOLE SHALL BE PROMOTED TO THE CONTRACTOR Y THE ATAI SHAME, AND CHEEK HES SON DOUL BE PROMOTED TO BE CONTRICTION IT FOR ANY CONTRICTION PLANT INSURED AT THE ANY CONTRICTION PLANT INSURED A
- MINISTOR OF ALL STREME, IMPROCEDED SOUND SHALL SE PART OF THE CONSISTENCY OLD COLOR OF THE CONSISTENCY AS SHALL SE TRADE HIS THE THAT CONSISTENCY MANAGE A SHALL SE TRADE HIS THE THAT CONSISTENCY MANAGE AND THE CONSISTENCY MANAGE AND THE CONSISTENCY MANAGE AND THE CONSISTENCY MANAGE AND THE CONSISTENCY MANAGES AND THE VALUE OF ANY FACE RESISTENCY THAT SHALL S
- 8 SHOP DRAWING OF EACH BARRICAGE, LIPON CONSTRUCTION COMPLETION

The approximation bane) shall be 1.2 fight screen band by 0.5 fight high black lettering. The body of the text shall be in black lettering by 0.2 fight high

ALL PARMY WILL BE BAKER W/ ENAMEL W/ UV PROTECTIVE COLATING OVER THE FACE OF THE SIGN

INFORMATION SIGNAGE

MOTE:

GENERAL NOTES



DOOR / EQUIPMENT SIGN

1234567

INFORMATION

FCC ASR SIGNAGE

Property of AT&T Authorized Personnel Only

In case of emergency, or prior to performing maintenance on this site, call and reference cell site number

Property of AT&T **Authorized** Personnel Only

> maintenance on this site, cal and reference cell she number

WARNING

CONTRACTOR SIMIL CONTACT AT&T R-RESC FOR INFORMATION ON UPE LEVELS AND RESTRUCTIONS ON

CONTRACTOR SHALL HASTALL ALL INFORMATION SCHOOLS ACCORDANCE W/ ATAT WALLESS DOCUMENT JOS-0074, NF EMPOSIUM, PAREST ENTITION SESSET TO CONTRACTOR PROGRAM, LAREST ENTITION.



Beyond This Point you are entering a controlled area where RF Emissions exceed the FCC Controlled Exposure limits Failure to obey all posted signs and sits guidelines could result in serious injury

Bet FCC 47CFR 1.13CF(b)

CAUTION



Beyond This Point you are entering a controlled area where RF Emissions may exceed the FCC Controlled Exposure limits

Obey all posted signs and site guidelit for working in an RF environment

BAC PCC 47C/R 1.180/66

NOTICE



Beyond This Point you are entering an area where RF Emissions may exceed the FCC General Population Exposure Limits

Follow all posted eigns and site guidelines for working in an RF environment.

Belt FCC 47CFR 1,1507(b)

NOTICE SIGN

PROPRIETARY INFORMATION

THE INFORMATION CONTAINED IN THIS
SET OF DRAWINGS IS PROPRIETARY
BY NATURE, ANY USE OR
DISCLOSURE OTHER THAN THAT WHICH
RELATES TO PEEK SITE-COM IS
STRICTLY PROHIBITED

CLIENT:



5001 EXECUTIVE PKWY SAN RAMON, CA 94583

PROJECT INFORMATION:

ZEE ESTATES

DATE LAWE 1,000' SOUTH EAST OF THE INTERSECTION OF GATE LAWE AND SALWON FALLS ROAD PLOT HILL, CA 95854 REV: == DATE: == DESCRIPTION: = = BY: 1 6-29-17 90% ZONING DOC'S RFI 1 8-3-17 90% ZONING DOC'S ALP 2 8-9-17 100% ZONING DOC'S ALP

COORDINATING ENGINEER:

-SFAI: -

Peek Site-Com

12852 Earhort Ave. Suite 101 Auburn, California 95602 Phone (530) 885-6160

E-Mail Info@peeksitecom.com


STE # DRAWN BY: CVL03629 RB


SITE SIGNAGE

SHELTER/CABINET DOORS SIGNAGE

GATE SIGNAGE

CAUTION AND WARNING SIGN

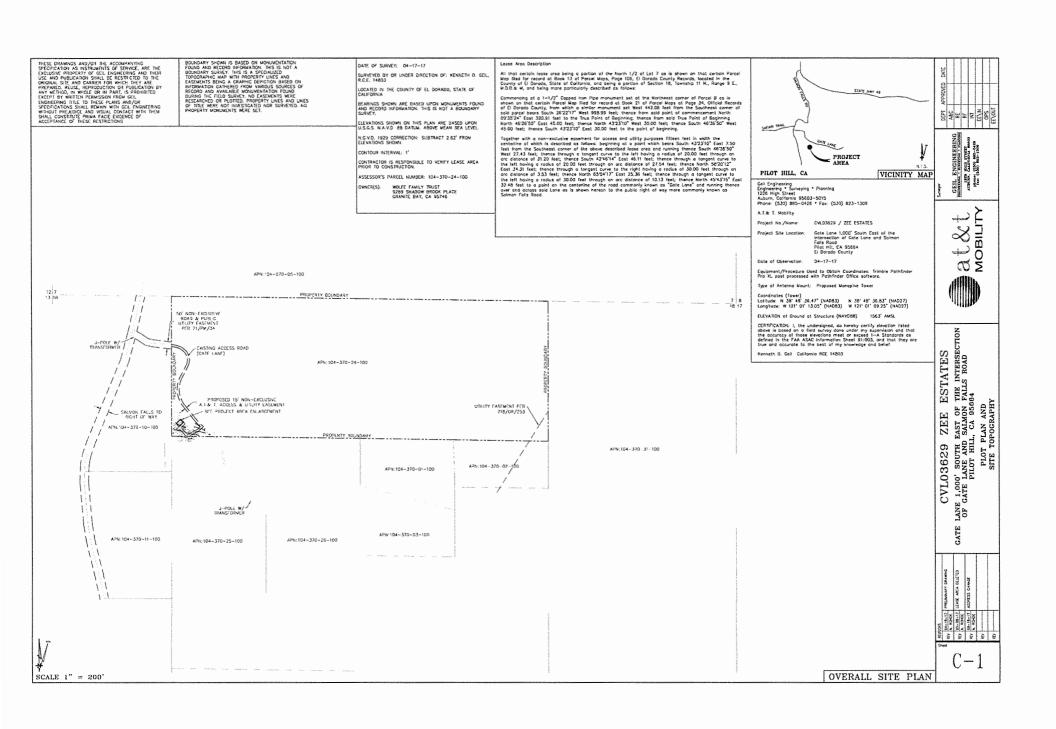

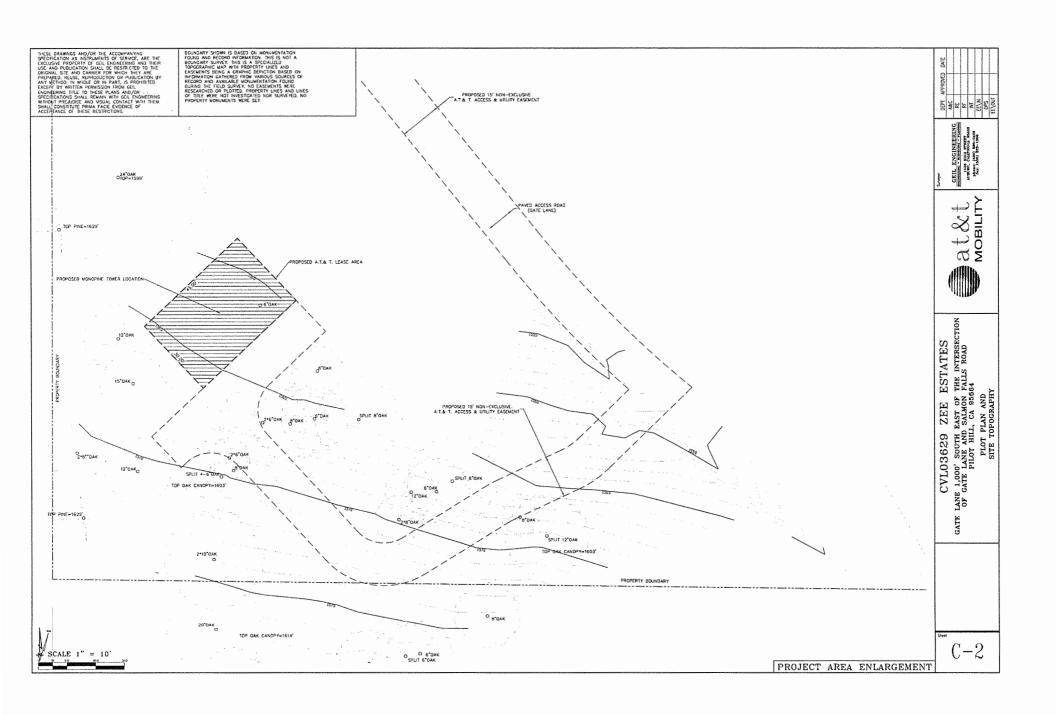

GENERAL NOTES

- THE CONTRACTOR SHALL HAVE A RESPONSIBLE PARTY, WHO SHALL HAVE THE AUTHORITY TO REPRESENT AND ACT FOR THE CONTRACTOR, ON THE JOS SITE DURING ALL WORKING HOURS.
- ALL WORK SHALL BE ACCOMPLISHED TO THE SATISFACTION OF THE WASHOE COUNTY AUTHORIZED REPRESENTATIVE.

DEFINITIONS:

CECT - ERGIGN AND SEDMENT CONTROL
(CSC) - ERGIGN AND SEDMENT CONTROL
(NPDES) - NATIONAL PALLUTANT DISCHARGE ELIMINATION SYSTEM
(CWA) - CLEAN WATER PALLUTION PREVENTION PLAN
(BWPS) - EST MANAGEMENT PRACTICES
(BWPS) - REST MANAGEMENT PRACTICES

THE CONTRACTOR SHALL;
MAKE HM/HERSELF AWARE OF THE REQUIREMENTS OF SWO GENERAL PERMIT AND THE PROVISIONS OF THE GRADING A EROSION CONTROL PLANS.

INFLEMENT THE ESC FEATURES AND BEST MANAGEMENT PRACTICES (BMP'S) CONTAMED IN THE IMPROVEMENT PLANS, AND OTHERWISE DILIGENTLY PURSUE COMPULANCE WITH THE LOCAL RECORRECMENT.

ASSIST THE OWNER, ENGNEER, AND PUBLIC WORKS DEPARTMENT STAFF IN THE ASSESSMENT OF THE FUNCTIONALITY OF AND MODIFICATIONS TO THE FEATURES AND PRACTICES IMPLEMENTED AND PROPOSED.

MEET WITH THE OWNER AND THE PUBLIC WORKS DEPARTMENT STAFF TO DETERMINE AND DISCUSS THE STATUS OF THE PROJECT, CONSTRUCTION SCHOOLIC, AND ANY MODIFICATION AND/OR ADDITIONS TO THE ESC FEATURES IN ORDER TO DIJGENILY PURSUE COMPLIANCE.

OCCUMENT ANY MANTENANCE, REPLACEMENT, INSPICTION, MODIFICATIONS OR ADDITIONS TO THE PROJECT ESS FEATURES, AND NOTEY THE THOMESE. DINNER AND PUBLIC WORKS OFFARMANT STATE OF ANY SUBSTAINFIA, MODIFICATIONS OR ADDITIONS TO THE ESS PRACEICES AND FEATURES, ALL DISTURBED AREAS SMALL BE PROJECTED WITH APPROVED MATERIALS WHIMI IS DATA OF COMPLETION OF THE PRINCED GRACES.

MAINTAIN AN INVENTORY OF ESC MATERIALS (STRAW BALES, 1.5" - 3" CLEAN ERUSHED ROCK, FIBER ROLLS, SULT FENCE, ROCK BAOS, ETC.) ON SHIE FOR EMPRICANCY USE AS DIRECTED BY THE EMBILIER, OWINE, OR THE PUBLIC WORKS DEPARTMENT STAFF.

OTHER RESPONSIBILITIES OF APPLICANT:

- A. PROTECTION OF UTILITIES. THE APPLICANT SHALL BE RESPONSIBLE FOR THE PREVENTION OF DAMAGE TO ANY PUBLIC UTILITIES OR SERVICES.
- D. PROTECTION OF ADJACENT PROPERTY. THE APPLICANT SHALL DE RESPONSIBLE
- C. FOR THE PREVENTION OF DAMAGE TO ADJACENT PROPERTY. NO PERSON(S) SHALL EXCAVATE ON LAND THAT IS SO CLOSE TO THE REPORTED LINE AS TO ENDANCER ANY ADJOVING PUDIL'S TREET, SOEMAK, ALLY, STRUCTURE OR OTHER PUBLIC OF PRIVATE PROPERTY EAST-CONTINUED LINES OF THE PROPERTY FROM ANY DAMAGE WHICH WIGHT DIMERSER, TREET
- ADVANCE NOTICE. THE APPLICANT SHALL NOTIFY THE COUNTY AT LEAST FORTY-DIGHT HOURS PRIOR TO THE START OF WORK,
- COMPLANCE WITH STORMWATER RUNDER POLLUTION CONTROL CODE. AT ALL TIMES DURING THE PRECONSTRUCTION AND CONSTRUCTION OF ANY PROJECT FOR WHICH CARAPING APPROXISTS AND PREVAMENT STRUCTURES ARE COMPLETE. THE APPLICANT SHALL FULLY COMPLY WITH ALL APPLICABLE REQUIREMENTS OF THE STORMWATER SHANDER POLLUTION CONTROL COOK.


- EROSION CONTROL NOTES ALL EROSION AND SEDMENT CONTROL MEASURES SHALL BE CONSTRUCTED AND MAINTAINED IN ACCORDANCE WITH THE COUNTY IMPROVEMENT STANDARDS, CURRENT EDITION, AND THE COUNTY EROSION AND SEDMENT CONTROL CUIDELINES.
- EROSION CONTROL BEST WAVACEMENT PRACTICES (BMPs) SHALL BE INSTALLED AND MARTIANED DURNIC THE MET SEASON (OCTIONER THROUGH APRIL 30). SEPIMENT CONTROL BMPs SHALL BE INSTALLED AND MARTIANDE DAL 12ATI.
- 3 ALL DRAWAGE MEITS INACOUTELY DOWNTREAM OF THE WORK AREAS AND WITHIN THE MORK AREAS SIMIL DE PROTECTED WITH SEDMENT CONFRO, AND INVET FILTER DAGS, YAM ROUND, BULET FILTER DAGS SIMIL DE REMONDET FROM THE DRAWAGE INLETS UPON ACCEPTANCE OF THE PURILC IMPROVEMENTS BY THE COUNTY.
- 4. ALL AREAS OISTURBED DURING CONSTRUCTION, BY CHADNIG, TRENCHING, OR OTHER ACTIVITIES, SHALL BE PROTECTED FROM EROSION DURING THE WET SEASON (OCTOBER 1 THROUGH APRIL 30). HOROSEED, IF UTUZED, MUST BE PACEED BY SEPTEMENE 15. THROUGH APRIL DURING THE WET SEASON SMALL USE A SECONDARY EROSION PROTECTION METHOD.
- SENSITIVE AREAS AND AREAS WHERE EXISTING VEGETATION IS BEING PRESERVED SHALL BE PROTECTED WITH CONSTRUCTION FENCING. SEDIMENT CONTROL BURS SHALL BE INSTALLED WHERE ACTIVE CONSTRUCTION AREAS BRAIN INTO SENSITIVE OR PRESERVED VEGETATION AREAS.
- 6. SEDIMENT CONTROL SUPS SHALL BE PLACED ALONG THE PROJECT PERMETER WHERE DRAWAGE LEAVES THE PROJECT. SEDIMENT CONTROL BUPS SHALL BE MAINTAINED YEAR ROUND UNITE. THE CONSTRUCTION IS COMPLETE OR THE DRAWAGE PATTERN HAS BEEN CHANGED AND NO LONGER LEAVES THE SITE.
- THE FOLLOWING AREAS ARE TO RECEIVE INTOROSEEDING OR OTHER EROSION CONTROL; ALL SLOPES GREATER THAN 10:1.
- 8. FOR DEMATERING OPERATIONS, SEDIMENT—LADON STORM MATER SHALL BE EITHER PUMPED (NOTE 10) OR ROUTED (TEMPORATE DAYERSON SHALE) TO SEDIMENT TRANS) TO ALLOW SEDIMENT TO SETTLE OUT BETORE DISCHARGE OFF—STE, ONCE SEDIMENT HAS SETTLED OUT, WATER WELL BE DISCHARGED THROUGH SHALE LINED WITH AMPERMOUS FLASTIC LINER.
- 9. USE OF FIBER BOLLS SMALL BE ANOMENTED DURING WET SEASON WITH DEMATERING BUP"B IN THE OVENT THAT FIDER ROLLS DO NOT EFFECTIVELY RETAIN STORM WATER ON STE. DEMATERING WAY INCLUDE FURMED OR BEHAVE TO ROUTE MAINT OF THE SECONDITY TRAP IF PILLIPS AND USED, THEN FILTER BAGS SHALL BE USED AT DISCHARGE HOSE ENGS. DEMATERING OMERICAL SHALL NOT OF DOSCHARGE DIRECTLY TO THE STORM DAYAN STSTEW.

	BMP IN	STALLATION	SCHEDULE
BEST WANAGEMENT PRACTICE	LOCATION	SCHEDULE SCHEDULE	MAINTENANCE SCHEDULE
A PRESUMENC ENTING VEGETATION	AROUND PERMETER OF PROJECT SITE	CONTINUENS, UNTIL CONSTRUCTION IS COMPLETED	EDUCATE EMPLOYEES AND SUSCONTRACTORS REGARDING EXPORTANCE AT MASTANNA EXSTRACT VECETATION TO PREVIOTE RESIDENCE AND THER AND SECURED AREAS ON THE ANALYSIS OF THE CONSTRUCTION SET. NOTICE SET PRANCES MAKEN TO VECETA THE DUTS OF VECETATION IS NOT DISTURBED.
B. PROTECT GRADED ANEAS AND SLEPES FROM WASHOUT & EROSION	THROUGHOUT PROJECT SITE	DURNO WET SEASON	DISPIECT CRADED AREAS AND SLOPES ON AT LEAST A MONTHLY BASIS TO DISCK TOR EFOSSION RECHARD TRIBUTIANY AREAS OR DESTAIL FEITER BARRIER ON SAND BAC DIVISE AS ACCUSTARY TO PERCHAL DISPISON.
C. GRAVEL PLTER	ALDRG FLOW LINES OF UNPAYED HOADWAYS WITHIN SITE	H PLACE DUTING WET SEASON LINTL ROADWAYS ARE PAMED	PRIFEIT DALY AND AFTER EACH STORM, RYMONE ONSITE SEDMENT DEPOSITED BONNO BERN OR BARRIER TO MANIAM EFFECTIVENESS.
D. INLET PLTER BAG	BLETS TO THE STORM DRAMASE SYSTEM	CONTINUOUS UNTIL LANDSCAPING IS IN PLACE	REPORT MEDGY AND AFTER EACH STORM, REMOVE SECURIST AND DESIGN SEFORE ACCURATIONS HAVE REACHED CHE THERE DIE DEPTH OF THE DA REFAR OR REPLACE DIET FETER SING AS SOON A DAMAGE OCCURS.
t. FIREN ROLL	SET PLAY SHEET	COMPANIUS	REPRET WERLY AND AFTER EACH STORM, REMOVE SEDWENT DEPOSITED BEING FREE ROLL WHENEVE HEGESSARY TO MAINTAIN EFFECTIVENESS.
F. INTEROSSEDING	EI SLOPES	M PLACE DURING BY SEPT. 13	INSPECT SLOPES ON AT LEAST A MONTHLY BASIS OFFICE FOR EROSON, IF EXISTEN IS MOTED, SPREAD STRAW WALCH OVER AFTECTED AREAS.
O. STABILIZED CONSTRUCTION ENTRANCE	ENTRANCES TO SITE FINCH PUBLIC ROACHAYS	CONTINUOUS, UNTIL ENTRANCES AND ONSITE ROADINAYS ARE PAVED	INSPECT ON A MONTHLY BASES AND AFTER EACH RANFALL ADD ACCESSATE BASE MATERIAL WHENCH INCESSANT TO PREVENT SEEMONT FROM BOING TRACKED INTO PUBLIC STREET.
H, WIND ERISSON CONTROL PRACTICES	MEREVER MECESSARY THROUGHOUT PROJECT SITE	CONTINUOUS UNTIL GRADING IS COMPLETED AND SOUS HAVE STABILIZED	RISPECT STE DURING WHEY CONCITIONS TO CONCITY AREAS SHICKE FROM EROSON IS COCUMENING AND ARATE EROSON AS NECESSARY
I, GOOD HOUSEKEEPING MEASURES	PROJECT SITE	COMPLETED	INSPECT SITE ON AT LEAST A MONTHLY BASIS TO VERFY THAT GOED HOUSEKEEPING PRACTICES ARE BEING IMPLEMENTED.
J. PROPER CONSTRUCTION MATERIAL STORAGE	DESCHATED ATEA	COMMUDUS UNTAL CONSTRUCTION IS COMPLETED	PASPECT SITE ON AT LEAST A WEDGY BASIS TO VERFY THAT CONSTRUCTION MATERIALS ARE STORE IN A MANUFER PROCESSOR BOARD NOT CAUSE STORM WATER POLICITION.
K. PROPEH CONSTINACTION WASTE STORAGE AND DISPOSAL INCLUDING	DESIGNATED COLLECTION AREA AND CONTANENS	CONTINUOUS UNTIL CONSTRUCTION IS COMPLETED	INSPECT SITE ON AT LEAST A WEIGHT BASIS TO ASSURE WASTE IS STORED PROPERLY AND DISPOSE OF AT LEGAL DISPOSAL SITE, DALLY.
1) CONCRETE SPEL CLEANUP INCLUDING 1) PAINT & PAINTING	MEA	MINISTRATELY AT TIME OF SPALL	INSPECT MATERIAL HANDING MISAS ON AT LEAST A MONTHLY BASIS TO VERBY PROPER SPEL CLEANUS
SUPPLIES 2) VENICLE FUEUNG WANTENANCE & CLEWING	DESCHATED AREA WITH SEDENDARY CONTARMENT	CONTINUOUS	KEEP AMPLE SUPPLIES OF SPILL CLEARSP MAIRINALS ON SITE & NOPECT ON KICHLAR SCHEDULE
L. STREET AND STORM DRANACE FACULTY MAINTENANCE DEPORTSONS	STREETS AND STORM DRAMAGE FACALITIES	CONTINUOUS UNTIL CONSTRUCTION IS COMPLETED	MANIAN STORM DRANGE FACULTES AND PAYED STREETS CLEAR OF SECUMENT AND DESKS.

- 1, MET STASON: EMTRE PERSON BETMEN OCTOBER 1 THROUGH APRIL 30. CONTRACTOR SHALL ALSO SAFEDIDIT ME SEASON BEASENES IF NET MEATHER IS EXPECTED DURING THE DRY SEASON. 2. PHASES OF DANCING.
- F. MACES OF DESCRIPTIONS
 BINDLE CENTED IN PRIOR CLURAGE MAD DESCRIPTION ACTIVITIES OCCUR.
 BOUND (1974) 22 WHICH CLUT HOS FILL ACTIVITIES OCCUR MAD THE DIT IMPROVEMENTS ARE CONTRIBUTED, INCLUDING
 FIRML (1974) 23 WHICH THE LIGHTHING MAY SET, MAD BYT IMPROVEMENTS ARE COMPUTED AND REACH FOR COMPUTED.

REQUIRED BMPS

- THE FOLLOWING BMPS SHALL BE REQUIRED ON ALL PROJECTS:
- A. ACCESS POINTS TO THE CONSTRUCTION SITE SHALL HAVE A STABILIZED CONSTRUCTION ACCESS.
- B. THE PRESERVATION OF EXISTING VEGETATION SHALL BE DONE IN ACCORDANCE WITH PRESERVATION OF EXISTING VEGETATION, AND SILT FENCE.
- C. PERIMETER PROTECTION ALONG PROPERTY LINES SHALL HAVE PRESERVATION OF EXISTING VEGETATION, OR SAT FENCE.
- SLOPES GREATER THAN 3 PERCENT SHALL BE TEMPORARLY SEEDED AND SLOPES CREATER 3:1
 (H.Y) SHALL HAVE HYDROSEDING AND/OR GEDTEXTILES, PLASTIC COVERS, AND/OR EROSION
 CONTROL BLACKETS INSTALED.
- E. THE TOE OF ALL SLOPES SHALL HAVE SILT FENCE AND/OR FIBER ROLL
- F. DISTURBED SOIL AREAS BEHIND THE CURB OR BACK OF WALK (OR CURB) SHALL HAVE STRAW MUICH, SOIL BINDERS OR GEOTEXTILES, PLASTIC COVERS, AND EROSION CONTROL BLANKETS/MATS IN CONJUNCTION WITH HYDROSEDING, SUIDFACE TREATMENTS SHALL EXTEND TO THE GREATER OF 6 MICHES (20 FEET) OR TO THE TOP OF SLOPE.
- G. ROADWAY SUBGRADES SHALL HAVE FIBER ROLL, SILT FENCE, OR SEDIMENT TRAP.
- H. DEAD END STREETS, TO BE EXTENDED IN THE FUTURE, SMALL HAVE PRESERVATION OF EXISTING VEGICIATION, HYDROSEEDING, SEDIMENT TRAP OR OTHER APPLICABLE BURY TO MINIMIZE THE TRANSPORT OF SEDIMENT ONTO OR FROM THE MINORYCY SURFACE.
- PROJECTS THAT INCLUDE DETENTION BASINS SHALL HAVE A SEDIMENT BASIN
- J. PLACE DRAINAGE INCET SEDIMENT BUPS AT ALL STORM DRAIN INJETS. BMPS SHALL INCLUDE INJET SEDIMENT CONTROL BARRIER, INJET FILTER BAG AND CONCRETE STAMPS OR EXPOXED PLAQUARDS.
- K. EACH CONSTRUCTION SITE SHALL PROVIDE DESIGNATED, PAINT AND WASTE DISPOSAL LOCATIONS AS
- . A BMP INSTALLATION SCHEDULE SHALL BE INCLUDED ON THE IMPROVEMENT PLAYS, THE SCHEDULE SHALL INCLUDE THE DIMPS FOR DOTH THE WET STASON AND THE DRY STASON.

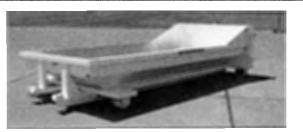

PORTABLE CONCRETE WASHOUT CONTAINER

INSPECTION & MAINTENANCE OF FIBER ROLLS:

- 1. MOMENT REPLACE SHAFT, TORN, LARRINGS OR ELLIGATION OF DEED 2. INFECT, PROT. BRICLE WITH NAME & FORECAST, FOLLOWING MAN THE HER PROTECTION OF THE REPLACE OF THE PROTECTION OF THE THE HER PROTECTION OF THE PROTECTION OF THE PROTECTION OF THE 3. STORED SHAFT OF THE PROTECTION OF THE PROTECTION OF THE THE PROTECTION OF THE PROTECTION OF THE PROTECTION OF THE PRO-TECT OF THE PROTECTION OF THE PROTECT NOTES:

- THE PROPERTY OF THE CONTINUED DOES DEADED TO CITIZED AND ASSOCIATION OF THE PROPERTY OF THE PR

REVEGETATION STANDARDS

FIBER ROLLS

TYPICAL FIBER ROLL INSTALLATION

FISER ROLL 200 MN MN. (8 N.)

19 MW x 19MM (3/4 IN. x 3/4 IN.) WOOD STAKES MAX. 1.2 M (4 FT.) SPACING

100 MM (4 IN.) MAX 50 MM (2 IN.) MIN.

- PRIMARITÉ RIVECTATION OR LANDSCAPING, É ECQUITICO, E. TO DE COMMENCIO DI NIE CONSTRUCTION STÉ AS SOON ÀS PRACTICA. AND IN NO USE EXCEENSI TREVES MONTRE AFFER ACHIEVAND FINAL GRACES AND UNITY PLACEORISM, MERNORS PRACTICAL, AND IN 10 THE DEVILOPION SIGNIC CONSTRUCTION SERVICES PROCIDEN CONTROL MESSINGS ART TO DE CONDIGNATION STATE OF PRACTICA CONTROL MESSINGS ART TO DE CONDIGNATION HIM SESSIBLES OF PRACTICAL PRINCIPALITY.
- ALL SUPPOSES OSTUBRED BY VEGETATION RELIGIAL, GRADNO, MAX. REGACO, ON DIFFER ACTIVITY OF CONSTRUCTION WHICH, ATTER THE HALFUAL VEGETATION COVER MEET DIE PREPARED FOR EDIFICIENT REVECETATION OF DIFFERENCE ACTIVITY OF DIFFERENCE ACTIVITY OF DIFFERENCE ACTIVITY OF DIFFERENCE ACTIVITY OF CANADA, WHICH PROVINCE ACTIVITY OF CANADA, ON PROVINCE OF VEGETATION IS NO DERMON MEET REMOVED.
- TOPSON REMOXED FROM THE SURFACE IN PREPARATION FOR GRADING SHALL BE RESTORED TO EXPOSE CUT AND FILL EMPARKMENTS OR BUILDING PAGES OF AS TO PROVIDE A SUITABLE BASE FOR SEEDING AND PLANTING.

- TEMPORARY SEXMENTATION CONTROL FACILITIES ARE TO BE INSTALLED IN CONJUNCTION WITH MITHAL GRADING OPERATIONS AND MAINTAINED THROUGHOUT THE CONSTRUCTION PERSON TO REMOVE SEDMENTS FROM RUNGEF WATERS DURING DEVELOPMENT.
- PERMANENT SEDMENT CATCHMENT BASINS OR OTHER TYPES OF SEDMENT RETURNON FACENCES ARE REQUESTED WHEREVER NECESSARY TO PREVENT CHICKMARGE OF SEDMENT WITH DATERS OF THE STATE, SEDMENT RETURNON FACENCES SHALL BE INSPICTED AND CLEANED ACCORDING TO A REQUEST MAINTENANCE SOMEDULE.
- THE PLANTING OR SEEDING OF VEGETATIVE PROTECTION MUST BE EFFECTIVE. IF THE VEGETATION DOES NOT GROW AND OFFER PROPER PROTECTION, IT MUST BE REPUBLIED OR RESEDUED.

DUST MITIGATION PLAN

SECTION 1: FUGITIVE DUST PREVENTION AND CONTROL

LAND CLEARING/EARTH MOVING:
MATER SHALL BE APPLIED IT MEANS OF TRUCK(S), HOSES
AND/OR SPERMELTES PROFE TO ANY LAND CLEARING OR
EARTH MOVEMENT TO MINAUZE DUST EMISSIONS. HAUL
VERCLES TRANSPORTING SOL INTO OR OUT OF THE
PROPERTY SHALL BE COMERCO.

VISIBLY DRY DISTURBED SOIL SURFACE AREAS: ALL VISIBLY DRY DISTURBED SOIL SURFACE AREAS OF OPERATION SHALL BE WATERED TO MINIMIZE DUST EMISSIONS.

VISERT DRY DISTURBED UNPAMED DRIVEWAYS:

ALL VISIEST DRY DISTURBED UNPAMED DRIVEWAY SURFACE

ARCAS OF OPERATION SHALL DE WATEMED TO MINIMEZE

DUST EMISSIONS. UNPAMED DRIVEWAYS MAY BE GRAVELED

TO REDUCE DUST EMISSIONS.

VEHICLES ENTERING / EXITING CONSTRUCTION AREA-VEHICLES ENTERING OR EXITING CONSTRUCTION AREA SHALL TRAVEL AT A SPEED WHICH MINIMIZES DUST EMISSIONS.

EMPLOYEE VEHICLES: CONSTRUCTION WORKERS PARK IN DESIGNATED PARKING AREA(S) TO HELP REDUCE DUST EMISSIONS.

SOL PILES: DOL PILE SURFACES SHALL BE MOSTENED IF OUST IS DOL PAINT OF FROM THE PILE(S). ACCOUNTELY SECURED THE PLANT OF THE MAINTAIN ANY DE REQUIRED TO FURTHER REDUCE DUST EMISSIONS.

PROPRIETARY INFORMATION

THE INFORMATION CONTAINED IN THIS THE INFORMATION CONTRINCE IN THIS
SET OF DRAWINGS IS PROPRIETARY
BY NATURE. ANY USE OR
DISCLOSURE OTHER THAN THAT WHICH
RELATES TO PEEK SITE-COM IS
STRICTLY PROHIBITED

CUENT:



5001 EXECUTIVE PKWY

PROJECT INFORMATION:

ZEE ESTATES GATE LANE 1,000' SOUTH EAST OF THE INTERSECTION OF CATE

11		PLOT HILL, CA 95654	
REV:	= DATE: ===	DESCRIPTION;	<u> </u>
1	6-29-17	90% ZONING DOC'S	RB
1	8-3-17	90% ZONING DOC'S	ALF
2	8-9-17	100% ZONING DOC'S	ALF
			T
			T
			1

COORDINATING ENGINEER:

- CAN: -

Peek Site-Com 12852 Earhart Ave. Suite 101 Auburn, California 95602 Phone (530) 885-6160

E-Mail Info@peeksilecom.com

STE # ____ OHK ____ DRAWN BY CVL03629 SHEET THRE:

EROSION CONTROL NOTES

GRADING STANDARDS

- GENERAL, UNLESS OTHERWISE RECOMMENDED IN THE APPROVED SOLS ENGINEERING OR ENCINEERING DEOLOGY REPORT, GRADING ACTIVITIES SHALL CONFORM TO THE PROVISIONS OF THIS SECTION
- A CUI SLOPE. HE SLOPE OF OUT SUPLACES SHALL DE NO SIEDER THAN IS SAFT FOR THE MYSTERS HE PERMITTER PARKNESS A SOLS DISCHMERING OR AN ENDREDHE SHA ON STALLE WE NO STEATER HAN IN NOT STATEMENT OF A UNIT SHEPPICHAL (SOLS 2,00°F) DINESS HE PERMITTER PARKNESS A SOLS DISCHMERING OR AN ENDRETHING DECOLOT REPORT, OR BOTH, STATING THAT HE SIT HAS SEEN INVESTIGATED AND GYING AN OPRION HAIT A CUIT AT A STEEPER SLOPE WILL BE STARLE AND INCLUSATE A HAZANO DISCHMERING OF AN ENDRESHE SHAPE WILL BE STARLE AND INCLUSATE A HAZANO DISCHMERING THE DISCHMERING OF AN ENDRESHE A STATE A HAZANO DISCHMERING DISC
- B. FILL SLOPE AND PREPARATION
- (1) PREPARATION OF GROUND, THE GROUND SURFACE SHALL BE PREPARED TO RECEIVE FILL BY REMOVING VEGETATION, NON-COMPLYING FIL, TOPSOIL AND OTHER UNSUITABLE MATERIALS SCARFYING TO PROVIDE A BOND WITH THE NEW FILL.
- (2) FEL MATERIAL AMOUNT OF ORGANIC MATERIAL DETRIBENTAL TO STRUCTURAL.
 INTEGRITY SHALL NOT BE PERMITTED IN PILLS, EXCEPT AS PERMITTED BY THE BULDING OFFICIAL, NO ROCK OR SHELAR IRREDUCIBLE MATERIAL WITH A MAXIMUM. DIMENSION GREATER THAN 12 INCHES (0.31 M) SHALL BE BURIED OR PLACED IN FILLS.
- (3) EXCEPTION, THE BUILDING OFFICIAL MAY PERMIT PLACEMENT OF LARGER ROCK MICH. THE SOLIS DIMARCEL PROPERTY DEVIALS A METHOD OF PLACEMENT, AND CONTINUOUSLY INSPECTS ITS PLACEMENT AND APPROVES THE FILL STABILITY. THE FOLLOWING CONTINUOUSLY MAY PROVE.
- (a) PRICE TO ISSUANCE OF THE CRADING PERMIT, POTENTIAL ROCK DISPOSAL
- AREAS SHALL BE SHOWN ON THE GRADING PLAN.
- (b) ROCK SZES GREATER THAN 12 INCHES (0.31 M) IN MAZBAUM DIMENSION SHALL BE 10 FEET (3.05 M) OR MORE BELOW GRADE, MEASURED VERTICALLY.
- (c) ROCKS SHALL BE PLACED SO AS TO ASSURE FILLING OF ALL VOIDS WITH WELL-GRADED SOIL.
- (4) COMPACTION, ALL FILLS SHALL BE COMPACTED TO A MINIAUM OF 90 PERCENT OF MAXIMUM DRY DENSITY WITH SUFFICIENT TESTING FOR DOCUMENTATION OF COMPLIANCE WITH THIS STANDARD.
- (5) SLOPE THE SLOPE OF FILL SUPFACES SHALL BE NO STEEPER THAN IS SAFE FOR THE INTERCED USE. FILL SLOPES SHALL BE NO STEEPER THAN 1 UNIT VERTICAL IN 2 UNITS HORIZONTAL (SOIL SLOPE).

- O. GENERAL CUT AND TILL SLOPES SHALL BE SET BACK FROM SITE BOUNDARIES IN
- b. ACCORDANCE WITH THIS SECTION, SETBACK DIMENSIONS SHALL BE HORIZONTAL DISTANCES MEASURED PERPENDICULAR TO THE SITE BOUNDARY
- c. TOP OF OUT SLOPE, THE TOP OF OUT SLOPES SHALL HOT BE MADE HEARER TO A SITE
- BOUNDARY LINE THAN A MINIMUM OF 2 FEET, THE SETBACK WAY NEED TO BE INCREASED FOR ANY REQUIRED INTERCEPTOR DRAINS.
- d. TOE OF FILL SLOPE, THE TOE OF FILL SLOPE SHALL BE WADE NOT NEARER TO THE SITE BOXDORY USE, THAN WINNIAM OF 2 FIRT, WHORE A FILL SLOPE IS TO BE LOCATIO MEAN THE SITE BOUNDARY AND THE ADJACENT OFFSITE PROPERTY IS DEVELOPED, SPECIAL PECULIATIONS SHALL BE RECORPORATED IN THE WOOK AS THOSE MOUSTAIN DEVELOPED TO ROUTED THE ADJANING PROPERTY FROM DAMACE AS A RESIZET OF SUCH CRADING, THESE PRICAUTIONS MAY INCLUDE BUT ARE NOT LIMITED TO.
- (2) PROVISION FOR RETAINING, OR SLOUGH WALLS.
- (3) MECHANICAL OR CHEMICAL TREATMENT OF THE FILL SLOPE SURFACE TO MINIMIZE EROSION.
- (4) PROVISIONS FOR THE CONTROL OF SURFACE WATERS.

MODIFICATION OF SETBACKS. THE BULDING OFFICIAL MAY APPROVE ALTERNATE SETBACKS HE BULDING OFFICIAL MAY EXCURRED INVESTIGATION AND RECOMMENDATION BY A QUALETED INVESTIGAT SURREPURS (DELOOSS) TO DEMONSTRATE THAT THE INTENT OF THIS SECTION HAS BEEN SATISFED.

- 3. MAINTENANCE REQUIRED, THE PROPERTY OWNER SHALL BE RESPONSIBLE FOR ADEQUATELY MAINTAINING ALL DRAINAGE FACULTES INSTALLED PURSUANT TO THIS SECTION.
- A. GENERAL GRADING OPERATIONS FOR WHICH A PERVIT IS REQUIRED SHALL BE SUBJECT TO INSPECTION BY THE BUILDING OFFICIAL
- A CRUTAL CRUMO OPERATIONS FOR MIDD A PERMIT IS REQUIRED SHALL BE SIJECT TO INSPECTION BY THE BILLION CITICAL.

 PERMITTEL THE PERMITTE SHALL BE RESPONSED FOR THE WORK TO REPERMINED IN ACCORDING THIN THE APPROVED PLACE AND SECONDATIONS AND IN CORPORATION THE PROVINCE PROFESSIONAL RESPONSED AND THE CONTROL OF THE PERMIT OF THE PROVINCE PROFESSIONAL RESPONSED AND THE SHALL PLACE ACCORDINATION REPERMINED SHALL CHARGE CONSILIENTS, RECONTROL AND THE CHARGE AND THE CHARGE CONSILIENTS, RECONTROL AND THE CHARGE AND THE CHARGE CONSILIENTS, RECONTROL AND THE CHARGE AND THE PROVINCE PROFESSIONAL PROFESSIONAL

- EROSIGN AND SEDIMENTATION CONTROL
- - (1) THE EROSION AND SEDMENT CONTROL PROMISIONS OF THIS SECTION SHALL DE APPLICABLE TO ALL FACILITIES AND ACTIVATICS UNDER THE SUPERMISION OF THE DEPARTMENT OF PUBLIC WORKS.
 - (2) THE ADMINISTRATION OF THIS SECTION, AS IT AFFECTS COUNTY FACILITIES AND ACTIVITIES, IS THE RESPONSIBILITY OF THE DIRECTOR OF THE DEPARTMENT OF PUBLIC MODING.
- STANDARD FOR THE SECTION AS IT AFTERS OTHER BUILDING, GRADING, MO BEARTD ACTIVITIES IS THE RESPONSEDLITY OF THE DIED BUILDING OFFICIAL.

 (A) MY GOSS OF REDCOGE REPORTS PREPARED FOR MY PROCESS WHEN A DEVISION FROM THE STANDARD FOR MY PROCESS OF THE CHEET BUILDING OFFICIAL.

 (B) RELATED ENVIRONMENTLY, DOZUMENT, SHALL BE PLACED IN THE RECORDS OF THE CHEET BUILDING OFFICIAL.

 (B) RECORD AND SEMENATION CONTROL. THESE WHENIAM RESISON AND SEMENATIONAL CONTROL. STANDARDS SHALL APPLY TO ALL PROJECTS REQUIRED BUILDING,

 GRADING, AND DEVILLATIONS CONTROL THESE WHENIAM RESISON AND SEMENATIONS CONTROL STRANDARD SHALL APPLY TO ALL PROJECTS REQUIRED BUILDING,

 GRADING, AND DEVILLATIONS OF SHALL BE INCOPROGRATION TO THE PROCESS THE SEMENATION OF DUMANGE TO ONSITE AND OFFSITE

 REPORTER. THESE STANDARDS SHALL BE RECORDED AND THE PROCESS THE SEMENATION TO DEPARE PROCESS THE CONTROL THE AND OFFSITE. (1) CENERAL CUIDELINES
- (a) NUMBER SOIL EXPOSURE DURING THE RAINY SEASON BY PROPER THING OF GRADING AND CONSTRUCTION.
 - (b) RETAIN TREES AND NATURAL VEGETATION TO STABILIZE HELISIDES, RETAIN MOISTURE, REDUCE EROSION, WINNVIZE SUTATION AND INJURIENT RUNOFF AND PRESERVE SCENC COLUMNES.
 - (c) VECETATE AND MULCH DENUDED AREAS TO PROTECT THEM FROM WINTER RAINS.
 - (d) DIVERT RUNOFF AWAY FROM STEEP, DEMODED SLOPES OR OTHER CRITICAL AREAS WITH BARRIERS, BERWS, DITCHES OR OTHER FACULTES.
 - (e) LIMIT CONSTRUCTION, CLEARING OF VECETATION AND DISTURBANCE OF THE SUIL TO AREAS OF PROVEN STABILITY. IMPRGATE GEOLOGIC HAZARDS AND ADVERSE SOIL CONDITIONS WIED THEY ARE ENCOUNTERED.
 - (f) REDUCE SEDMENT TRANSPORT OF THE SITE TO THE MAXIMUM EXTENT FEASBLE THROUGH THE USE OF BEST MANAGEMENT PRACTICES (BMPS).

- (c) PROPOSE A NEW OR MODIFIED EROSON AND SEDAMENT CONTROL TECHNIQUE IF THE TECHNIQUE IS PREFERRED AND MEETS THE INTENT OF THESE RECULATIONS.
 OSTAIN APPROVAL FROM THE COUNTY PROR TO IMPLEMENTATION.
- (h) CONDUCT FREQUENT SITE INSPECTIONS TO ENSURE THAT CONTROL MEASURES ARE WORKING PROPERLY AND TO CORRECT PROBLEMS AS MEDED
- (1) EMPLOY OTHER MEANS OF EROSION AND SEDIMENT CONTROL AS REQUIRED BY THE CHIEF BUILDING OFFICIAL OR DIRECTOR OF THE DEPARTMENT OF PUBLIC WORKS AS APPLICABLE.
- (c) USE SEDIMENT BASINS, SILT TRAPS, OR SINEAR MEASURE TO RETAIN SEDIMENT TRANSPORTED BY RUNGET WATER CHISTE.
- (b) COLLECT AND DRECT SURFACE RUNOFF AT NON-ERDSIVE VELOCITIES TO THE COMMON NATURAL WATERCOURSE OF THE DRAINAGE AREA.
- (c) AVOID CONCENTRATING SURFACE WATER ANYMHERE EXCEPT SWALES OR WATERCOURSES.
- (c) PREVENT MUD FROM BEING TRACKED ONTO THE PUBLIC ROADWAY BY TRAVELING OVER A TEMPORARY CRAVEL CONSTRUCTION ENTRANCE OR WASHING OFF VENICLE TIRES BEFORE ENTERING A PUBLIC OR PROVATE DRIVEWAY.

(3) SLOPE CONSTRUCTION

(2) SEDBMENT CONTROL

- (a) WINIMIZE LENGTH AND STEEPHESS OF SLOPES BY BENCHING, TERRACING OR CONSTRUCTING DIVERSION STRUCTURES.
- (b) PRESERVE, MATCH, OR BLEND CLITS AND FILLS WITH THE HATURAL CONTOURS AND UNDULATIONS OF THE LAND.
- (c) ROUND SHARP ANGLES AT THE TOP AND SIDES OF CUT AND FILL SLOPES.
- (c) MAINTAIN CUT AND FILL SLOPES AT LESS THAN TWO-TO-ONE (2:1, RIN-RISE) SLOPE URLESS A CEOLOGICAL AND ENGINEERING ANALYSIS INDICATES THAT STEEPER SLOPES ARE SATE AND EROSION AND SEDMENT CONTROL MEASURES CAN SUCCESSIVELY PREVENT EROSION.

(4) PROTECTION OF WATERCOURSES AND DRAINAGE INLETS

- (c) PREPARE DRAINACEWAYS TO HANGLE CONCENTRATED OR INCREASED RUNCEF FROM DISTURBED AREAS BY USING APPROPRIATE LINING MATERIALS OR ENERGY AUSORBING DEVICES TO REDUCE THE VELOCITY OF RUNCET WATER.
- (b) TRAP SCHMINT-LADDA RUNDET IN BASHS TO ALLOW SOIL PARTICLES TO SETTLE OUT RETORE FLORS ARE RELEASED TO RECEIVING WATERS, STORM DRAMS, STREETS OR ADMICHT PROPERTY. THIS STANDARD IS NOT MANDATORY FOR GRADING. THE SITE OF FULLY WINTERZED AND STANDLED PROOK TO AND MICH. CONDUCTED RETWEEN APPLIES AND OCTOBER IS OCTOBER IS, REMOVE TRAPPED SEDMENT TO A SATARLE LOCATION ON-SITE OR AT A DISPOSAL STE APPROVED BY THE CONITY.
- (c) DO NOT GRADE OR DRIVE EQUIPMENT IN A STREAMSIDE MANAGEMENT OR OTHER WET AREAS EXCEPT AS ALLDRED THROUGH THE COUNTY STREAMSIDE MANAGEMENT AREA ORDINANCE.
- (d) DEPOSIT OR STORE EXCAVATED MATERIALS AWAY FROM WATERCOURSES.
- (e) PROTECT ALL EXISTING OR NEWLY INSTALLED STORM DRAINAGE STRUCTURES FROM SEDIMENT CLOGGING.
- (1) (F) USE STRAW BALES, FILTER FABRIC WRAPS AND DRAMACE INLET PROTECTIONS IN A MANNER THAT DOES NOT CAUSE ADDITIONAL EROSION OR FLOCOING OF A ROADWAY.

(5) DISPOSAL OF EXCAVATED MATERIALS


- (c) STOCKPILE TOPSOIL ON THE SITE FOR USE ON AREAS TO BE REVEGETATED.
- (b) PLACE STOCKPILED SOIL IN LOCATIONS, SO THAT IF EROSION OCCURS, IT WILL NOT CONTRIBUTE TO OFFSITE SEDIMENT DISCHARGE.
- (c) PROTECT STOCKPIED SOL PROMPTLY THROUGH THE USE OF APPROPRIATE BUPS TO REDUCE THE RISK OF EROSION AND SEDWENT TRANSPORT. APPLY MULCH OR OTHER PROTECTIVE CONFIRMS ON STOCKPLED MATERIAL THAT WILL BE EDIOSED THROUGH THE WATER SEASON.
- (c) DISPOSE OF EXCAVATED MATERIAL NOT USED AT THE SITE AT A LOCATION APPROVED BY THE COUNTY.

(6) DUST CONTROL

- (e) ALL CONSTRUCTION AREAS, INCLIDING DISPOSAL SITES, SHALL BE TREATED AND MAINTAINED AS NECESSARY TO MINIMIZE THE EMISSION OF DUST, MAINTENANCE SHALL BE CONDUCTED AS NECESSARY TO PREVENT A MUSANCE TO DITISTE PROPERTIES.
- (b) ALL CONSTRUCTION SITES, INCLUDING DRIVEWAYS, SHALL BE MAINTAINED AS NECESSARY TO MINIMIZE THE EMISSION OF DUST AND PREYENT THE CREATION OF A MUSEANCE TO ADJACENT PROPERTIES.

(7) REVEGETATION

- (c) APPLY TEMPORARY SEEDING AND MULCHING TO DENUDED AREAS PRIOR TO OCTOBER 15 UNLESS THE PROJECT IS CONDITIONED OTHERWISE
- (b) ESTABLISH A PERMANENT VEGETATIVE COVER ON DENUGED AREAS NOT DITHERMISE STABILIZED, PERMANENT VEGETATION GROUND COVER MUST CONTROL SOIL EROSION SATISFACTORILY AND SURVIVE SEVERE WEATHER CONDITIONS.
- (c) RETAIN A VECETATIVE BARRIER WHENEVER POSSIBLE AROUND PROPERTY BOUNDARIES.
- (d) USE SELF-SUSTAINING, NON-INVASIVE PLANTS THAT REQUIRE LITTLE OR NO MAINTENANCE AND DO NOT CREATE AN EXTREME FIRE HAZARD.
- (e) USE NATIVE PLANT SPECIES WHENEVER FEASIBLE.

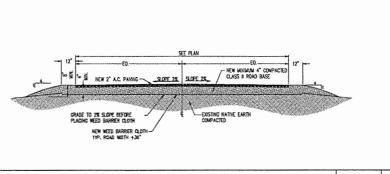

PROPRIETARY INFORMATION

THE INFORMATION CONTAINED IN THIS SET OF DRAVINGS IS PROPRIETARY
BY NATURE. ANY USE OR
DISCLOSURE OTHER THAN THAT WHICH
RELATES TO PEEK SITE-COM IS
STRICTLY PROHIBITED

CLIENT:



5001 EXECUTIVE PKWY SAN RAMON, CA 94583

FROJECT INFORMATION:

ZEE ESTATES

CATE LANE 1,000' SOUTH EAST OF THE INTERSECTION OF GATE LANE AND SALVEN FALLS ROAD PLOT HIL, CA 95884

1	62917	90% ZONING DOC'S	RB
1	8-3-17	90% ZONING DOC'S	ALP
2	B-9-17	100% ZONING DOC'S	ALP
_			
II			
			1

COORDINATING ENGINEER: ---

Peek Site-Com 12852 Eorhart Ave. Suite 101 Auburn, California 95602 Phone (530) 885-6160

E-Mail info@peeksitecom.com




CVL03629 SHEET TITLE: = GRADING NOTES & DETAILS

SHEET NUMBER

DRAWS BY: =

TYP. A/C ROAD SECTION

SCALE: N.T.S.

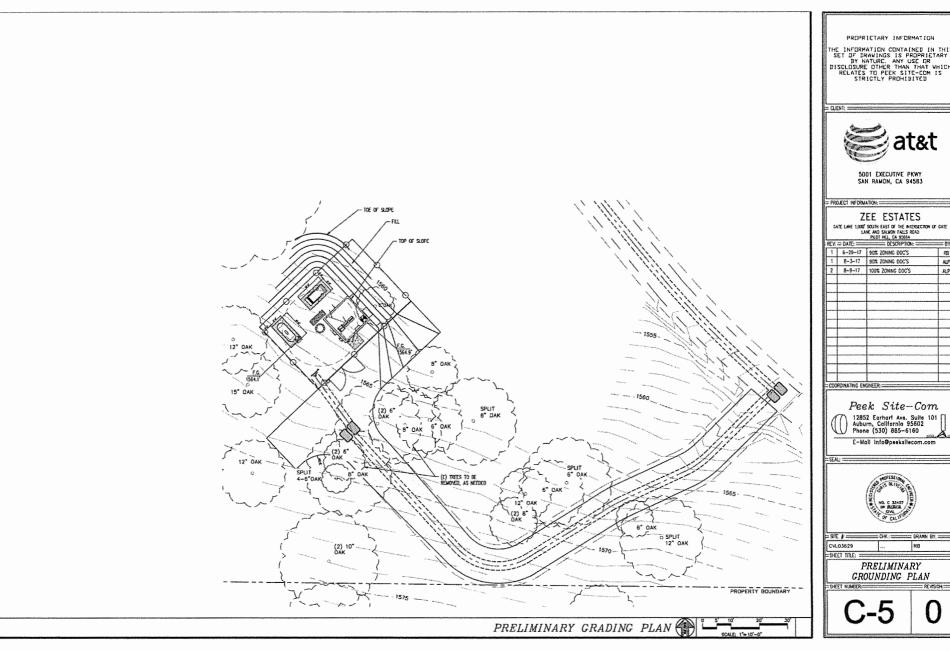

THE INFORMATION CONTAINED IN THIS SET OF DRAWINGS IS PROPRIETABY BY NATURE. ANY USE OR DISCLOSURE OTHER THAN THAT WHICH RELATES TO PECK SITE-COM IS STRICTLY PROHIBITED



5001 EXECUTIVE PKWY SAN RAMON, CA 945B3

L		PLOT HLL, CA 95664	
REV:	= DATE: ===	DESCRIPTION:	B
1	6-29-17	90% ZONING DOC'S	FEE
1	8-3-17	90% ZONING DOC'S	AU
2	8-9-17	100% ZONING DOC'S	AU
-			
			1
			_

Peek Site-Com


12852 Earhart Ave. Suite 101 Auburn, California 95502 Phone (530) 885-6160


E-Mail Info@peeksitecom.com



RB

PRELIMINARY GROUNDING PLAN

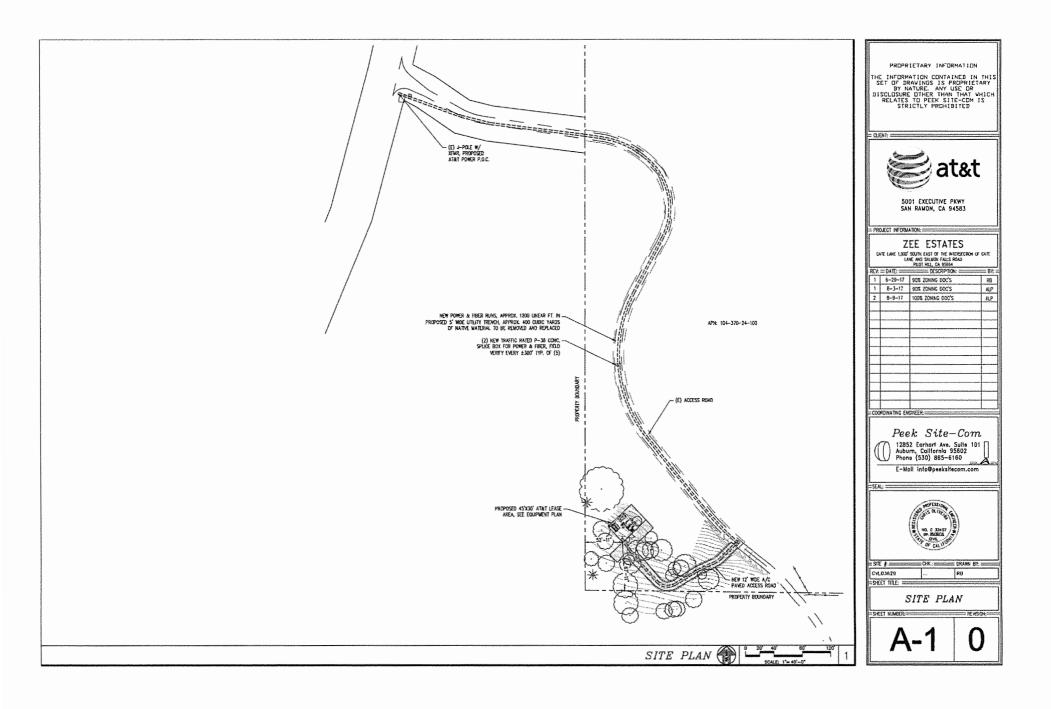

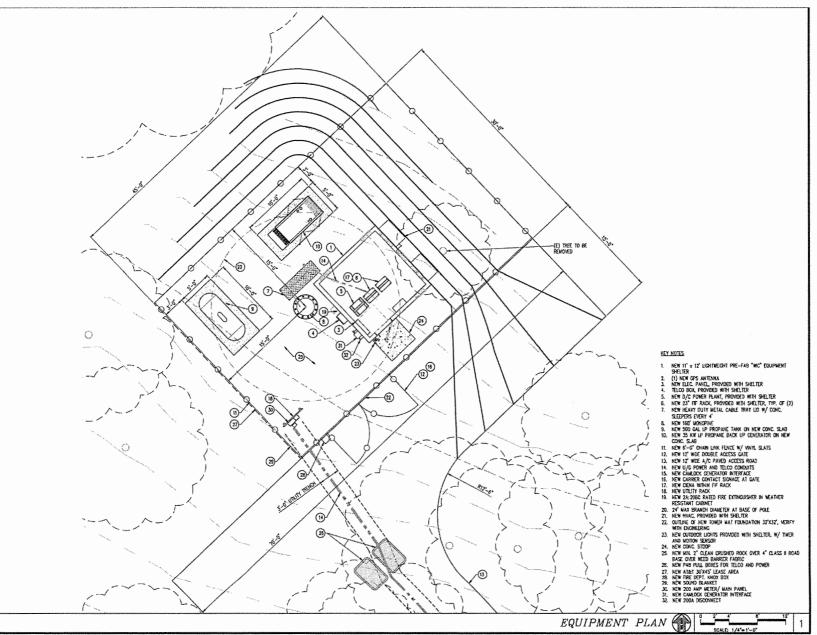

PROPRIETARY INFORMATION

THE INFORMATION CONTAINED IN THIS
SET OF DRAWINGS IS PROPRIETARY
BY NATURE. ANY USE OR
DISCLOSURE OTHER THAN THAT WHICH
RELATES TO PEEK SITE-COM IS
STRICTLY PROHIBITED

CLIENT:



5001 EXECUTIVE PKWY SAN RAMON, CA 94583

PROJECT INFORMATION:

ZEE ESTATES

CATE LANE 1,000' SOUTH EAST OF THE BITERSECTION OF GATE
LANE AND SALMON FALLS ROAD
THE OF THE PARTY OF THE PA

L		PROT REE, CA 93694	
REV:	= DATE: ====	DESCRIPTION:	= BY: :
1	6-29-17	90% ZONING DOC'S	RE
1	8-3-17	90% ZONING DOC'S	ALP
2	8-9-17	100% ZOHING DOC'S	ALP
= 000	RDINATING EN	GNEER:	


Peek Site-Com


12852 Earhart Ave. Suite 101 Auburn, California 95602 Phone (530) 885-6160

E-Mail Info@peeksitecom.com

STE R DRAWN BY: CVL03529 RS SHEET TITLE:

EQUIPMENT PLAN

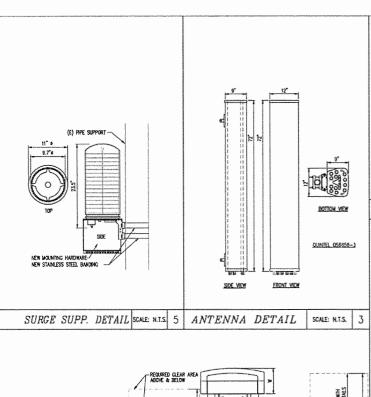

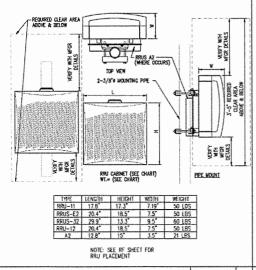

RRU DETAIL

SCALE: N.T.S.

4

RF SCHEDULE

SECTOR/POS.	ANTENNA NICOEL	RAD CENTER	PHYSICAL AZIMUTH	RRU	TMA	FIBER LENGTH	COAX LENGTH	COAX DIA.	NO.
A/1	CS6656-3	± 150°	90"	(1) RRUS-11 & (1) RRUS-32 B2	N/A	± 220'	t N/A	N/A	-
A/2	Q56656-3	± 150°	90"	(1) RRUS-12 & (1) RRUS-32 866	H/A	± 220°	± N/A	N/A	-
A/3	QS6656~3	± 140"	60.	(1) RRUS-11	N/A	± 210°	± N/A	N/A	-
A/4	058656-3	± 140°	90"	(1) RRUS-32 830	H/A	± 210'	± N/A	N/A	-
8/1	C28656~3	± 150°	330	(1) RRUS-11 & (1) RRUS-32 B2	H/A	± 220'	± N/A	N/A	-
B/2	058656~3	± 150°	770.	(1) RRUS-11, (1) RRUS-12 & (1) RRUS-32 B66	N/A	± 220°	± N/A	N/A	-
E/3	QS6656~3	± 140°	330.	(1) RRUS-32 B30	N/A	± 210°	± N/A	N/A	-
B/4	0\$6656-3	± 140'	330.	(1) RRUS-32 830	N/A	± 210'	± N/A	N/A	-
C/1	2S8656-J	± 150°	210"	(1) RRUS-11 & (1) RRUS-32 82	N/A	± 220°	± N/A	N/A	-
C/2	0\$8856-3	± 150°	210	(1) RRUS-11, (1) RRUS-12 & (1) RRUS-32 B65	N/A	± 220'	± H/A	N/A	-
C/3	QS6656-3	± 140°	210"	(1) RRUS-32 B30	N/A	± 210°	± 14/A	N/A	-
C/4	058656-3	± 140°	210"	(1) RRUS-32 B30	N/A	± 210°	± N/A	N/A	-

RF SCHEDULE

SCALE: N.T.S.

NEW ANTENNA SECTION A NEW ANTENNA

SCALE: 3/8"=1'-0"


PROPRIETARY INFORMATION THE INFORMATION CONTAINED IN THIS
SET OF DRAWINGS IS PROPRIETARY
BY NATURE. ANY USE OR
DISCLOSURE OTHER THAN THAT WHICH
RELATES TO PEEK SITE-COM IS
STRICTLY PROHIBITED 5001 EXECUTIVE PKWY SAN RAMON, CA 94583 PROJECT INFORMATION; ZEE ESTATES CATE LANE 1,000" SOUTH EAST OF THE INTERSECTION OF GATE LANE AND SALMON FALLS ROAD PLOT NUL. CA 93964 DESCRIPTION: 1 6-29-17 90% ZONING DOC'S Rß 1 8-3-17 90% ZONING DOC'S ALP 2 8-9-17 100% ZONING DOC'S ALP Peek Site-Com 12852 Earhart Ave. Suite 101 Auburn, Colifornia 95602 Phone (530) 885-6160 E-Mail info@peeksitecom.com SEAL: STE A STE DRAWN BY: = CVL03629 SHEET TITLE: = ANTENNA PLAN & **DETAILS**

OUTLINE OF 6' MONOPINE BRANCHES SECTOR B NEW CROSSOVER PLATE KIT. - NEW ANTENNA SITE-PRO MODEL # SP216 OR EQUAL, TYP. OF (3) - NEW RRUS-11 NEW 24" SUPPORT ARM, TYP. OF (3), SITE-PRO MODEL SY197-24 OR EQUAL NEW ANTENNA **HEW ANTENNA** NEW 3-1/2"4X7" LONG SCH. 40 HEW RRUS-12 HEW UNIVERSAL RING MOUNT SITE-PRO MODEL # LWRW OR EQUAL (2) FUTURE 4'# -SECTION A M/W DISHES AZ=90* ¢γ MEW ANTONNA NEW ANTENNA-- New Crossover Plate Kit, Site-Pro Model # SP219 Or Equal, Typ. of (6) SECTOR C C/2 NEW RRUS-12 - NEW RRUS-11 -NEW ANTENNA - NEW ANTENNA - NEW RRUS-32 - OUTLINE OF 6' MONOPINE BRANCHES RAD CENTER ± 150' CUTLINE OF 6' MONOPINE BRANCHES - NEW SURGE SUPPRESSOR STANDOFF ARM, SITE PRO-MODEL / MNOZ, TYP. OF (4) NEW ANTENNA -NEW RRUS-32 - NEW RRUS-32 NEW RRUS-32 -NEW RRUS-12 NEW MONOPOLE

3-SECTOR T-ARM KIT,
SITE PRO MODEL/
RNV5-272 OR EQUAL

NEW RRUS-32-BACK TO BACK PIPE MOUNT KIT, SITE PRO MODEL # BBPM-KI, TYP. OF (4) RRU PIPE, SITE PRO MODEL P263, TYP. OF (12) -- NEW TRUS-32 QUAD UNIVERSAL RING HOUNT, SITE PRO MODEL # U084 NEW RRUS-32 NEW D/C POWER - NEW RRUS-11 & FIBER TRUNKS - NEW SURGE SUPPRESSOR SECTION C RAD CONTER & 140'

ANTENNA PLAN

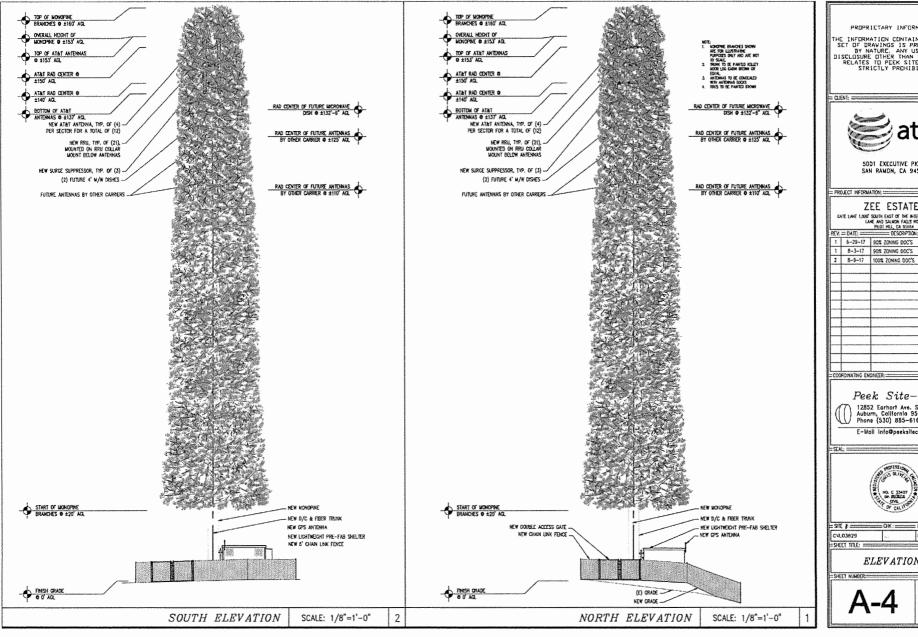

PROPRIETARY INFORMATION

THE INFORMATION CONTAINED IN THIS SET OF DRAWINGS IS PROPRIETARY BY NATURE. ANY USE OR DISCLOSURE OTHER THAN THAT WHICH RELATES TO PEEK SITE-COM IS STRICTLY PROHIBITED



5001 EXECUTIVE PKWY SAN RAMON, CA 94583

ZEE ESTATES

GATE LANE 1,000" SOUTH EAST OF THE INTERSECTION OF GATE
LANE AND SALVEN FALLS ROAD

łL		PLO1 HU, CA 95654	
REV.	= DATE: ===	DESCRIPTION:	BY
1	6-29-17	90% ZONING DOC'S	RS
1	8-3-17	90% ZONING DOC'S	ALF
2	8-9-17	100% ZONING DOC'S	ALP


Peek Site-Com

12852 Earhort Ave. Suite 101 Auburn, California 95602 Phone (530) 885-6160

E-Mail Info@peeksitecom.com



ELEVATIONS

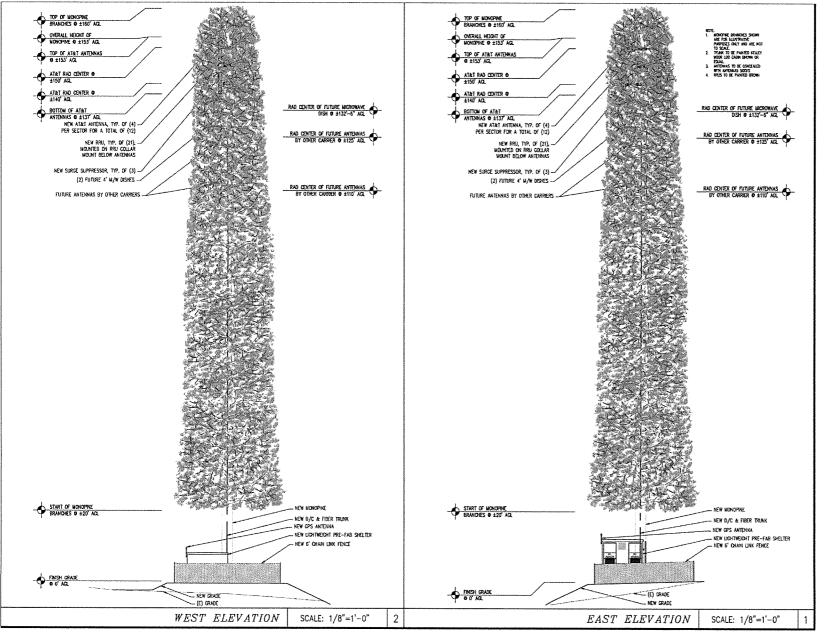

PROPRIETARY INFORMATION

THE INFORMATION CONTAINED IN THIS SET OF DRAWINGS IS PROPRIETARY BY NATURE, ANY USE OR DISCLOSURE OTHER THAN THAT WHICH RELATES TO PECK SITE-COM IS STRICTLY PROHIBITED



5001 EXECUTIVE PKWY SAN RAMON, CA 94583

PROJECT INFORMATION:

ZEE ESTATES GATE LANE 1,000" SOUTH EAST OF THE INTERSECTION OF GATE
LANE AND SALVON FALLS ROAD

		PLOT HEL, CA 95664	
REV.	= DATE; ===	DESCRIPTION:	BY:
1	62917	90% ZONING DOC'S	RB
1	8-3-17	90% ZONING DOC'S	ALP
2	8-9-17	100% ZONING DOC'S	ALP
		ļ	
]	

COORDINATING ENGINEER:

Peek Site-Com 12852 Earhart Ave. Suite 101 Auburn, California 95602 Phone (530) 885-6160


E-Mail Info@peeksitecom.com

CHK,: DRAWN BY: CVL03629 RB SHEFT TIME:

ELEVATIONS

APPROVED EL DORADO GOUNTY



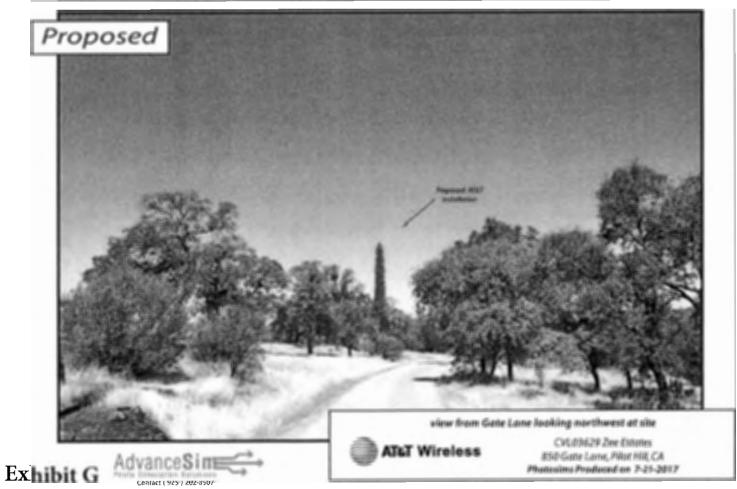

Site 6 Zee Estates







Advance\$im= Contact (925) 202-8507

AT&T Wireless

85/D Gatte Larre, Pilist Hill, CA Photosims Produced on 7-21-2017

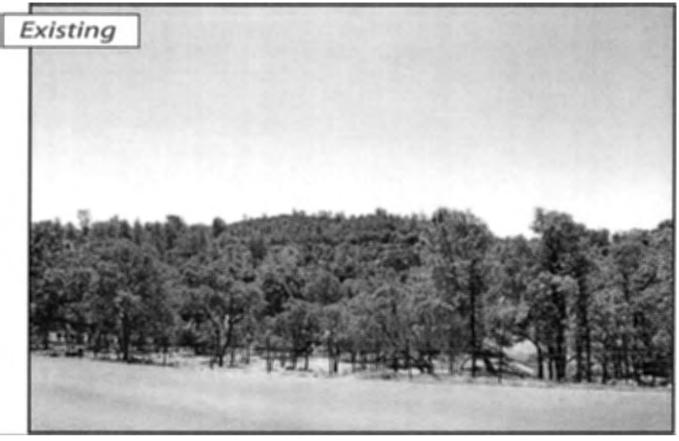

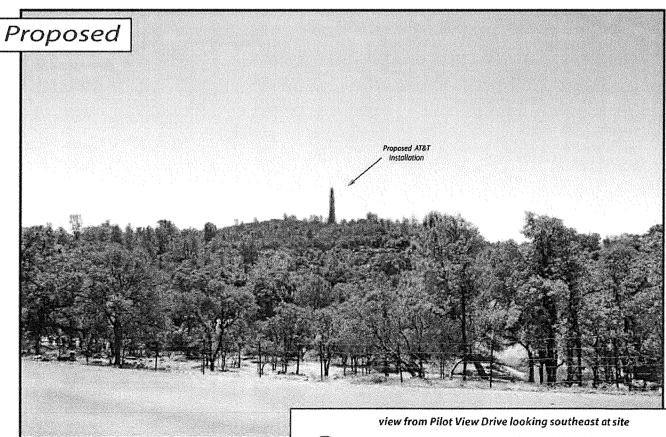

AdvanceSimple Simulation Solutions
Contact (925) 202-8507

AT&T Wireless

CVL03629 Zee Estates 850 Gate Lane, Pilot Hill, CA Photosims Produced on 7-21-2017







Contact (925) 202-8507


ATLT Wireless

850 Gate Lana, Filse Hill, CA Photosims Produced on 7-25-2017

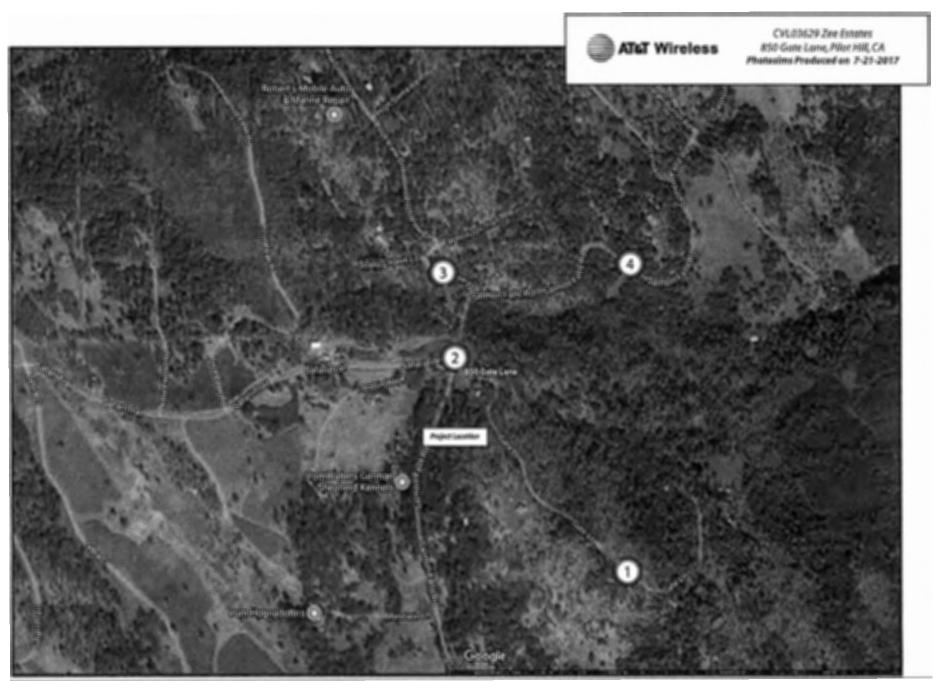


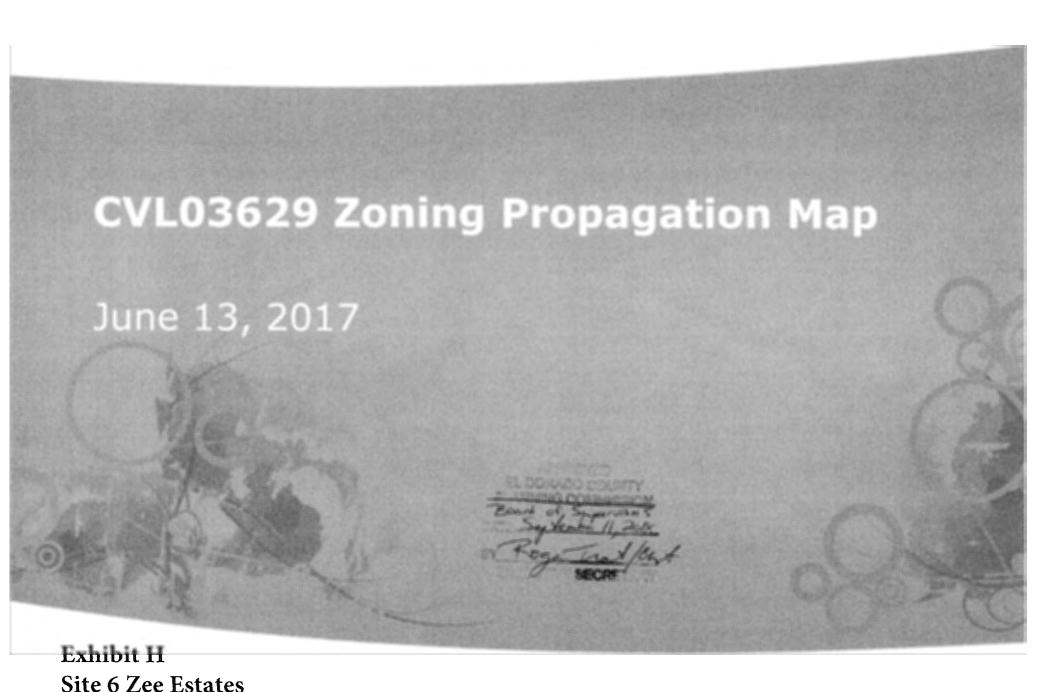

EXISTING LTE 700 Coverage (RC = 150')

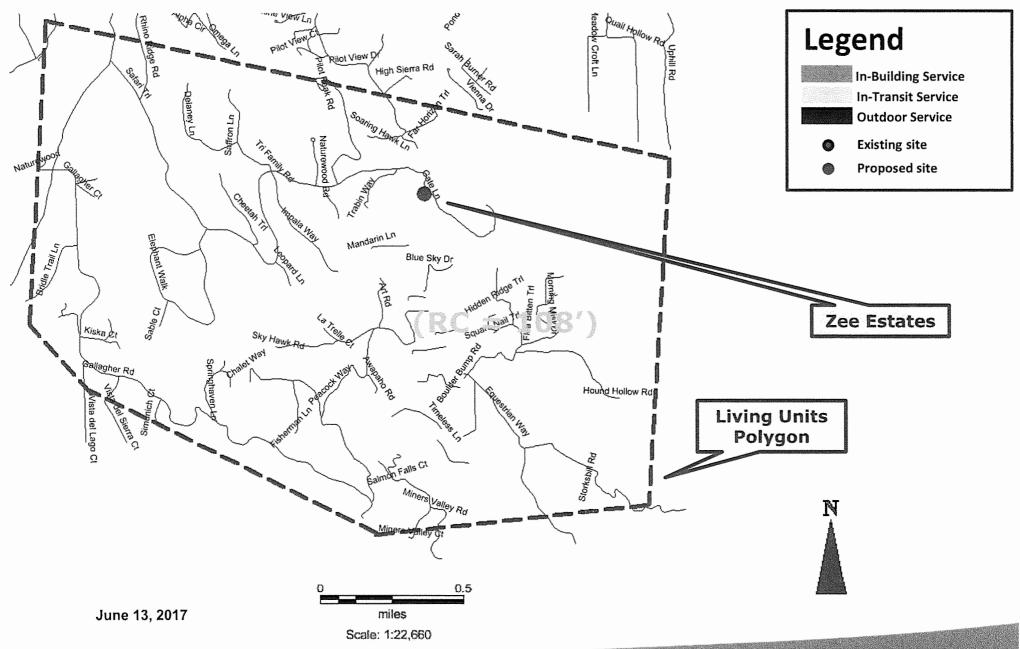

PROPOSED LTE 700 Coverage (RC = 150')

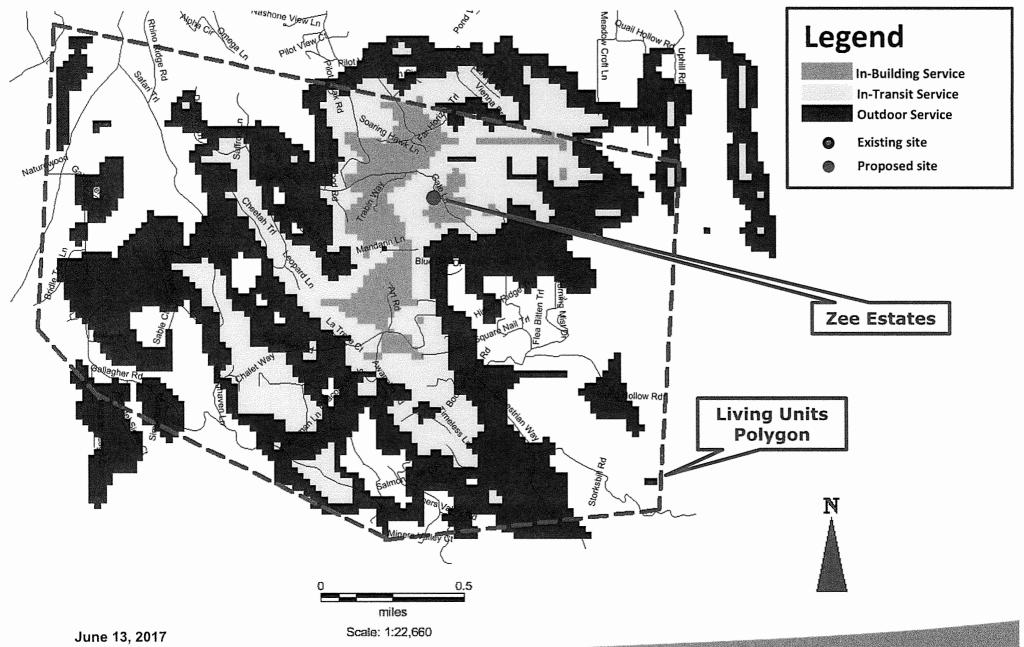





Radio Frequency Emissions Compliance Report For AT&T

Site Name:

Zee Estates

Site Structure Type: Monopine

Address:

Gate Lane 1.000' South East of the

Latitude:

38.810023

intersection of Gate Lane and

Salmon Falls Road

Pilot Hill, CA

Longitude:

-121.020325

Report Date: July 17, 2017

Project:

New Build

General Summary

AT&T Mobility has contracted Waterford Consultants, LLC to conduct a Radio Frequency Electromagnetic Compliance assessment of the proposed Zee Estates site located at Gate Lane 1,000' South East of the intersection of Gate Lane and Salmon Falls Road, Pilot Hill, CA. This report contains information about the radio telecommunications equipment to be installed at this site and the surrounding environment with regard to RF Hazard compliance. This assessment is based on installation designs and operational parameters provided by AT&T Mobility.

The compliance framework is derived from the Federal Communications Commission (FCC) Rules and Regulations for preventing human exposure in excess of the applicable Maximum Permissible Exposure ("MPE") limits. At any location at this site, the power density resulting from each transmitter may be expressed as a percentage of the frequency-specific limits and added to determine if 100% of the exposure limit has been exceeded. The FCC Rules define two tiers of permissible exposure differentiated by the situation in which the exposure takes place and/or the status of the individuals who are subject to exposure. General Population / Uncontrolled exposure limits apply to those situations in which persons may not be aware of the presence of electromagnetic energy, where exposure is not employment-related, or where persons cannot exercise control over their exposure. Occupational / Controlled exposure limits apply to situations in which persons are exposed as a consequence of their employment, have been made fully aware of the potential for exposure, and can exercise control over their exposure.

	Limits for General Populat	ion/ Uncontrolled Exposure	Limits for Occupational	l/ Controlled Exposure
Frequency (MHz)	Power Density (mW/cm²)	Averaging Time (minutes)	Power Density (mW/cm²)	Averaging Time (minutes)
30-300	0.2	30	1	6
300-1500	f/1500	30	f/300	6
1500-100,000	1.0	30	5.0	6

f=Frequency (MHz)

In situations where the predicted MPE exceeds the General Population threshold in an accessible area as a result of emissions from multiple transmitters, FCC licensees that contribute greater than 5% of the aggregate MPE share responsibility for mitigation.

Based on the computational guidelines set forth in FCC OET Bulletin 65, Waterford Consultants, LLC has developed software to predict the overall Maximum Permissible Exposure possible at any particular location given the spatial orientation and operating parameters of multiple RF sources. These theoretical results represent worst-case predictions as emitters are assumed to be operating at 100% duty cycle.

Exhibit I Site 6 Zee Estates

For any area in excess of 100% General Population MPE, access controls with appropriate RF alerting signage must be put in place and maintained to restrict access to authorized personnel. Signage must be posted to be visible upon approach from any direction to provide notification of potential conditions within these areas. Subject to other site security requirements, occupational personnel should be trained in RF safety and equipped with personal protective equipment (e.g. RF personal monitor) designed for safe work in the vicinity of RF emitters. Controls such as physical barriers to entry imposed by locked doors, hatches and ladders or other access control mechanisms may be supplemented by alarms that alert the individual and notify site management of a breach in access control. Waterford Consultants, LLC recommends that any work activity in these designated areas or in front of any transmitting antennas be coordinated with all wireless tenants.

Analysis

AT&T Mobility proposes the following installation at this location:

- Install twelve (12) new panel antennas
- Install six (6) new RRUS-11, three (3) RRUS-12, twelve (12) RRUS-32

The antennas will be mounted on a 160-foot Monopine with centerlines at 150 and 140 feet above ground level. The antennas will be oriented toward 90, 330 and 210 degrees. The Effective Radiated Power (ERP) in any direction from all AT&T Mobility operations will not exceed 26,556 Watts. Other appurtenances such as RRUs and hybrid cable are not sources of RF emissions. From this site, AT&T Mobility will enhance voice and data services to surrounding areas in licensed 700, 850, 1900, 2100 and 2300 MHz bands. No other antennas are known to be operating in the vicinity of this site.

Power density decreases significantly with distance from any antenna. The panel-type antennas to be employed at this site are highly directional by design and the orientation in azimuth and mounting elevation, as documented, serve to reduce the potential to exceed MPE limits at any location other than directly in front of the antennas. For accessible areas at ground level, the maximum predicted power density level resulting from all AT&T Mobility operations is 0.4105% of the FCC General Population limits (0.0821% of the FCC Occupational limits). Incident at adjacent buildings depicted in Figure 1, the maximum predicted power density level resulting from all AT&T Mobility operations is 0.7055% of the FCC General Population limits (0.1411% of the FCC Occupational limits). The proposed operation will not expose members of the General Public to hazardous levels of RF energy and will not contribute to existing cumulative MPE levels on walkable surfaces at ground or at adjacent buildings by 5% of the General Population limits.

Waterford Consultants, LLC recommends posting contact information signage at the gate that informs personnel entering the site of basic precautions to be followed when working around antennas. RF alerting signage (Caution) should be posted at the base of the proposed Monopine to inform authorized climbers of potential conditions near the antennas. These recommendations are depicted in Figure 2.

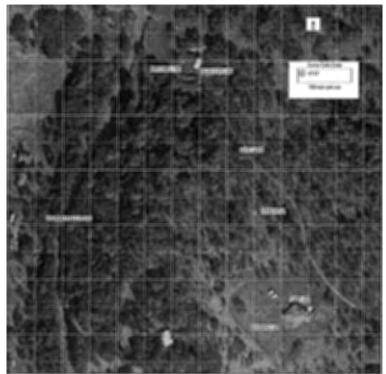


Figure 1: Antenna Locations

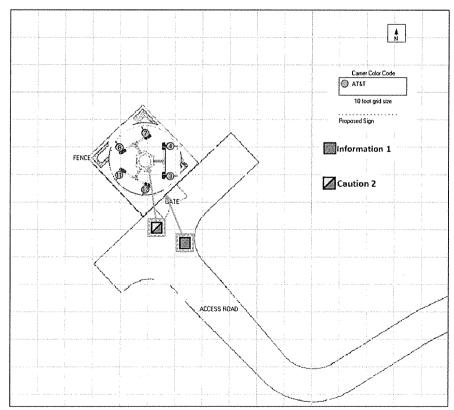


Figure 2: Mitigation Recommendations

Compliance Statement

Based on information provided by AT&T Mobility and predictive modeling, the installation proposed by AT&T Mobility at Gate Lane 1,000' South East of the intersection of Gate Lane and Salmon Falls Road, Pilot Hill, CA will be compliant with Radiofrequency Radiation Exposure Limits of 47 C.F.R. § 1.1307(b)(3) and 1.1310. RF alerting signage and restricting access to the Monopine to authorized climbers that have completed RF safety training is required for Occupational environment compliance.

Certification

I, David H. Kiser, am the reviewer and approver of this report and am fully aware of and familiar with the Rules and Regulations of both the Federal Communications Commissions (FCC) and the Occupational Safety and Health Administration (OSHA) with regard to Human Exposure to Radio Frequency Radiation, specifically in accordance with FCC's OET Bulletin 65. I have reviewed this Radio Frequency Exposure Assessment report and believe it to be both true and accurate to the best of my knowledge.

