INDEX OF SHEETS

SHEET	PLAN SHEET	TITLE
1		TITLE SHEET
2	L-1	SITE PLAN
3	L-2	LAYOUT
4	L-3	RAILROAD RECONSTRUCTION


COUNTY OF EL DORADO, CA DEPARTMENT OF TRANSPORTATION

PROJECT PLANS FOR THE CONSTRUCTION OF

LATROBE RAILROAD STORM DAMAGE REPAIR

IN THE COUNTY OF EL DORADO, DISTRICT 2 APPROX. 5.4 MILES OUTH OF THE U.S. HWY 50/LATROBE RD INTERCHANGE

> To be supplemented with Standard Plans and Specifications dated 2015, including the 2015 Revised Standard Specifications, of the California Department of Transportation, unless otherwise noted.

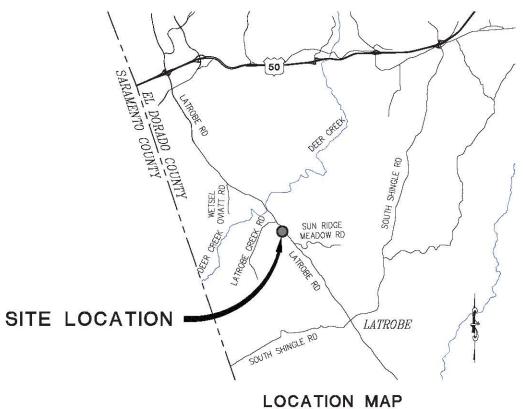


NOT TO SCALE

CONTRACTOR'S LICENSE CLASSIFICATION: Bidders shall be properly licensed to perform the Work pursuant to the State Contractor's License Act (Business and Professions Cade section 7000 et seq.) and shall possess a CLASS A LICENSE or equivalent combination of Classes required by the categories and type of Work included in the Contract Documents and Plans. Failure of the successful Bidder to obtain proper and adequate licensing at the time bids are submitted shall constitute a failure to execute the Contract, and forfeiture as provided under that section.


REVISIONS

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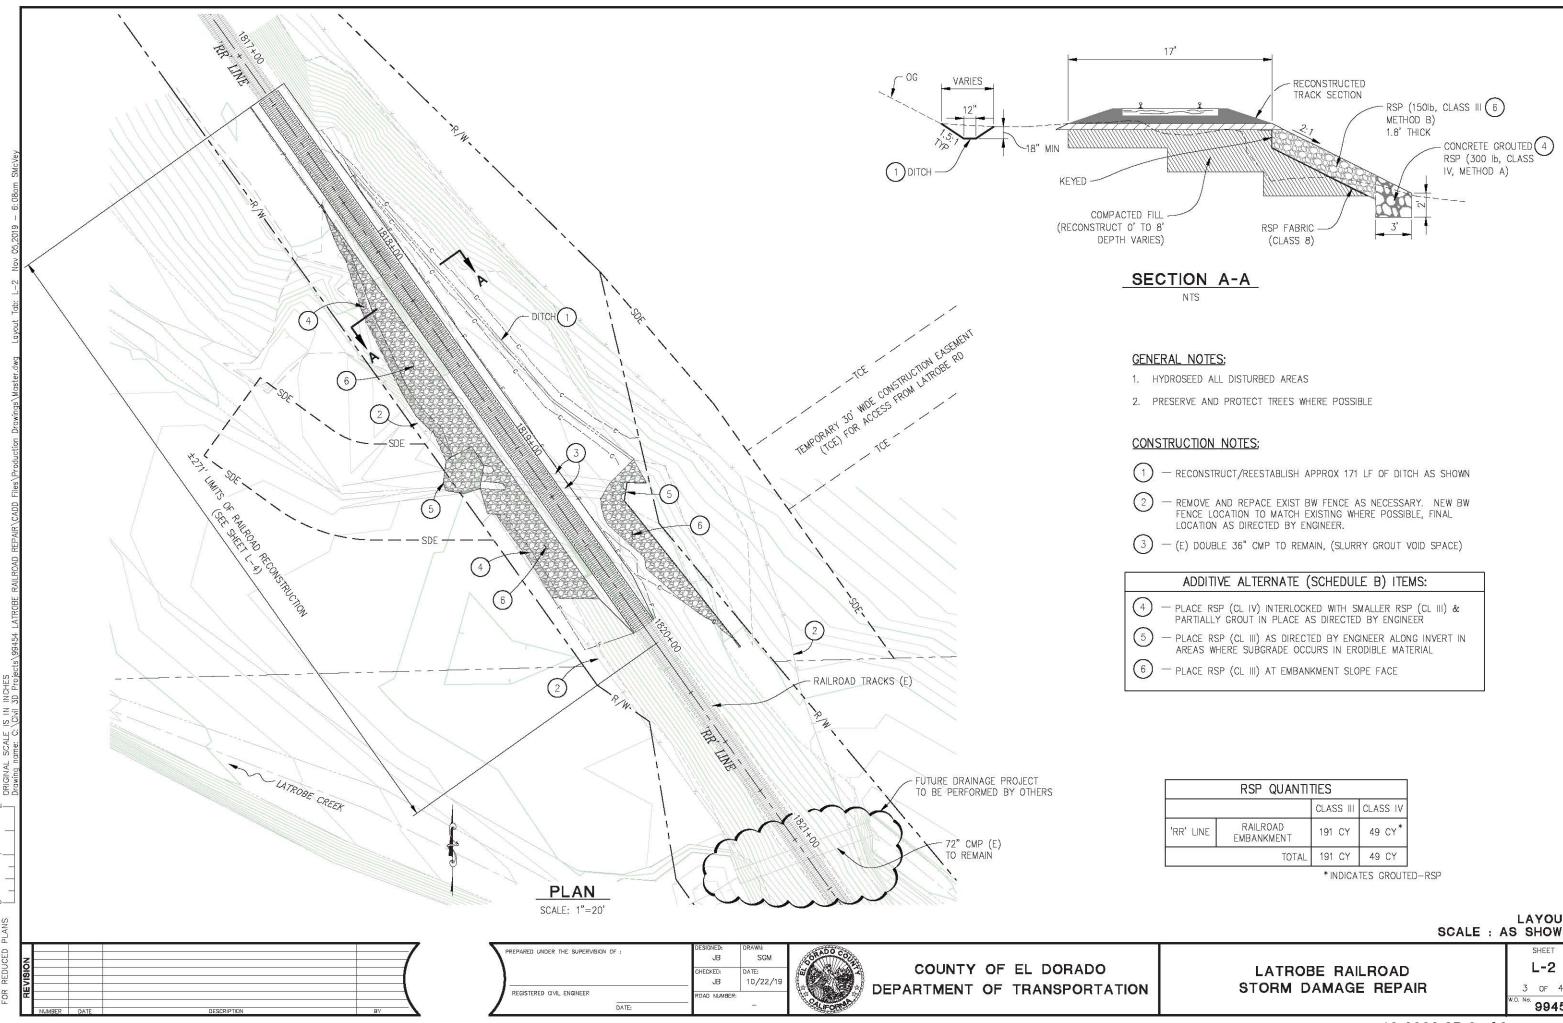


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RAILROAD AS DIRECTED BY ENGINEER	
\bigcirc — WASHOUT REPAIR SITE, SEE SHEETS L-2 THR	₩ L-3
(3) – 30' WIDE TEMPORARY CONSTRUCTION EASEME FOR ACCESS TO SITE FROM LATROBE RD	NT (TCE)
	SITE PLAN As shown
LATROBE RAILROAD STORM DAMAGE REPAIR	SHEET L-1 2 OF 4 W.O. No. 88454
	00404

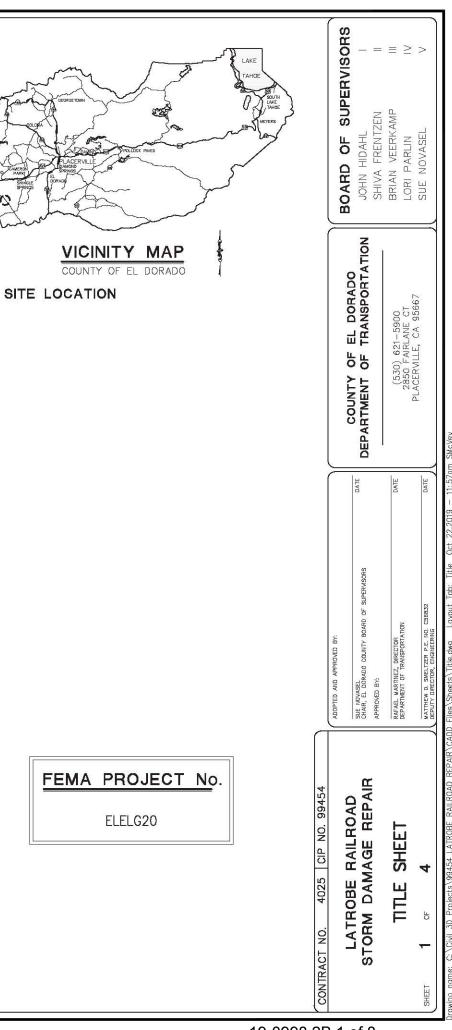(1) — PLACE BALLAST AT VARIOUS LOCATIONS ALONG


CONSTRUCTION NOTES:

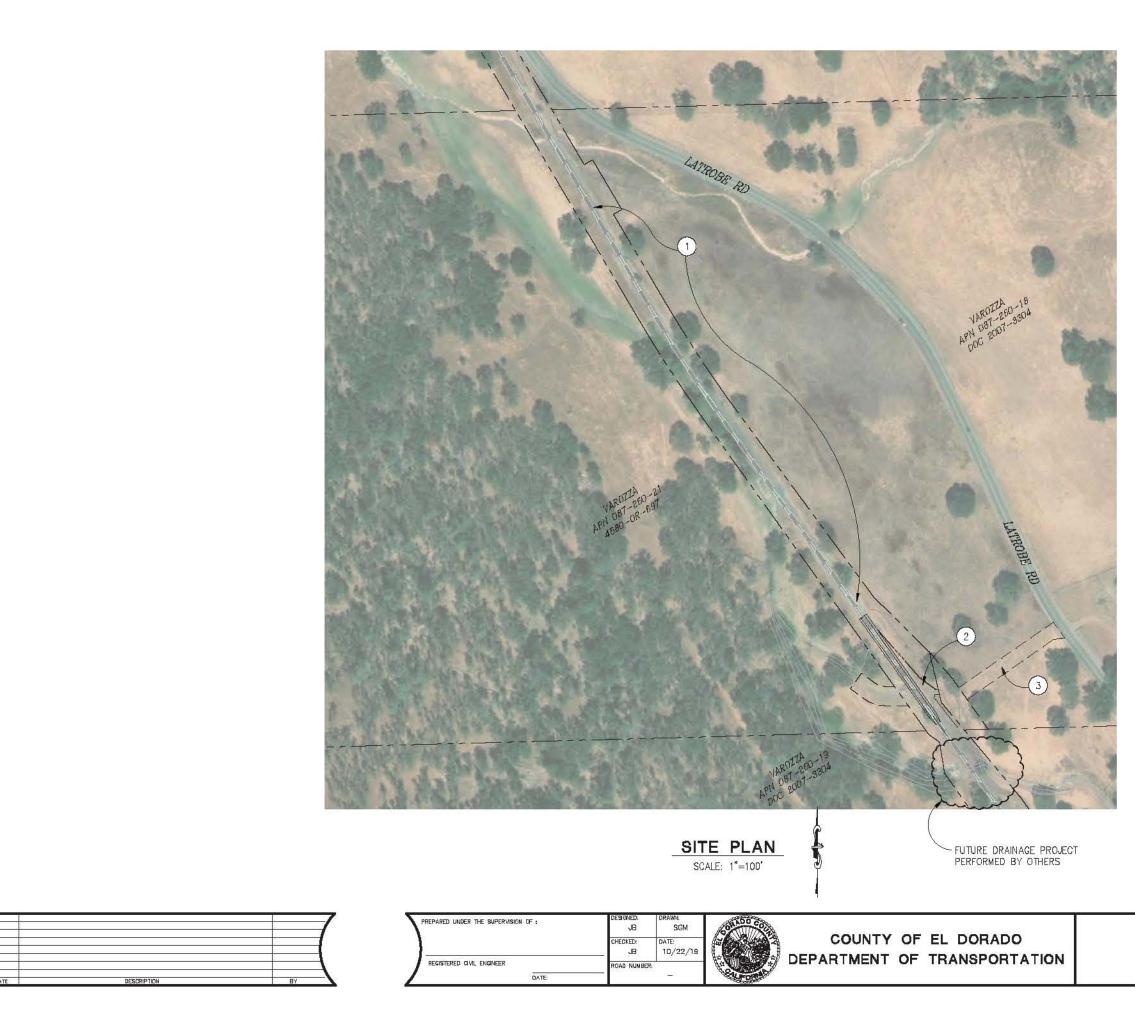

CLASS III CLAS				
191 CY	49 CY*			
191 CY	49 CY			
	191 CY			

TOTAL	191 CY	49 CY		
	* INDICA	TES GROUTE	D-RSP	
				LAYOUT
			SCALE :	AS SHOWN
				SHEET
LATROE		LROAD		L-2
STORM D	AMAG	E REPA	NR .	3 OF 4
				^{₩.0. №} . 994 54
				M3

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BALLAST QUANTITY				
LOCATION	QTY	REFERENCE		
WASHOUT REPAIR SITE	136 CY	L-4		
MISC & ERODED AREAS (AS DIRECTED BY ENGINEER)	40 CY	L—1		
TOTAL	176 CY			

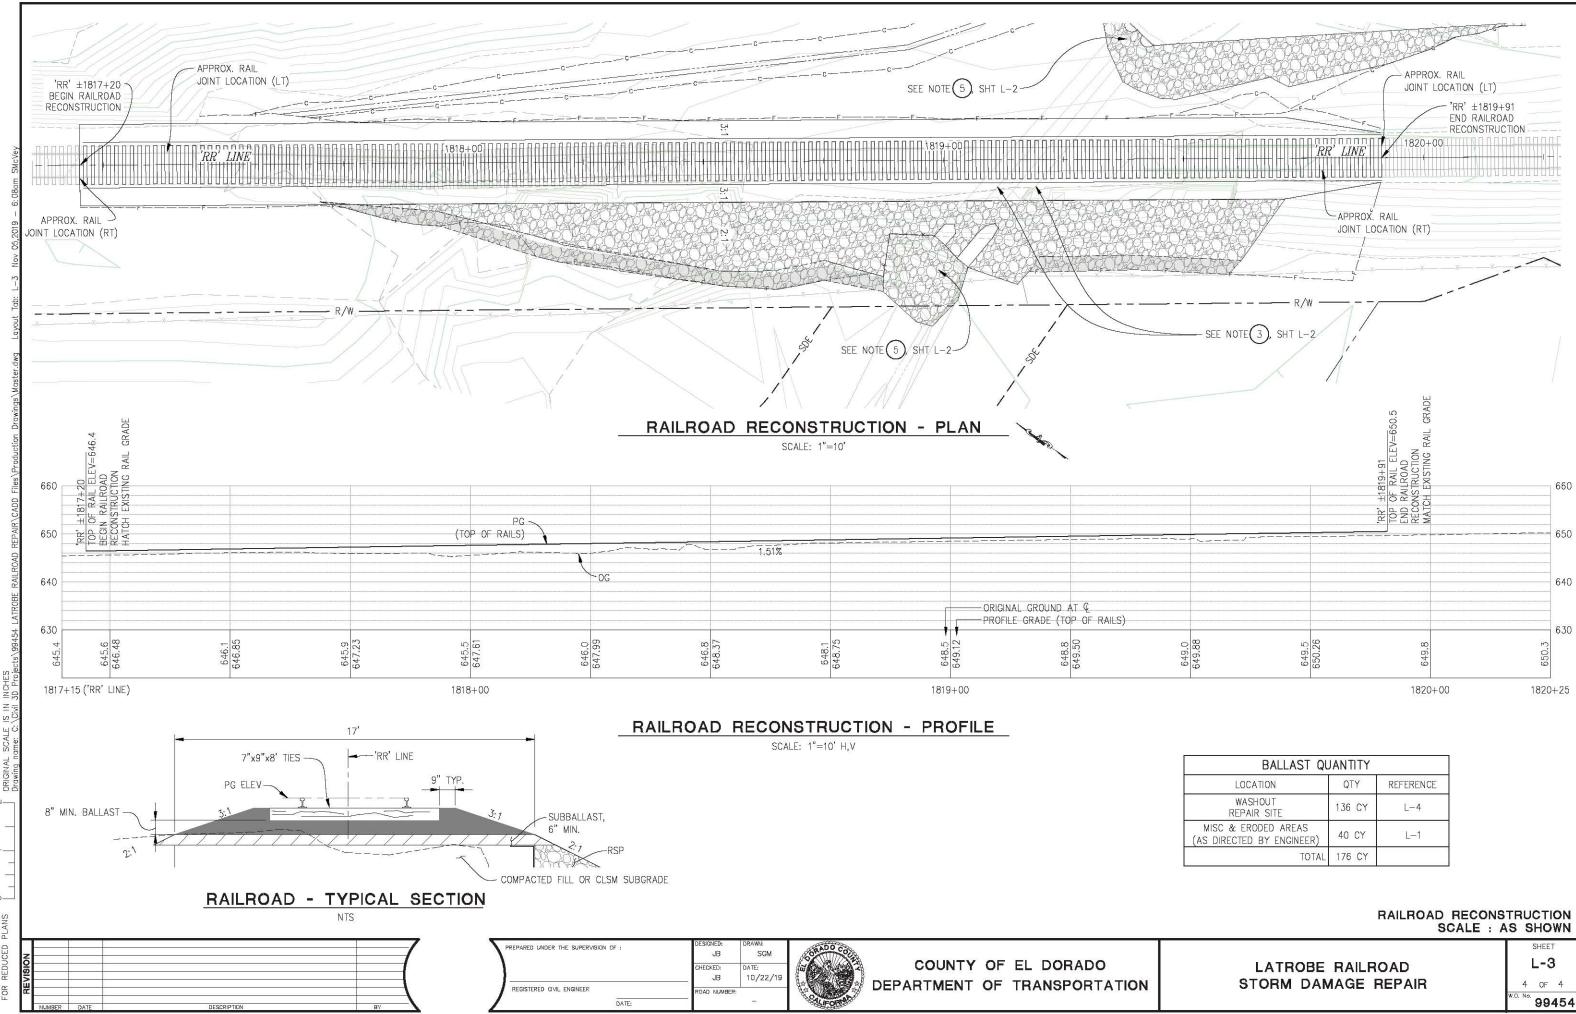INDEX OF SHEETS

SHEET	PLAN SHEET	TITLE
1		TITLE SHEET
2	L-1	LAYOUT
3	L-2	LAYOUT
4	C-1	CONSTRUCTION DETAILS


COUNTY OF EL DORADO, CA DEPARTMENT OF TRANSPORTATION

PROJECT PLANS FOR THE CONSTRUCTION OF

HENNINGSEN LOTUS PARK RIVERBANK RESTORATION

IN THE COUNTY OF EL DORADO, DISTRICT 4 APPROX 1.4 MILES NORTHWEST OF THE TOWN OF COLOMA

To be supplemented with Standard Plans and Specifications dated 2015, including the 2015 Revised Standard Specifications, of the California Department of Transportation, unless otherwise noted.

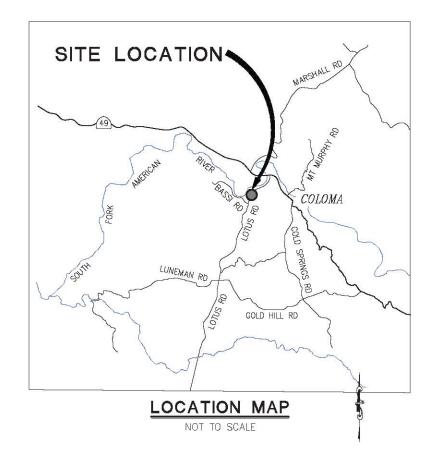


CONTRACTOR'S LICENSE CLASSIFICATION: Bidders shall be properly licensed to perform the Work pursuant to the State Contractor's License Act (Business and Professions Code section 7000 et seq.) and shall possess a CLASS A LICENSE or equivalent combination of Classes required by the categories and type of Work included in the Contract Documents and Plans. Failure of the successful Bidder to obtain proper and adequate licensing at the time bids are submitted shall constitute a failure to execute the Contract, and forfeiture as provided under that section.

REVISIONS				
2				

MARK DATE



BY

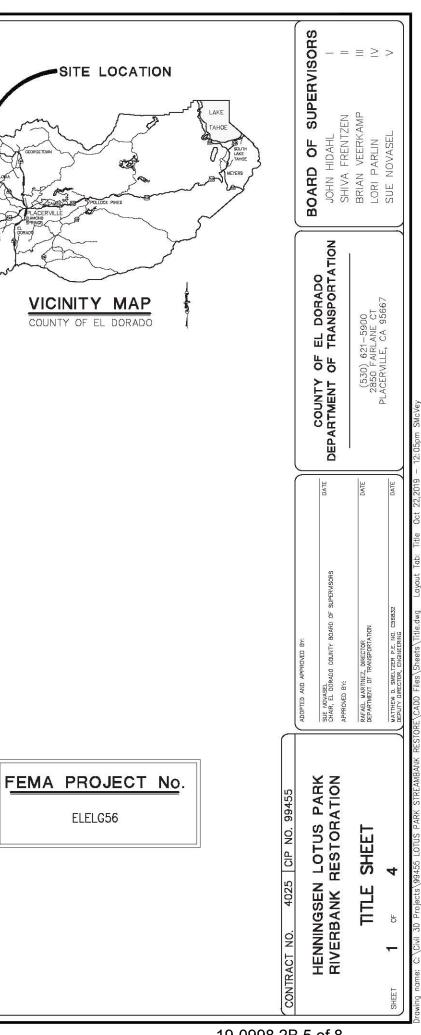

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NOTES:

- 1. REFER TO SHEETS H-1 AND H-2 FOR APPROXIMATE LOCATIONS OF RSP, SHOULDER BACKING AND DECOMPOSED GRANITE PLACEMENT.
- DIMENSIONS AND QUANTITIES SHOWN AT LOCATION(S) ARE APPROXIMATE. ACTUAL PLACEMENT LIMITS AND LOCATIONS WILL BE DETERMINED BY ENGINEER.
- "RSP CL III/CL IV" INDICATES AN AGGREGATE SIZING OF RSP MATERIAL THAT IS COMPOSED OF BOTH CL III & CL IV SIZING (APPROXIMATELY 40/60 SPLIT OR AS DETERMINED BY ENGINEER)
- 4. APPROXIMATELY 3 EA. "PEDESTRIAN PATHS" MUST BE MADE AVAILABLE IN THE FINAL RSP SLOPE CONFIGURATION. LIMITS OF THE RSP & CONFIGURATION DETAILS OF THE PEDESTRIAN PATHS WILL BE DETERMINED BY ENGINEER.
- ADDITIONAL SHOULDER BACKING MATERIAL MAY BE NEEDED IN EXCESS OF THE AVAILABLE MATERIAL SHOWN ON SHEET H-1.
- 6. REFER TO SHEET H-3 FOR CONSTRUCTION DETAILS.



G	
LOCA	
1	
2	
3	



REGISTERED CIVIL ENGINEER	ROAD NUMBE	R; _	CALIFOR
	CHECKED: JB	DATE: 10/22/19	Ш ¢
PREPARED UNDER THE SUPERVISION OF :	DESIGNED: JB	DRAWN: SGM	ORADO

COUNTY OF EL DORADO

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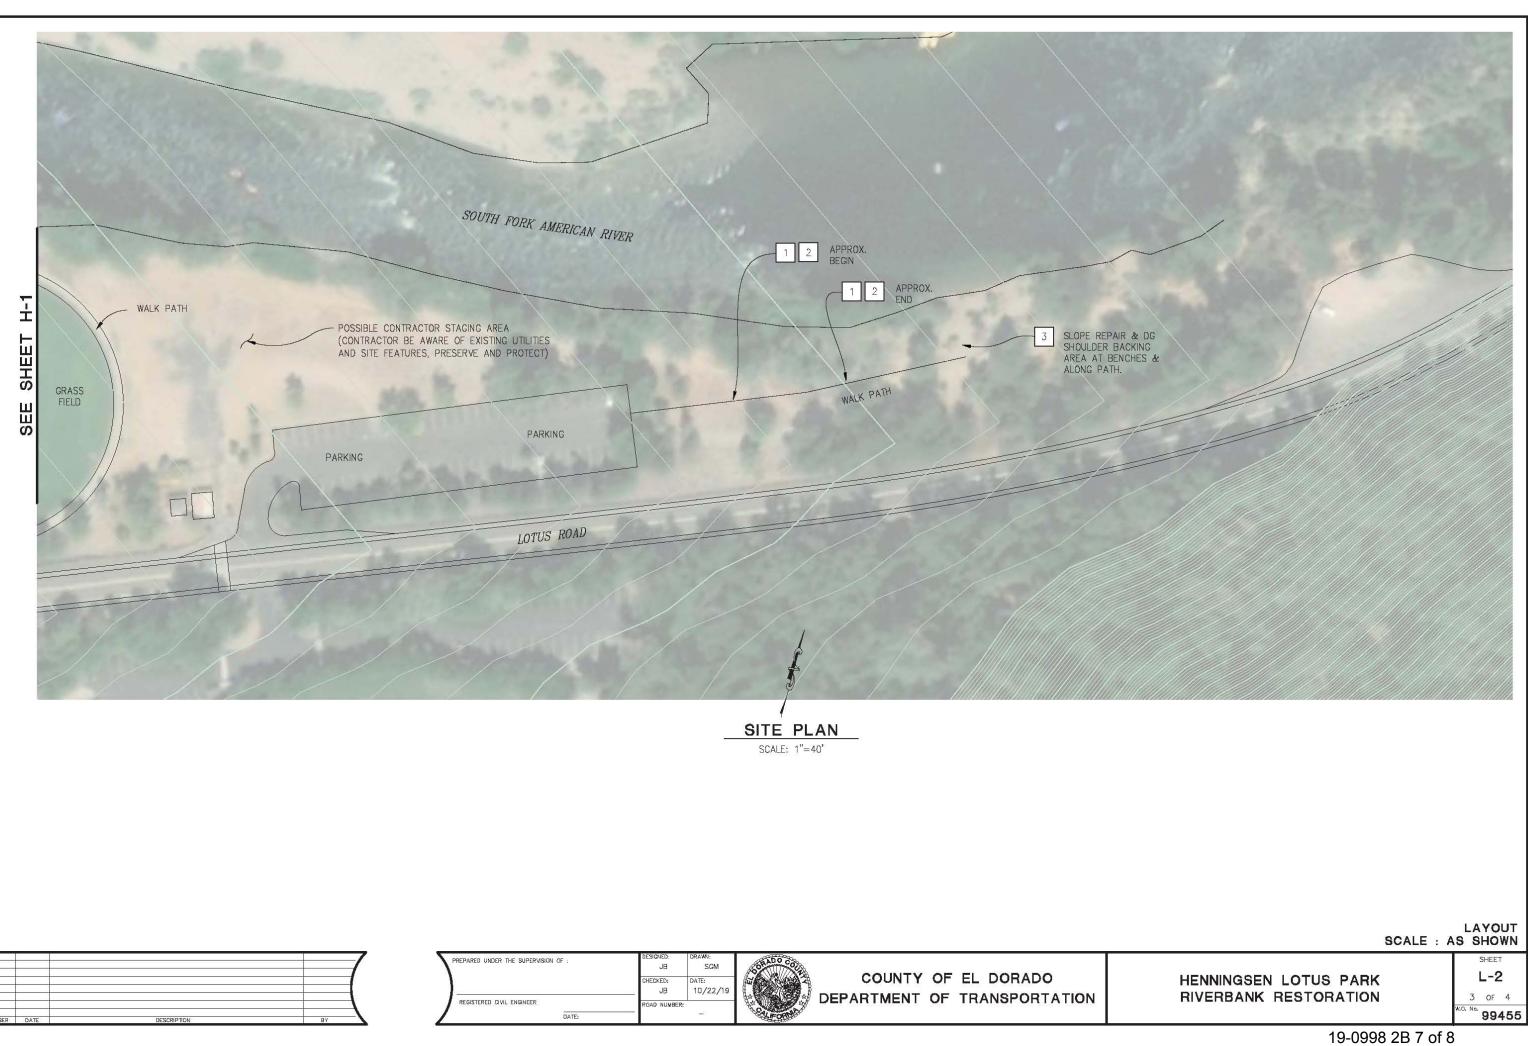
HENNINGSEN LOTUS PARK RIVERBANK RESTORATION

SHEET L-1 2 of 4 W.D. No. **99455**

LAYOUT SCALE : AS SHOWN

QUANTITIES ALONG RIVERBANK SLOPE							
CATION	APPROXIMATE DIMENSIONS	RSP CL III/CL IV (METHOD B)	SHLD BACKING	DG (CY)			
1	APPROX. 400' LONG X (VARIES 3'-20') WIDE X 3' THICK (AVG)	650 CY					
2	SHOULDER BACKING AT BACK OF WALK (AS NEEDED/SHOWN) 500 LF X (VARIES 0-6") X WDTH AS SHOWN ON SHEET H-3		20 CY				
3	75' LONG X (VARIES 3'-12') WIDE X 3' DEEP	100 CY		15 CY			
	TOTAL	750 CY	20 CY	15 CY			

1 APPROX END RSP ALONG SLOPE	-
2 APPROX END SHOULDER BACKING AT BACK OF WALK GRASS FIELD	SEE SHEET H-2
LOTUS ROAD	-



SCALE IS IN INCHES

ORIGINAL Drawing pr

0-

SN

